241569

DISCIPLINE **GENERAL**


SHEET NAME **CVR-SHT**


VILLAGE OF LITHOPOLIS

JACKSON LAKE CAMPGROUND FORCE MAIN INTERCONNECT


FAIRFIELD COUNTY, OHIO

MARCH 2025

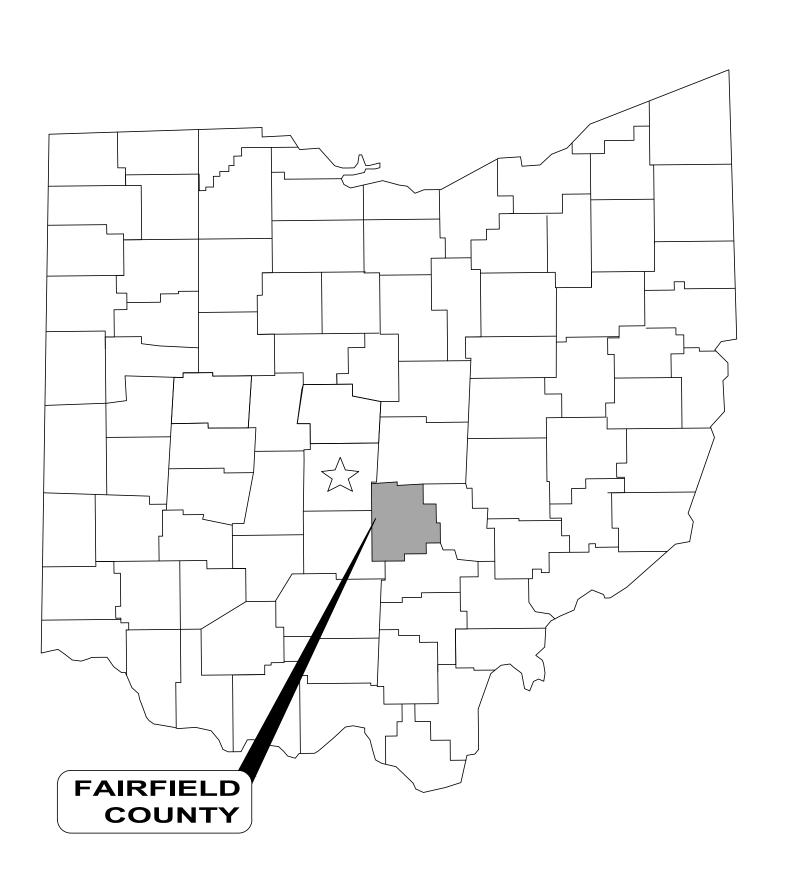

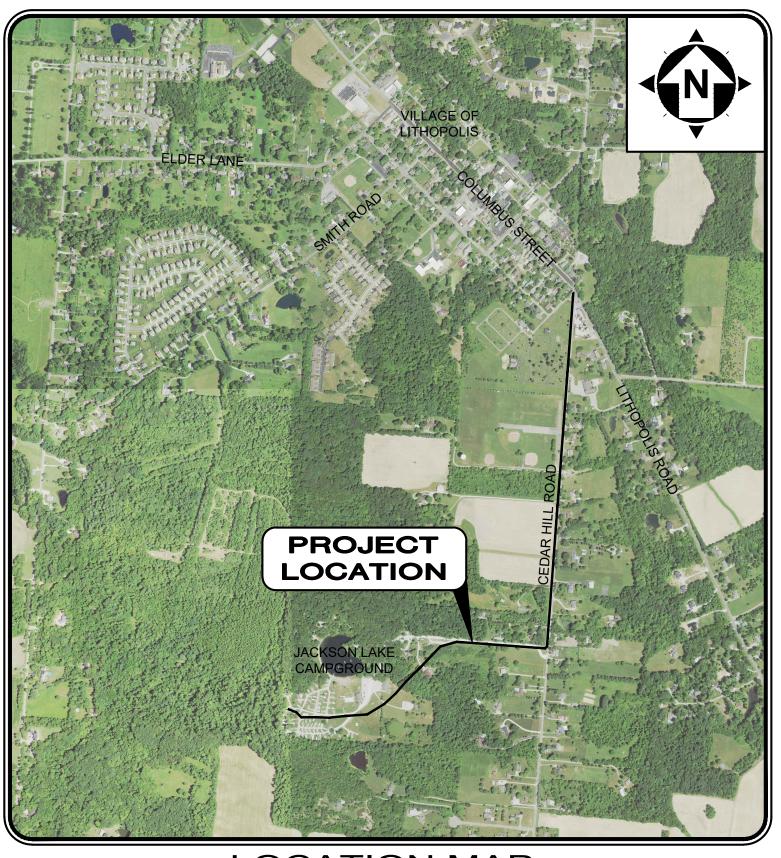

LOCATION MAP NOT TO SCALE

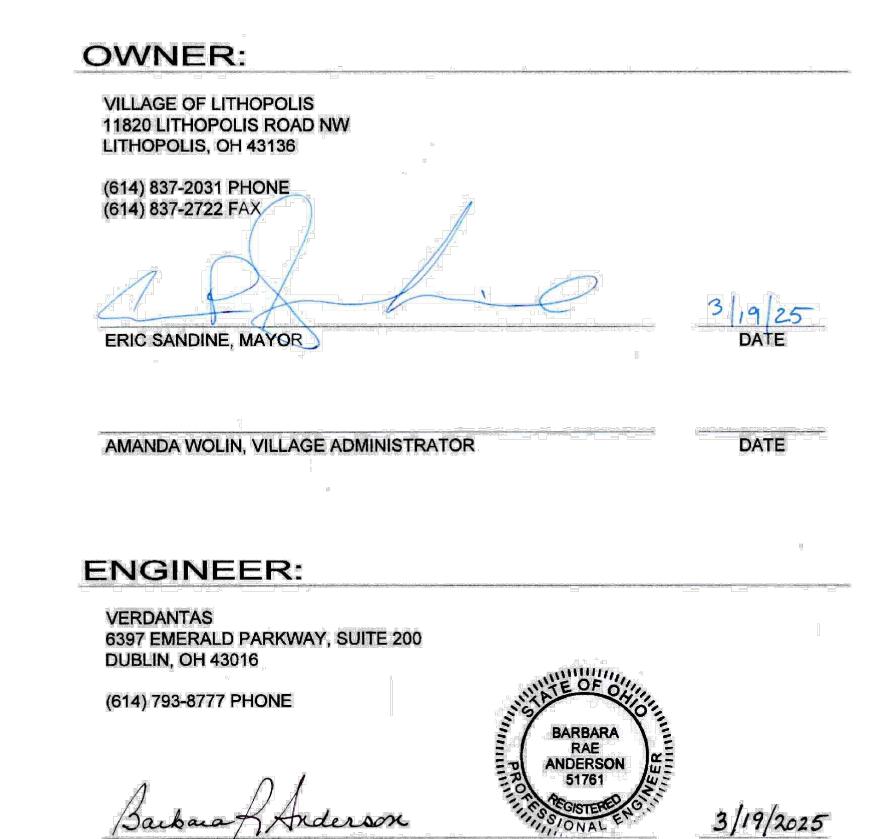

1-800-362-2764 CALL TWO WORKING DAYS BEFORE YOU DIG (NON MEMBERS MUST BE CALLED DIRECTLY)

1. UNDERGROUND BUILDING SERVICE UTILITY LINES ARE NOT SHOWN ON THE PLANS. THE CONTRACTOR SHALL BE RESPONSIBLE FOR LOCATING, MAINTAINING AND REPLACING AS NECESSARY TO ENSURE CONTINUAL SERVICE TO

2. THE CONTRACTOR IS RESPONSIBLE TO CALL OHIO UTILITIES PROTECTION SERVICE @ 1-800-362-2764, THREE WORKING DAYS PRIOR TO CONSTRUCTION.

ENGINEER'S PROJECT No. 241569

GENERAL NOTES:

- GENERAL: THE CURRENT FAIRFIELD COUNTY CONSTRUCTION AND MATERIAL SPECIFICATIONS (FCCMS), INCLUDING ALL SUPPLEMENTS THERETO, WITH THE REQUIREMENTS OF FAIRFIELD COUNTY IN FORCE ON THE DATE OF CONTRACT, SHALL GOVERN ALL MATERIALS, METHODS OF CONSTRUCTION AND WORKMANSHIP INVOLVED IN THE IMPROVEMENTS SHOWN ON THESE PLANS, EXCEPT AS SUCH SPECIFICATIONS ARE MODIFIED BY THE FOLLOWING SPECIFICATIONS OR BY THE CONSTRUCTION DETAILS SET FORTH HEREIN. ANY MODIFICATION TO THE SPECIFICATIONS OR CHANGES TO THE WORK AS SHOWN ON THESE PLANS MUST HAVE PRIOR WRITTEN APPROVAL OF THE OWNER.
- WORK LIMITS: THE CONTRACTOR SHALL CONFINE HIS ACTIVITIES TO THE PROJECT SITE UNDER DEVELOPMENT, EXISTING RIGHTS-OF-WAY, CONSTRUCTION EASEMENTS AND PERMANENT EASEMENTS, AND SHALL NOT TRESPASS UPON OTHER PRIVATE PROPERTY WITHOUT THE WRITTEN CONSENT OF THE PROPERTY OWNER. APPROVAL OF THESE PLANS IS CONTINGENT UPON ALL EASEMENTS REQUIRED FOR CONSTRUCTION OF THE WORK BEING SECURED OR PLATTED, AND FURNISHED TO THE OWNER.
- MISCELLANEOUS WORK: ALL ITEMS OF WORK CALLED FOR ON THE PLANS FOR WHICH NO SPECIFIC METHOD OF PAYMENT IS PROVIDED SHALL BE PERFORMED BY THE CONTRACTOR AND THE COST OF SAME SHALL BE INCLUDED IN THE PRICE BID FOR THE VARIOUS RELATED ITEMS.
- FIELD TILE: ALL FIELD TILE AND OTHER DRAINAGE TILE BROKEN DURING EXCAVATION SHALL BE REPLACED TO ITS ORIGINAL CONDITION OR CONNECTED EITHER TO A CURB SUB-DRAIN OR A STORM SEWER SYSTEM, AS DIRECTED BY THE OWNER.
- G-5 SURPLUS EXCAVATION: THE CONTRACTOR SHALL PROPERLY DISPOSE OF ALL SURPLUS EXCAVATION.
- G-6 EXISTING UTILITIES: THE INFORMATION SHOWN CONCERNING EXISTING UTILITIES IS NOT REPRESENTED. WARRANTED OR GUARANTEED TO BE COMPLETE OR ACCURATE. IT SHALL BE THE CONTRACTOR'S RESPONSIBILITY TO PHYSICALLY LOCATE AND VERIFY IN THE FIELD, ALL UTILITY LOCATIONS AND ELEVATIONS, WHETHER SHOWN ON THE PLANS OR NOT, PRIOR TO THE BEGINNING OF CONSTRUCTION OPERATIONS. THE CONTRACTOR SHALL SUPPORT, PROTECT, AND RESTORE ALL EXISTING UTILITIES AND ASSOCIATED ITEMS TO THE SATISFACTION OF THE UTILITY OWNER.

THE CONTRACTOR SHALL NOTIFY ALL UTILITY OWNERS, IN ACCORDANCE WITH SECTION 153.64 OF THE OHIO REVISED CODE, AT LEAST FORTY-EIGHT (48) HOURS PRIOR TO THE BEGINNING OF ANY WORK, TO REQUEST UTILITY LOCATIONS, TO COORDINATE THE WORK, AND TO KEEP THE UTILITY OWNERS APPRAISED OF THE CONSTRUCTION SCHEDULE AND REQUIREMENTS UNTIL ALL WORK IS COMPLETED. THE CONTRACTOR SHALL PROVIDE THE COUNTY SANITARY ENGINEER WITH EVIDENCE OF HAVING NOTIFIED THE UTILITY OWNERS OF THE CONSTRUCTION WORK AND SCHEDULE PRIOR TO BEGINNING ANY WORK.

NOTICE SHALL BE GIVEN TO THE OHIO UTILITIES PROTECTION SERVICE (800-362-2764) FOR THE MEMBER UTILITIES. THE VILLAGE OF LITHOPOLIS IS A MEMBER UTILITY FOR WATER AND SANITARY SEWER UTILITIES. THE FAIRFIELD COUNTY ENGINEER (740-652-2300) AND LOCAL GOVERNMENTAL ENTITY RESPONSIBLE FOR STORM SEWERS ARE NOT MEMBERS OF A REGISTERED UNDERGROUND PROTECTION SERVICE AND MUST BE CONTACTED DIRECTLY.

- SAFETY OF CONSTRUCTION: COMPLIANCE WITH THE OCCUPATIONAL SAFETY AND HEALTH ACT OF 1970. AS AMENDED AND APPLICABLE OSHA REGULATIONS IS REQUIRED OF ALL CONTRACTORS ON THE PROJECT. EACH CONTRACTOR AND SUBCONTRACTOR IS RESPONSIBLE TO IMPLEMENT, MAINTAIN AND SUPERVISE ALL SAFETY REQUIREMENTS, PRECAUTIONS AND PROGRAMS IN CONNECTION WITH THE WORK.
- NOTIFICATION: THE CONTRACTOR SHALL NOTIFY THE VILLAGE OF LITHOPOLIS SEVENTY-TWO (72) HOURS, EXCLUDING WEEKENDS AND HOLIDAYS, PRIOR TO THE START OF CONSTRUCTION OF WATER AND/OR SANITARY SEWER UTILITIES. WHEN CONSTRUCTION IS SUSPENDED FOR MORE THAN SEVEN DAYS, THE CONTRACTOR SHALL NOTIFY THE VILLAGE OF LITHOPOLIS SEVENTY-TWO (72) HOURS, EXCLUDING WEEKENDS AND HOLIDAYS, PRIOR TO RESUMING CONSTRUCTION. CONSTRUCTION SHALL NOT START PRIOR TO THE REQUIRED NOTICE BEING
- G-9 CLEAN-UP: THE TRACKING OF MUD, DIRT OR DEBRIS UPON ANY PUBLIC ROADWAY IS PROHIBITED AND ANY SUCH OCCURRENCE SHALL BE CLEANED UP IMMEDIATELY BY THE CONTRACTOR. THE CONTRACTOR SHALL CLEAN UP ALL DEBRIS AND MATERIALS RESULTING FROM THE CONSTRUCTION OPERATION AND RESTORE ALL SURFACES, STRUCTURES, DITCHES, AND PROPERTY TO ITS ORIGINAL CONDITION AND TO THE SATISFACTION OF THE VILLAGE OF LITHOPOLIS AND GOVERNING HIGHWAY AUTHORITY.
- G-10 PERMITS: THE CONTRACTOR SHALL OBTAIN ANY AND ALL NECESSARY PERMITS PRIOR TO BEGINNING CONSTRUCTION. ALL WORK SHALL BE PERFORMED IN ACCORDANCE WITH THE APPLICABLE FEDERAL. STATE AND COUNTY REGULATIONS AND REQUIREMENTS.
- G-11 CROSSINGS: ALL WATER MAINS AND SERVICES SHALL BE CONSTRUCTED WITH AT LEAST 10 FEET HORIZONTAL SEPARATION AND AT LEAST AN 18 INCH VERTICAL SEPARATION FROM ALL SANITARY AND STORM SEWERS. WHEN THE 10 FOOT OR 18 INCH CLEARANCE CANNOT BE OBTAINED. THE SANITARY OR STORM SEWER SHALL BE CONSTRUCTED OF WATERLINE MATERIALS AS APPROVED IN THE COUNTY'S CONSTRUCTION AND MATERIAL SPECIFICATIONS, AND/OR THE WATERLINE MUST BE RELOCATED OR LOWERED AS DIRECTED BY THE VILLAGE OF LITHOPOLIS.
- G-12 TRAFFIC CONTROL: A SUBDIVISION STREET, UNLESS IT IS ALSO A COUNTY OR STATE HIGHWAY, MAY BE CLOSED TO THROUGH TRAFFIC ONE (1) BLOCK AT A TIME FROM 8:00 A.M. TO 4:00 P.M. MONDAY THROUGH FRIDAY. THE CONTRACTOR SHALL SUBMIT A PLAN AND SCHEDULE FOR DETOURING TRAFFIC TEN (10) DAYS PRIOR TO THE CLOSING OF ANY STREET. ANY TEMPORARY CLOSING OF A STREET DOES NOT RELIEVE THE CONTRACTOR OF THE RESPONSIBILITY TO PROVIDE ACCESS TO THE PROPERTY BY EMERGENCY VEHICLES, MAIL/DELIVERY VEHICLES AND THE OWNERS.

WHERE IT IS ANTICIPATED THAT WORK WILL CLOSE A STREET, THE CONTRACTOR SHALL INFORM THE RESIDENTS TO BE AFFECTED, COUNTY SHERIFF'S OFFICE, TOWNSHIP FIRE DEPARTMENT, COUNTY SANITARY ENGINEER, COUNTY ENGINEER, APPLICABLE SCHOOL DISTRICT, AND OTHER APPLICABLE CITY AND TOWNSHIP ENTITIES AS TO THE EXTENT, NATURE, AND TIME OF THE ANTICIPATED WORK. NO STREET SHALL BE CLOSED UNTIL THE SCHEDULE IS APPROVED BY THE COUNTY ENGINEER.

ADEQUATE LIGHTS, SIGNS, AND BARRICADES SHALL BE USED, AS REQUIRED IN ITEM 614 OF THE ODOT CONSTRUCTION AND MATERIAL SPECIFICATIONS AND OMUTCD, TO SAFEGUARD THE TRAVELING PUBLIC AT ALL ALL TRENCHES SHALL BE BACKFILLED OR SECURELY PLATED WITHIN THE PUBLIC RIGHT-OF-WAY DURING NON-WORKING HOURS.

- G-13 CURB MARKINGS: THE VILLAGE OF LITHOPOLIS REQUIRES THAT THE LETTERS "V" FOR WATER MAIN VALVE. "W" FOR WATER SERVICE LINE AND "S" FOR SANITARY SEWER SERVICE LINE BE EMBEDDED IN THE CONCRETE CURB. FOR STANDARD CURBS, THE LETTER IS TO BE LOCATED IN THE CENTER ON THE TOP FLAT PORTION OF THE CURB. FOR ROLLED CURBS, THE TOP OF THE LETTER IS TO BE LOCATED ON THE FACE OF THE CURB WITHIN ONE AND ONE-HALF (1-1/2) INCHES OF THE CREST. THE LETTER IS TO BE AT LEAST TWO (2) INCHES WIDE, THREE (3) INCHES HIGH AND ONE QUARTER (1/4) INCH DEEP. THE LETTER "V" IS TO BE LOCATED ON THE CURB IMMEDIATELY ADJACENT TO ALL WATER MAIN VALVES. THE LETTERS "W" AND "S" ARE TO BE LOCATED DIRECTLY OVER THE HOUSE SERVICE LINES.
- G-14 SEDIMENT AND EROSION CONTROL: THE CONTRACTOR SHALL BE SOLELY RESPONSIBLE FOR PROVIDING NECESSARY AND ADEQUATE MEASURES FOR PROPER CONTROL OF EROSION AND SEDIMENT RUNOFF FROM THE SITE ALONG WITH PROPER MAINTENANCE AND INSPECTION IN COMPLIANCE WITH THE NPDES GENERAL PERMIT FOR STORM WATER DISCHARGE ASSOCIATED WITH CONSTRUCTION ACTIVITY. ALL SEDIMENT AND EROSION CONTROL MEASURES REQUIRED IN THE PLANS, THE FAIRFIELD COUNTY CONSTRUCTION AND MATERIAL SPECIFICATIONS, AND THE OHIO EPA STORM WATER REGULATIONS AND GENERAL PERMIT SHALL BE IN PLACE AND OPERATIONAL PRIOR TO CONSTRUCTION BEGINNING IN THE WORK AREA.
- G-15 PROHIBITED CONSTRUCTION ACTIVITIES: THE FOLLOWING CONSTRUCTION ACTIVITIES ARE PROHIBITED ON THE PROJECT.
 - USING ANY SUBSTANCE OTHER THAN WATER TO CONTROL DUST
 - TRACKING OF MUD, DIRT AND DEBRIS ONTO ANY PUBLIC ROADWAY
 - OPEN BURNING OF PROJECT DEBRIS WITHOUT A PERMIT. THE CONTRACTOR IS RESPONSIBLE FOR OBTAINING THE PERMIT OR DISPOSING OF THE TREES AND
 - PUMPING OF SEDIMENT-LADEN WATER FROM TRENCHES OR OTHER EXCAVATIONS INTO ANY SURFACE WATERS, ANY STREAM CORRIDORS, ANY WETLANDS, OR STORM SEWERS.
 - DISCHARGING POLLUTANTS SUCH AS CHEMICALS, FUELS, LUBRICANTS, BITUMINOUS MATERIALS, RAW SEWAGE - AND OTHER HARMFUL WASTE INTO OR ALONGSIDE RIVERS, STREAMS, IMPOUNDMENTS OR INTO NATURAL OR MAN-MADE CHANNELS LEADING THERETO.
 - STORING CONSTRUCTION EQUIPMENT AND VEHICLES AND/OR STOCKPILING CONSTRUCTION MATERIALS ON PROPERTY, PUBLIC OR PRIVATE, NOT PREVIOUSLY SPECIFIED FOR SAID PURPOSES.
 - DISPOSING OF EXCESS OR UNSUITABLE EXCAVATED MATERIAL IN WETLANDS OR FLOODPLAINS, EVEN WITH THE PERMISSION OF THE PROPERTY OWNER.
 - INDISCRIMINATE, ARBITRARY, OR CAPRICIOUS OPERATION OF EQUIPMENT IN ANY STREAM CORRIDORS, WETLANDS, SURFACE WATERS, OR OUTSIDE THE EASEMENT AREA.
 - PERMANENT OR UNSPECIFIED ALTERATION OF THE FLOW LINE OF A STREAM.
 - REMOVAL OF TREES AND BUSHES, OR DAMAGING VEGETATION OUTSIDE THE LIMITS OF THE CONSTRUCTION AREA.
 - DISPOSAL OF TREES, BRUSH AND OTHER DEBRIS IN ANY STREAM CORRIDORS, ANY WETLANDS, ANY SURFACE WATERS OR AT UNSPECIFIED LOCATIONS.
- G-16 RECORD DRAWINGS: ONE (1) SET OF RECORD CONSTRUCTION DRAWINGS AND A COMPUTER DISK IN AUTOCAD FORMAT AND .TIFF OR .PDF FORMAT SHALL BE PROVIDED TO THE VILLAGE OF LITHOPOLIS AS SOON AS ALL PUBLIC IMPROVEMENTS ARE COMPLETED AND PRIOR TO FINAL ACCEPTANCE
- G-17 THIS PROJECT IS LOCATED WITHIN THE KNOWN HABITAT RANGES OF THE FEDERALLY LISTED AND PROTECTED INDIANA, NORTHERN LONG-EARED, AND TRI-COLORED BAT. NO TREES SHALL BE REMOVED UNDER THIS PROJECT FROM APRIL 1 THROUGH SEPTEMBER 30. ALL NECESSARY TREE REMOVAL SHALL OCCUR FROM OCTOBER 1 THROUGH MARCH 31. THIS REQUIREMENT IS NECESSARY TO AVOID AND MINIMIZE IMPACTS TO THESE SPECIES AS REQUIRED BY THE ENDANGERED SPECIES ACT (ESA). FOR THE PURPOSES OF THIS NOTE, A TREE IS DEFINED AS: A LIVE, DYING, OR DEAD WOODY PLANT, WITH A TRUNK 3 INCHES OR GREATER IN DIAMETER AT A HEIGHT OF 4.5 FEET ABOVE THE GROUND SURFACE, AND WITH A MINIMUM HEIGHT OF 13 FEET.

UNDERGROU	ND UTILITIES
OWNER	CONTACT
OUPS	(800) 362-2764
VILLAGE OF LITHOPOLIS	(614) 837-2031
SOUTH CENTRAL POWER	(740) 422-6166
AT&T	(614) 237-7276
COLUMBIA GAS	(740) 334-1633

SANITARY NOTES:

- SA-1 TESTING: AN INFILTRATION OR EXFILTRATION TEST SHALL BE MADE IN ACCORDANCE WITH THE FAIRFIELD COUNTY SPECIFICATIONS WITH MAXIMUM TEST SECTIONS OF 400 FEET. LEAKAGE THROUGH JOINTS SHALL NOT EXCEED 100 GALLONS PER DAY PER INCH OF SEWER DIAMETER PER MILE OF PIPE. AIR TESTING IS AN ACCEPTABLE ALTERNATE TESTING METHOD FOR LEAKAGE AND SHALL BE MADE IN ACCORDANCE WITH FAIRFIELD COUNTY SPECIFICATIONS AND ASTM F1417-92. SANITARY SEWERS SHALL BE MANDREL TESTED AND LEAKAGE TESTED NO SOONER THAN 60 DAYS AFTER INSTALLATION. AFTER ACCEPTABLE MANDREL AND LEAKAGE TESTING, ALL SANITARY SEWERS SHALL BE VIDEOTAPED IN DVD FORMAT. THE DVD VIDEO SHALL CLEARLY IDENTIFY THE LOCATION OF THE CAMERA WITHIN THE SEWER, DATE AND TIME OF DVD VIDEO, AND BE OF SUFFICIENT QUALITY TO DETERMINE THE CONDITION OF THE SEWERS. ALL SANITARY MANHOLES SHALL BE VACUUM TESTED, IN ACCORDANCE WITH ASTM C1244-93. ALL TEST REPORTS AND DVD VIDEO SHALL BE FURNISHED TO THE VILLAGE OF LITHOPOLIS PRIOR TO ACCEPTANCE OF THE SYSTEM.
- SA-2 WYE POLES: THE CONTRACTOR SHALL FURNISH AND PLACE, AS DIRECTED, APPROVED WYE POLES MADE OF 4" X 4" TREATED HARDWOOD LUMBER AT ALL WYE LOCATIONS, ENDS OF EXTENDED SERVICES, OR AT THE END OF EACH RISER WHERE RISERS ARE REQUIRED, EXTENDING A MINIMUM OF 3 FEET ABOVE FINAL SURFACE GRADES. THE WYE POLES SHALL BE PAINTED WITH TNEMEC ENDURATONE SERIES 1028 HUNTER GREEN.
- SA-3 RISERS: RISERS SHALL BE PLACED ON ALL WYES WHERE THE FLOW LINE DEPTH IS GREATER THAN 12 FEET. TOPS OF RISERS ARE TO BE 10 FEET BELOW GROUND, PLUS OR MINUS ONE FOOT, OR AS OTHERWISE DIRECTED BY THE VILLAGE OF LITHOPOLIS OR HIS DESIGNATED
- SA-4 SERVICE CONNECTIONS: SERVICE OR HOUSE CONNECTIONS SHALL NOT BE CONNECTED TO THE LATERAL OR MAIN LINE SEWERS SHOWN HEREON UNTIL FULL APPROVAL OF SAID LATERAL OR MAIN LINE SEWER HAS BEEN RECEIVED.
- SA-5 STORM WATER CONNECTIONS: NO FOUNDATION DRAINS, ROOF DRAINS, OR OTHER STORM WATER DRAINS OF ANY KIND SHALL BE CONNECTED INTO THE SANITARY SEWER SYSTEM.
- SA-6 TRENCH DAMS: THE CONTRACTOR SHALL PLACE A CUT OFF TRENCH DAM OF NATIVE CLAY OR IMPERVIOUS SOIL ACROSS AND ALONG THE TRENCH UPSTREAM FROM THE MAIN LINE SEWER CONNECTION TO RETARD AND RESIST THE MOVEMENT OF GROUNDWATER THROUGH THE TRENCH GRANULAR BEDDING OR BACKFILL MATERIAL. THE TRENCH DAMS SHALL BE CAREFULLY COMPACTED AND SHALL BE SIX (6) FEET IN THICKNESS AS MEASURED LONG THE SERVICE CENTER LINE AND SHALL BE CONSTRUCTED AGAINST THE UNDISTURBED TRENCH SIDES FROM THE SUBGRADE OR BOTTOM OF THE STONE FOUNDATION, WHICHEVER IS LOWER, TO THE LIMIT OF 36 INCHES OVER THE TOP OF THE PIPE, NO MORE THAN TEN (10) FEET FROM THE MAIN LINE SANITARY SEWER. SEE FAIRFIELD COUNTY STANDARD DRAWING SA.S-7 FOR THE SIX (6) INCH SANITARY SEWER SERVICE DETAIL.
- SA-7 MANHOLE SEALING: THE MANHOLE FRAME CASTING AND THE TOP OF THE MANHOLE CONE SHALL BE EXTERNALLY SEALED WITH CCI PIPELINE SYSTEMS WRAPIDSEAL MANHOLE ENCAPSULATION SYSTEM.
- SA-8 MANHOLE TOPS: WHERE MANHOLES ARE LOCATED WITHIN ROAD GRADING LIMITS, THE TOPS SHALL BE BUILT TO ELEVATIONS SHOWN ON THE APPROVED PLANS OR DIRECTED BY THE COUNTY SANITARY ENGINEER. ELSEWHERE, MANHOLES SHALL BE BUILT OR SUBSEQUENTLY ADJUSTED TO BE THREE (3) TO SIX (6) INCHES ABOVE FINAL SURFACE GRADES ESTABLISHED FOR THE DEVELOPMENT. ONLY ONE (1) PRECAST GRADE RING UP TO 6" IS ALLOWED FOR ADJUSTMENT. ANY ADJUSTMENT IN EXCESS OF 6" REQUIRES A BARREL CHANGE. ALL SANITARY MANHOLES SHALL BE BACKFILLED WITH GRANULAR MATERIAL FROM BASE TO TOP OF CONE.
- SA-9 CONSTRUCTION AND MATERIAL SPECIFICATIONS: ALL MATERIALS AND CONSTRUCTION SHALL MEET THE REQUIREMENTS OF THE CURRENT FAIRFIELD COUNTY CONSTRUCTION AND MATERIAL SPECIFICATIONS INCLUDING ALL SUPPLEMENTS THERETO. ALL SEWER PIPES SHALL BE LAID WITH STONE OR GRAVEL BACKING AS SHOWN ON STANDARD DRAWING SA.S-1. ALL PIPES SHALL BE PVC PLASTIC PIPE, ASTM D3034, SDR 35 CELL CLASSIFICATION 12454 B OR C UNLESS OTHERWISE NOTED ON THE PLANS. PIPE FOR ALL HOUSE SERVICES SHALL BE SIX (6) INCHES NOMINAL DIAMETER PVC PLASTIC SEWER PIPE, ASTM D3034, SDR 35. SERVICES SHALL BE SUBJECT TO THE INFILTRATION AND EXFILTRATION TESTS. AIR TESTING OF SANITARY SEWERS AND SERVICE LINES IS ACCEPTABLE. ALL SERVICE EXTENSIONS SHALL BE LAID AT A MINIMUM GRADE OF 1/4 INCH PER FOOT (2.08%).

WHERE THE SANITARY SEWER CROSSES UNDER A PROPOSED STORM SEWER, THE TRENCH SHALL BE BACKFILLED TO THE BOTTOM OF THE PROPOSED STORM SEWER WITH COMPACTED GRANULAR MATERIAL MEETING ODOT ITEM 304, TEN (10) FEET CENTERED ON THE STORM SEWER.

WHERE THE SANITARY SEWER CROSSES A PROPOSED STREET OR ROAD, THE TRENCH BACKFILL SHALL BE COMPACTED GRANULAR MATERIAL. ODOT ITEM 304. FROM THE BOTTOM OF THE TRENCH TO A PLANE SIX (6) INCHES BELOW THE SUBGRADE. THE LIMITS OF PLACEMENT SHALL BE FROM THE RIGHT-OF-WAY LINE TO THE RIGHT-OF-WAY LINE. ALL OTHER TRENCH BACKFILL SHALL BE COMPACTED TYPE C BACKFILL, UNLESS OTHERWISE NOTED ON THE PLANS. THE COST OF BACKFILL IS TO BE INCLUDED IN THE PRICE BID FOR THE VARIOUS SEWER ITEMS.

ALL MANHOLES SHALL HAVE NEENAH R-1762 FRAMES WITH SELF-SEALING LIDS MARKED "SANITARY SEWER". MANHOLES LOCATED WITHIN 100 YEAR FLOOD PLAINS, OR WHERE FLOODING COULD OCCUR, SHALL HAVE NEENAH R-1915-H FRAME WITH BOLT DOWN SEALED LIDS MARKED "SANITARY SEWER". ALL MANHOLES SHALL HAVE POLYPROPYLENE STEPS TO WITHIN ONE (1) FOOT OF THE TOP OF THE MANHOLE. ALL MANHOLE RINGS SHALL BE CONCRETE, SEALED TO PRECAST CHIMNEY SECTIONS WITH SEALER APPROVED BY THE CVILLAGE OF LITHOPOLIS. BRICK RISERS ARE NOT ACCEPTABLE.

GREEN METALLIC FIELD LOCATOR TAPE OF SIX (6) INCH WIDTH SHALL BE PLACED OVER ALL SANITARY SEWER AND FORCE MAIN LINES, WITHIN 12 TO 18 INCHES OF FINISHED GRADE. FOURTEEN GAUGE TRACER WIRE SHALL ALSO BE INSTALLED ON ALL SANITARY FORCE MAINS.

SA-10 PRESSURE SEWER MATERIAL STANDARDS: ALL MATERIALS UTILIZED IN THE CONSTRUCTION OF FORCE MAIN PRESSURE SEWER IN THIS PROJECT SHALL CONFORM TO THE LATEST REVISION OF THE APPROPRIATE STANDARDS AS FOLLOWS:

HDPE: DR11, AWWA C906 PC 350, AWWA C151 JOINT: HDPE: **ASTM F2620** AWWA C111 INSTALLATION: HDPE: ASTM D2321

AWWA C600

GRAVITY SEWER MATERIAL STANDARDS: ALL MATERIALS UTILIZED IN THE CONSTRUCTION OF GRAVITY SEWER IN THIS PROJECT SHALL CONFORM TO THE LATEST REVISION OF THE APPROPRIATE STANDARDS AS FOLLOWS:

SDR35, ASTM D3034 **ASTM D3212**

INSTALLATION: HDPE: ASTM D2321

Sheet

Number

17

19

21

22

23

1	COVER SHEET
2	GENERAL NOTES
3	OVERALL SHEET LAYOUT
4	FORCE MAIN PLAN & PROFILE - 0+00 - 5+00
5	FORCE MAIN PLAN & PROFILE - 5+00 - 10+00
6	FORCE MAIN PLAN & PROFILE - 10+00 - 15+00
7	FORCE MAIN PLAN & PROFILE - 15+00 - 20+00
8	FORCE MAIN PLAN & PROFILE - 20+00 - 25+00
9	FORCE MAIN PLAN & PROFILE - 25+00 - 30+00
10	FORCE MAIN PLAN & PROFILE - 30+00 - 35+00
11	FORCE MAIN PLAN & PROFILE - 35+00 - 40+00
12	FORCE MAIN PLAN & PROFILE - 40+00 - 45+00
13	FORCE MAIN PLAN & PROFILE - 45+00 - 50+00
14	FORCE MAIN PLAN & PROFILE - 50+00 - 55+00
15	FORCE MAIN PLAN & PROFILE - 55+00 - 60+00
16	FORCE MAIN PLAN & PROFILE - 60+00 - 65+00

Sheet List Table

Sheet Title

FORCE MAIN PLAN & PROFILE - 65+00 - 68+95

PUMP STATION SITE PLAN

PUMP STATION DETAILS

CONSTRUCTION DETAILS

CONSTRUCTION DETAILS

ELECTRICAL LEGEND & GENERAL NOTES

ELECTRICAL DETAILS



FORCE MAIN INTERCONNECT	ISSUE DATE: 9/4/25	1	REVISED PER OEPA COMMENTS	7/16/2025	
ILLAGE OF LITHOPOLIS, FAIRFIELD COUNTY, OHIO -	SCALE: AS NOTED	2	REVISED PER OEPA COMMENTS	7/30/2025	
	DESIGNED BY: BRA	က	REVISED PER OEPA COMMENTS	9/4/2025	
GENERAL NOTES	DRAWN BY: AGD				
	CHECKED BY: BRA				

PROJECT NO.

241569


DISCIPLINE


GENERAL

SHEET NAME

GEN-NTS



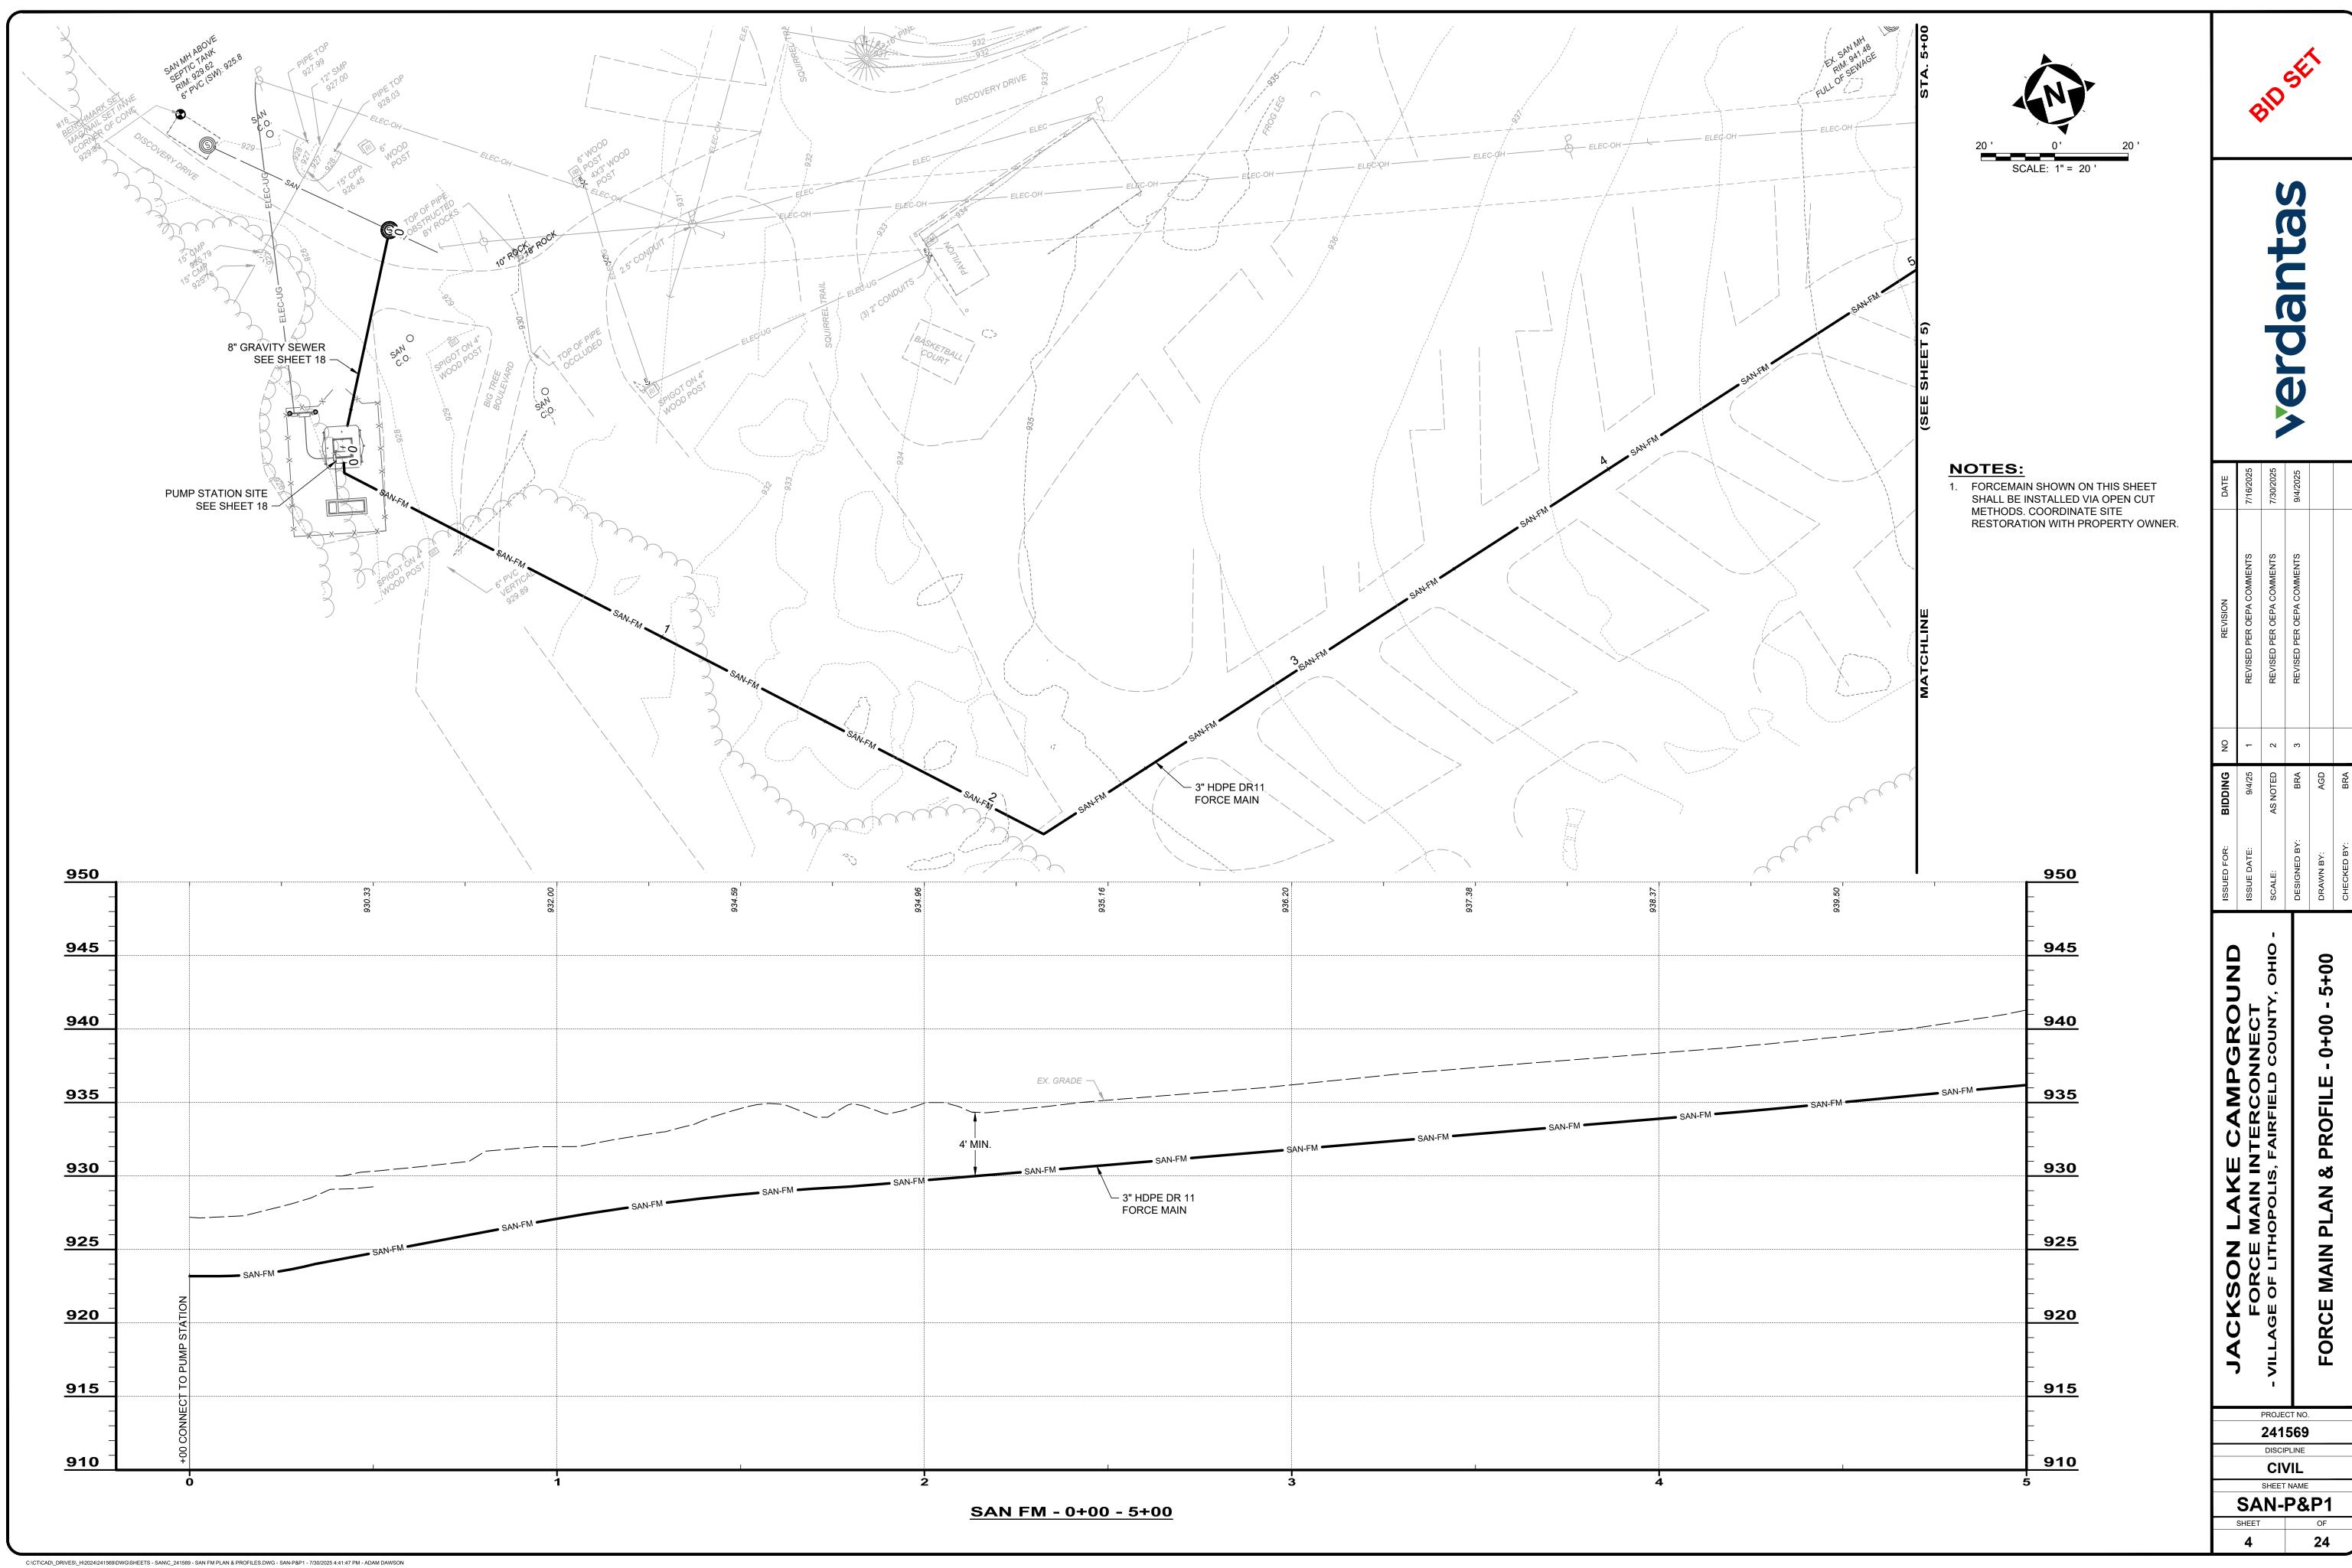

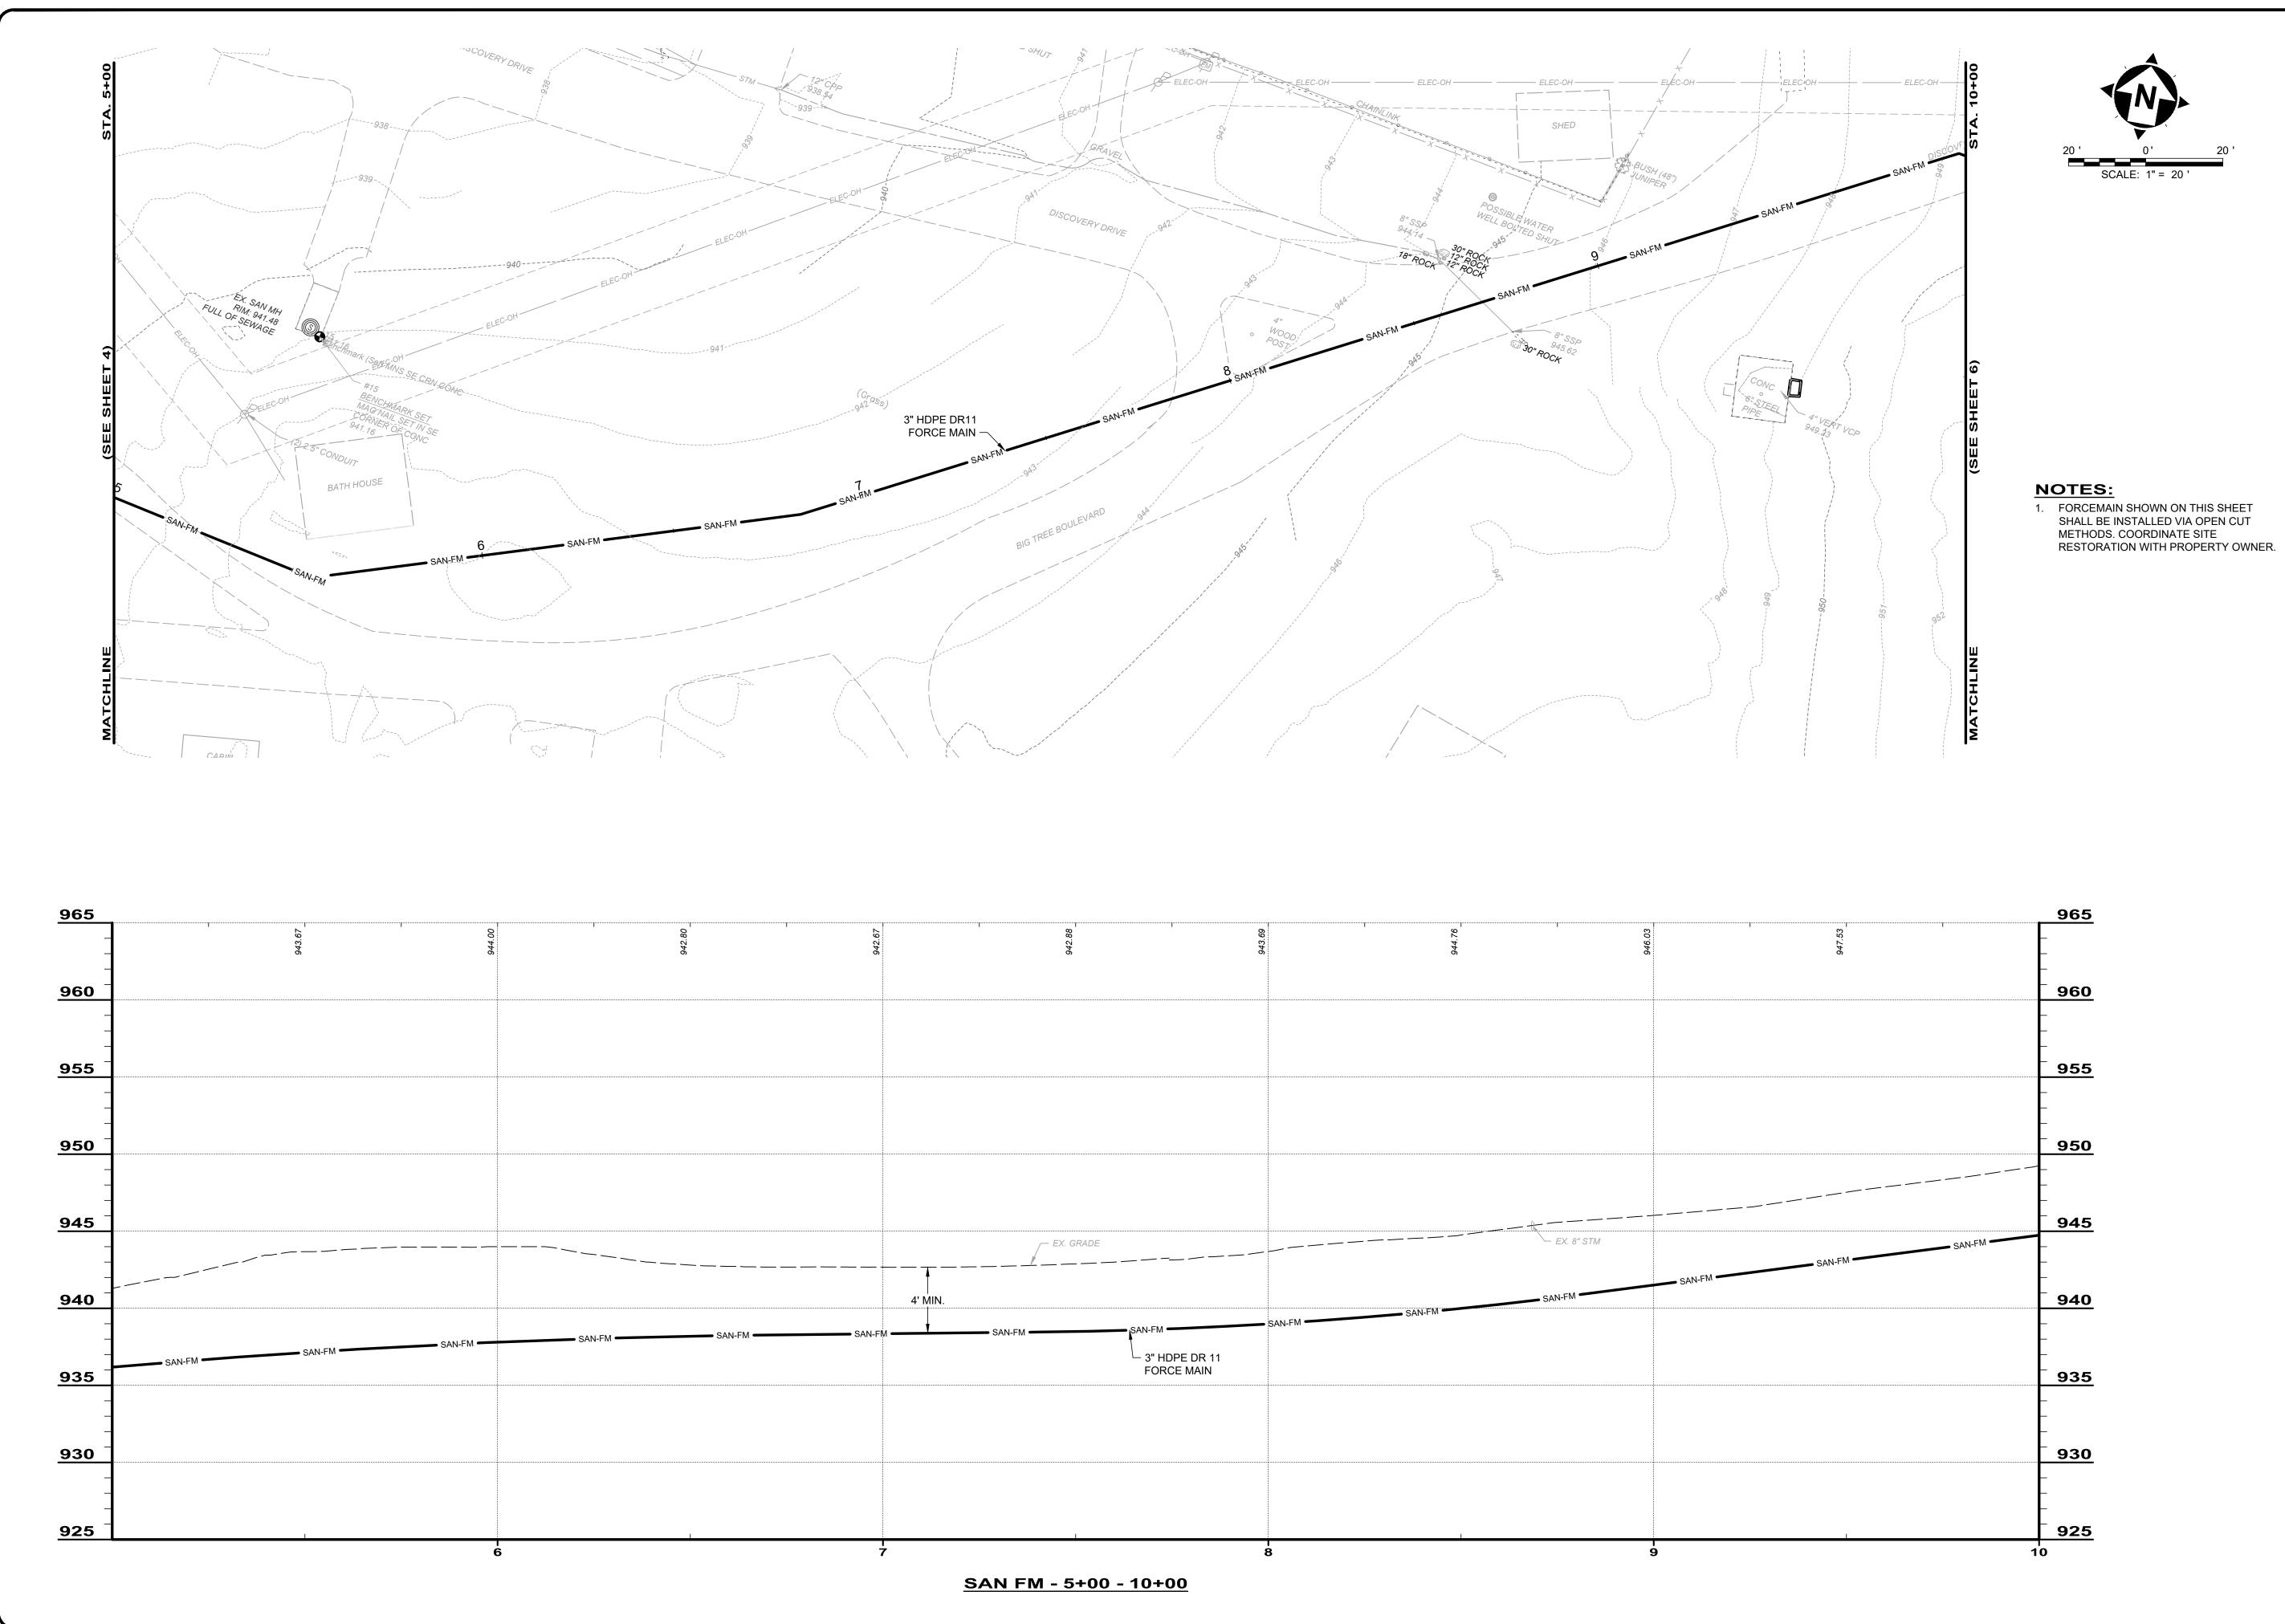



verdant

EPA COMMENTS 7/30/2025

EPA COMMENTS 9/4/2025

FORCE MAIN INTERCONNECT

- VILLAGE OF LITHOPOLIS, FAIRFIELD COUNTY, OHIO
SCALE:

90 IN TERCONNECT

SCALE:

PESIGN

PESIGN

PERIOR MAIN PLAN & PROFILE - 5+00 - 10+00

CHECK


CHECK

SAN-P&P2

SHEET OF

DISCIPLINE

CIVIL SHEET NAME

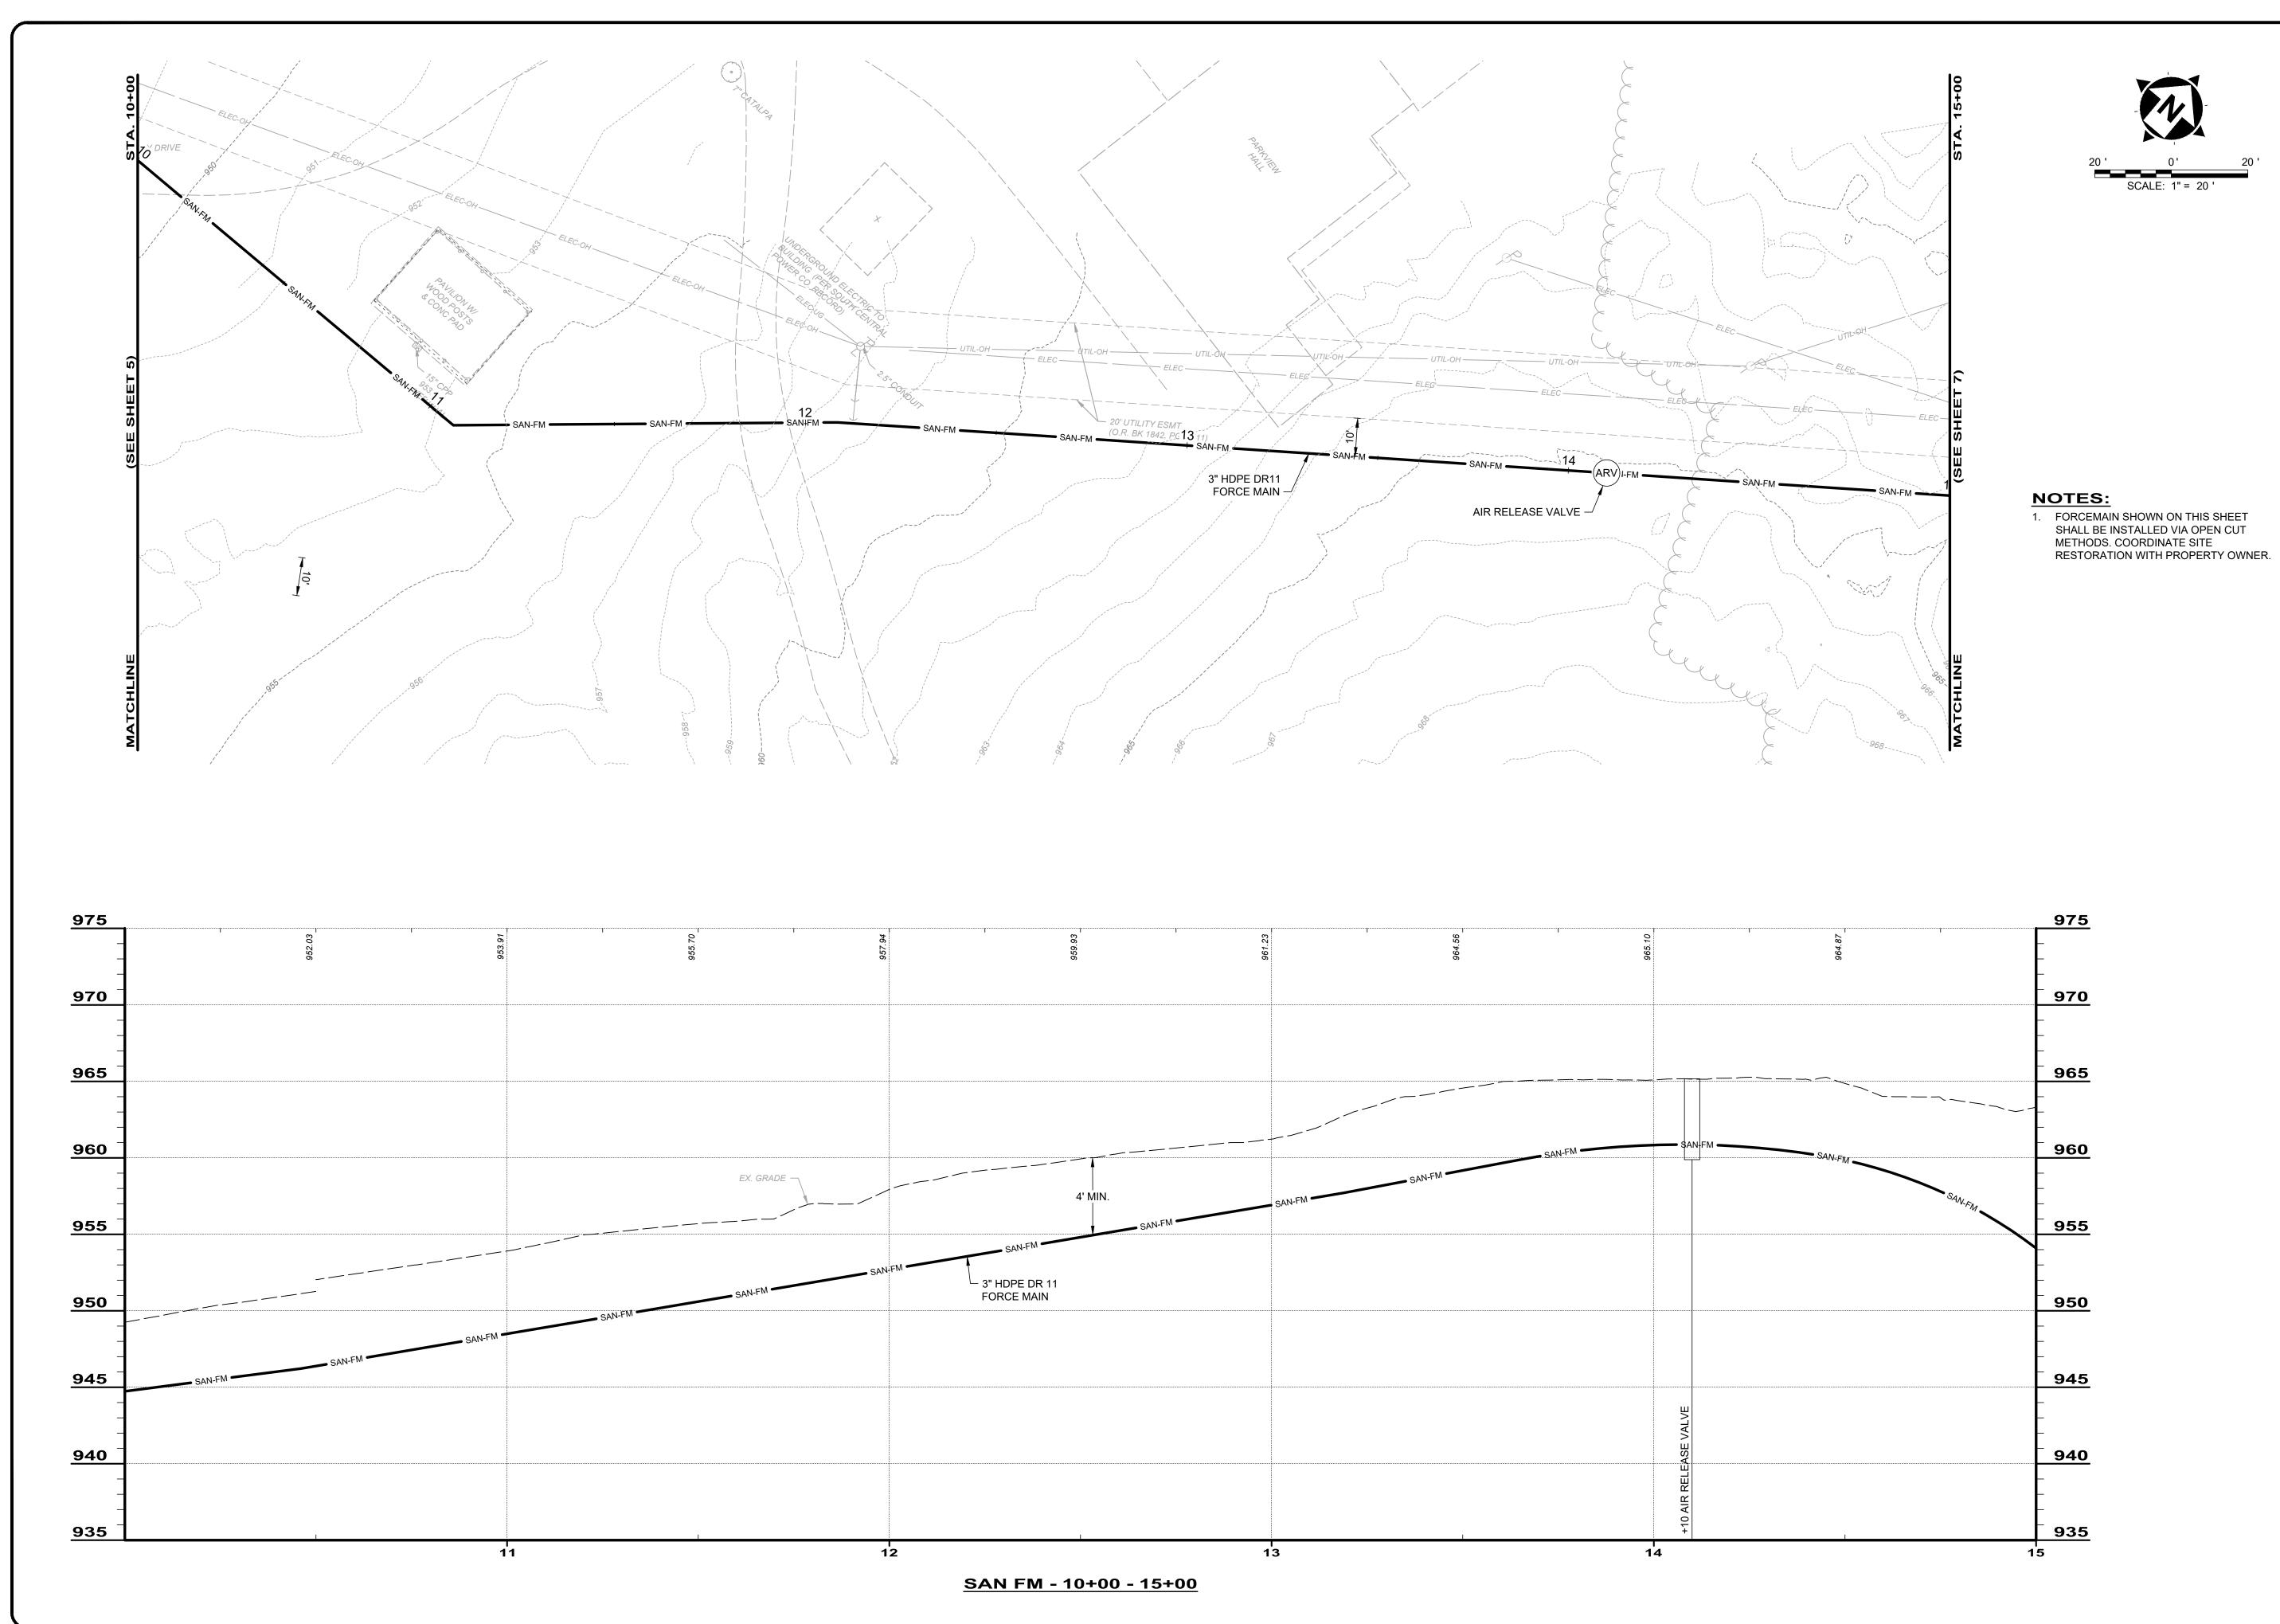



verdant

/4/25	1	REVISED PER OEPA COMMENTS	7/16/2025
тер	2	REVISED PER OEPA COMMENTS	7/30/2025
BRA	8	REVISED PER OEPA COMMENTS	9/4/2025
AGD			
V 0 0			


FORCE MAIN INTERCONNECT	881
//////////////////////////////////////	SC
	DE
ORCE MAIN PLAN & PROFILE - 10+00 - 15+00	DR

CIVIL
SHEET NAME
SAN-P&P3
SHEET OF

PROJECT NO.

241569

DISCIPLINE

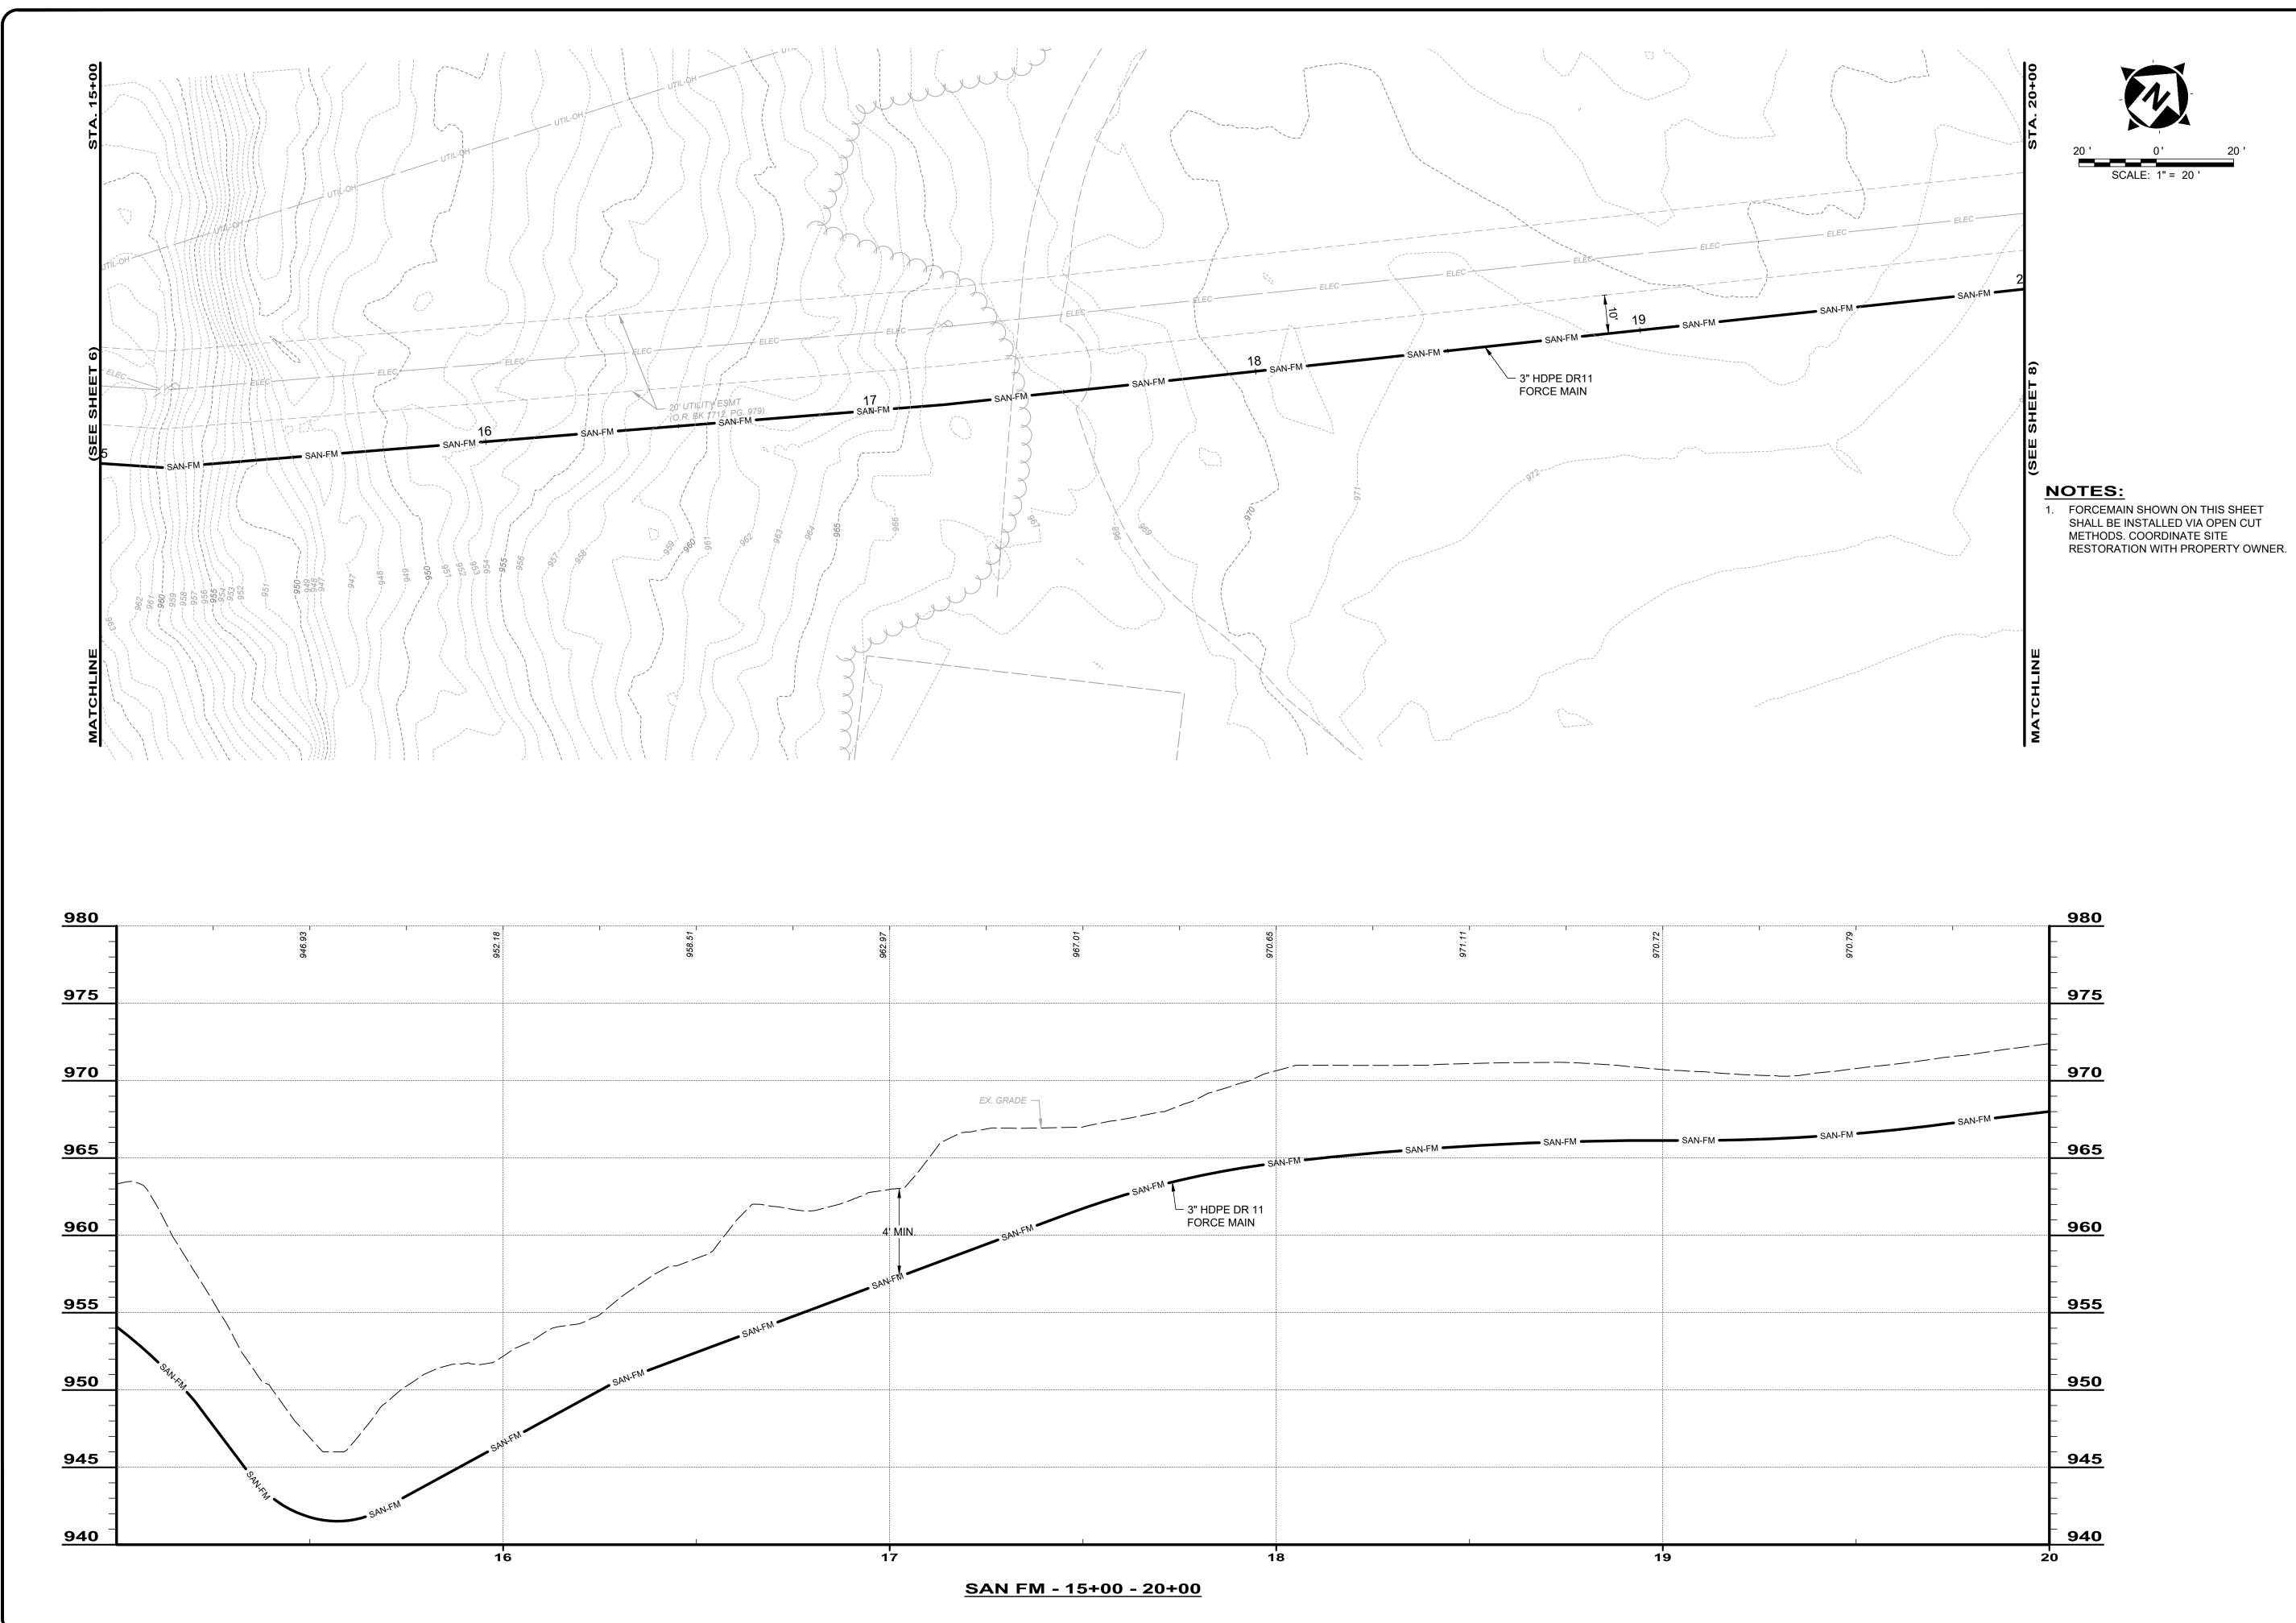





2025 **VED DOIN** 2025 **VED DOIN** 2025


FORCE MAIN PLAN & PROFILE - 15+00 - 20+00

DISCIPLINE

CIVIL
SHEET NAME
SAN-P&P4

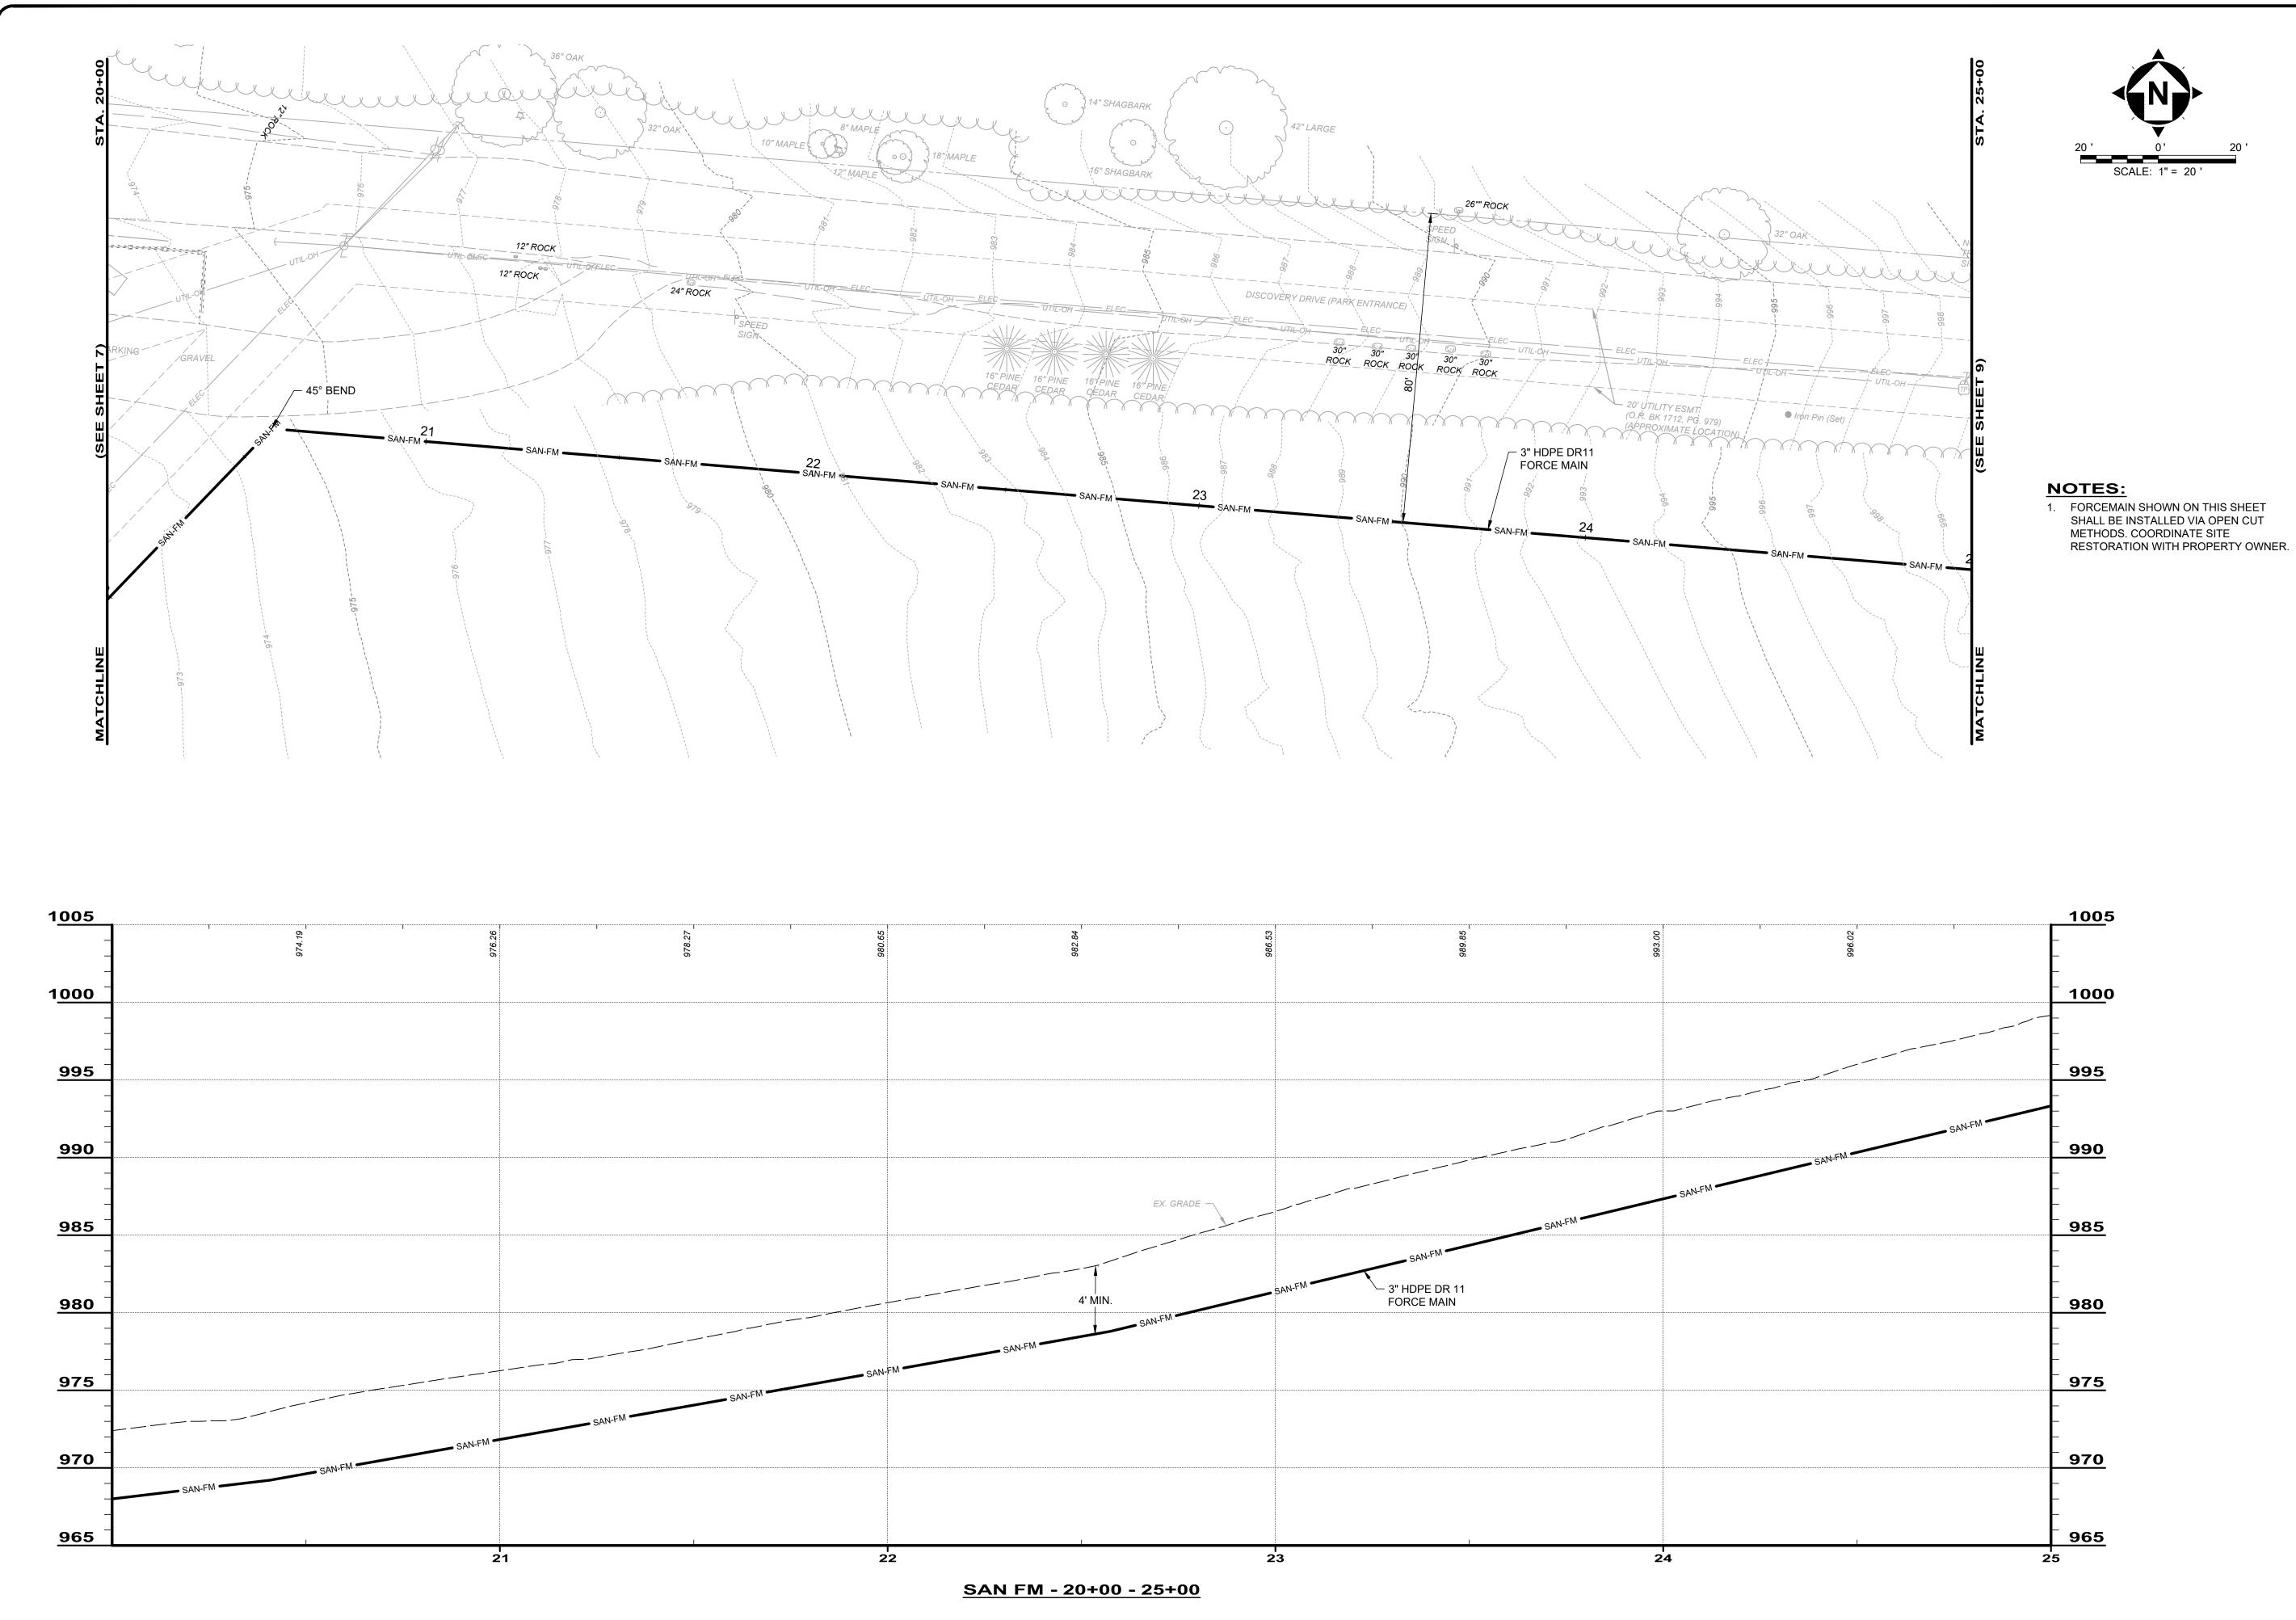

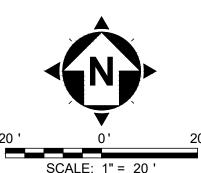

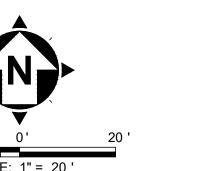




38
ant
6 10

			L L	30/4/0	~
		FORCE MAIN INTERCONNECT	ISSUE DATE:	9/4/25	_
DISCI		- VILLAGE OF LITHOPOI	SCALE:	AS NOTED	2
PLINE	ст NO. 569		DESIGNED BY:	BRA	က
		FORCE MAIN PLAN & PROFILE - 20+00 - 25+00	DRAWN BY:	AGD	
			CHECKED BY:	BRA	

SHEET NAME SAN-P&P5

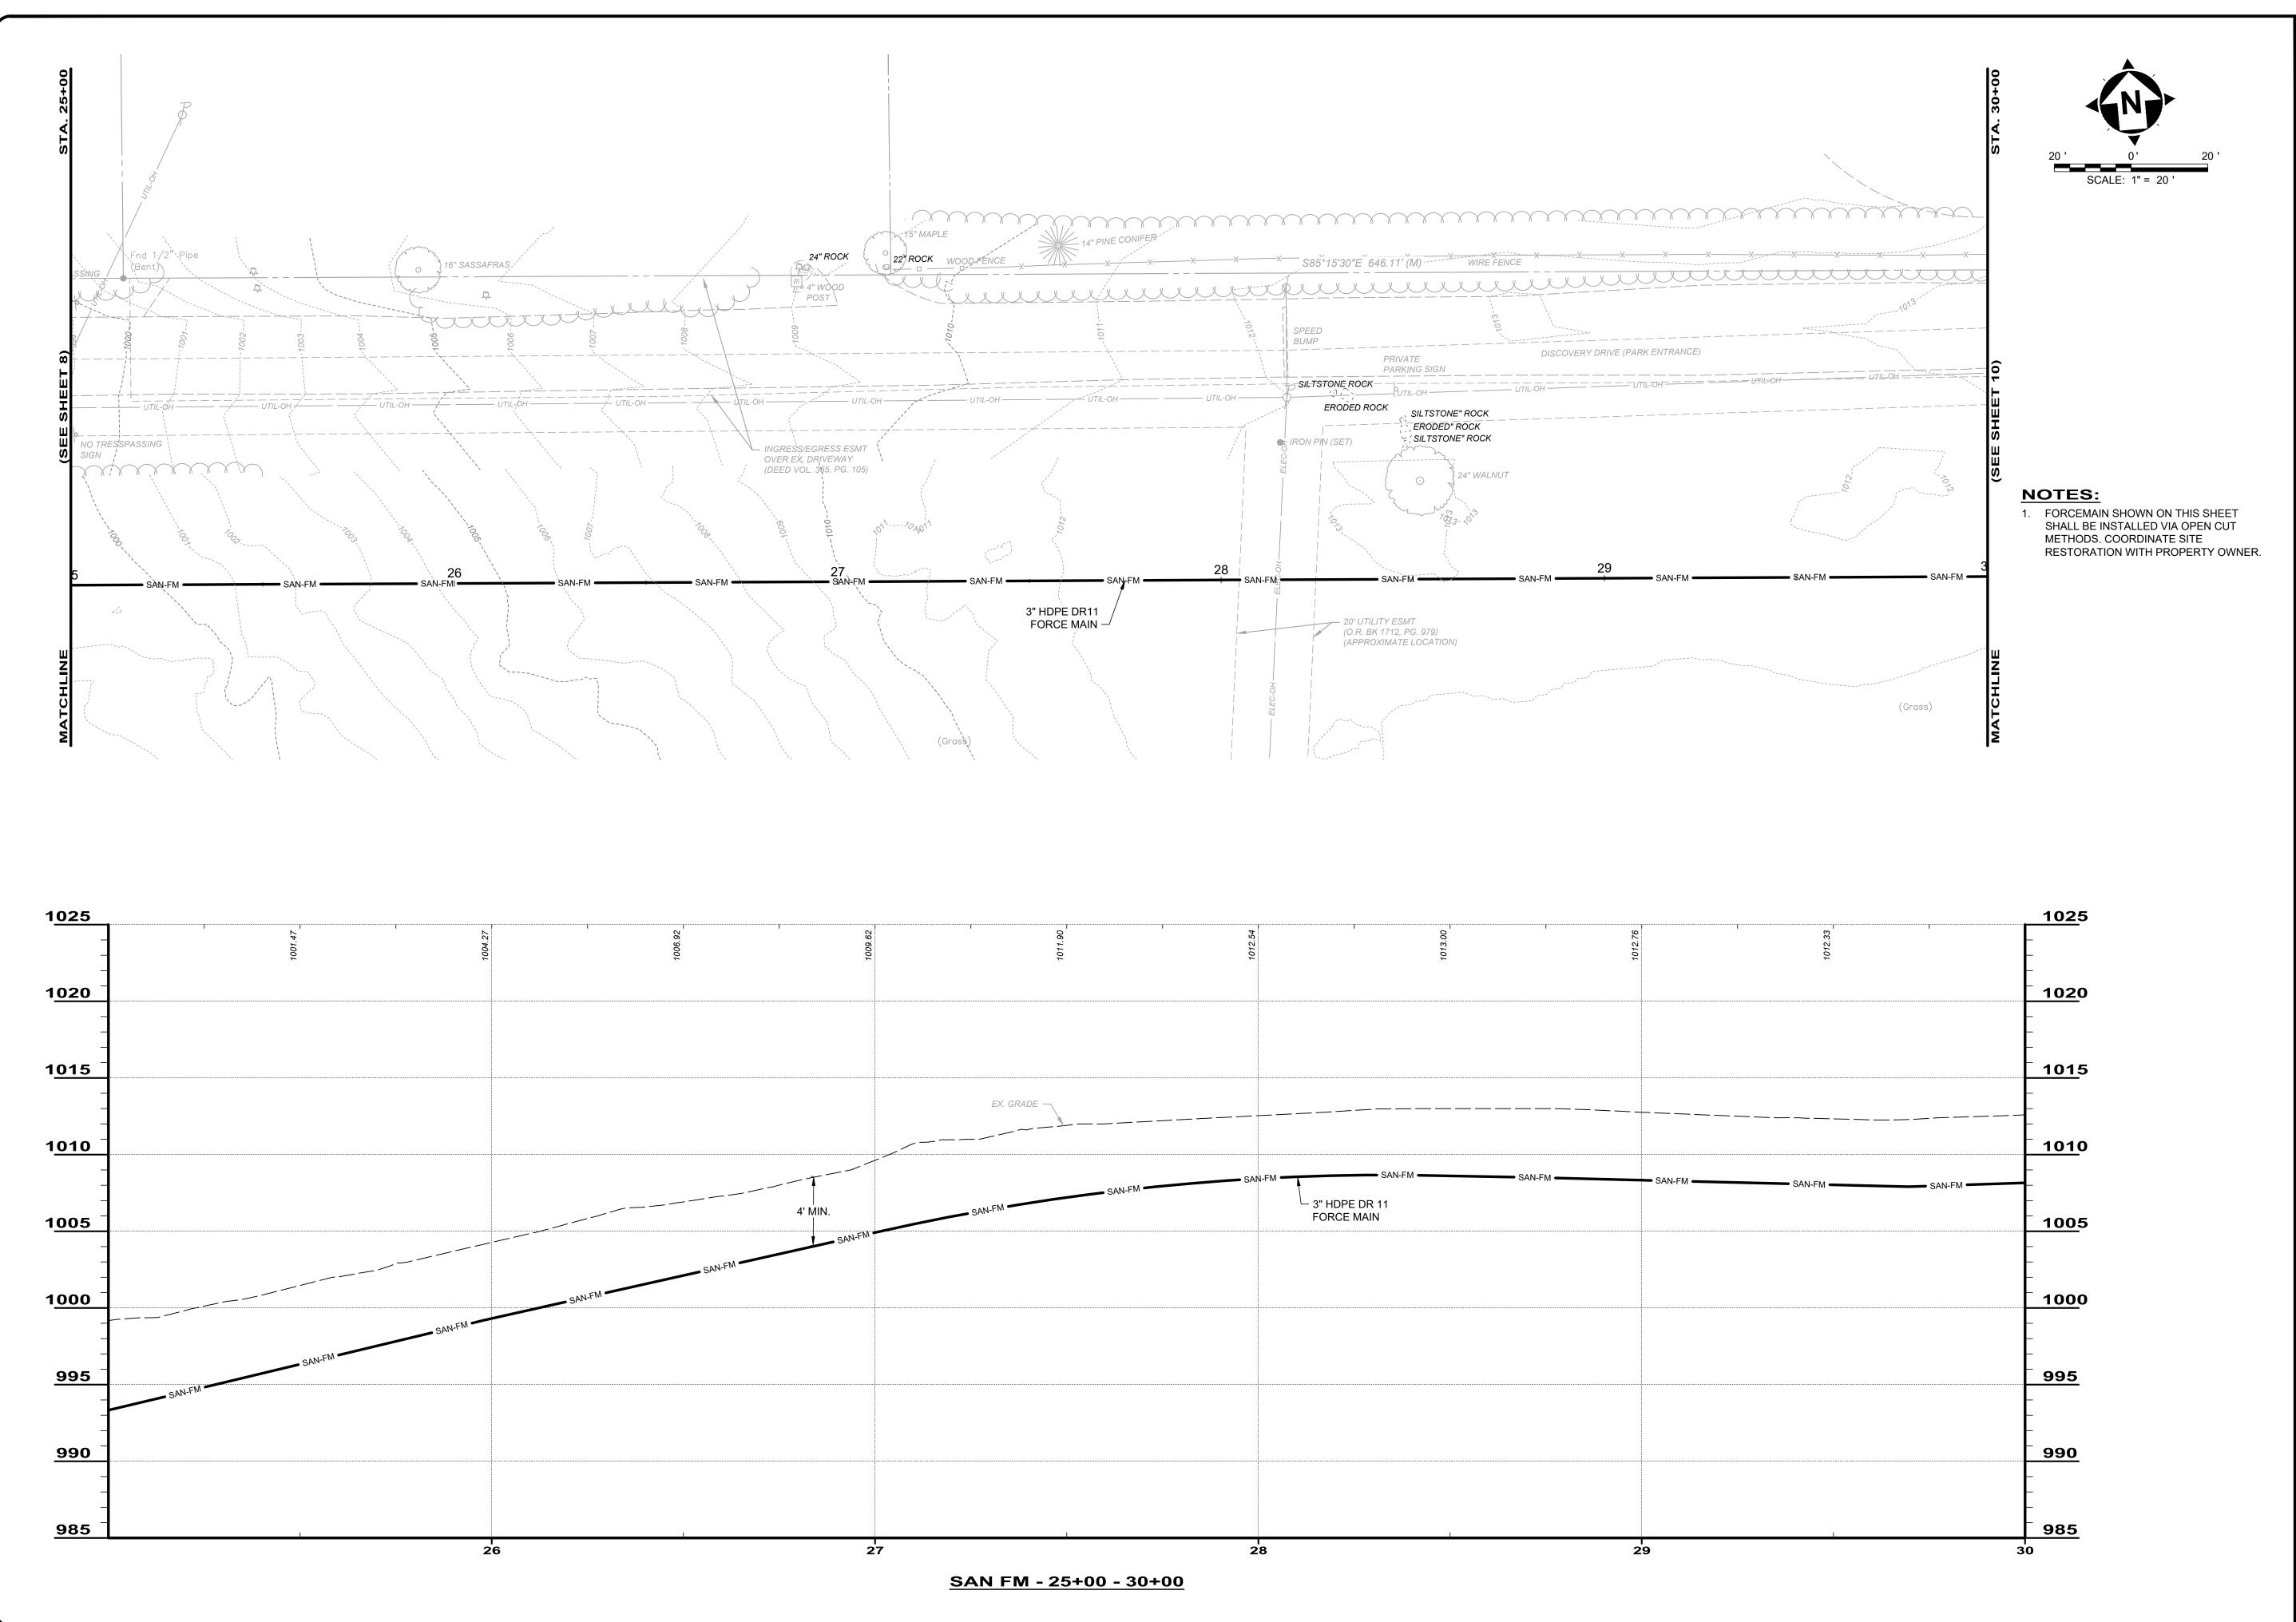



verdanta

 25
 1
 REVISED PER OEPA COMMENTS
 7/16/2025

 ED
 2
 REVISED PER OEPA COMMENTS
 7/30/2025

 RA
 3
 REVISED PER OEPA COMMENTS
 9/4/2025

 SD
 9/4/2025

FORCE MAIN INTERCONNECT

AGE OF LITHOPOLIS, FAIRFIELD COUNTY, OHIO
DESIGN


PROJECT NO.

241569


DISCIPLINE

CIVIL

SAN-P&P6
SHEET OF

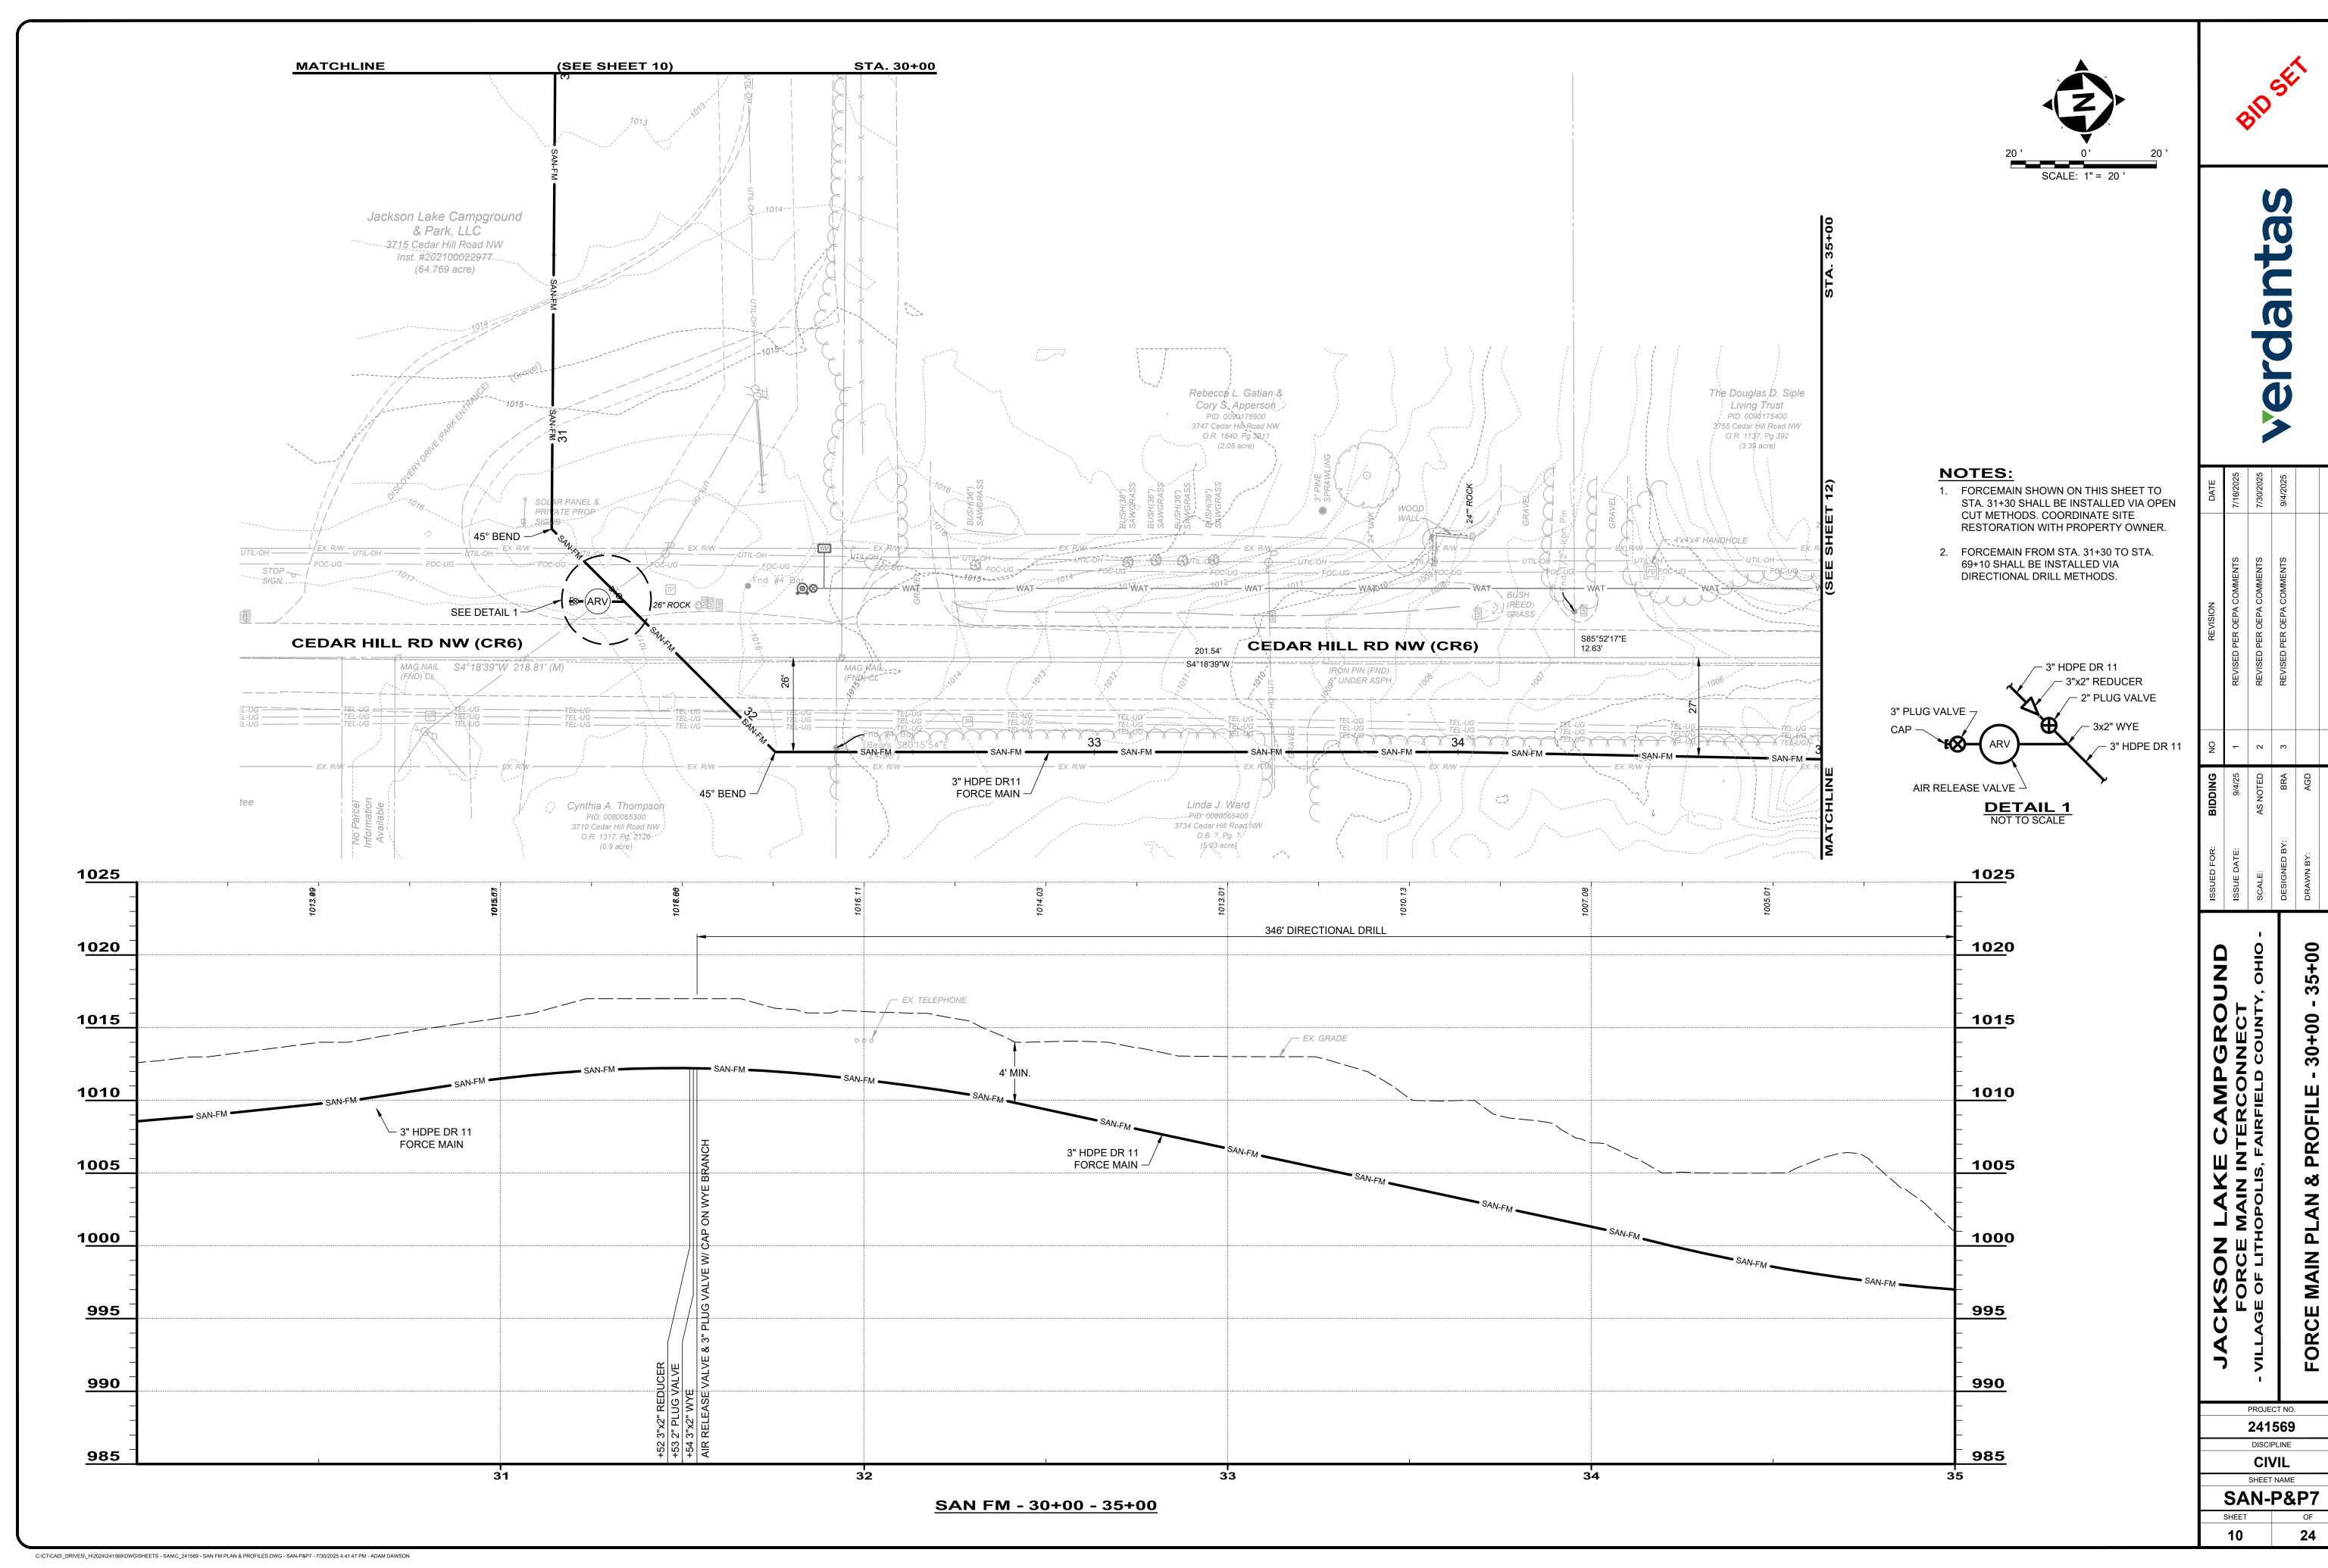

	ISSUE DATE:	9/4/25	_	REVISED PER OEP
- ОНІО -	SCALE:	AS NOTED	2	REVISED PER OEP,
	DESIGNED BY:	BRA	е	REVISED PER OEP,
- 35+00	DRAWN BY:	AGD		
	CHECKED BY:	BRA		

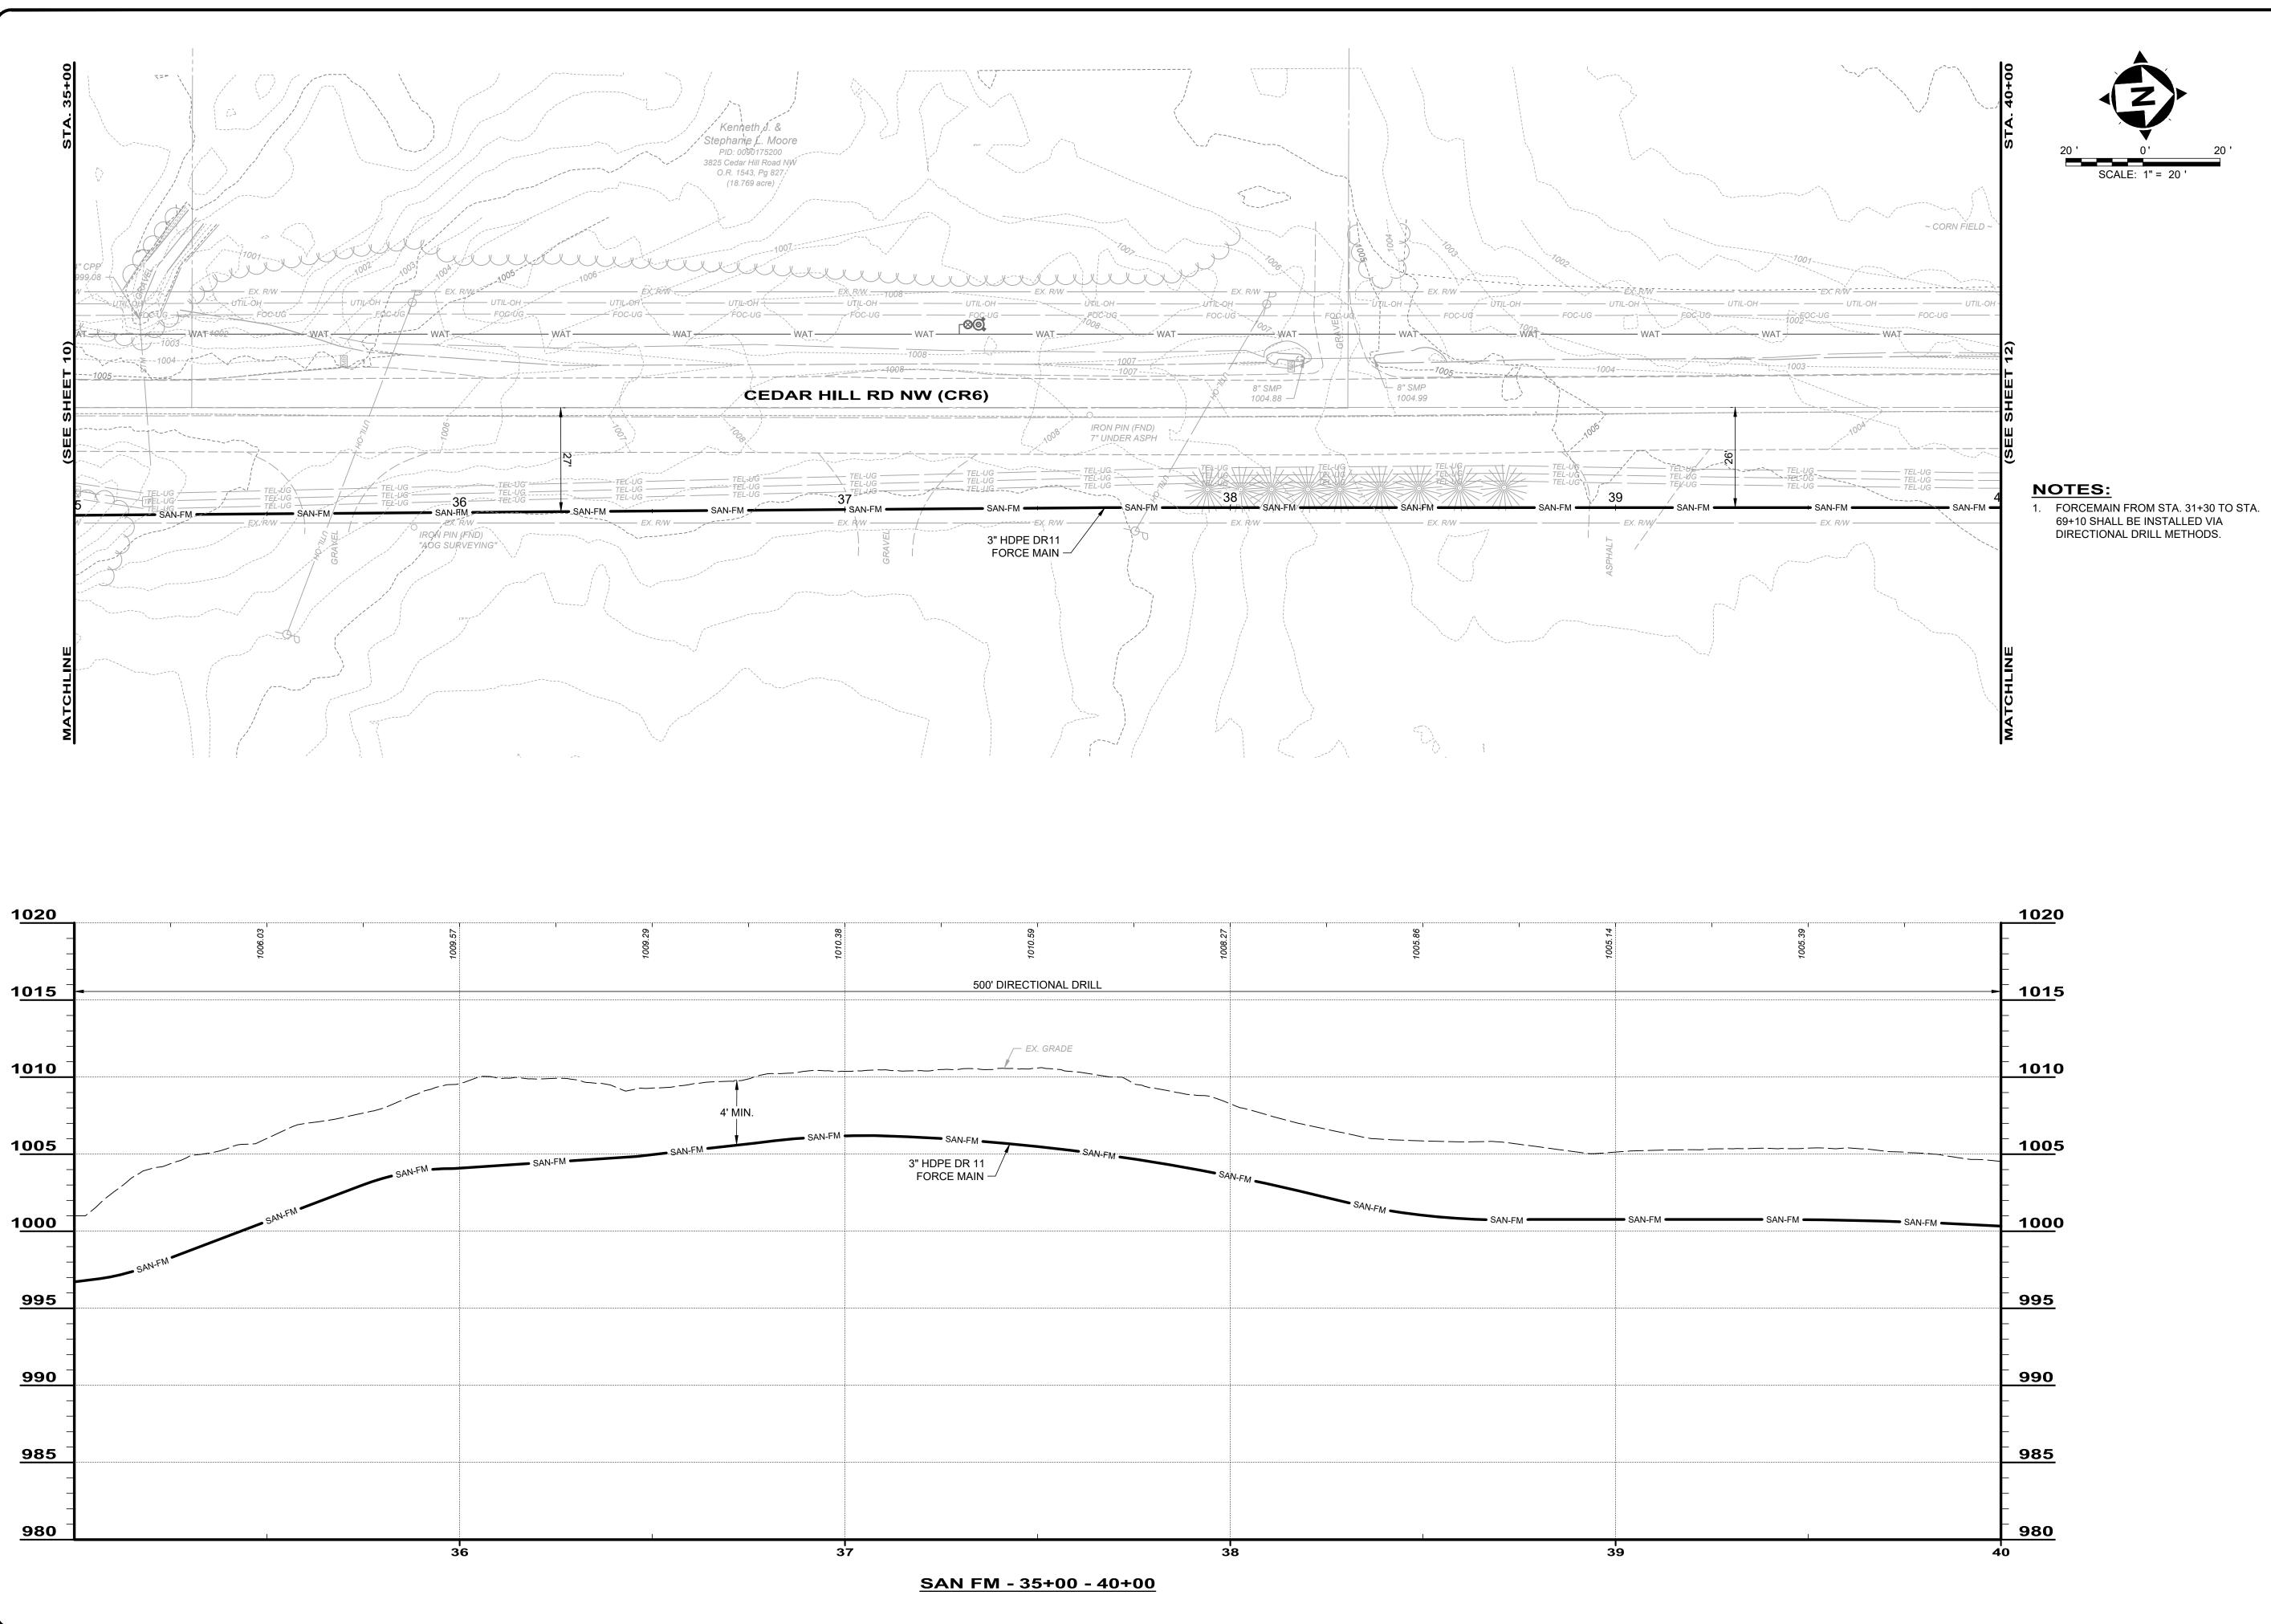



erdanta

PROJECT NO.

241569

DISCIPLINE


CIVIL

SHEET NAME

SAN-P&P8

SHEET OF

11 24

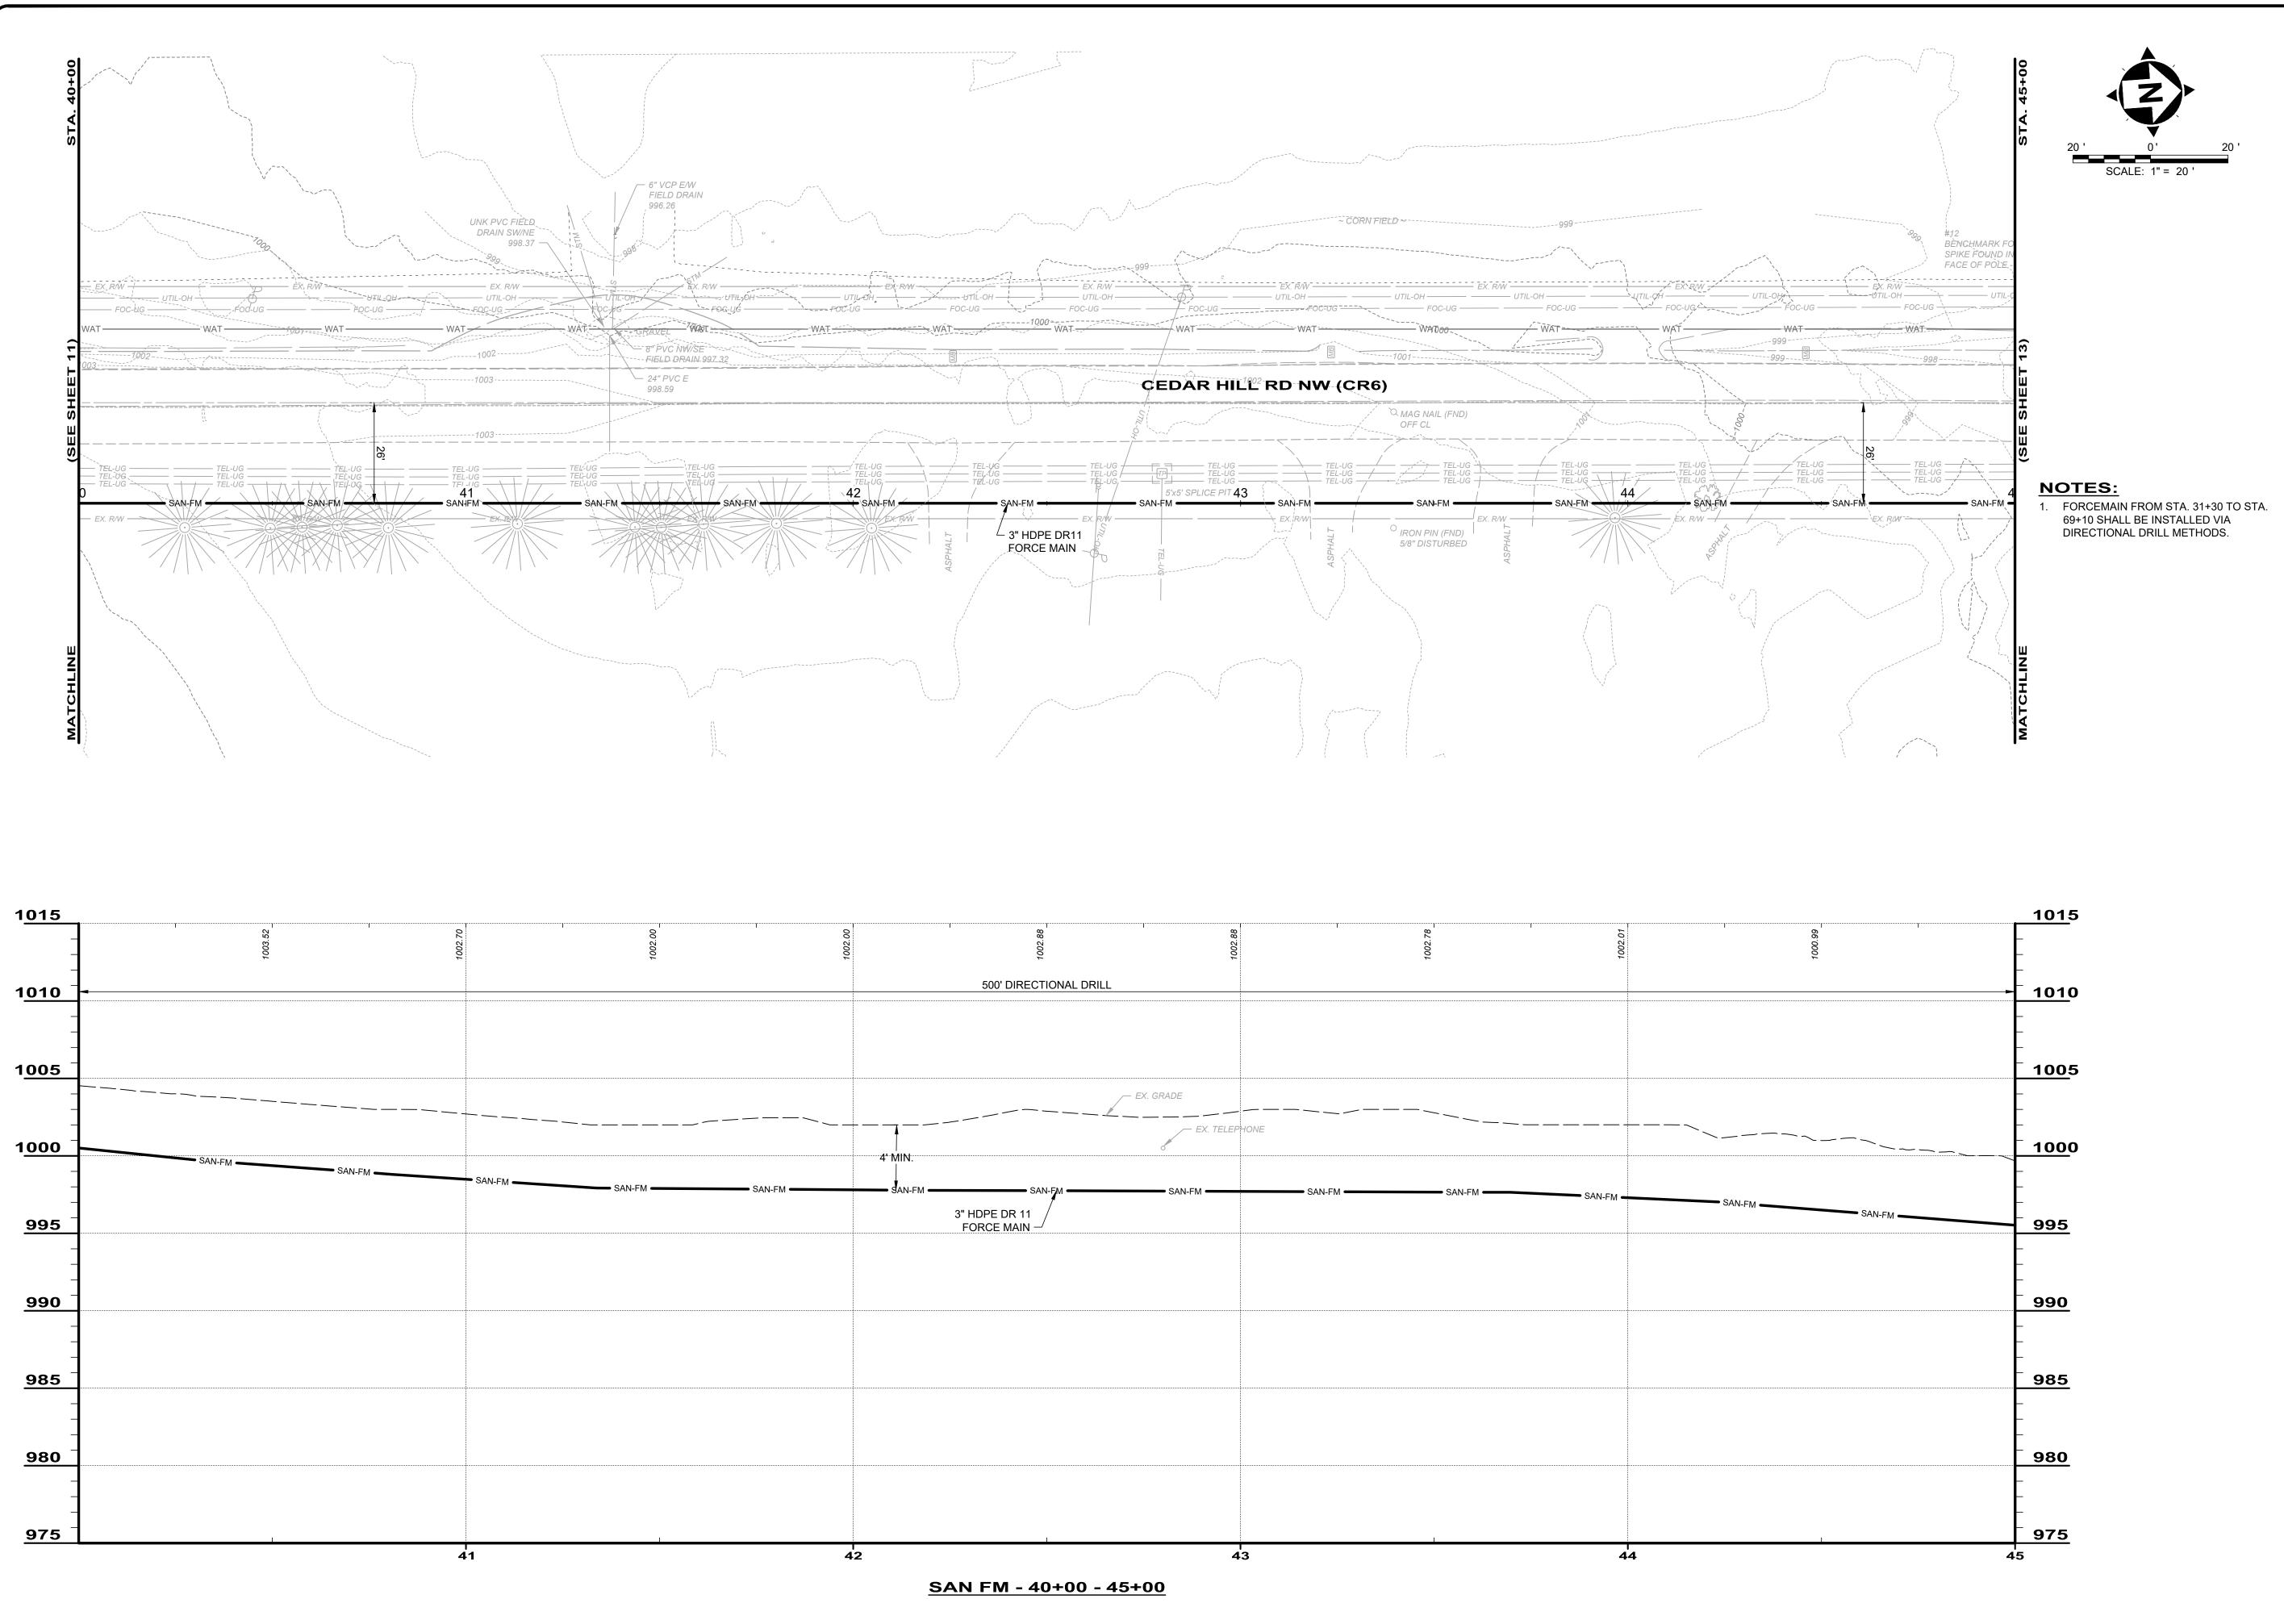



verdanta

PER OEPA COMMENTS 7/16/2025
PER OEPA COMMENTS 7/30/2025
PER OEPA COMMENTS 9/4/2025

FORCE MAIN INTERCONNECT

-VILLAGE OF LITHOPOLIS, FAIRFIELD COUNTY, OHIO
PESIGNED BY:

PORCE MAIN PLAN & PROFILE - 40+00 - 45+00


PROJECT NO.

241569

DISCIPLINE

CIVIL


SAN-P&P9
SHEET OF

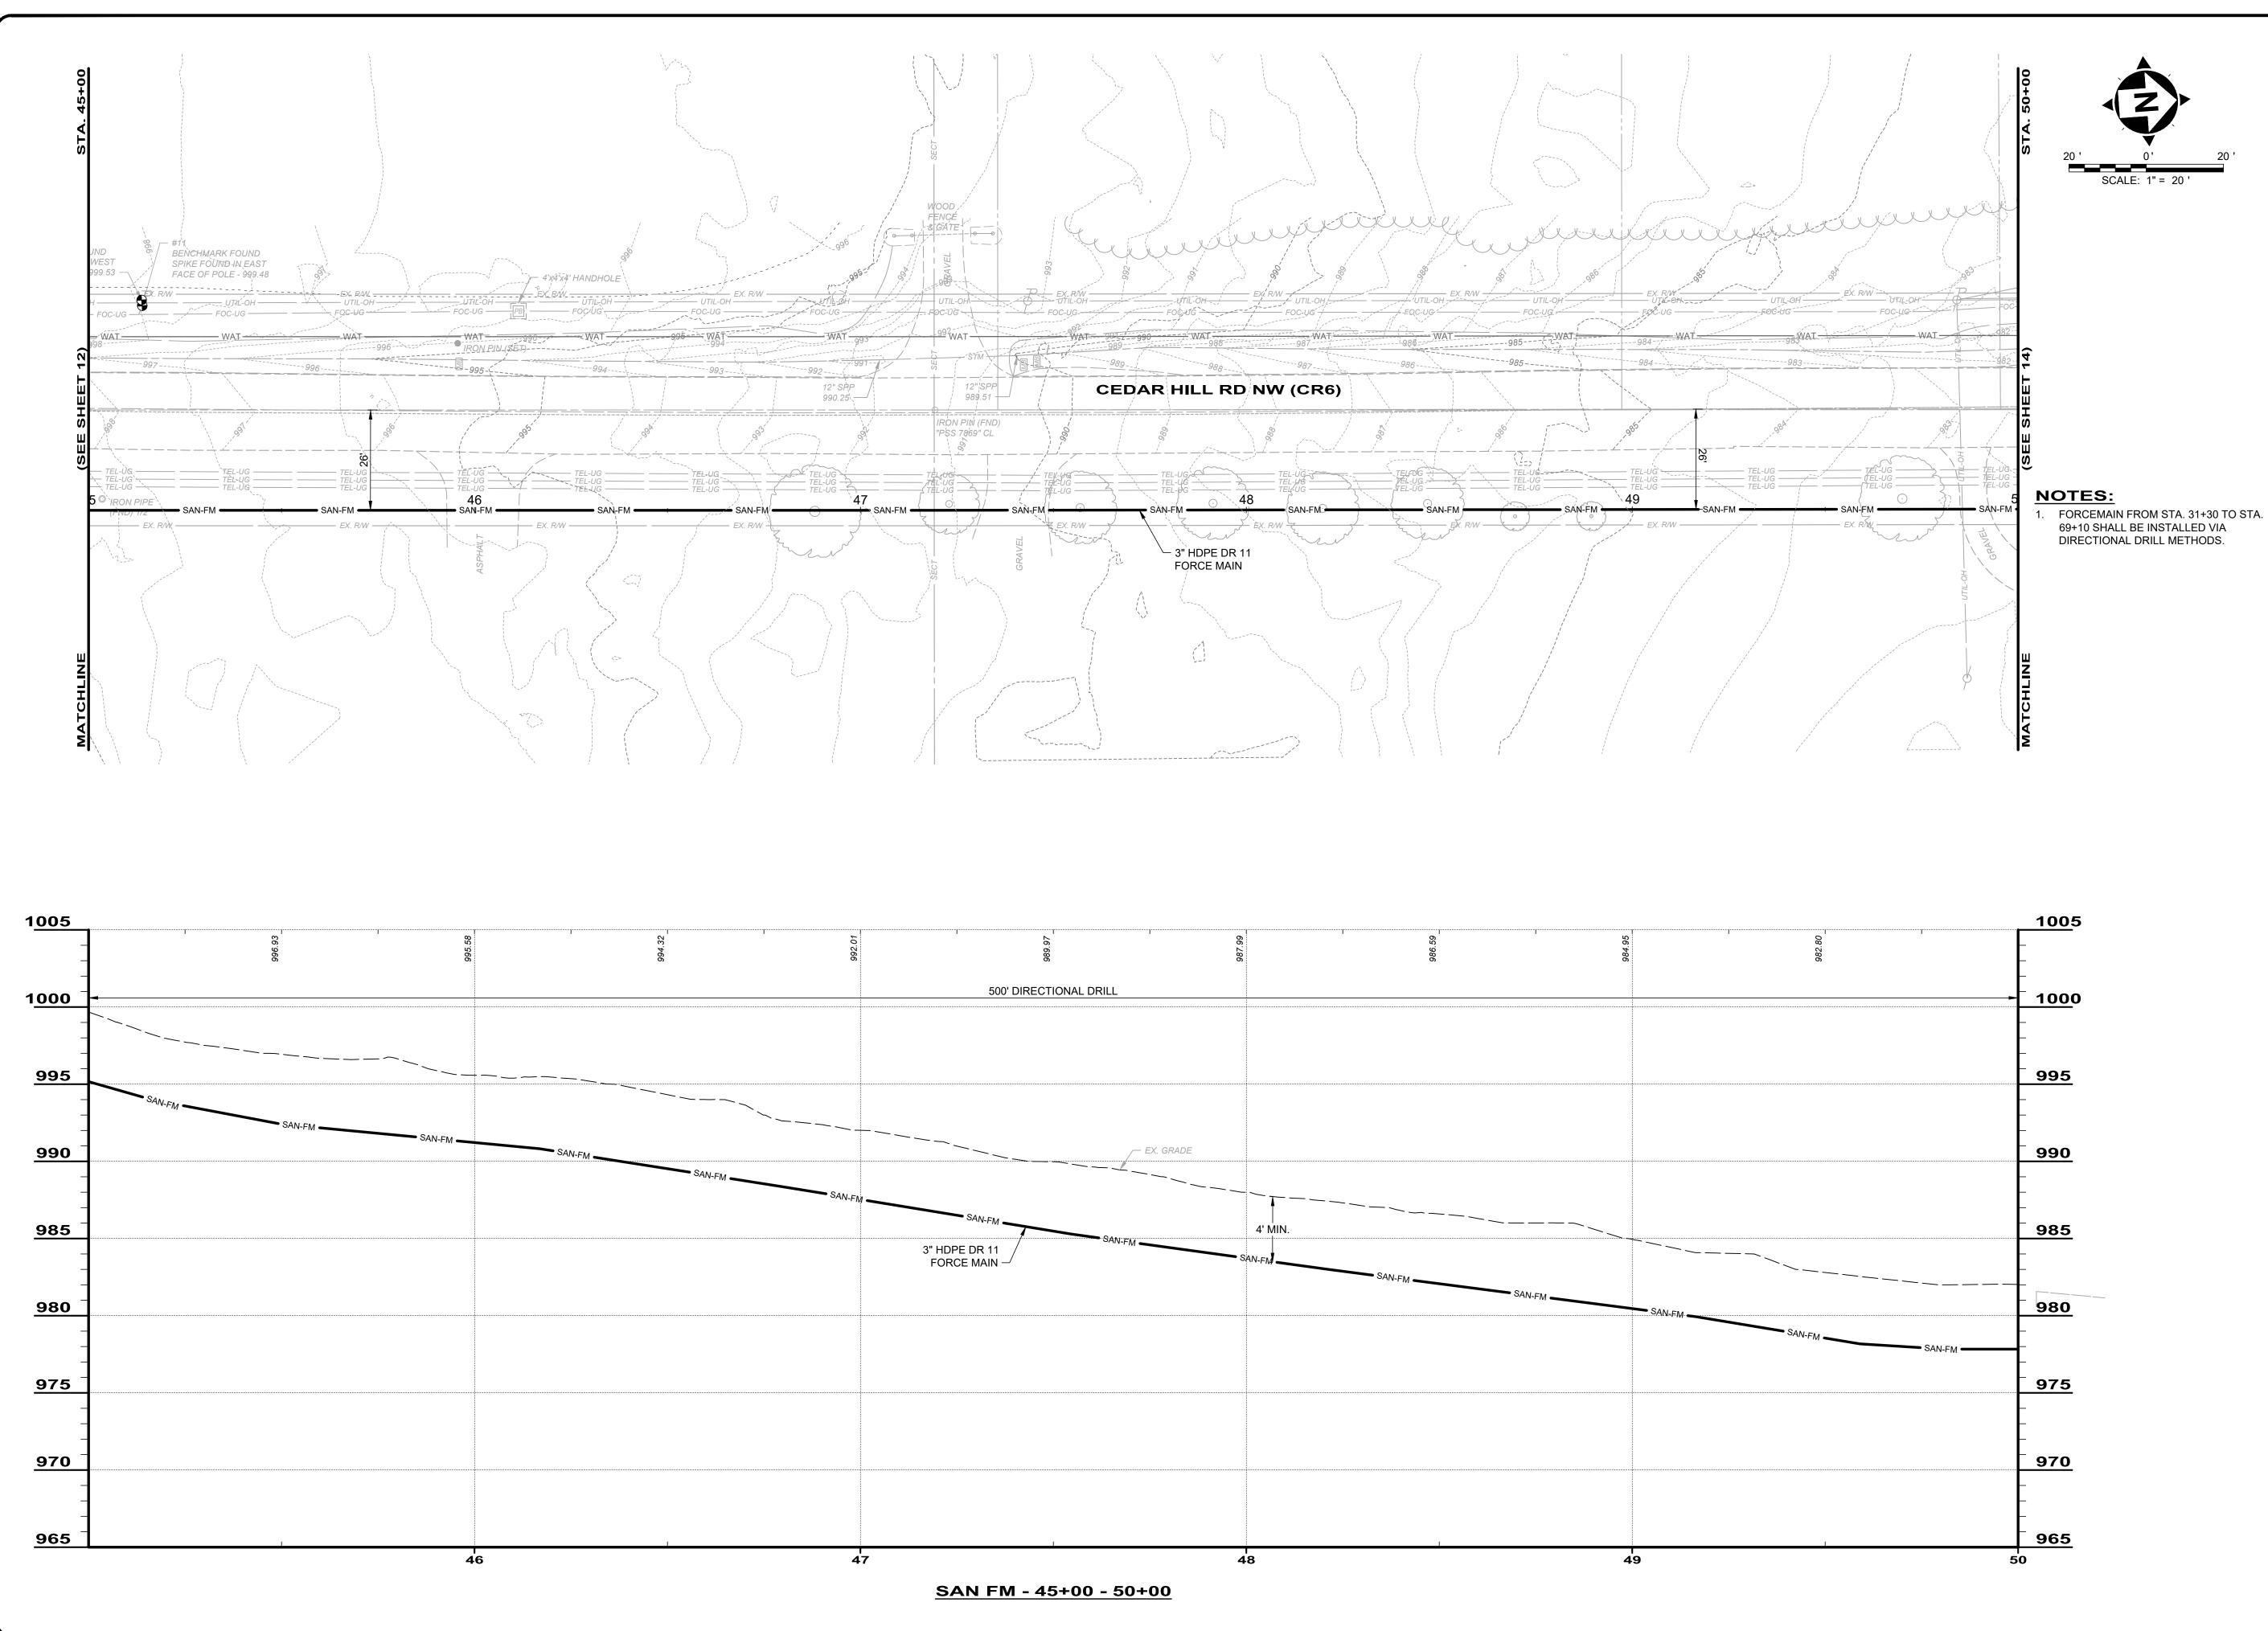



	LACKSON LAKE CAMPGROUND	ISSUED FOR:		NO
	FORCE MAII	ISSUE DATE:	9/4/25	~
PROJE 241 DISCII	- VILLAG	SCALE:	AS NOTED	2
569		DESIGNED BY:	BRA	က
	FORCE MAIN PLAN & PROFILE - 45+00 - 50+00	DRAWN BY:	AGD	
		CHECKED BY:	BRA	

CIVIL SHEET NAME SAN-P&P10

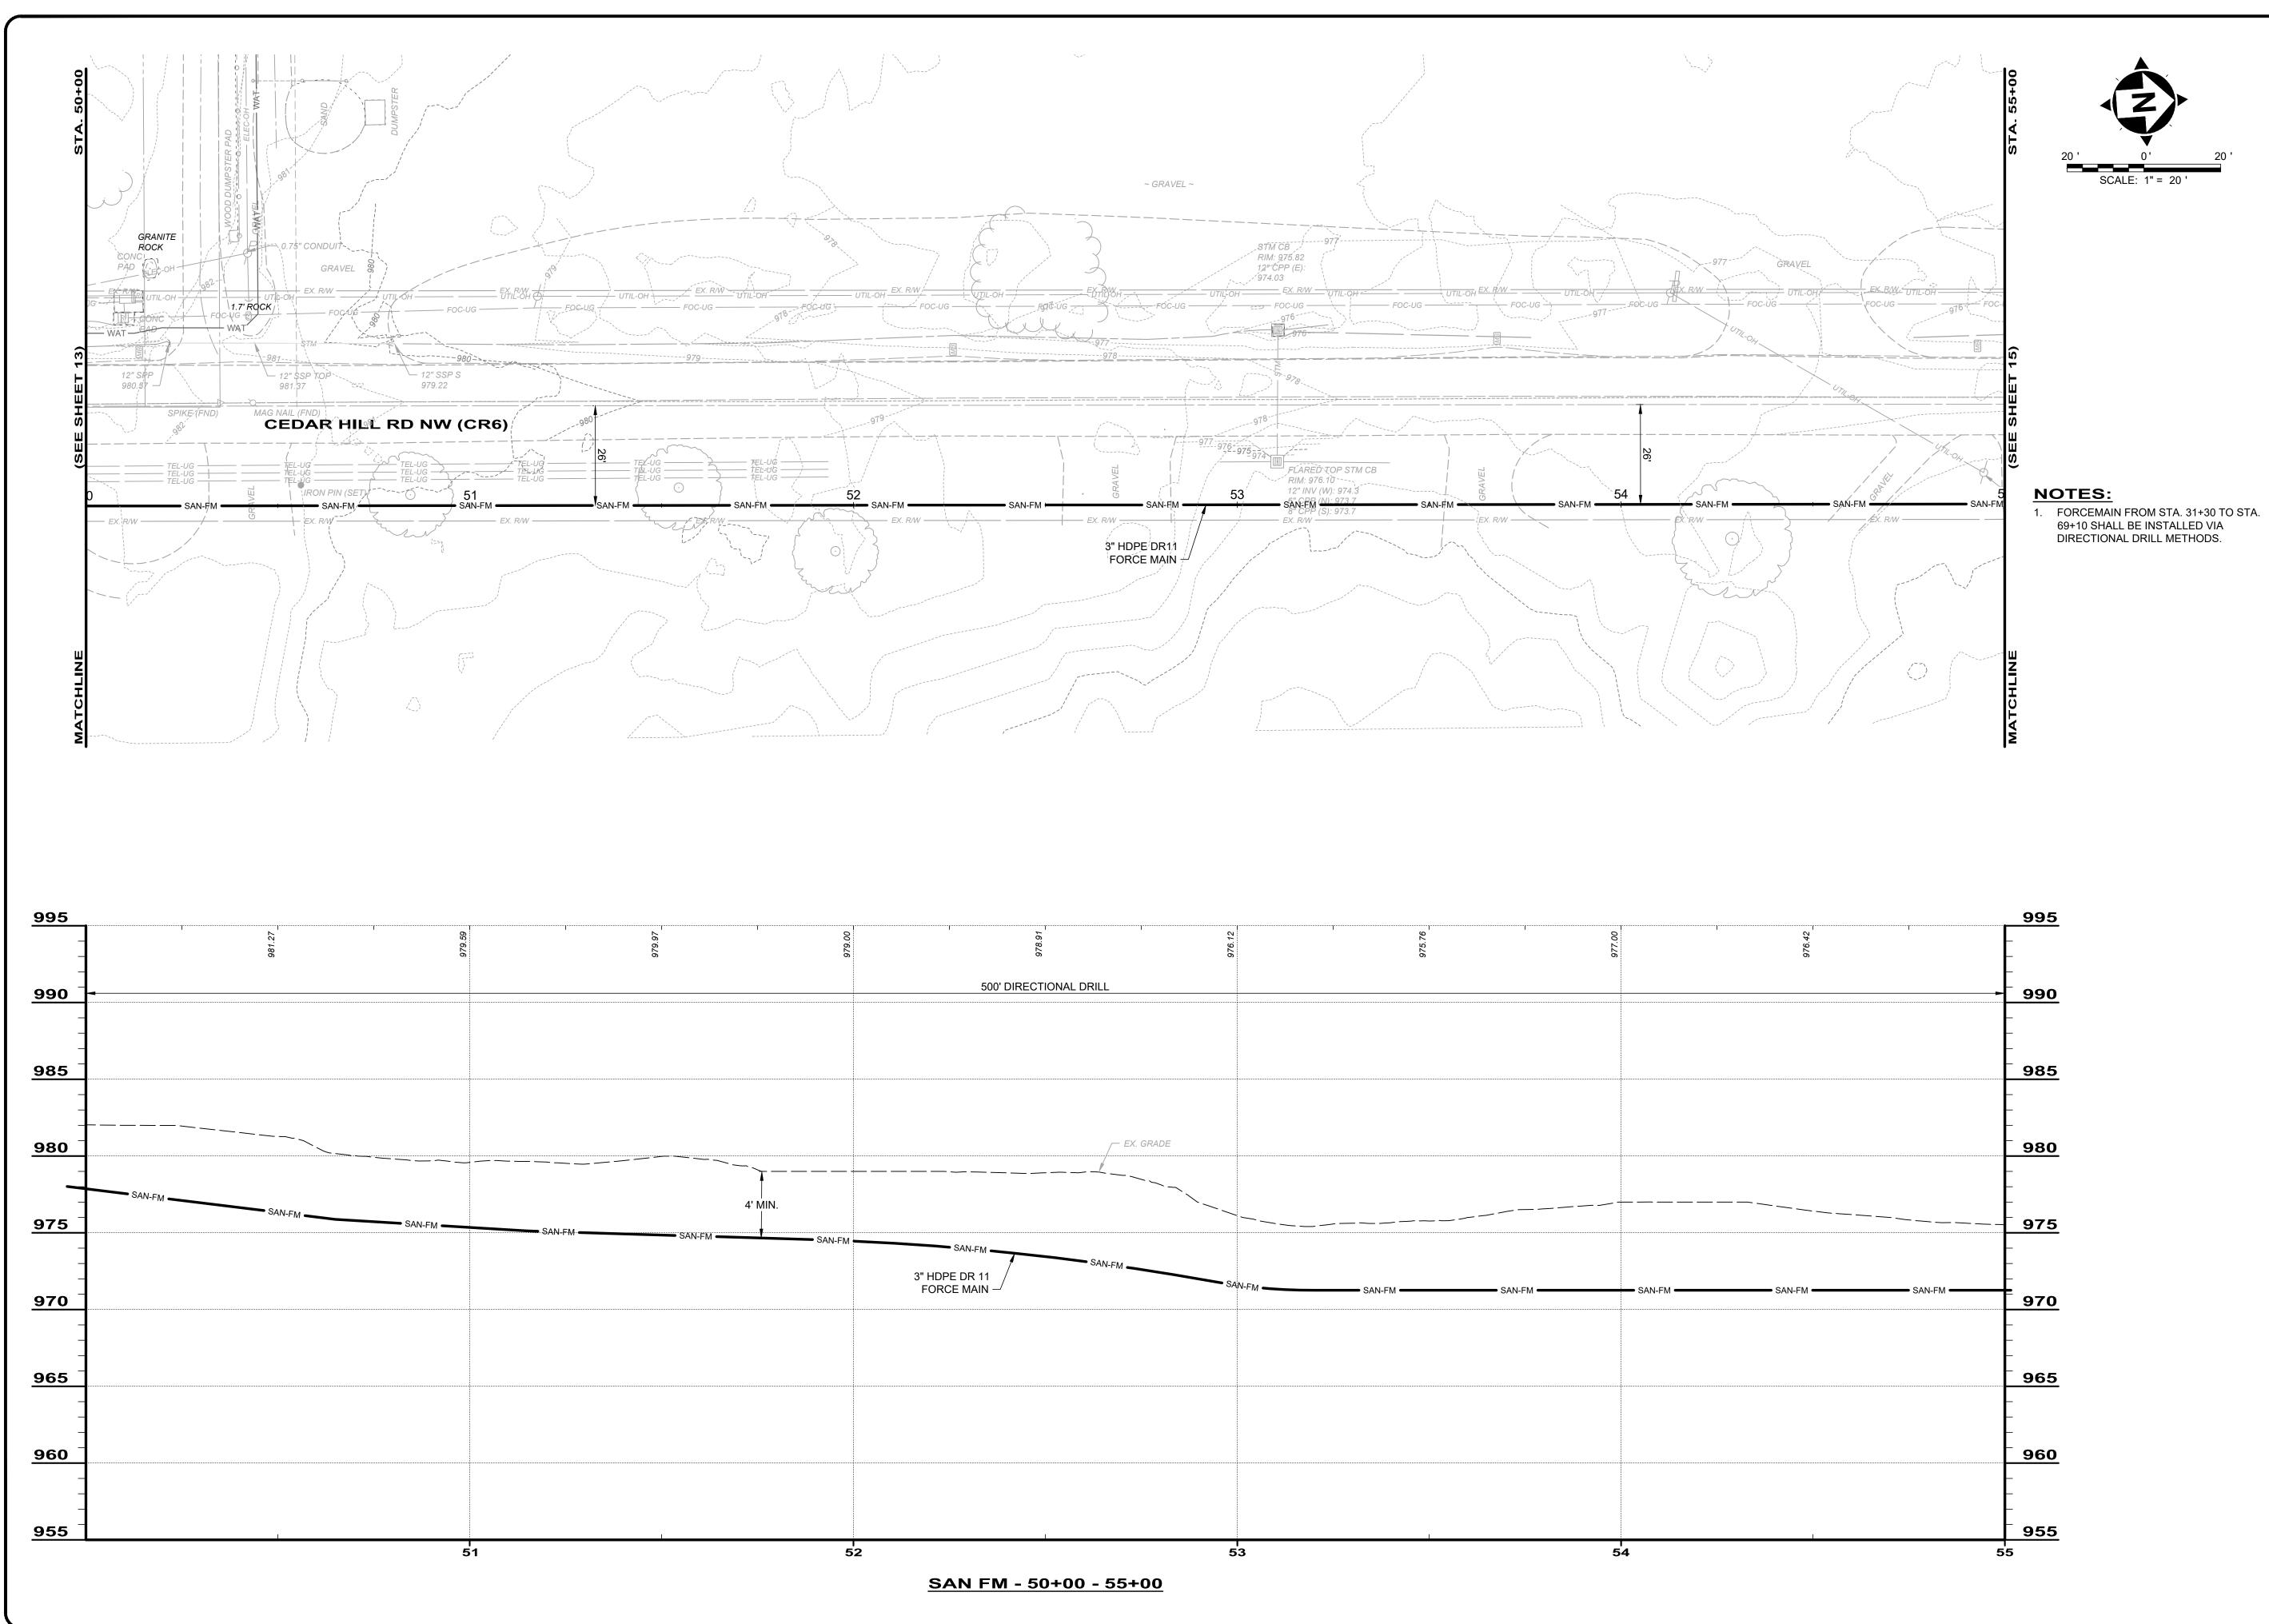



erdanta

	2		ם א
9/4/25	~	REVISED PER OEPA COMMENTS	7/16/2025
AS NOTED	2	REVISED PER OEPA COMMENTS	7/30/2025
BRA	3	REVISED PER OEPA COMMENTS	9/4/2025
AGD			
BRA			

FORCE MAIN INTERCONNECT	ISSUE DATE:
VILLAGE OF LITHOPOLIS, FAIRFIELD COUNTY, OHIO -	SCALE:
	DESIGNED BY
FORCE MAIN PLAN & PROFILE - 50+00 - 55+00	DRAWN BY:


- VIL	FO
PROJEC ⁻	T NO.
2415	69
DISCIPL	INE

CIVIL
SHEET NAME

SAN-P&P11

SHEET OF


14 24

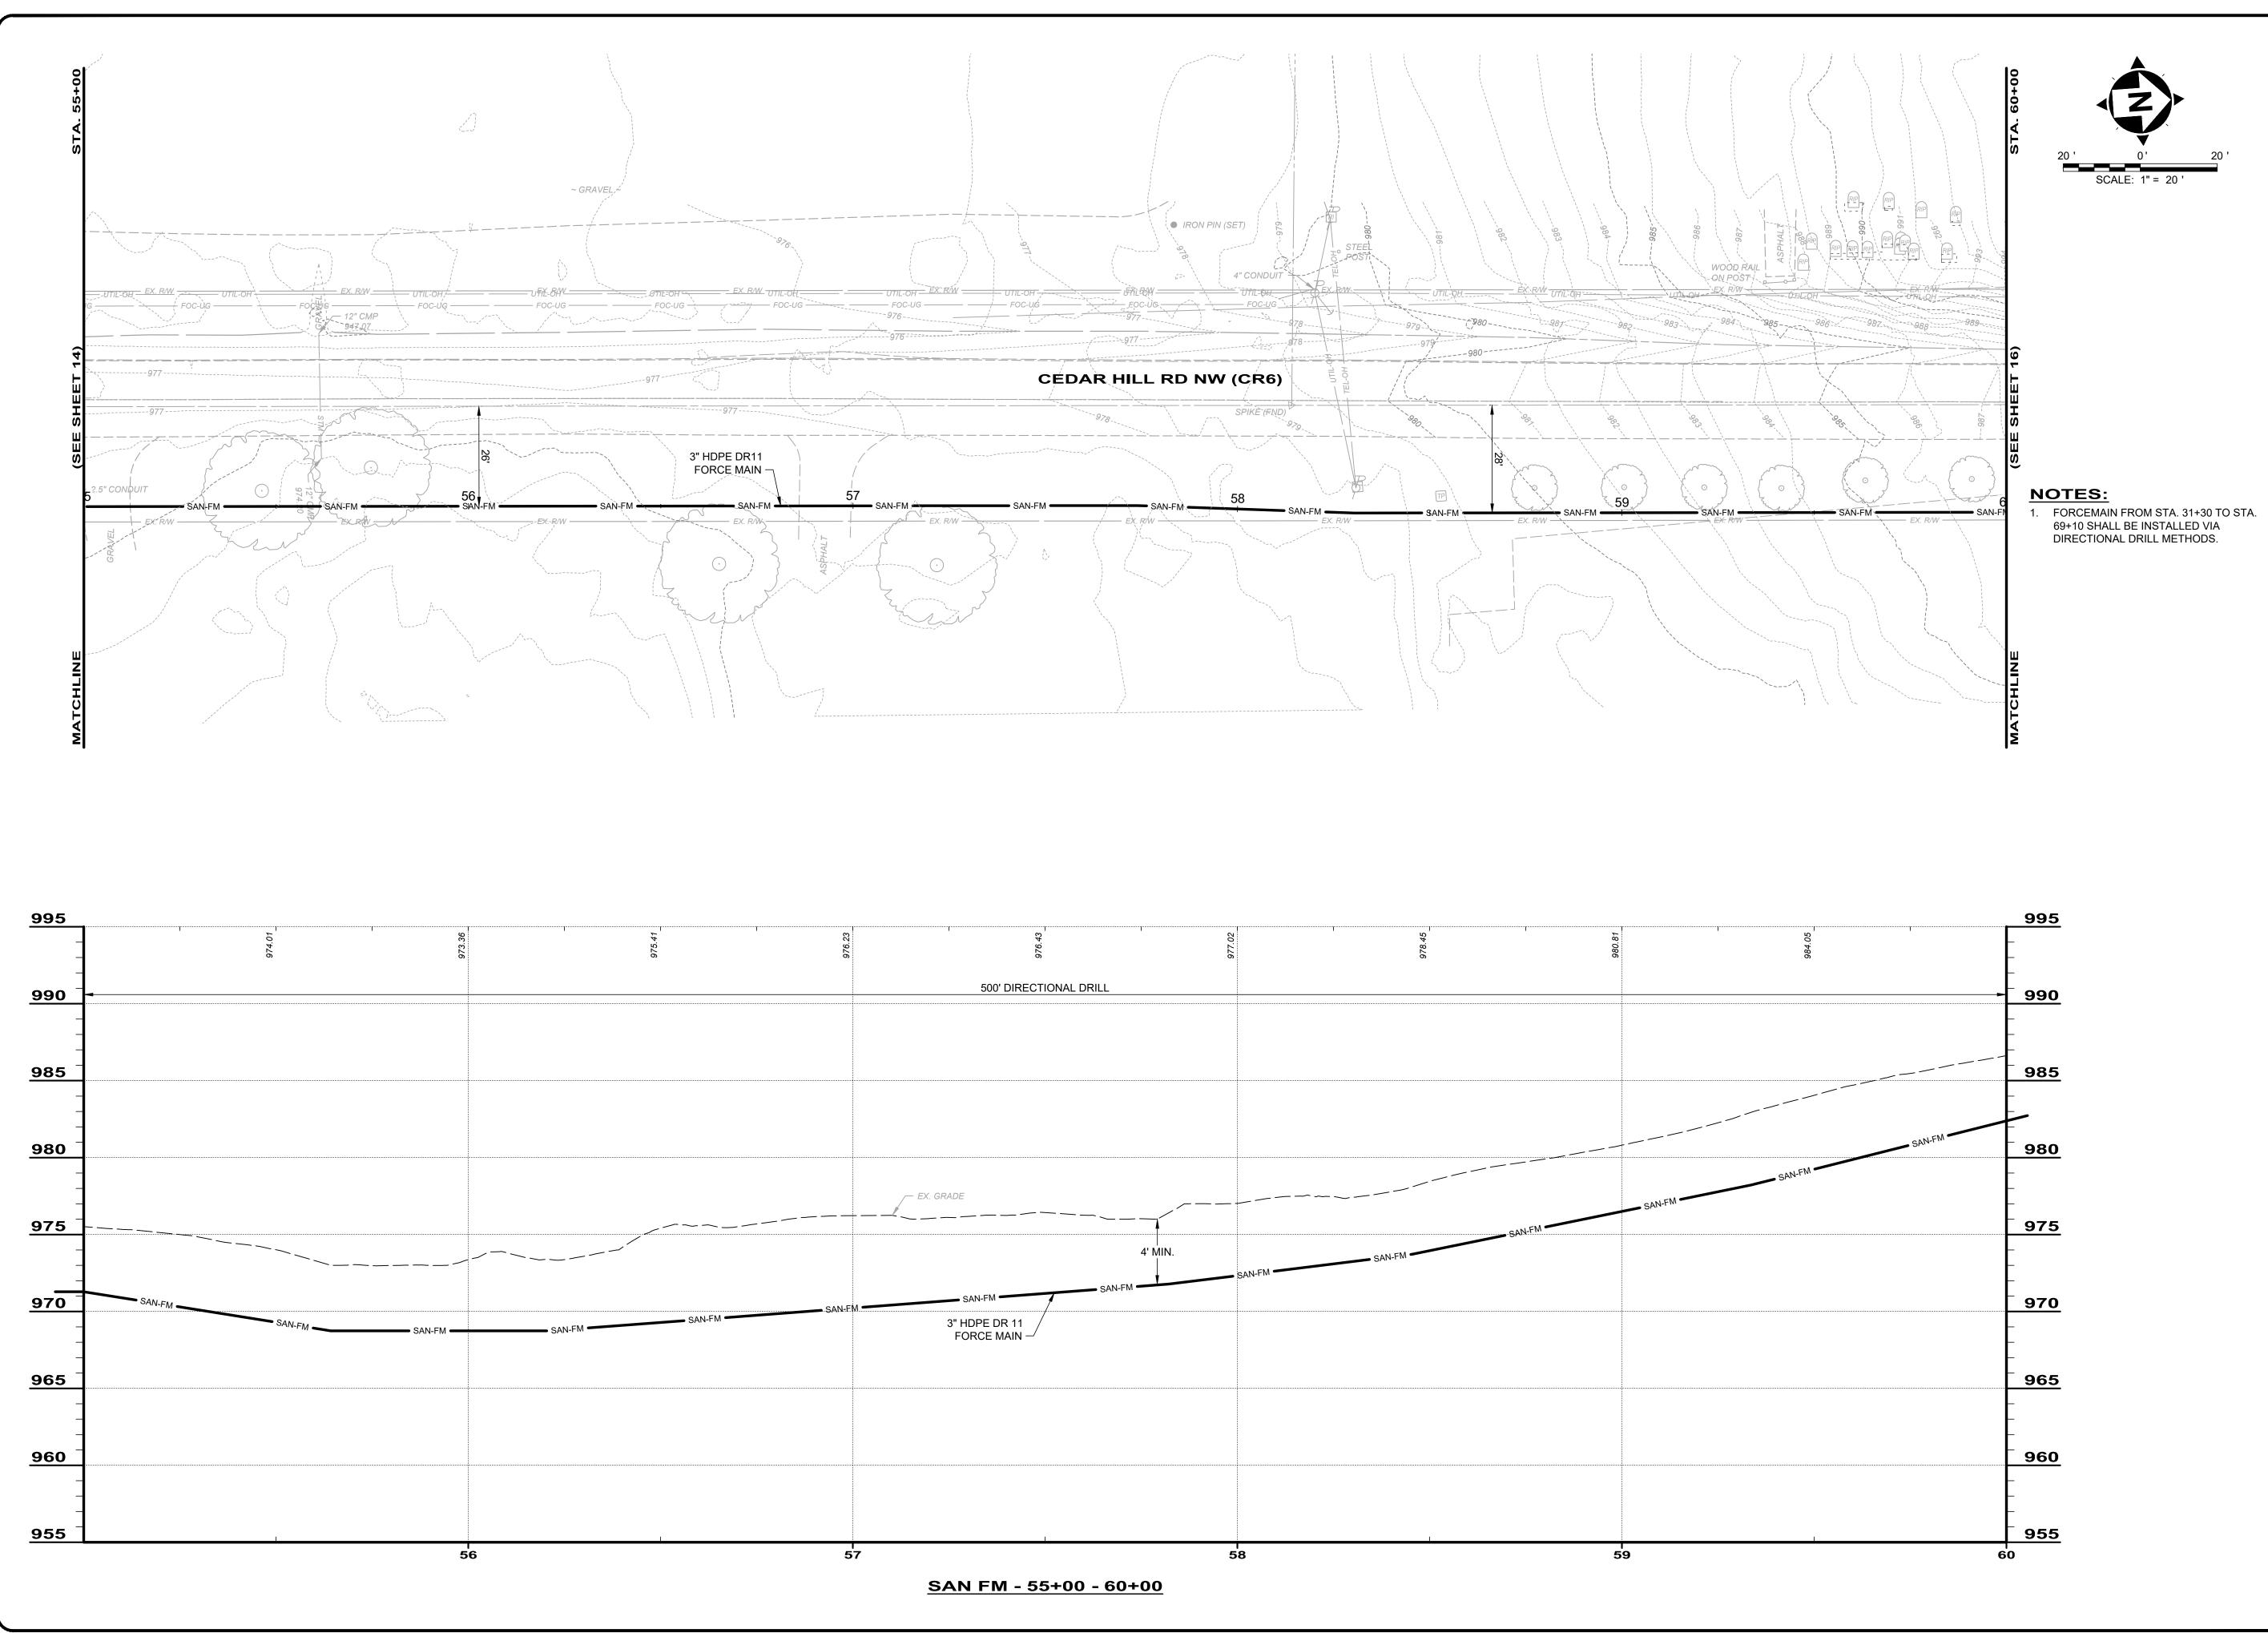



PROJECT NO. 241569 DISCIPLINE CIVIL SHEET NAME

SAN-P&P12

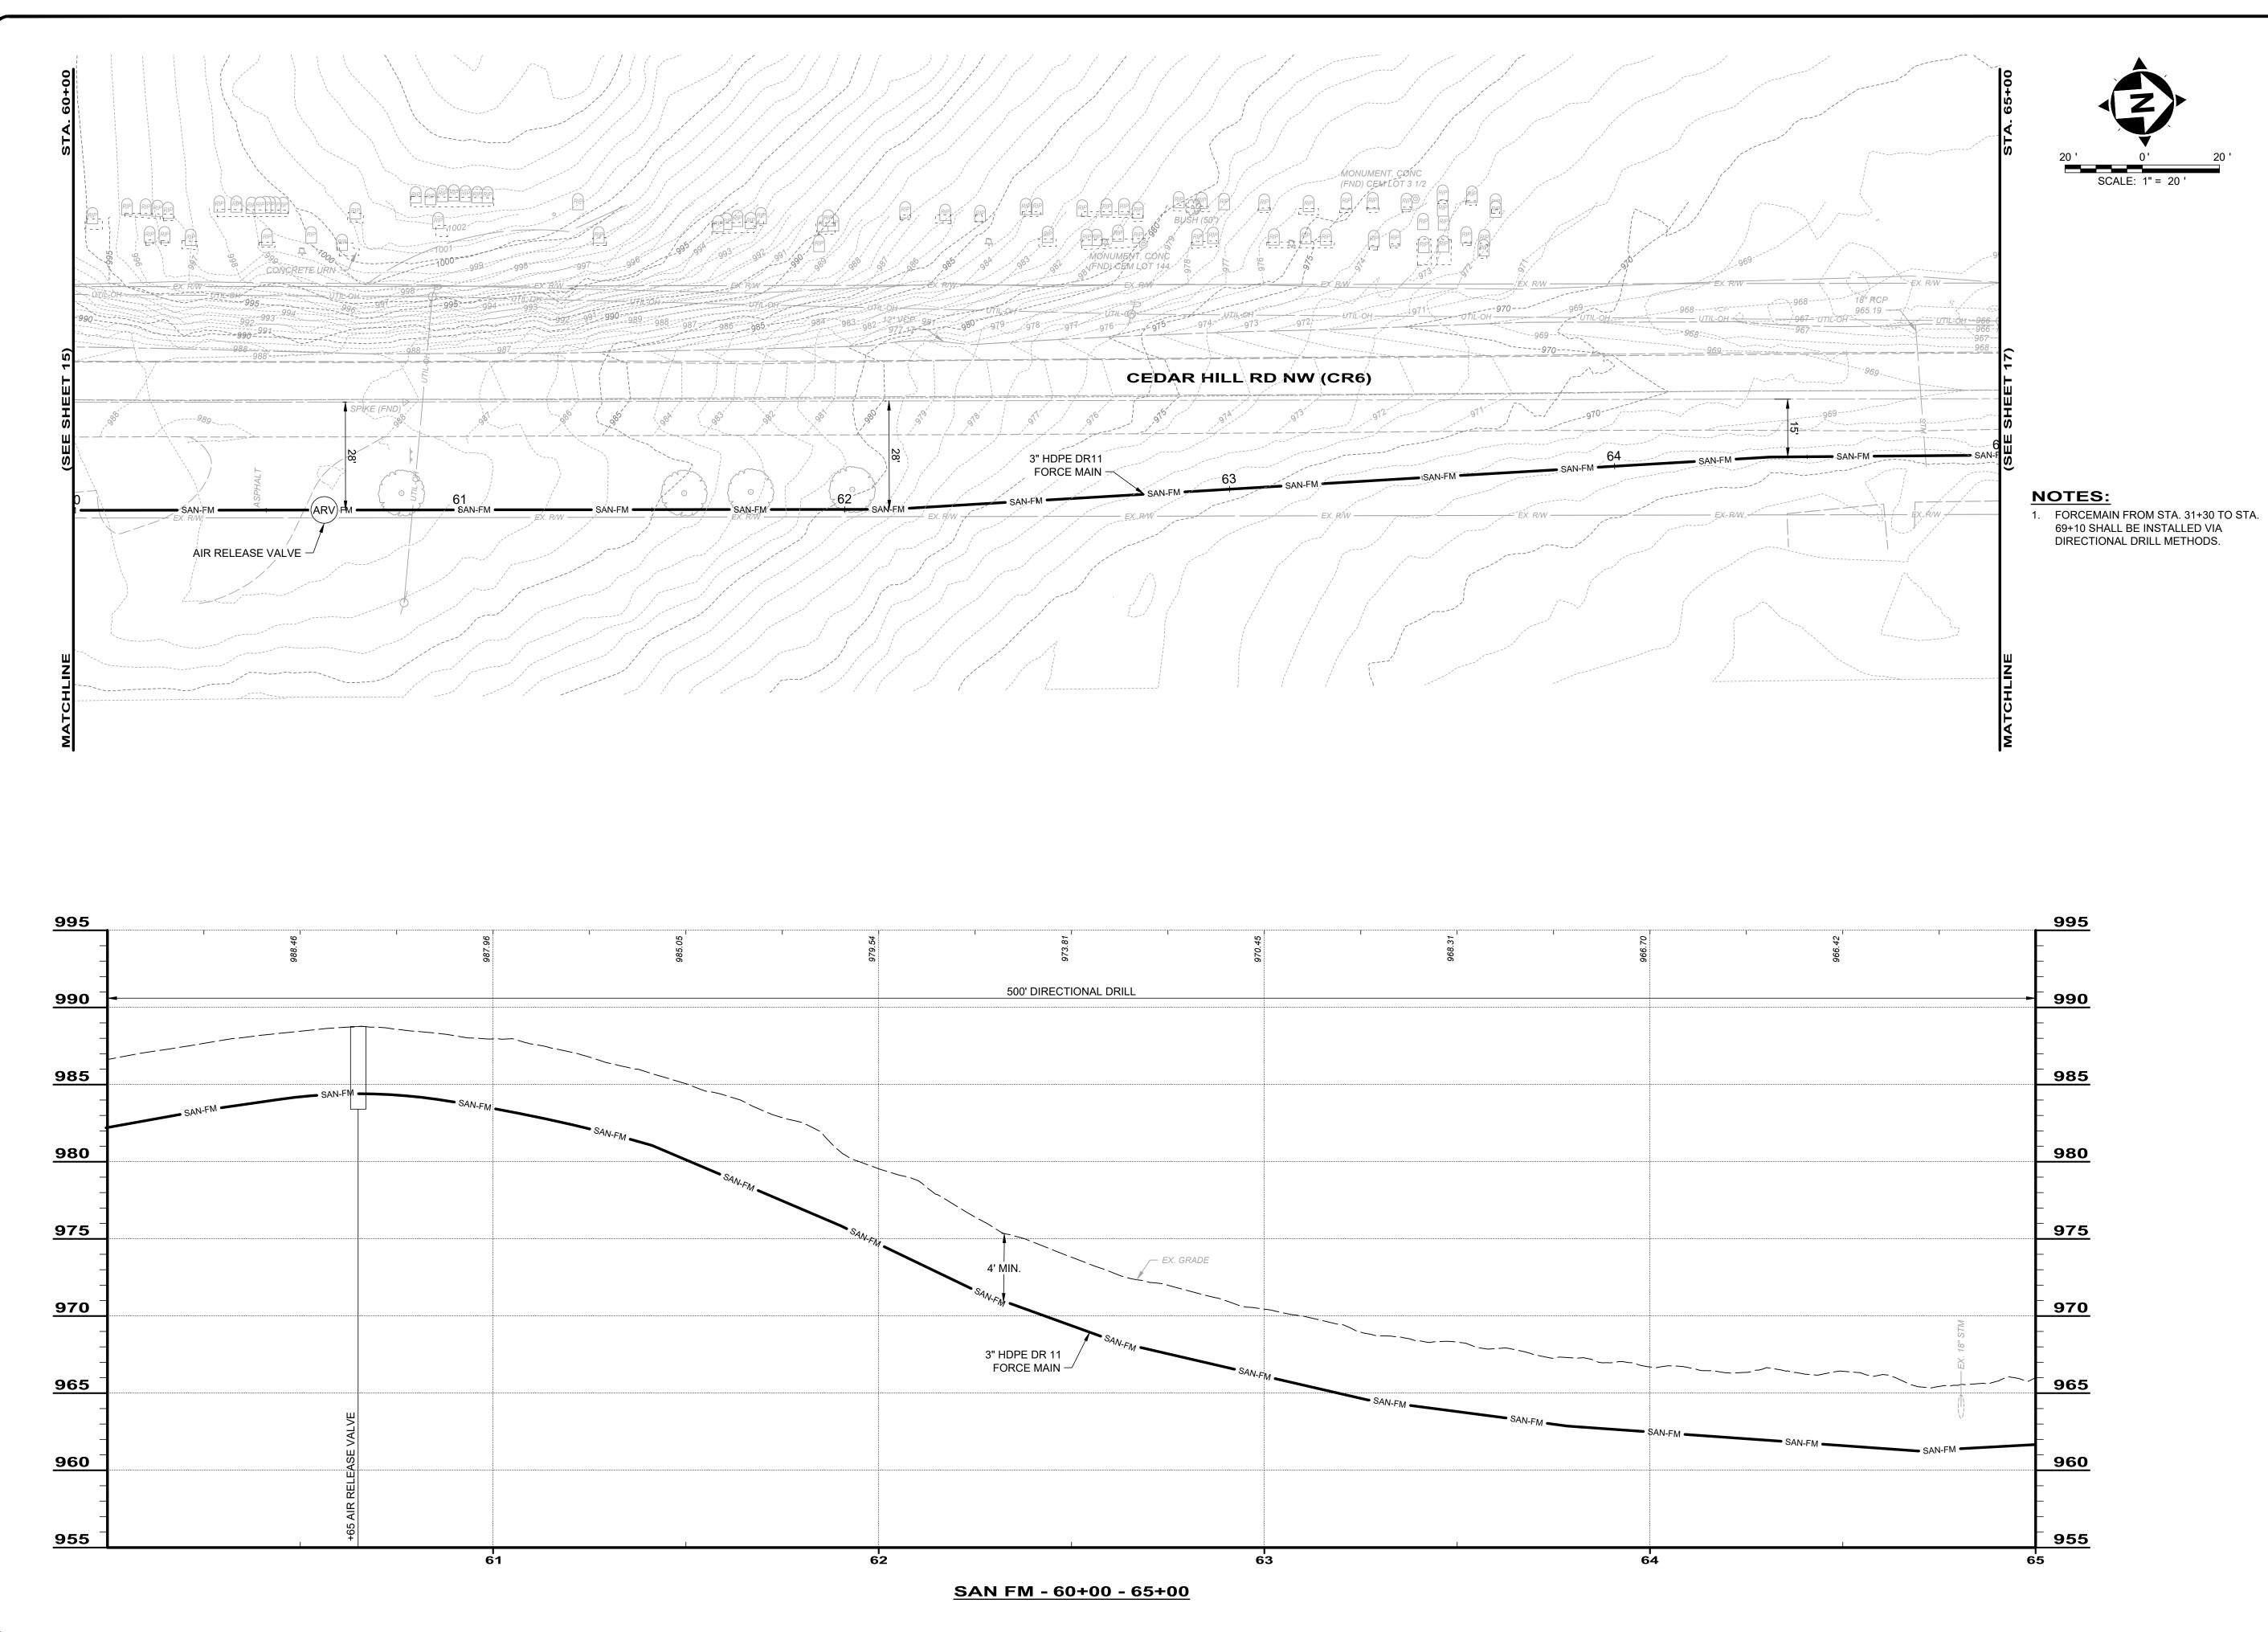




verdantas

	CACCAMP CAMP GACAC		
	FORCE MAIN INTERCONNECT	ISSUE DATE:	
PROJE 241	- VILLAGE OF	SCALE:	¥
ст NO. 569		DESIGNED BY:	
	FORCE MAIN PLAN & PROFILE - 60+00 - 65+00	DRAWN BY:	

DISCIPLINE

CIVIL SHEET NAME SAN-P&P13

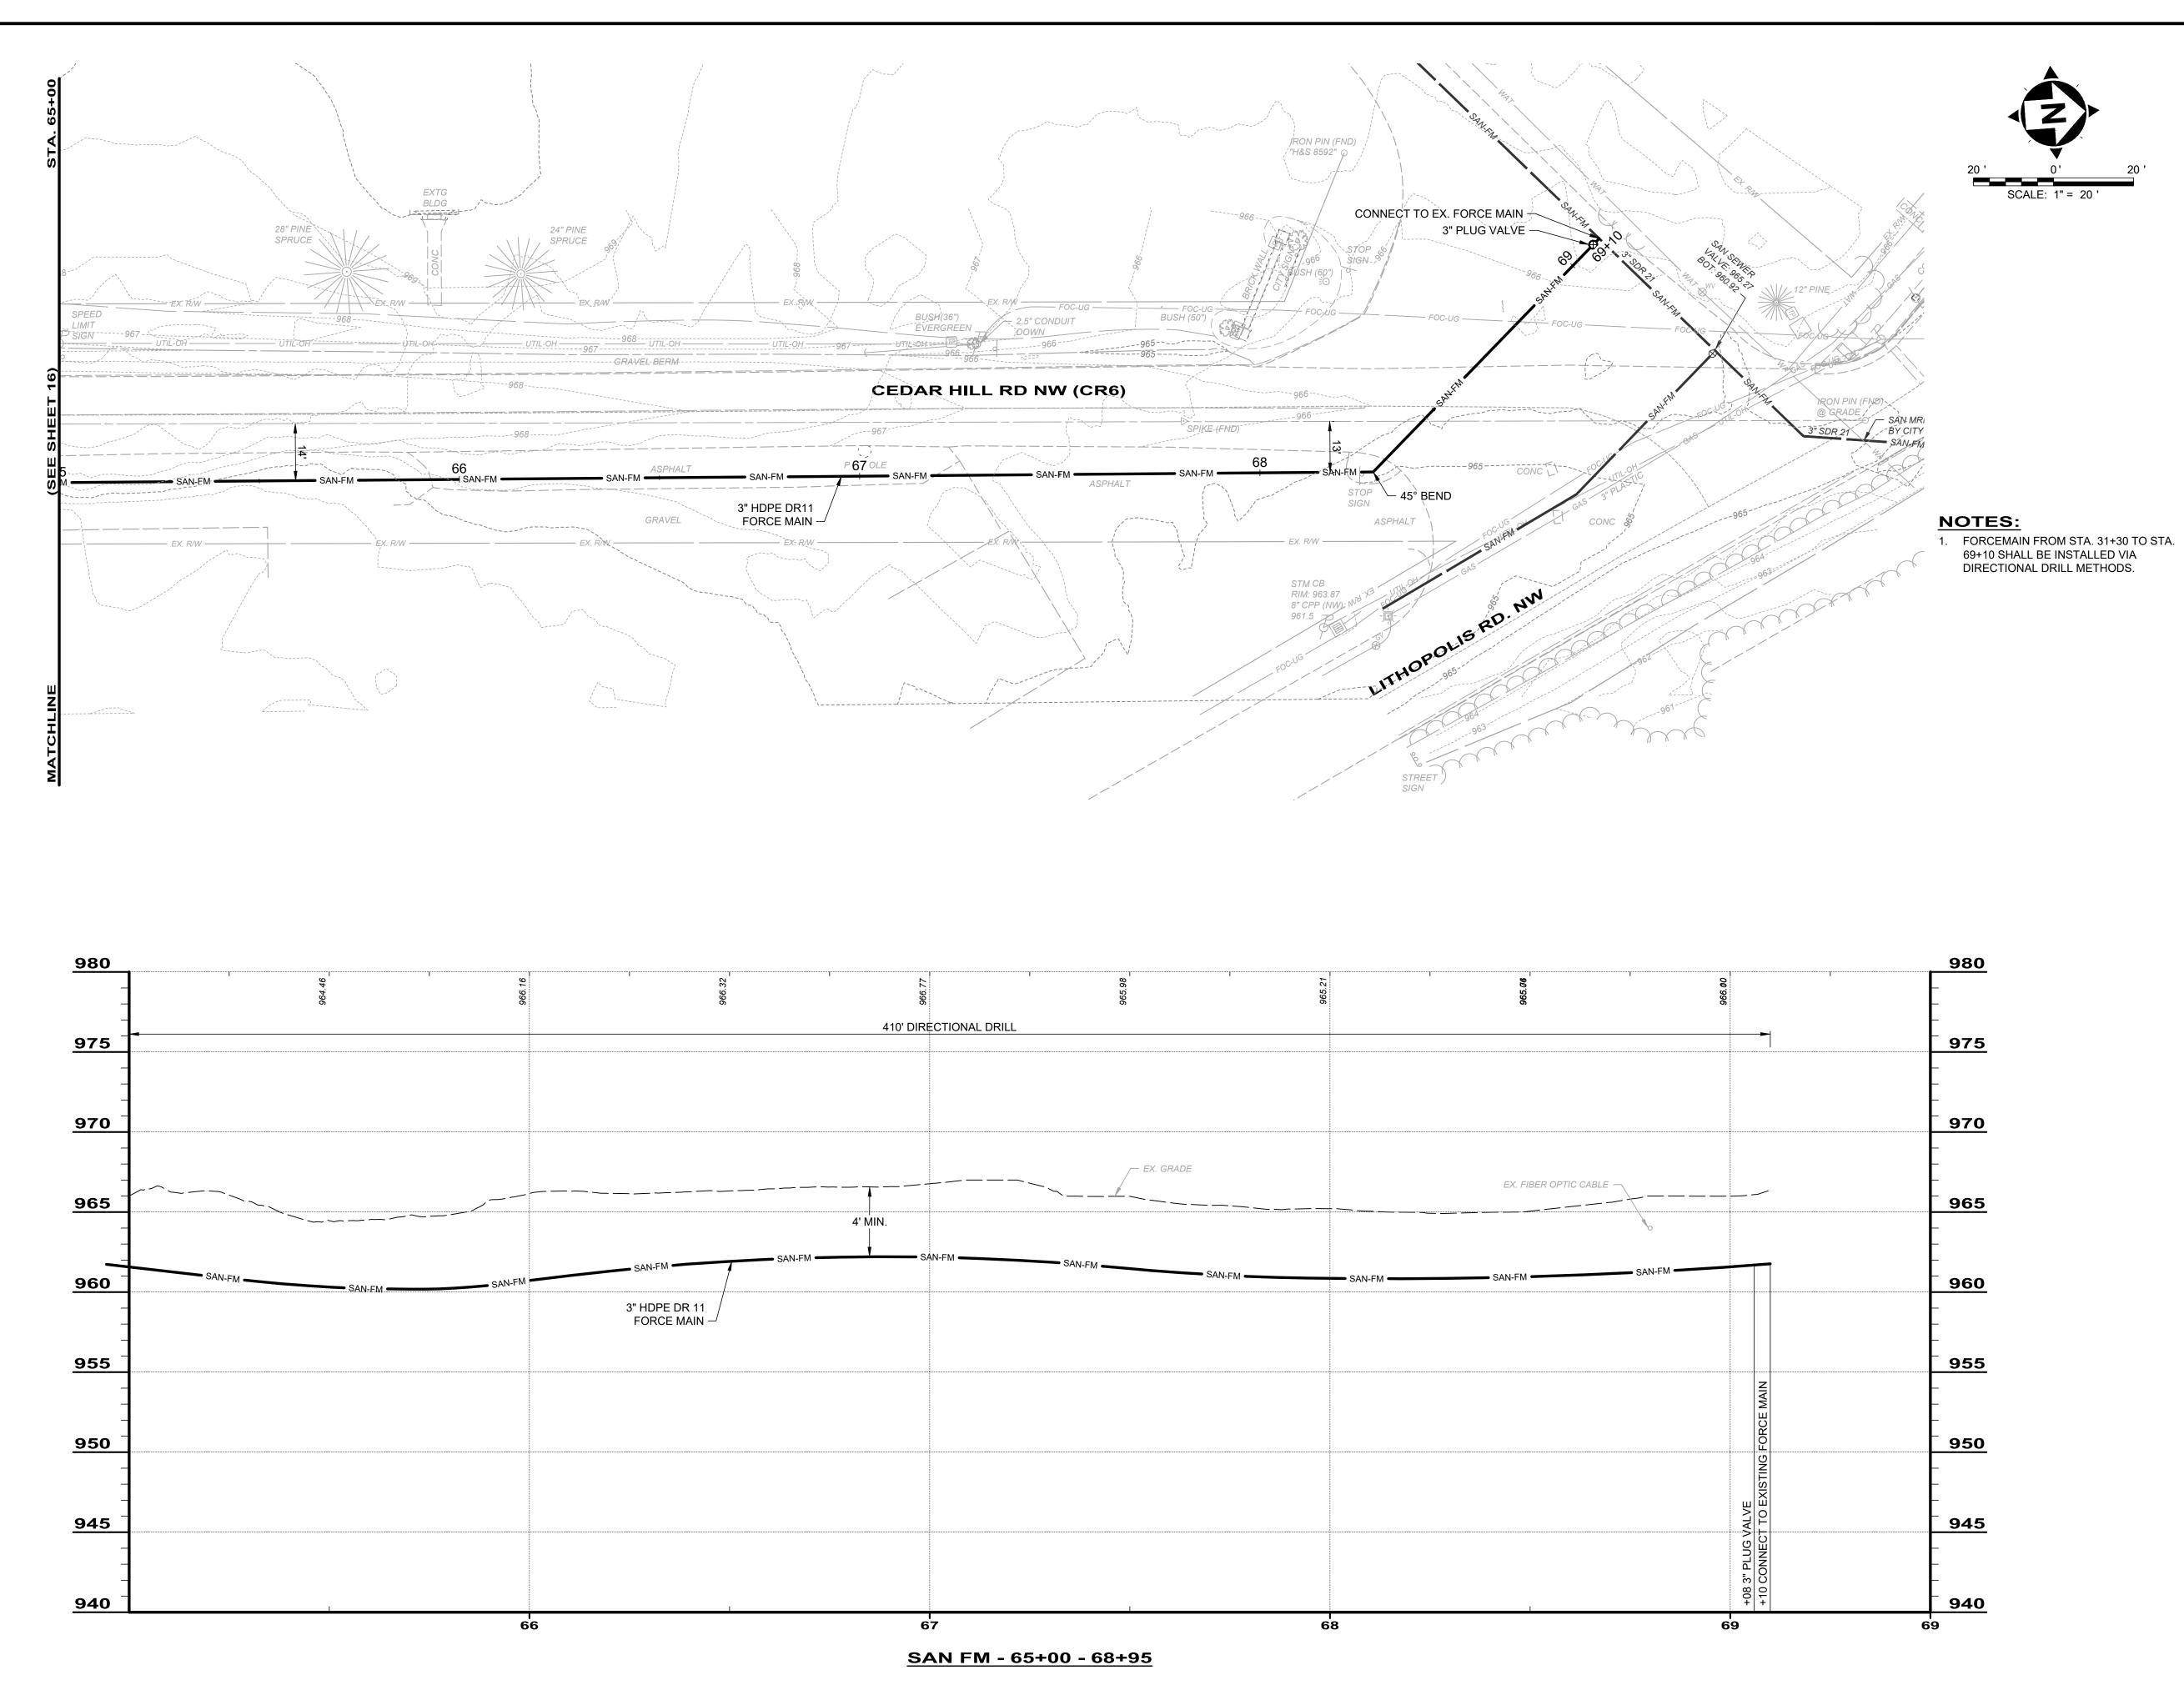



erdanta

INTERCONNECTISSUE DATE:9/4/251REVISED PERS, FAIRFIELD COUNTY, OHIO -SCALE:AS NOTED2REVISED PERPROFILE - 65+00 - 68+95DRAWN BY:AGD3REVISED PERCHECKED BY:BRA3REVISED PERCHECKED BY:BRA3REVISED PER

PROJECT NO.

241569

DISCIPLINE


CIVIL

SHEET NAME


SAN-P&P14

SHEET OF

17 24

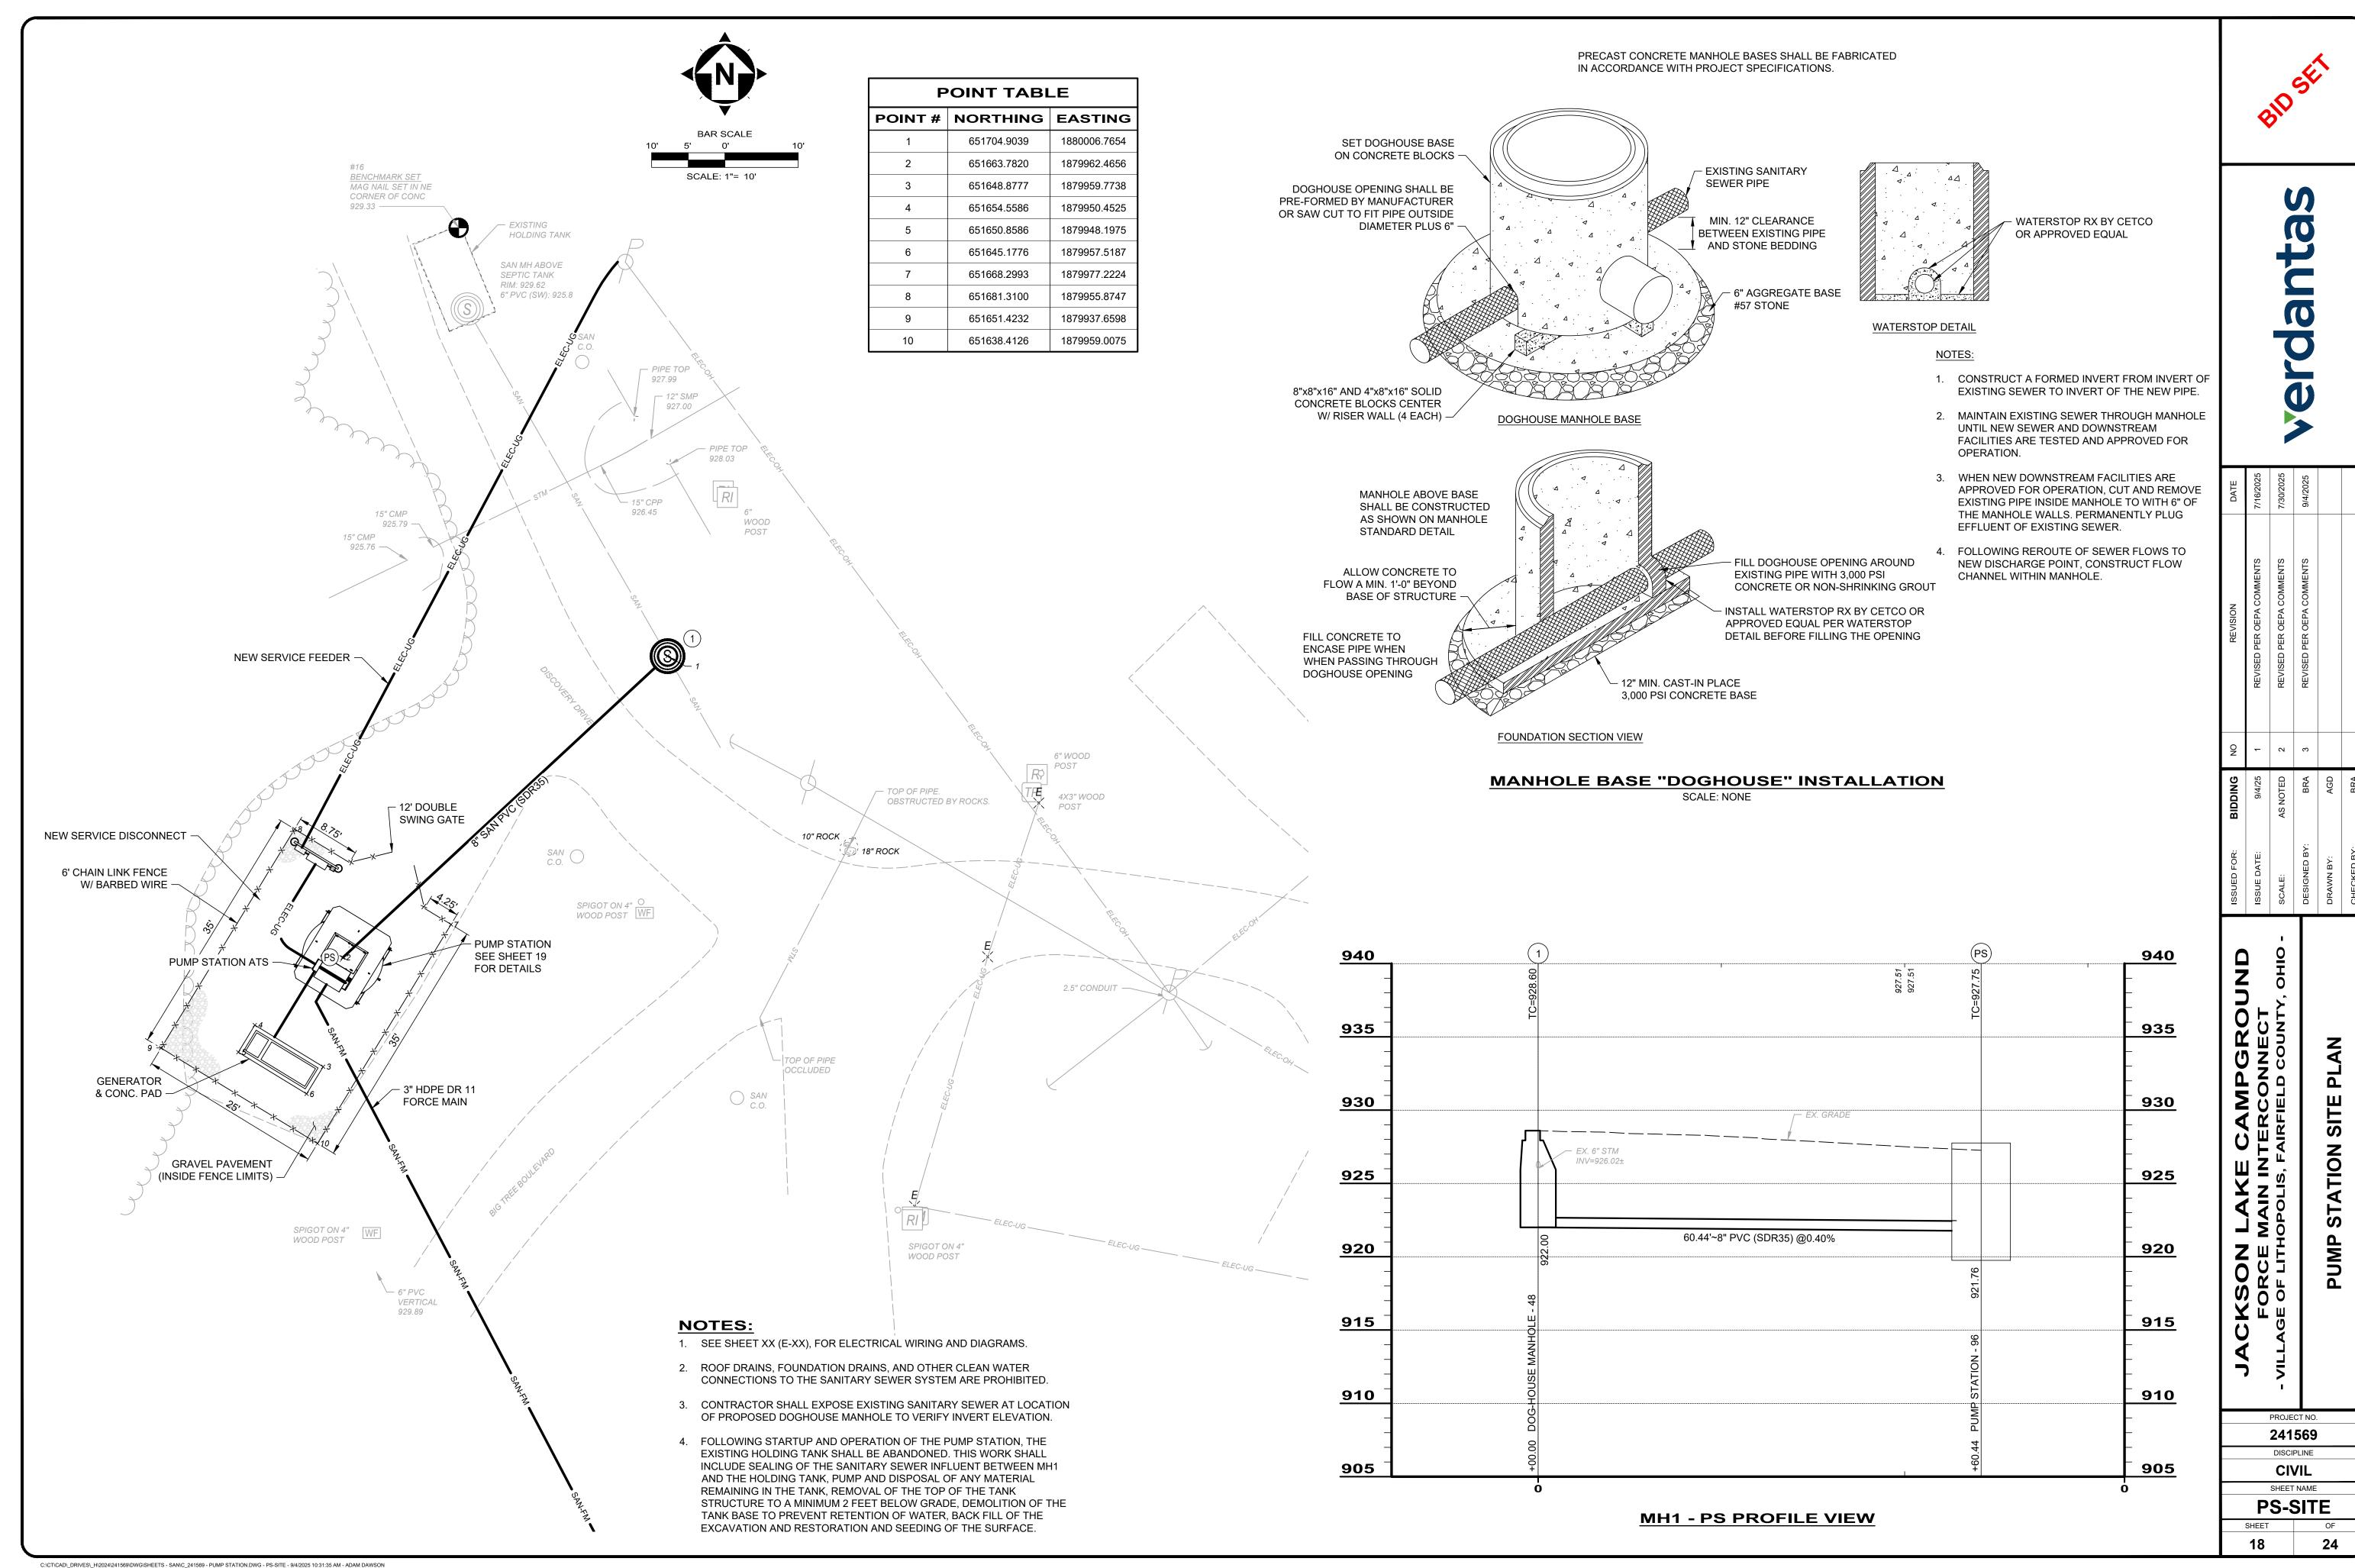




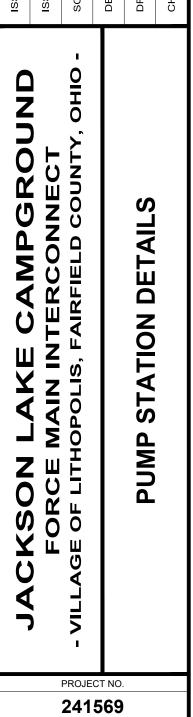


DISCIPLINE CIVIL SHEET NAME **PS-DETS**




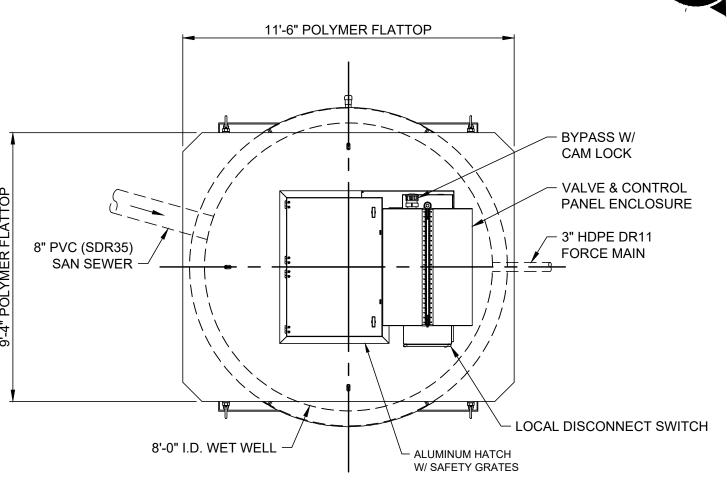

PLAN VIEW

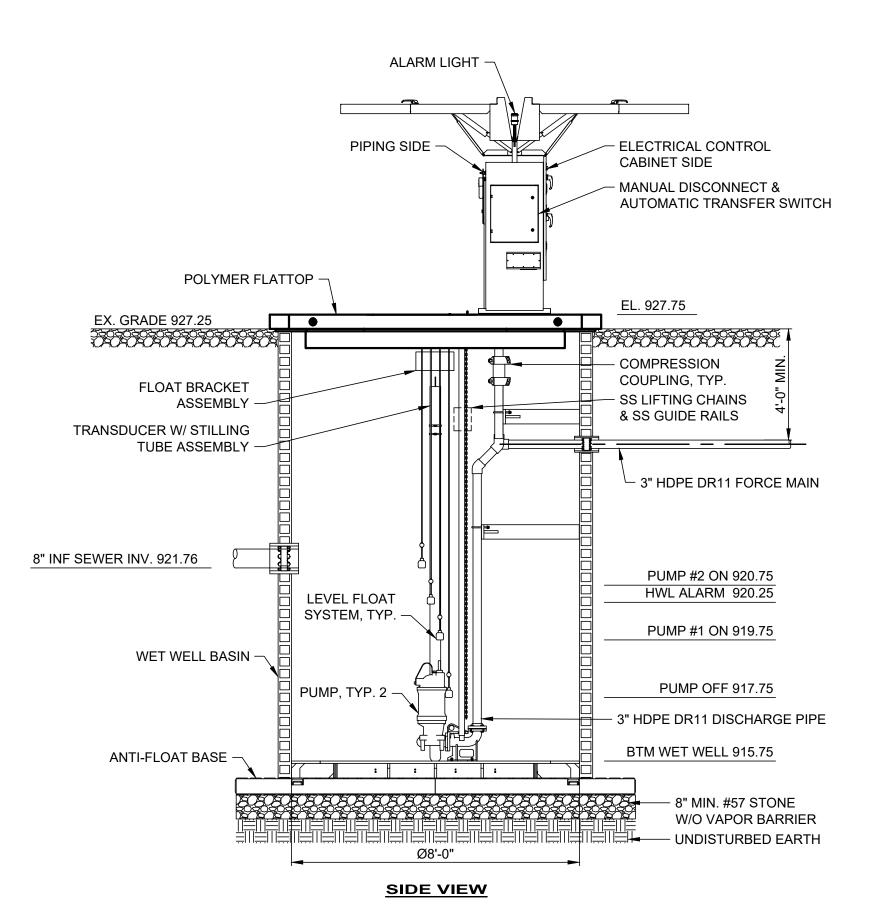

PUMP STATION DETAILS

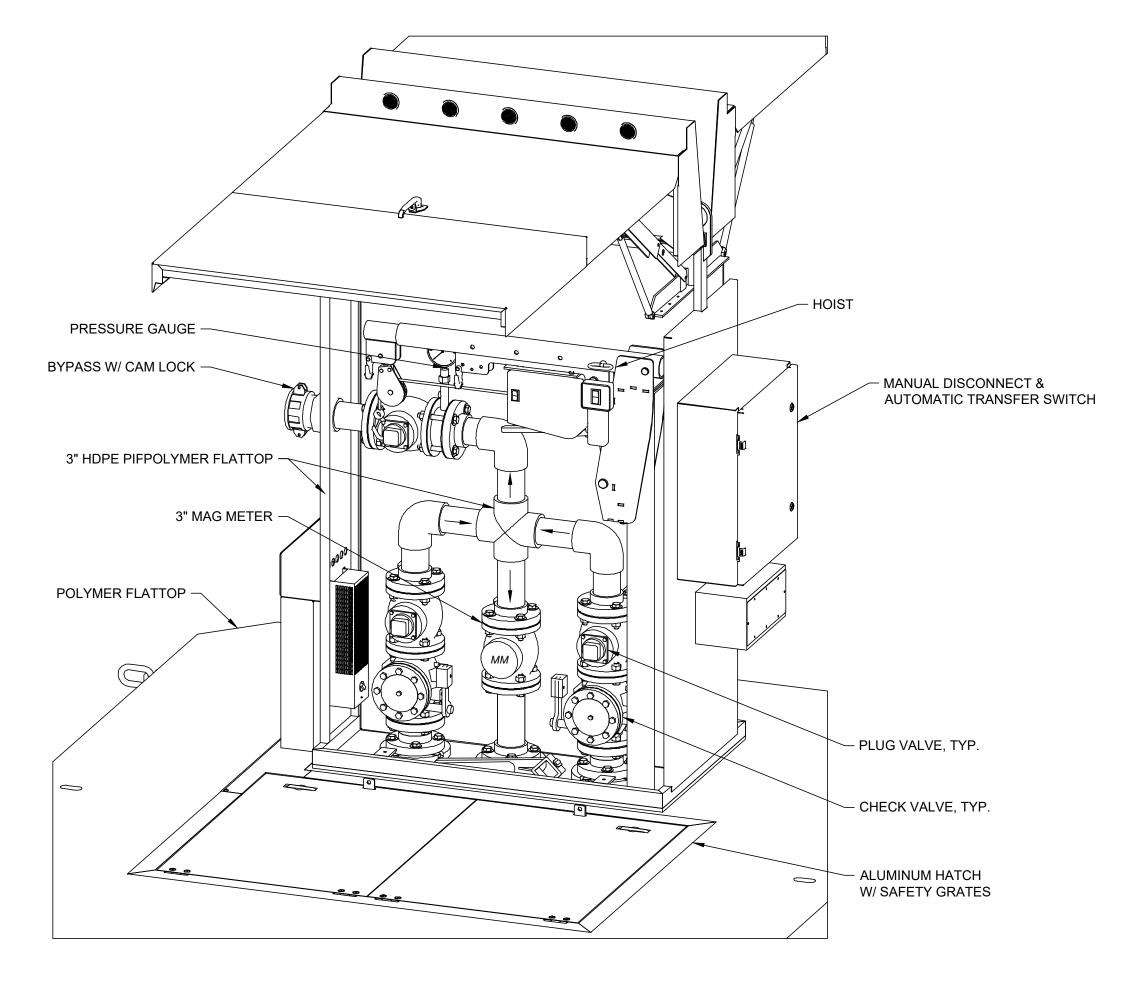

VALVE & CONTROL PANEL ENCLOSURE ISOMETRIC VIEW

GRINDER STATION DESIGN INFOR	MATION
NUMBER OF PUMPS DESIGN PUMP FLOW (GPM) DESIGN PUMP TDH (FT) PUMP SPEED (RPM) CONSTANT OR VARIABLE MOTOR HORSEPOWER	2 54 125' 1750 VARIABLE 7.5

NOTES:

- 1. ALL EXCAVATED AREAS TO RECEIVE STRUCTURAL BACKFILL. SEE SPECIFICATION.
- 2. ALL ELECTRICAL COMPONENTS SHALL BE MOUNTED TO PROVIDE A MINIMUM 3 FOOT CLEARANCE ABOVE THE 100-YEAR FLOOD.
- 3. CONTRACTOR SHALL PROVIDE ALL CONDUIT AND CONDUCTORS TO INTERFACE
- 4. PANEL SHALL BE SIZED TO ALLOW A MINIMUM 9" LATERAL CLEARANCE BETWEEN
- MAJOR COMPONENTS. 5. UNLESS OTHERWISE SPECIFIED ENCLOSURES SHALL BE NEMA 4X STAINLESS STEEL.
- 6. ROOF DRAINS, FOUNDATION DRAINS, AND OTHER CLEAN WATER CONNECTIONS TO
- THE SANITARY SEWER SYSTEM ARE PROHIBITED.
- 7. PUMPS SHALL BE SET UP TO RUN ALTERNATELY AFTER EACH CYCLE.


241569

DISCIPLINE

DETAILS

SHEET NAME

DETS1

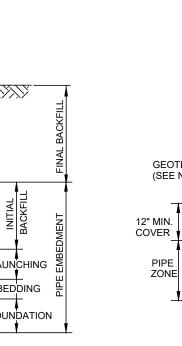

TRENCH WIDTH (SEE NOTE 1) GEOTEXTILE FABRIC (SEE NOTE 7) — BEDDING (MAY NOT BE REQUIRED) SHAPE TRENCH BOTTOM FOR PROJECTING PIPE BELLS TO ALLOW PIPE BARREL TO BE EVENLY SUPPORTED BY THE TRENCH BOTTOM

PIPE | SPRINGLINE PIPE SPRINGLINE CONCRETE CRADLE BEDDING 1/8 PIPE I.D (MAY NOT BE REQ'D.) FOUNDATION (MAY NOT BE REQ'D.) IS GREATER

EXCAVATED

TRENCH WIDTH

(SEE NOTE 1)

PIPE

SUBGRADE

OR STRUCTURE

PARALLEL

ZONE OF INFLUENCE

EDGE OF PAVEMENT

ZONE OF

INFLUENCE

OR STRUCTURE

TRANSVERSE

ZONE OF INFLUENCE

BACKFILL

MATERIAL-

SPECIAL

. BACKFILI

MATERIAL -

— ZONE OF

INFLUENCE

CLASS 'C' PIPE EMBEDMENT CLASS 'A' PIPE EMBEDMENT CLASS 'B' PIPE EMBEDMENT

EXCAVATED

TRENCH WIDTH

(SEE NOTE 1)

1. MAXIMUM EXCAVATED TRENCH WIDTH: THE MAXIMUM EXCAVATED TRENCH WIDTH FROM THE BOTTOM OF THE TRENCH TO 12" OVER THE TOP OF THE PIPE (WITHIN PIPE EMBEDMENT) SHALL BE O.D. + 24" FOR ALL PIPES UP TO AND INCLUDING 24" I.D. + 30" FOR PIPE FROM 24" I.D. TO 54" I.D. AND O.D. + 48" FOR PIPES SIZES 60" I.D. AND OVER.


- 2. FOUNDATION: WHERE AN UNSTABLE TRENCH BOTTOM CONDITION IS ENCOUNTERED, THE CONTRACTOR SHALL EXCAVATE TO A DEPTH REQUIRED BY THE ENGINEER AND REPLACE WITH MATERIAL AS DIRECTED BY THE ENGINEER.
- PIPE EMBEDMENT: CLASS A: CLASS A PIPE EMBEDMENT SHALL BE USED FOR ALL PIPING UNDER PAVEMENT OR STRUCTURES WITH LESS THAN 12 INCHES OF PIPE COVER TO THE SUBGRADE. THE CONCRETE CRADLE SHALL BE IN ACCORDANCE WITH ODOT ITEM 499, CLASS "C". THE INITIAL BACKFILL SHALL BE AASHTO NO. 57 OR NO. 67 GRANULAR PIPE EMBEDMENT.

CLASS B: CLASS B PIPE EMBEDMENT SHALL BE USED FOR ALL PIPING UNLESS OTHERWISE NOTED ON THE PLANS OR AUTHORIZED BY THE ENGINEER THE BEDDING AND HAUNCHING SHALL BE AASHTO NO. 57 OR NO. 67 GRANULAR PIPE EMBEDMENT. IN ALL AREAS UNDER PAVEMENT, STRUCTURES OR WITHIN THE ZONE OF INFLUENCE, THE INITIAL BACKFILL SHALL BE AASHTO NO. 57 OR NO. 67 STONE GRANULAR PIPE EMBEDMENT. IN ALL AREAS OUTSIDE OF PAVEMENT, STRUCTURES OR THE ZONE OF INFLUENCE, THE INITIAL BACKFILL SHALL BE SUITABLE ON-SITE MATERIAL APPROVED BY THE ENGINEER FOR ONLY REINFORCED CONCRETE PIPE AND DUCTILE IRON PIPE. THE INITIAL BACKFILL FOR ALL OTHER PIPES SHALL BE AASHTO NO. 57 OR NO. 67 GRANULAR PIPE EMBEDMENT.

CLASS C: CLASS C PIPE EMBEDMENT SHALL ONLY BE USED FOR DUCTILE IRON WATER MAIN, DUCTILE IRON FORCE MAINS OR AS AUTHORIZED BY THE ENGINEER. THE PIPE EMBEDMENT SHALL BE AASHTO NO. 57 OR NO. 67 GRANULAR PIPE EMBEDMENT IN ALL AREAS UNDER PAVEMENT, STRUCTURES OR WITHIN THE ZONE OF INFLUENCE. THE PIPE EMBEDMENT SHALL BE SUITABLE ON-SITE MATERIAL APPROVED BY THE ENGINEER IN ALL AREAS OUTSIDE OF PAVEMENT, STRUCTURES OR THE ZONE OF INFLUENCE. WHERE ROCK OR SHALE IS ENCOUNTERED, A MINIMUM 6-INCHES OF AASHTO NO. 57 OR NO. 67 GRANULAR PIPE BEDDING OR SAND BEDDING SHALL BE PLACED AS DIRECTED BY THE ENGINEER

- 4. FINAL BACKFILL: IN ALL AREAS UNDER PAVEMENT, STRUCTURES OR WITHIN THE ZONE OF INFLUENCE THE FINAL BACKFILL SHALL BE SPECIAL BACKFILL MATERIAL. IN ALL AREAS OUTSIDE OF PAVEMENT, STRUCTURES OR THE ZONE OF INFLUENCE, THE FINAL BACKFILL SHALL BE SUITABLE ON-SITE MATERIAL APPROVED BY THE ENGINEER.
- 5. SPECIFICATIONS: ALL TRENCHING, PIPE EMBEDMENT AND BACKFILL MATERIALS SHALL BE IN ACCORDANCE WITH SPECIFICATION 310000CT -EARTHWORK.
- 6. CLAY TRENCH DAMS: CLAY TRENCH DAMS SHALL BE REQUIRED AS SHOWN ON PLANS OR WHEN AND WHERE NECESSARY AS DIRECTED BY THE ENGINEER.
- 7. GEOTEXTILE FABRIC: INSTALL A GEOTEXTILE FABRIC IN ACCORDANCE WITH ODOT 712.09, TYPE A, AFTER ALL INITIAL BACKFILL CONSISTING OF AASHTO NO. 57 OR NO. 67 GRANULAR PIPE EMBEDMENT.
- 8. DETECTOR TAPE: IF REQUIRED IN THE SPECIFICATIONS, INSTALL DETECTABLE WARNING TAPE ABOVE UTILITIES, 12" BELOW FINISHED GRADE, EXCEPT 6 INCHES BELOW SUBGRADE UNDER PAVEMENT AND SLABS.

TRENCHING, EMBEDMENT AND BACKFILL DETAIL

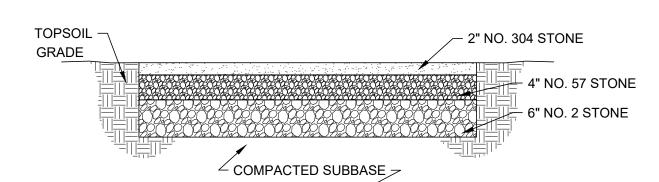

GRAVEL PAVEMENT DETAIL

-BITUMINOUS SEALER O.D.O.T.

ITEM 702.01, 702.02 OR 702.04

(1) FOR PUBLIC ROADWAYS, COMMERCIAL

(2) FOR RESIDENTIAL DRIVEWAY AND DRIVE

THE OVERLAY AND/OR "T" BE LESS

IN NO CASE SHALL THE THICKNESS OF

SEE TRENCH AND BEDDING DETAILS

DRIVES AND DRIVE APRONS.

APRONS ONLY (DRIVEWAY).

THAN EXISTING.

(TYP. EACH SIDE)

SCALE: NONE

111111

"T" = 7 1/2" MIN.

"T" = 4 1/2" MIN.


MAX. PAY LIMIT UNLESS

OTHERWISE NOTED ON THE PLANS

PIPE O.D. + 6' FOR PIPE ≤ 24" I.D. OR

SCALE: NONE

PIPE O.D. + 6'-6" FOR PIPE > 24" I.D.

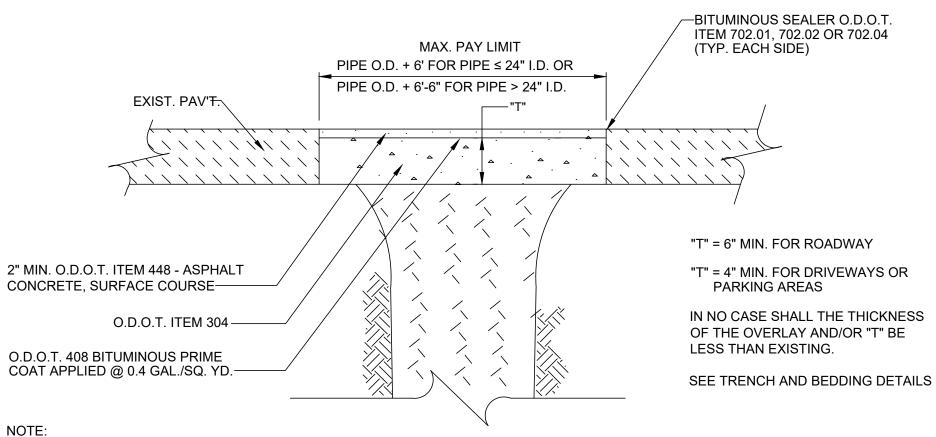

BOTH DIRECTIONS, FOR THE FULL WIDTH OF THE TRENCH.

— 18" MINIMUM

SEWER LINE

MECHANICAL BELL JOINT CLAMP

SERVICE LINE OR APPURTENANCE.

ALL ITEMS IN THE PROPOSAL.

SECTION

1. IF JOINT ON WATER MAIN IS WITHIN LIMITS OF SEWER TRENCH, INSTALL

2. IF CLEARANCE IS LESS THAN 18", ENCASE SEWER PIPE 6 FT. EACH SIDE

3. IN NO CASE SHALL THE SEWER PIPE CONTACT ANY WATER MAIN,

-2000 P.S.I. CONCRETE

OUTSIDE OF PIPE.

VERTICAL WATER MAIN CLEARANCE

SCALE: NONE

CONCRETE PADS SHALL BE USED

WHERE EVER THERE IS LESS THAN 18" OF CLEARANCE BETWEEN

2000 P.S.I. CONCRETE

UNLESS OTHERWISE DIRECTED BY THE ENGINEER, WHERE TWO PIPES (SEWER & WATER) CROSS EACH OTHER, A CONCRETE PAD AND CRADLE SEPERATOR SHALL BE PLACED

BETWEEN THEM AS INDICATED ABOVE. WHERE PERMISSION IS GRANTED TO OMIT THE

PIPES. SUCH TAMPED BACKFILL SHALL BE CONTINUOUS FROM THE CRADLE OF THE LOWER PIPE TO THE TOP OF THE UPPER PIPE AND AT THE BOTTOM SHALL EXTEND IN

PIPE CROSSING DETAIL

SCALE: NONE

CONCRETE PADS, GRANULAR BACKFILL SHALL BE TAMPED IN 6" LAYERS AROUND BOTH


OF WATER MAIN. COST SHALL BE INCLUDED IN THE UNIT PRICES BID FOR

1) EXISTING SUBBASE MATERIAL (IF ANY) SHALL BE REPLACED, AS DIRECTED BY ENGINEER.

TYPE C PAVEMENT REPLACEMENT (ASPHALT)

TYPE D PAVEMENT REPLACEMENT (ASPHALT OVER STONE BASE) SCALE: NONE

BEARING FACE (X Y) IN SQ. FT SIZING SCHEDULE CONCRETE VOLUME IN CU. YD. 22 1/2° BEND SOIL BEARING CAPACITY SOIL BEARING CAPACITY | 1000 P.S.F. | 3000 P.S.F. | 5000 P.S.F. | 1000 P.S.F. | 3000 P.S.F. | 5000 P.S.F. 1.60 0.13 2.63 10 0.34 3.76 0.48 6.60 90° BEND TEE OR DEAD END SOIL BEARING CAPACITY SOIL BEARING CAPACITY | 1000 P.S.F. | 3000 P.S.F. | 5000 P.S.F. | 1000 P.S.F. | 3000 P.S.F. | 5000 P.S.F. 0.07 13.16 0.79 $\frac{11.16}{0.72}$ 24.06 1.39 14.44 0.90 51.10 1.54 <u>17.03</u> 1.00

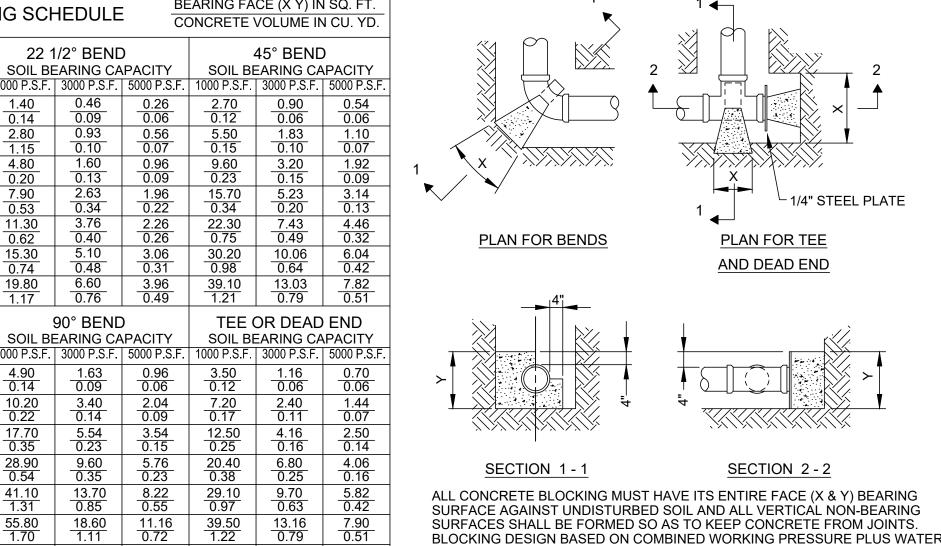

THRUST BLOCKING DETAIL SCALE: NONE

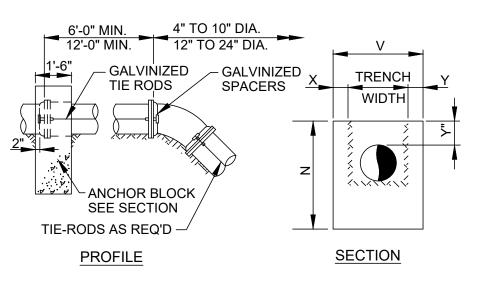


TABLE OF DIMENSINS - OVER BENDS

PIPE	11 1/-	4°, 22 1/	S	TIE RODS		
SIZE	Х	V	Υ	N	C.Y.	NO. & SIZE
4"	1'-0"	4'-3"	1'-0"	2'-4"	.55	2-3/4" DIA.
6"	1'-0"	4'-6"	1'-0"	2'-6"	.61	2-3/4" DIA.
8"	1'-0"	4'-8"	1'-0"	2'-8"	.67	2-3/4" DIA.
10"	1'-0"	4'-10"	1'-0"	2'-10"	.72	4-3/4" DIA.
12"	1'-0"	5'-0"	1'-0"	3'-0"	.78	4-3/4" DIA.
14"	1'-0"	5'-2"	1'-0"	3'-3"	.87	6-3/4" DIA.
16"	1'-0"	5'-4"	1'-0"	4'-4"	1.09	8-3/4" DIA.
18"	1'-0"	5'-6"	1'-0"	4'-7"	1.34	8-3/4" DIA.

- 1. TABLE PORTION FOR NO. AND SIZE OF TIE RODS IS APPLICABLE TO ALL TIE-IN PIPING REQUIRING SUCH REINFORCEMENT.
- 2. USE OF ANCHOR BLOCKS AND OR THRUST BLOCKS NEEDED ONLY IF A TIE-RODDED EXTENSION PIECE EQUALS OR EXCEEDS A STANDARD PIPE LENGTH.

REIN'F. FOR SAG BENDS 11 1/4° BEND-NO BLK'G. REQ'D. 22 1/2° BEND-2 #4 EQ. SPC'D. 45° BEND-#4 @ 6" C/C

HAMMER OF 240 PSI AND FOR BEARING CAPACITY FOR SAND - 1000 PSF,

SAND AND GRAVEL - 3000 PSF, SHALE - 5000 PSF.

TARFI	OF DIMENSIONS - SAG BENDS


BLOCKING

SECTION

TABEL OF DIMENSIONS - SAG BENDS									
PIPE	22	1/2° BE	ND		45° BEN	D			
SIZE	Α	W	C.Y.	Α	W	C.Y.			
4"	_		_						
6"				O'-8"	1'-8"	0.05			
8"	0'-8"	1'-4"	0.04	0'-9"	2'-8"	0.10			
10"	0'-8"	2'-0"	0.06	1'-2"	2'-10"	0.16			
12"	0'-8"	2'-4"	0.08	1'-7"	3'-0"	0.24			
14"	0'-8"	2'-9"	0.09	1'-8"	3'-2"	0.28			
16"	0'-9"	3'-4"	0.14	2'-3"	3'-4"	0.41			
18"	1'-0"	3'-6"	0.20	2'-9"	3'-6"	0.54			

3. BLOCKING DESIGN BASED ON COMBINED WORKING PRESSURE OF WATER HAMMER AND SOIL BEARING AT 3000 P.S.I.

OVER & SAG BEND THRUST BLOCKING DETAILS SCALE: NONE

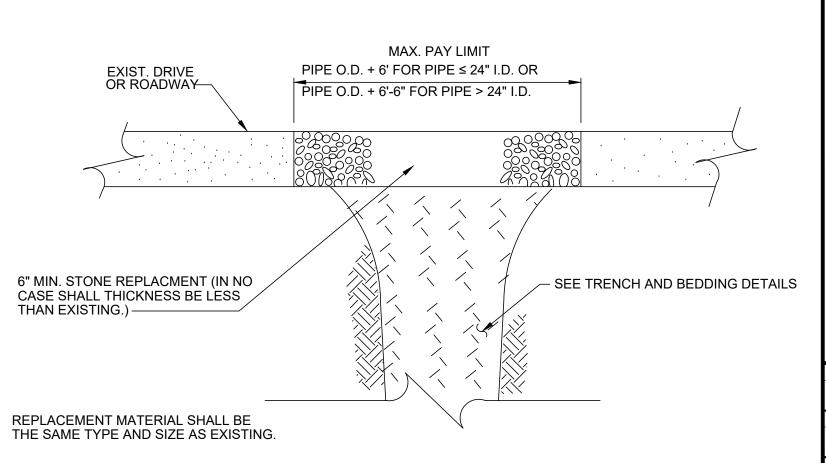

(STONE)

TYPE F PAVEMENT REPLACEMENT SCALE: NONE

EXIST. PAV'T.

O.D.O.T. ITEM 301

ODOT 407 TACK COAT APPLIED AT 0.15 GAL/SQ. YD.


1) EXISTING SUBBASE MATERIAL (IF ANY) SHALL

BE REPLACED, AS DIRECTED BY ENGINEER.

1 1/2" MIN. O.D.O.T. ITEM 448 - TYPE 1

ASPHALT SURFACE COURSE, PG 64-22

/////////////

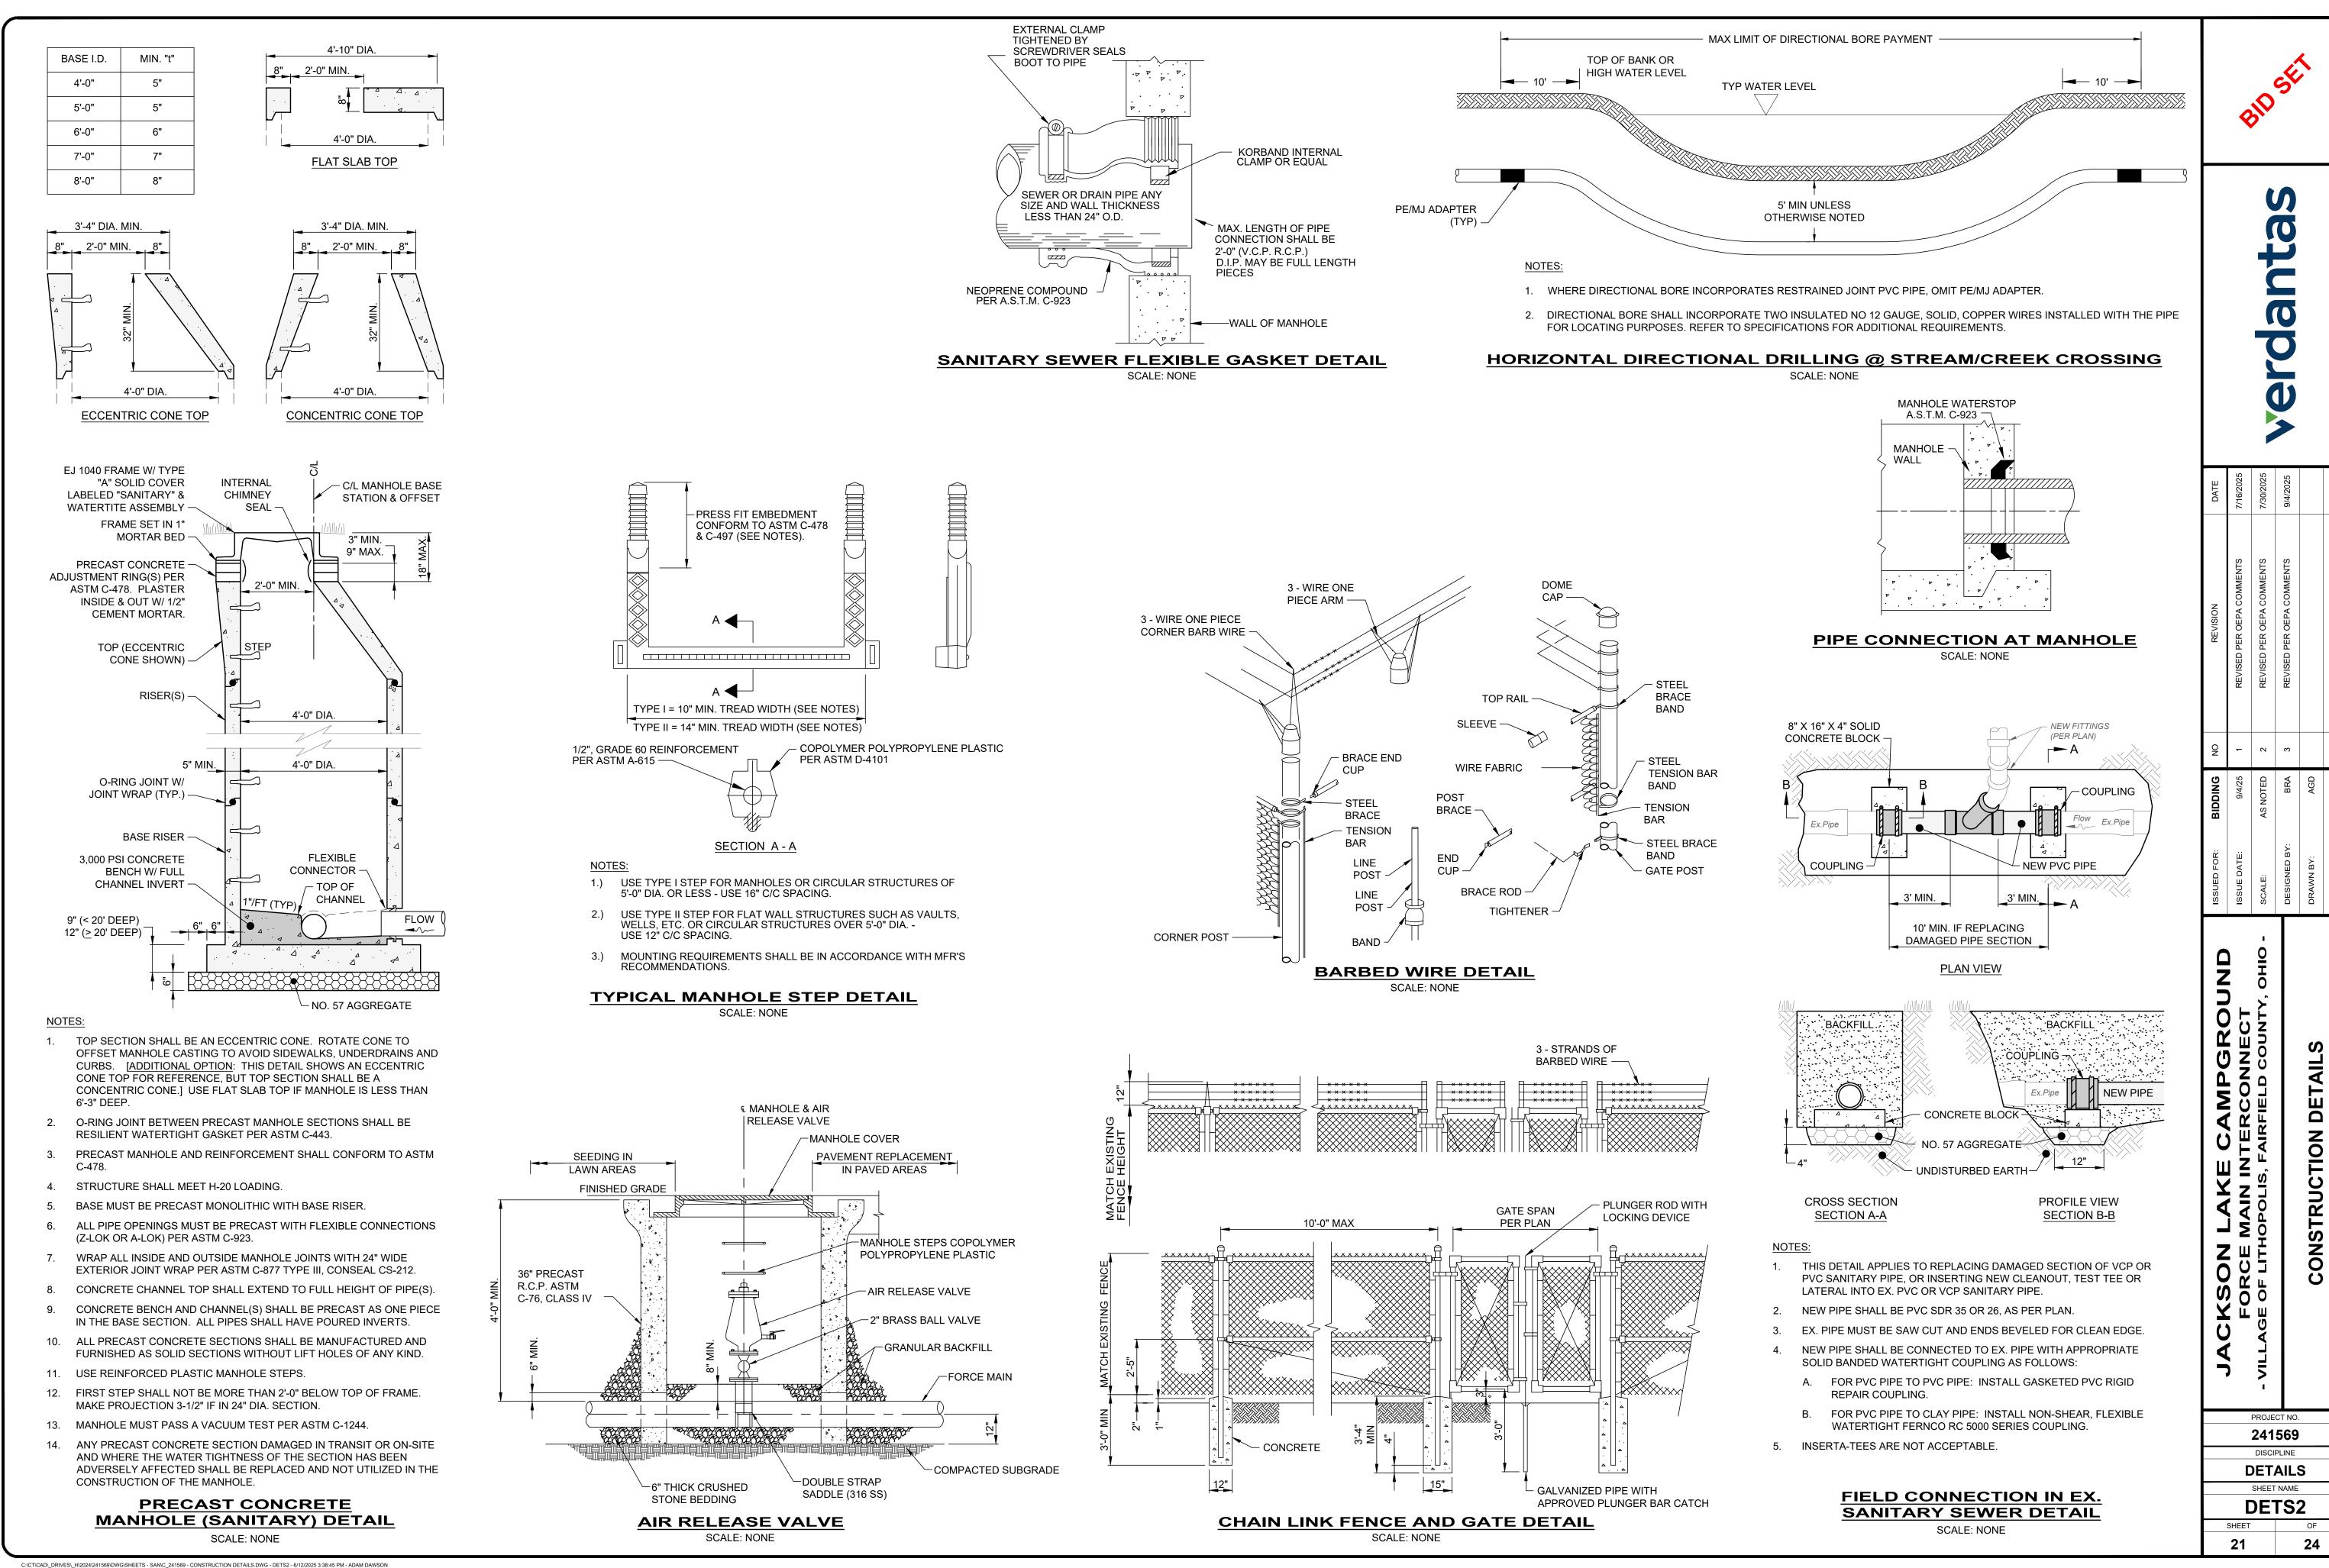

- 1. ALL ELECTRICAL EQUIPMENT AND MATERIALS WILL BE SELECTED AND INSTALLED IN COMPLIANCE WITH ALL APPLICABLE NATIONAL, STATE, AND LOCAL FIRE CODES, INCLUDING BUT NOT LIMITED TO ALL PERTINENT NFPA REGULATIONS. IT IS THE ELECTRICAL CONTRACTOR'S RESPONSIBILITY TO ENSURE COMPLIANCE WITH THESE
- 2. DO NOT INSTALL DEVICES SCALED FROM THESE DRAWINGS. ALL DEVICES SHALL BE INSTALLED AT LOCATIONS SHOWN IN THE APPROVED CONDUIT/DEVICE LAYOUT DRAWINGS AND WITH DIMENSIONS TAKEN IN THE FIELD.
- 3. ELECTRICIAN TO VISIT SITE AND VERIFY ALL EXISTING CONDITIONS PRIOR TO BID.
- 4. NO DUCTWORK OR PIPING TO BE RUN ABOVE ELECTRICAL PANELS OR THROUGH ELECTRICAL EQUIPMENT ROOMS. ELECTRICIAN SHALL COORDINATE WITH ALL TRADES FOR EQUIPMENT LAYOUTS PRIOR TO ROUGH-IN
- 5. MANUFACTURERS AND CATALOG NUMBERS SHOWN IN THE LIGHT FIXTURE SCHEDULE ARE PROVIDED TO INDICATE DESIRED LIGHT FIXTURE CHARACTERISTICS. IT IS THE INTENT OF THE DOCUMENTS TO ALLOW ALTERNATE MANUFACTURERS TO PROVIDE LIGHTING PRODUCTS FOR THE PROJECT, AS LONG AS PROPOSED ALTERNATES PROVIDE THE SAME GENERAL DESIGN AND LIGHTING CHARACTERISTICS AS NOTED IN THE LIGHT
- 6. ELECTRICIAN TO CONFIRM LOCATIONS OF ALL ELECTRICAL EQUIPMENT AND ELECTRICAL CHARACTERISTICS OF PROCESS EQUIPMENT PROVIDED BY OTHER TRADES PRIOR TO INSTALLING ROUGH-INS AS SHOWN ON THE ELECTRICAL PLANS. ALL SHOP DRAWING REQUIREMENTS WILL BE CONSIDERED AS THE MEANS AND METHODS
- 7. THIS PROJECT INVOLVES WORK AT AN INDUSTRIAL FACILITY AND THE CONTRACTOR IS EXPECTED TO PROVIDE CRAFTSMANSHIP REFLECTING THE NATURE OF THE FACILITY. CONDUITS IN PROCESS AREAS ARE TO BE SURFACE MOUNTED RIGID GALVANIZED STEEL (RGS). IN CLASSIFIED AREAS SEAL ALL CONDUITS TO RESTRICT THE PASSAGE OF GASSES AND VAPORS, AND ARRANGE SEALING FITTING DRAINS IN CONDUIT SYSTEMS TO PREVENT ACCUMULATION OF CONDENSATE ABOVE SEALS. ALL CONDUITS ENTERING OR LEAVING A MOTOR CONTROL CENTER, CONTROL PANEL, VALVE ACTUATOR, INSTRUMENT, A BUILDING, OR A PANELBOARD SHALL BE MADE WATERTIGHT USING AN INFLATABLE SEALED BLADDER DUCT SEALING SYSTEM, RAYCHEM 'RAYFLATE' DUCT SEALING SYSTEM RDSS OR APPROVED EQUAL. ALL HARDWARE IS TO BE STAINLESS STEEL UNLESS
- 8. ELECTRICIAN SHALL REVIEW ALL OTHER TRADES' CONSTRUCTION DOCUMENTS AND/OR COORDINATE WITH OTHER TRADES AND VERIFY IF THERE ARE ANY ADDITIONAL ELECTRICAL REQUIREMENTS NOT SHOWN ON ELECTRICAL DRAWINGS. COST FOR WORK SHOWN ON OTHER TRADES' DRAWINGS SHALL BE INCLUDED IN BASE BID. ALL FIELD WIRING AND TERMINATIONS OF PROCESS EQUIPMENT AND INSTRUMENTATION AND CONTROLS SHALL BE THE RESPONSIBILITY OF THE ELECTRICIAN. ALL CABLES AND WIRES PROVIDED BY VENDORS SHALL BE INSTALLED AND TERMINATED BY THE ELECTRICIAN. WIRE ALL MISCELLANEOUS POWER AND CONTROLS AS
- 9. ELECTRICAL WIRES SHALL BE MINIMUM #12 AWG, COPPER, 600 V RATED. #14 AWG COPPER SHALL BE PERMISSIBLE FOR CONTROL CIRCUITRY. AMPACITY RATINGS SHALL BE BASED UPON 75°C RATINGS.
- 10. A 4-20mA SIGNAL IS AN ANALOG SIGNAL USED TO TRANSMIT DATA (LEVEL, FLOW, ETC.) FOR PROCESS CONTROLS. THE ELECTRICIAN SHALL PROVIDE, INSTALL, AND TERMINATE SHIELDED TWISTED PAIRS (STP) WIRING IN RIGID GALVANIZED STEEL CONDUIT (RGS). RGS IS USED IN AN ATTEMPT TO REDUCE THE DISTORTION AFFECT FROM EMI AND RFI. BELOW GRADE CONDUITS SHALL BE PVC SCHED-40. PARALLEL RUNS OF DATA CONDUITS AND POWER CONDUITS SHALL BE SEPARATED BY 2 FEET. THE STP SHIELD SHALL BE
- 11. THE ELECTRICIAN SHALL BE RESPONSIBLE FOR LAYOUT AND COORDINATION OF OPENINGS AND CHASES AND SHALL PERFORM ALL CUTTING AND PATCHING AS REQUIRED TO INSTALL THEIR WORK. ALL CONCRETE HOUSE KEEPING PADS SHALL BE FRAMED AND POURED BY THE ELECTRICIAN. PADS SHALL HAVE A 45 DEGREE, 1"
- 12. THE ELECTRICIAN SHALL INSTALL & DISTRIBUTE TEMPORARY POWER SERVICE FOR THE DURATION OF THIS PROJECT AS DEFINED IN DIVISION 1 SPECIFICATIONS. ALL COSTS ASSOCIATED WITH THE INSTALLATION DISTRIBUTION AND MAINTENANCE OF THE TEMPORARY POWER IS THE RESPONSIBILITY OF THE ELECTRICIAN. THERE SHALL BE 120/240V,1PH,3W POWER AVAILABLE AT ALL LOCATIONS OF CONSTRUCTION AS DIRECTED IN FIELD AND AS SPECIFIED. ALL TEMPORARY EQUIPMENT, CONDUITS & CONDUCTORS SHALL BE COMPLETELY
- 13. ALL ELECTRICAL EQUIPMENT, DEVICES, LIGHTING FIXTURES, CONDUIT, AND WIRING SHOWN ON THE ELECTRICAL DRAWINGS IS NEW UNLESS CLEARLY CALLED OUT AS EXISTING. ALL EXISTING ELECTRICAL EQUIPMENT THAT IS CALLED OUT TO BE REUSED SHALL BE INSPECTED IN THE FIELD BY THE ELECTRICIAN AND THE CONSTRUCTION MANAGER TO DETERMINE ITS CONDITION PRIOR TO STARTING ANY WORK. PROVIDE DOCUMENTATION TO OWNER INDICATING CONDITION OF THE EXISTING EQUIPMENT, AND REUSE EXISTING EQUIPMENT ONLY IF ALL PARTIES AGREE THE CONDITION IS ACCEPTABLE. ALL EXISTING EQUIPMENT DETERMINED TO BE UNUSABLE SHALL BE REPLACED WITH LIKE KIND AS DIRECTED BY THE OWNER. ANY OF THE OWNERS EQUIPMENT DETERMINED TO BE REUSED THAT IS DAMAGED BY ANY CONTRACTOR DURING SWITCHOVER SHALL BE REPLACED BY THAT CONTRACTOR. ALL EXISTING EQUIPMENT IS THE PROPERTY OF THE OWNER (NOT THE CONTRACTOR) AND SHALL BE TREATED ACCORDINGLY.
- 14. THE ELECTRICIAN SHALL BE HELD RESPONSIBLE TO ENSURE ALL CONTROLLERS TO BE INSTALLED ARE
- 15. CONFORM TO THE NEC, OSHA, FIRE MARSHAL, BUILDING DEPARTMENT AND OTHER APPLICABLE CODES AND REGULATIONS. OBTAIN PERMITS, PAY ALL FEES, AND ARRANGE FOR REQUIRED INSPECTIONS.
- 16. ALL LIGHTING AND RECEPTACLE WIRING TO BE #12 XHHW WITH EQUIPMENT GROUND IN 3/4" C UNLESS
- 17. DO NOT MOUNT ANY LIGHT FIXTURE DIRECTLY OVER PIPING OR EQUIPMENT THAT WILL INTERFERE WITH
- 18. SIZE JUNCTION BOXES AS REQUIRED PER NEC. PROVIDE BARRIER TYPE TERMINAL STRIPS, AND ALL WIRING TO
- 21. MOTOR OVERLOAD SETTING SHALL BE FIELD SELECTED PER MOTOR NAME PLATE CURRENT AND INSTALLED
- 22. MOUNT LOCAL CONTROLS AND SERVICE DISCONNECTS ON WALL NEAREST EQUIPMENT WHERE POSSIBLE. (MAXIMUM 60" ABOVE FINISHED FLOOR OR FINAL GRADE, MAXIMUM LATERAL DISTANCE FROM WALL TO
- TRANSITION TO ABOVE GRADE SHALL BE MADE USING FACTORY PVC COATED RIGID STEEL CONDUIT SWEEPS.



		プレン		
	7/30/2025	9/4/2025		
	REVISED PER OEPA COMMENTS	REVISED PER OEPA COMMENTS		
-	2	က		
	AS NOTED	JPB	JPB	901
i : :	TE:	IGNED BY:	.WN BY:	CKED BV.

241569

DISCIPLINE

ELECTRICAL

SHEET NAME

E-01


24

JACKSON LAKE CAMPGROUND LIFT STATION RISER DIAGRAM

ONE-LINE SCHEDULE								
	A	В	©	D	E	F	G	
LS NAME	VOLTS / PH / HP	WIRE AND CONDUIT SIZE	SERVICE ENTRANCE RATED CIRCUIT BREAKER DISCONNCT	WIRE AND CONDUIT SIZE	METER SOCKET RATING	WIRE AND CONDUIT SIZE TO PUMPS	WIRE AND CONDUIT SIZE FROM GENERATOR	
JACKSON LAKE CAMPGROUND LS	240V / 1φ / 2 @ 10 HP	(2) #3/0 + (1) #3/0 NEU IN 2"C	200 AMP / 150 AMP	(2) #1/0 + (1) #1/0 NEU + (1) #4 GND IN 2"C	PER UTILITY	(3) #10 & (1) #10 GND + (2) #18 IN 1-1/2"C	(2) #1/0 + (1) #1/0 NEU + (1) #6 GND IN 2"C	

GENERAL DETAIL NOTES:

- 1. THE ELECTRICAL CONTRACTOR SHALL PROVIDE A STAINLESS STEEL UNISTRUT STRUCTURE W/ ALL S.S. HARDWARE.
- 2. THE ELECTRICAL CONTRACTOR SHALL PROVIDE THIS SYSTEM SIZED BASED ON THE APPROVED SHOP DRAWINGS AND AS NEEDED TO INSTALL ACTUAL EQUIPMENT PROVIDED.
- 3. BASE DETAIL IS TYPICAL FOR STANDARD SOIL BEARING. WHERE NON-STANDARD SOIL OCCURS, CONSULT CIVIL ENGINEER FOR BASE DESIGN PRIOR TO INSTALLATION.
- 4. THE WIDTH OF THE RACK WILL VARY BASED ON SERVICE SIZES. THE OWNER WOULD LIKE THIS TO BE AS SHORT AS POSSIBLE. PROVIDE CHANNEL ON BOTH SIDES SO THAT THE EQUIPMENT CAN BE MOUNTED ON THE FRONT AND ON THE BACK. ALL PANELS AND DEVICES SHALL BE A MINIMUM OF 18 INCHES ABOVE GRADE.
- 5. VFD'S SHALL BE SELECTED BASED UPON ANTICIPATED AMPERAGE DRAW OF THE PUMPS AND UPON A SINGLE PHASE FEED.
- 6. PUMP HORSEPOWER REFLECTED WITHIN THE ELECTRICAL DETAILS IS REFLECTIVE OF THE PUMP AMPERAGE DRAW FOR THIS APPLICATION. ALL DEVICES, CONDUCTORS, CONDUIT, ETC., SHALL BE SELECTED BASED UPON THE ANTICIPATED AMPERAGE DRAW.

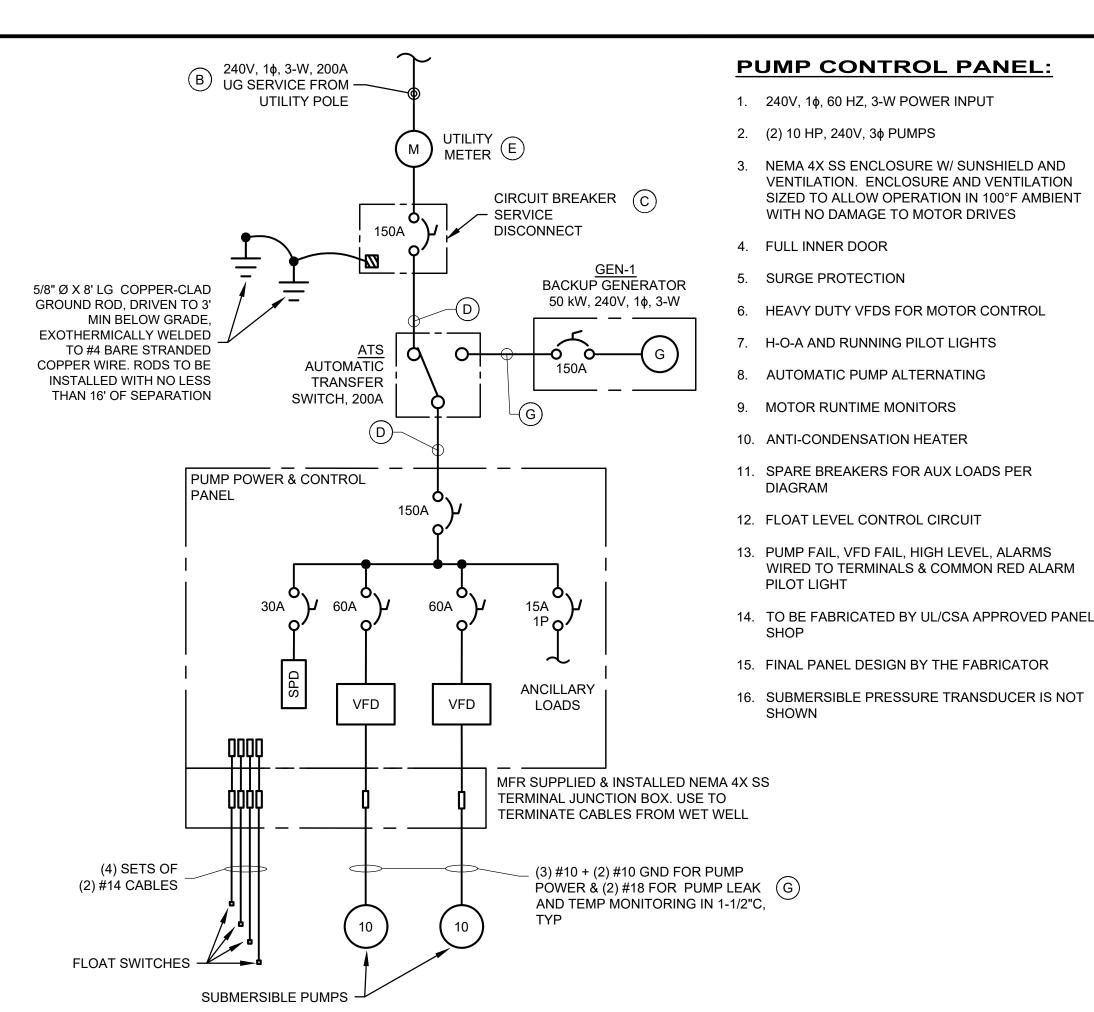

NOTE: ALL DEVICES TO BE 2-POLE, UNO.

PR. PUMP STATION CONNECTION DIAGRAM

O

KEVISION	REVISED PER OEPA COMMENTS	REVISED PER OEPA COMMENTS	REVISED PER OEPA COMMENTS		
ON N	7	2	3		
BIDDING	9/4/25	AS NOTED	JPB	JPB	JPB
ISSUED FOR:	ISSUE DATE:	SCALE:	DESIGNED BY:	DRAWN BY:	СНЕСКЕD ВҮ:

PROJECT NO. 241569 DISCIPLINE **ELECTRICAL**


SHEET NAME

E-02

GENERAL NOTES:

- 1. CONFORM TO THE NEC. OSHA. FIRE MARSHAL. BUILDING DEPARTMENT AND OTHER APPLICABLE CODES AND REGULATIONS. OBTAIN PERMITS, PAY ALL FEES, AND ARRANGE FOR REQUIRED
- COMPLY WITH ALL COUNTY/VILLAGE STANDARDS, UTILITY CO. REQUIREMENTS, SPECIFICATIONS, AND THE REQUIREMENTS OF THE CONTRACT AS SPECIFIED BY ENGINEER, PROJECT MANAGER OR OWNER.
- 3. CONTACT OUPS, VISIT SITE, AND VERIFY EXISTING CONDITIONS AND TAKE INTO CONSIDERATION
- 4. SYSTEMS ARE TO BE COMPLETE AND WORKABLE IN ALL RESPECTS. INSTALL PER MANUFACTURERS AND PROPERLY ADJUST AND START UP.
- 5. DRAWINGS ARE DIAGRAMMATIC. FIELD VERIFY EXISTING CONDITIONS AND CONNECTION POINTS PRIOR TO STARTING WORK. FULLY COORDINATE WORK WITH OTHER TRADES. APPROVED SHOP DRAWINGS ARE TO BE CONSIDERED AS THE MEANS AND METHODS OF INSTALLATION.
- 6. CONTRACTOR IS SOLELY RESPONSIBLE FOR CONSTRUCTION MEANS, METHODS, CONSTRUCTION SEQUENCES, AND WORKERS SAFETY.
- 7. PERFORM ALL DEMOLITION WORK REQUIRED FOR PROJECT AND DISPOSE OF DEMOLITION MATERIALS IN CODE APPROVED MANNER.
- 8. ALL CUTTING, TRENCHING, BACKFILLING AND PATCHING OF EXISTING SURFACES INCIDENTAL TO THIS WORK SHALL BE PERFORMED BY THIS CONTRACTOR. CUTTING AND PATCHING SHALL BE PERFORMED IN COMPLIANCE WITH THE PROJECT REQUIREMENTS. ALL BELOW GRADE CONDUITS SHALL BE 24" BELOW GRADE.
- 9. ALL ELECTRICAL EQUIPMENT AND WIRING AND OTHER ELECTRICALLY CONDUCTIVE MATERIAL. LIKELY TO BECOME ENERGIZED SHALL BE BONDED AND GROUNDED PER ARTICLE 250 OF THE NATIONAL ELECTRICAL CODE.
- 10. WIRES SHALL BE:
- 10.1. #12 AWG AND #10 SOLID OR STRANDED CONDUCTOR COPPER, 600V, TYPE THWN/THHN, WHHM OR THW (75/90°C)
- 10.2. #8 AWG TO AND INCLUDING 600 MCM AWG, STRANDED CONDUCTOR, 600V, TYPE
- THWN/THHN, WHHM OR THW (75/90°C) 10.3. COLOR CODE ALL WIRES PER NEC, GROUND CONDUCTORS SHALL BE GREEN. ALL WIRING SHALL BE IN CONDUIT, RIGID GALVANIZED STEEL ABOVE GRADE AND SCHEDULE 40 PVC BELOW GRADE.

- 11. ALL ELECTRICAL EQUIPMENT SHALL BE UL LISTED FOR THE PURPOSE AND ENVIRONMENT AND SHALL BE NOTED AS SUCH.
- 12. 75°C CONDUCTOR RATINGS HAVE BEEN APPLIED UP TO 100 AMPS. ALL EQUIPMENT TERMINATION PROVISIONS SHALL BE LISTED AND IDENTIFIED FOR USE WITH 75°C CONNECTIONS PER NEC 110-14C
- 13. ALL EXISTING CIRCUITS REQUIRED TO REMAIN ACTIVE SHALL BE REWORKED OR MAINTAINED AS REQUIRED.
- 14. ALL ELECTRICAL EQUIPMENT, DEVICES, CONDUIT, AND WIRING SHOWN ON THE ELECTRICAL DRAWINGS IS NEW UNLESS CLEARLY CALLED OUT AS EXISTING. ALL EXISTING ELECTRICAL EQUIPMENT THAT IS CALLED OUT TO BE REUSED SHALL BE INSPECTED IN THE FIELD BY THE ELECTRICAL CONTRACTOR AND THE CONSTRUCTION MANAGER TO DETERMINE ITS CONDITION PRIOR TO STARTING ANY WORK. PROVIDE DOCUMENTATION TO OWNER INDICATING CONDITION OF THE EXISTING EQUIPMENT AND REUSE EXISTING EQUIPMENT ONCE ALL PARTIES AGREE THE CONDITION IS ACCEPTABLE. ALL EXISTING EQUIPMENT DETERMINED TO BE UNUSABLE SHALL BE REPLACED WITH LIKE KIND AS DIRECTED BY THE OWNER. ANY OF THE OWNERS EQUIPMENT DETERMINED TO BE REUSED THAT IS DAMAGED BY ANY CONTRACTOR DURING SWITCHOVER SHALL BE REPLACED BY THAT CONTRACTOR. ALL EXISTING EQUIPMENT IS THE PROPERTY OF THE OWNER (NOT THE CONTRACTOR) AND SHALL BE TREATED ACCORDINGLY.
- 15. ALL CABLES ARE TO BE CLEARLY MARKED WITH BRADY TYPE LABELS AND RECORD DRAWINGS SHALL INDICATED THE INDIVIDUAL MARKINGS.

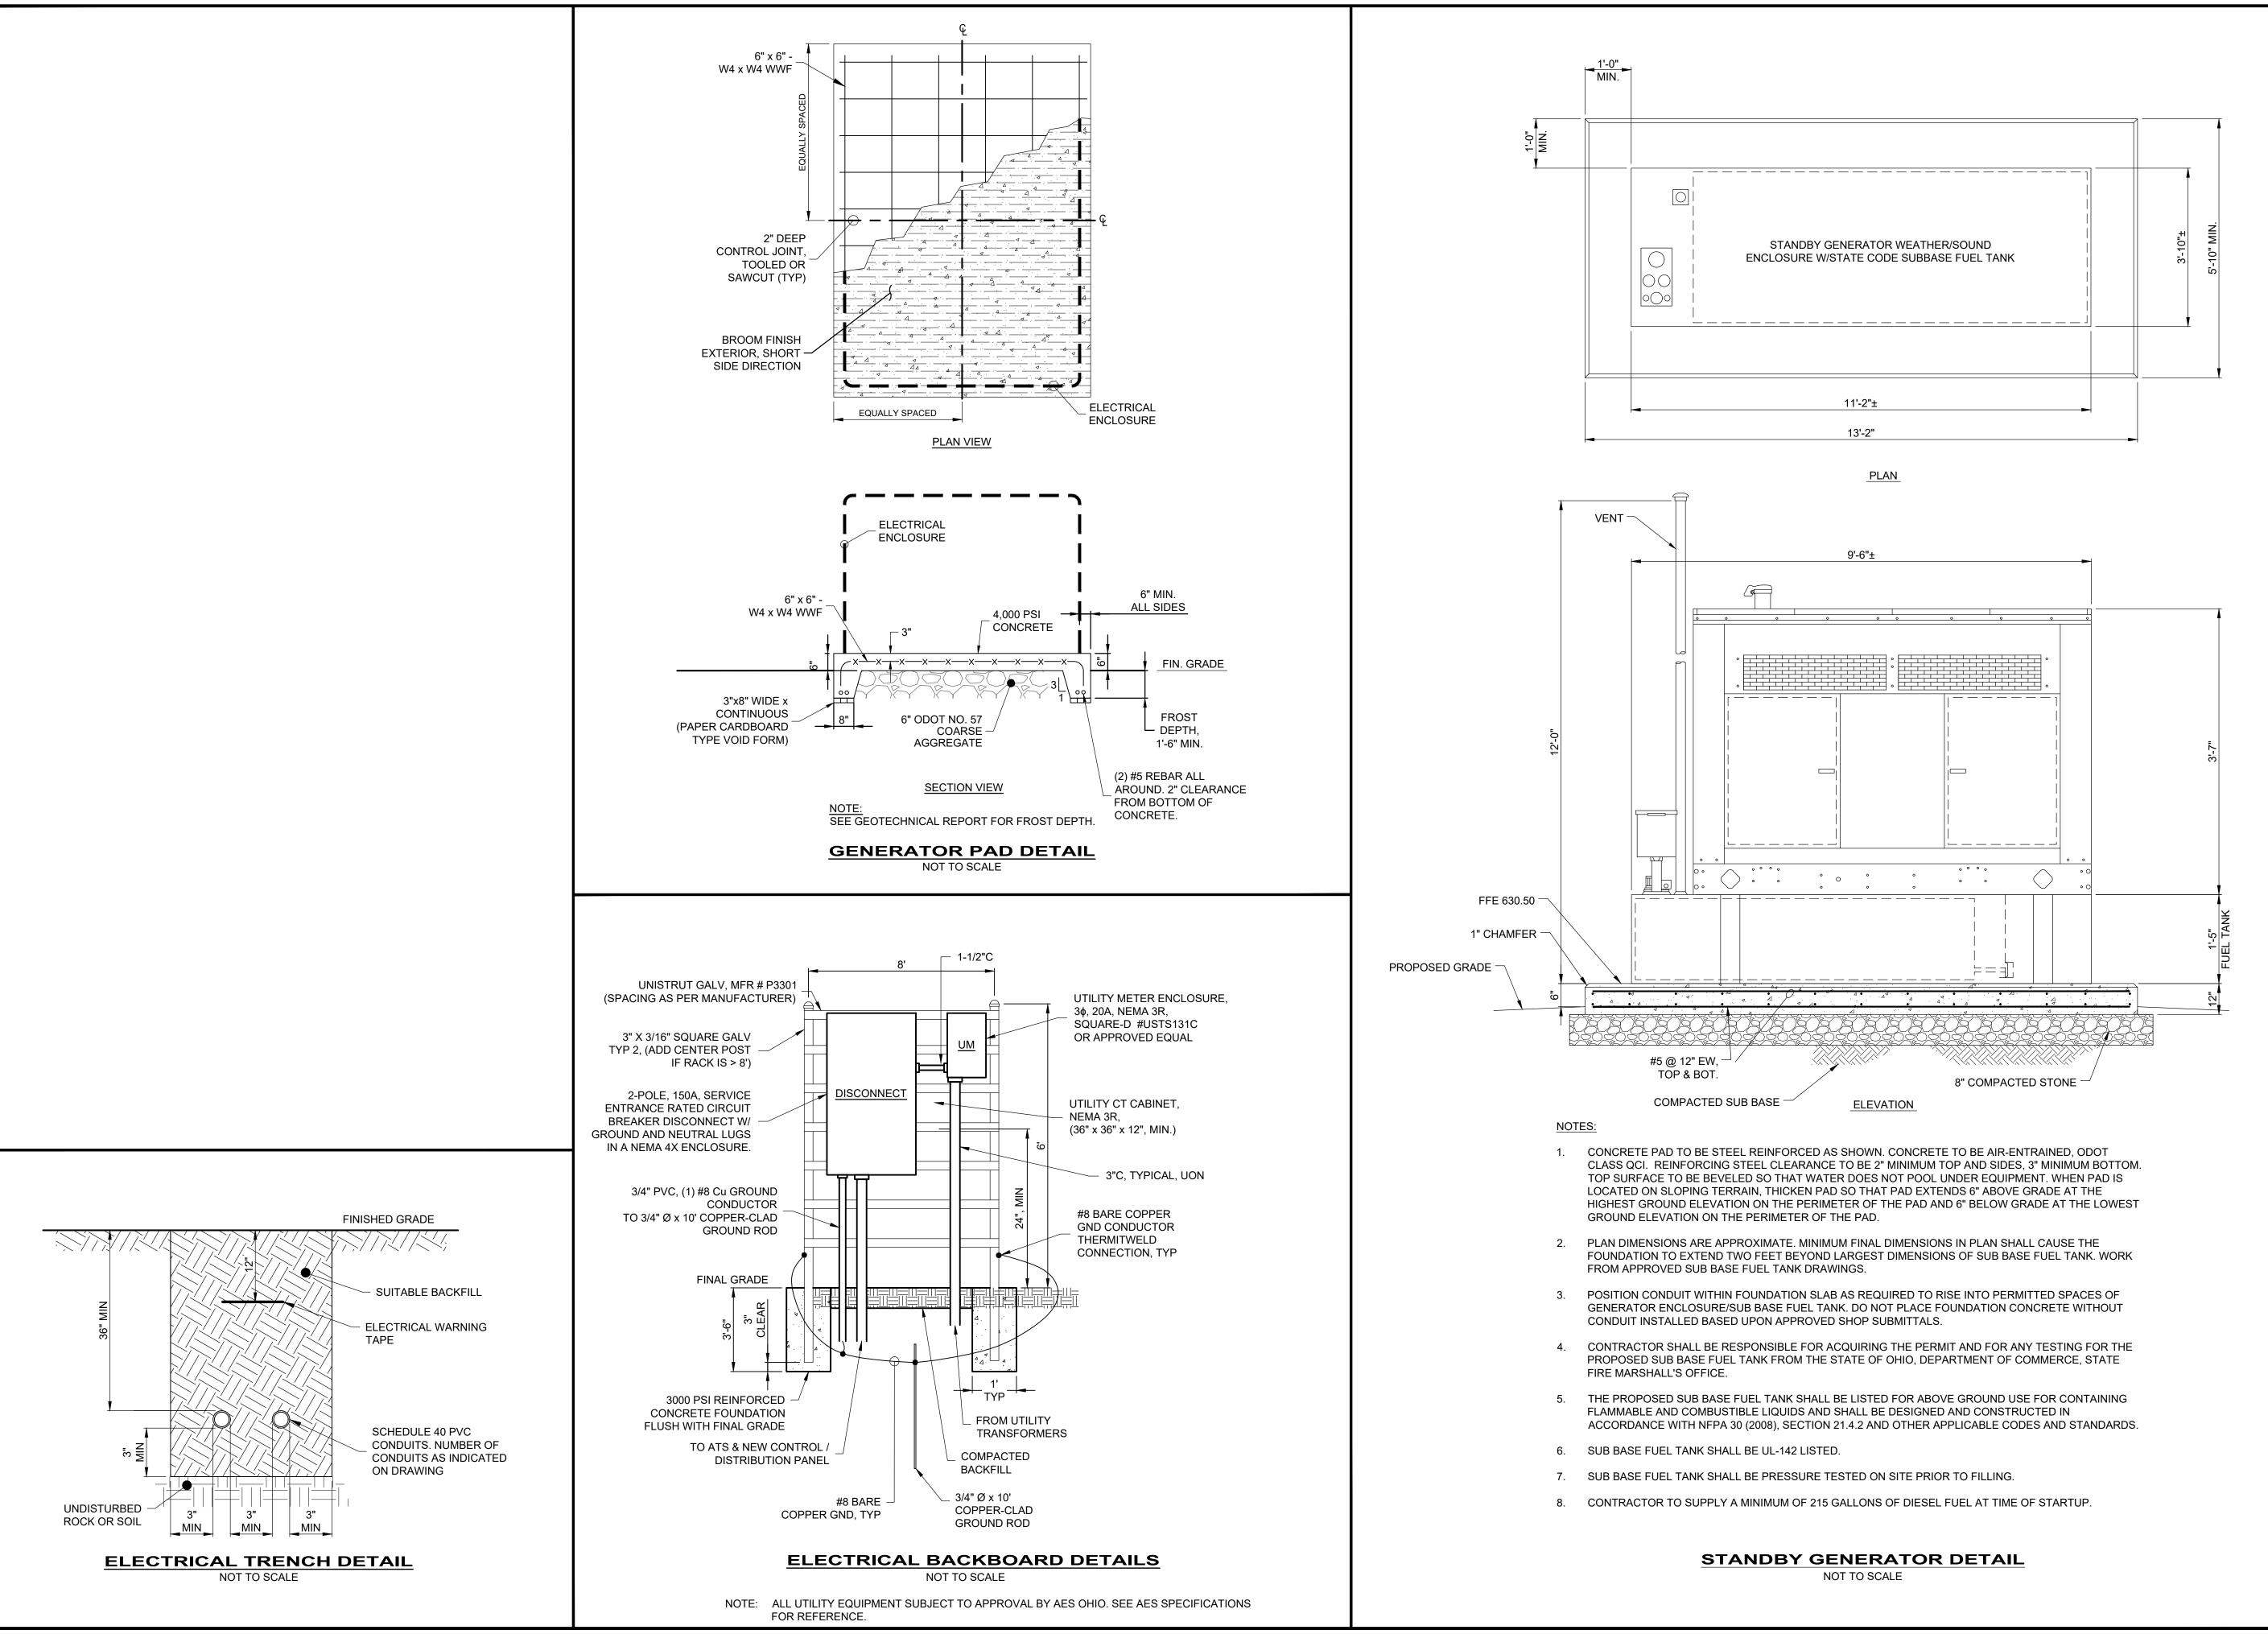

DISCIPLINE

ELECTRICAL SHEET NAME

E-03

C:\CT\CAD_DRIVES_H\2024\241569\DWG\SHEETS - SAN\E_241569 - ELECTRICAL DETAILS.DWG - E-03 - 6/18/2025 9:40:20 AM - ADAM DAWSON