

# SR 124 WATERLINE IMPROVEMENTS PIKE WATER, INC.

PIKE COUNTY, OHIO

OCTOBER 2022

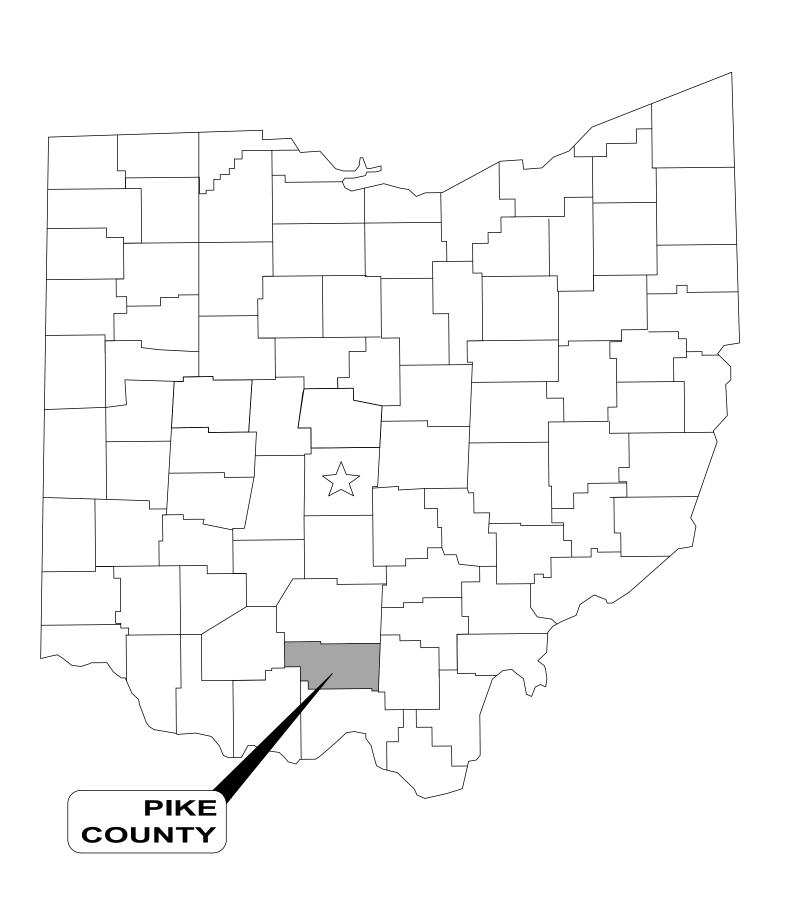

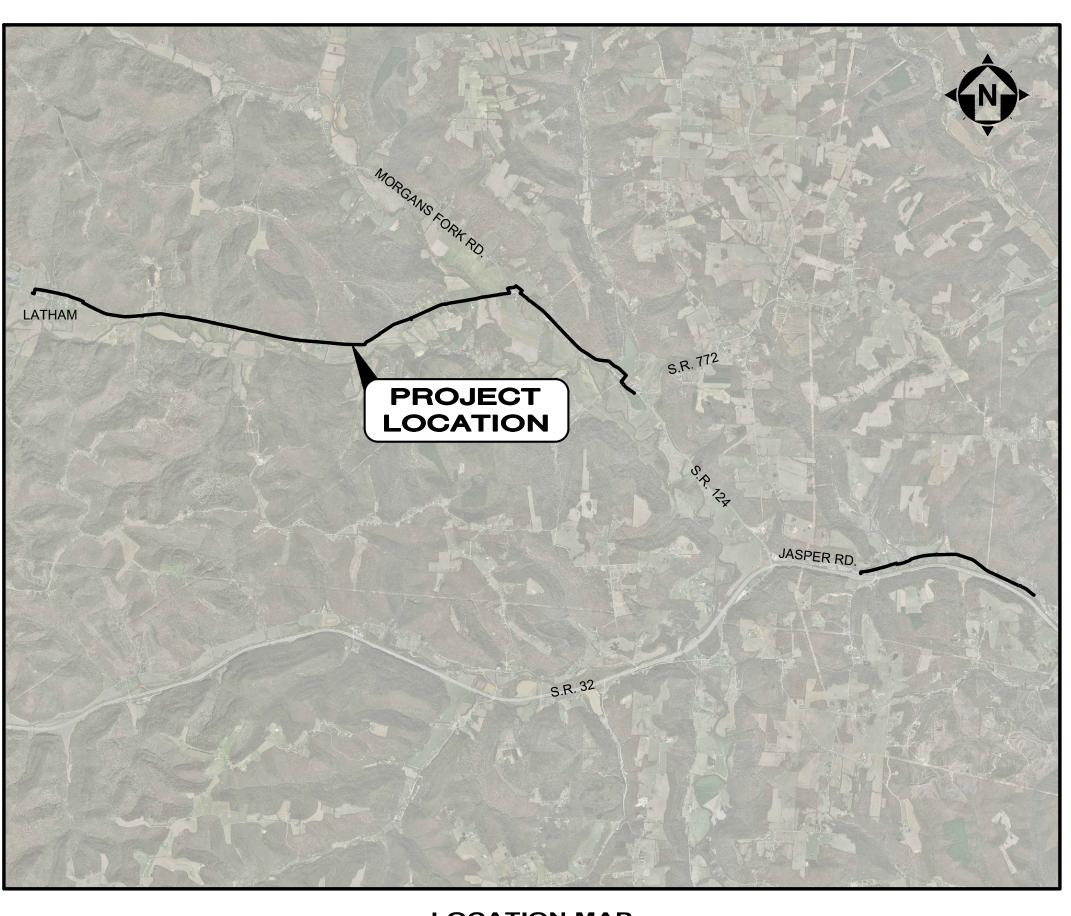

200' 0' 200'

SCALE: 1" = 200'

### PIKE WATER APPROVALS:

FARON YOUNG, GENERAL MANAGER

#### **ENGINEER:**

CT CONSULTANTS, INC.
7965 NORTH HIGH STREET, SUITE 340
COLUMBUS, OH 43235

(614) 885-1700 PHONE (614) 885-1701 FAX

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Backara Ti Hoderson

BARBARA R. ANDERSON

3/3/202

OHIO P.E. No. E-51761



1. UNDERGROUND BUILDING SERVICE UTILITY LINES ARE NOT SHOWN ON THE PLANS. THE CONTRACTOR SHALL BE RESPONSIBLE FOR LOCATING, MAINTAINING AND REPLACING AS NECESSARY TO ENSURE CONTINUAL SERVICE TO BUILDINGS

2. THE CONTRACTOR IS RESPONSIBLE TO CALL OHIO UTILITIES PROTECTION SERVICE @ 1-800-362-2764, THREE WORKING DAYS PRIOR TO CONSTRUCTION.

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ENGINEER'S PROJECT No. 220239



your trusted advisor

Consultants architects
planners

	SR 124 WATERLINE	TERLINE	ISSUED FOR:	BIDDING	ON	REVISION	DATE	
		MENTS	ISSUE DATE:	2/6/2025	_	REVISED FOR CONSTRUCTION	3/20/2025	
	PROJE	NTY, OH -	SCALE:	AS SHOWN				2010
PLINE	CT NO.		DESIGNED BY:	RAB				
-		HEET	DRAWN BY:	RAB				

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#### **GENERAL NOTES:**

THE TERM CONTRACTOR IN THESE DOCUMENTS REFERS TO THE GENERAL CONTRACTOR, ALL SUB-CONTRACTORS, SUPPLIERS AND SERVICE SUPPLIERS PROVIDING SERVICES, MATERIAL OR LABOR DIRECTLY OR INDIRECTLY TO THIS PROJECT.

BY SUBMITTING A BID OR STARTING CONSTRUCTION THE CONTRACTOR

THE CONTRACTOR HAS VISITED THE SITE AND IS SATISFIED THAT HE UNDERSTANDS ALL SITE CONDITIONS THAT MAY HAVE AN EFFECT ON THE BID PRICE AND CONSTRUCTION SCHEDULE.

THE CONTRACTOR FULLY UNDERSTANDS THE MAKE-UP, CONSTRUCTION, AND OPERATION OF ALL SYSTEMS AND EQUIPMENT HE IS CONSTRUCTING AND THAT HE HAS INCLUDED IN HIS PRICE ALL MATERIALS, SUPPLIES, ACCESSORIES, AND SERVICES NECESSARY TO MAKE THESE SYSTEMS COMPLETE AND OPERATIONAL WHETHER SUCH MATERIALS, SUPPLIES, AND SERVICES ARE EXPLICITLY SHOWN ON THE DRAWINGS OR INCLUDED IN THESE SPECIFICATIONS OR ONLY IMPLIED BY THE CLEAR INTENT OF THESE DOCUMENTS FOR THE CONTRACTORS TO PROVIDE A COMPLETE AND FULLY OPERATIONAL SYSTEM AS PART OF THE SCOPE OF WORK UNDERTAKEN BY THIS CONTRACTOR.

THE OWNER DOES NOT SUPERVISE, NOR ARE THEY ENGAGED IN CONSTRUCTION. THE OWNER HAS NO CONTROL OVER OR CHARGE OF, AND THEREFORE IS NOT RESPONSIBLE FOR CONSTRUCTION MEANS, METHODS, TECHNIQUES OR PROCEDURES, OR FOR SAFETY PRECAUTIONS AND PROGRAMS IN CONNECTION WITH THE WORK. THESE ARE SOLELY THE CONTRACTOR'S RESPONSIBILITY UNDER THE CONTRACT FOR CONSTRUCTION.

MATERIAL SAFETY DATA SHEETS (MSDS'S) FOR ALL PRODUCTS AND/OR BUILDING MATERIALS THAT MAY CONTAIN HAZARDOUS OR TOXIC CHEMICALS SHALL BE MADE READILY AVAILABLE TO CONTRACTOR, EMPLOYEES AND OWNER'S PERSONNEL DURING CONSTRUCTION.

#### MAINTAINING TRAFFIC:

THE CONTRACTOR SHALL BE RESPONSIBLE FOR MAINTAINING AND CONTROLLING TRAFFIC ON ALL STREETS AND ROADS AFFECTED BY CONSTRUCTION AND SHALL, PRIOR TO ANY CONSTRUCTION, SUBMIT A CONSTRUCTION SCHEDULE TO THE OWNER FOR APPROVAL INDICATING DATES AND DURATION OF EACH PHASE OF CONSTRUCTION.

ALL CONSTRUCTION SIGNS AND TEMPORARY TRAFFIC CONTROL AND PROTECTION DEVICES SHALL BE ERECTED AND MAINTAINED IN ACCORDANCE WITH "OHIO DEPARTMENT OF TRANSPORTATION MANUAL OF UNIFORM TRAFFIC CONTROL DEVICES AND O.D.O.T. ITEM 614 - MAINTAINING TRAFFIC.

MAINTENANCE OF TRAFFIC OPERATIONS MUST ADHERE TO ALL REGULATIONS AND/OR MANDATES BY THE APPROPRIATE MAINTAINING AUTHORITY OF THE ROADWAY.

COSTS FOR MAINTENANCE OF TRAFFIC SHALL BE INCLUDED IN THE LUMP SUM PAY ITEM -MAINTAINING TRAFFIC.

#### TEMPORARY SURFACES:

TEMPORARY SURFACES WHERE EXCAVATIONS ARE LOCATED IN STREETS, DRIVES AND PARKING AREAS SHALL BE FURNISHED AND PLACED BY THE CONTRACTOR AND SHALL BE FULLY MAINTAINED TO MINIMIZE INCONVENIENCE TO THE PUBLIC.

#### SAFETY TRENCH PROTECTION AND BACKFILLING:

THE CONTRACTOR SHALL BE SOLELY RESPONSIBLE FOR COMPLYING WITH ALL FEDERAL, STATE, AND LOCAL SAFETY REQUIREMENTS, INCLUDING THE OCCUPATIONAL SAFETY AND HEALTH ACT OF 1970, TOGETHER WITH EXERCISING PRECAUTIONS AT ALL TIMES FOR THE PROTECTION OF PERSONS (INCLUDING EMPLOYEES) AND PROPERTY. IT IS ALSO THE SOLE RESPONSIBILITY OF THE CONTRACTOR TO INITIATE, MAINTAIN AND SUPERVISE ALL SAFETY REQUIREMENT, PRECAUTIONS AND PROGRAMS IN CONNECTION WITH THE WORK. THE CONTRACTOR SHALL ALSO ABIDE BY ALL ORDINANCES OF THE MUNICIPALITY.

BACKFILLING SHALL FOLLOW IMMEDIATELY BEHIND CONSTRUCTION. ONLY THE MINIMUM LENGTH OF TRENCH REQUIRED FOR CONSTRUCTIONS SHALL BE OPEN AT ANY GIVEN TIME, AND NO EXCAVATIONS SHALL REMAIN OPEN OVERNIGHT OR BEYOND THE COMPLETION OF THE DAYS WORK.

THE CONTRACTOR SHALL, AT ALL TIMES DURING CONSTRUCTION, PROVIDE PROPER AND SATISFACTORY MEANS AND DEVICES FOR THE REMOVAL OF ALL WATER ENTERING THE EXCAVATIONS AND SHALL REMOVE ALL SUCH WATER AS FAST AS IT MAY COLLECT IN SUCH A MANNER AS SHALL NOT INTERFERE WITH THE EXECUTION OF THE WORK. FLOWS SHOULD BE FILTERED BEFORE ENTERING STORM DRAINS OR STREAMS.

#### CHANGES TO WORK:

ANY MODIFICATIONS AND CHANGES TO THE WORK AS SHOWN ON THE DRAWINGS MUST HAVE THE PRIOR WRITTEN APPROVAL OF THE OWNER AND ENGINEER

#### SITE INVESTIGATION:

THE CONTRACTOR SHALL INVESTIGATE THE SITE PRIOR TO BIDDING. THE CONTRACTOR SHALL EXAMINE IN THE FIELD THE ACCESS PROBLEMS, AVAILABLE WORK AREAS, WATER CONDITIONS, NEARBY STRUCTURES, TREES, GROUND CONDITIONS AND FILL MATERIALS. FIELD VISITS SHALL BE COORDINATED WITH THE OWNER

#### **SURVEY MONUMENTS:**

ALL PROPERTY LINE MARKERS (IRON PINS, SPIKES, CONCRETE MONUMENTS, ETC.) THAT ARE LIABLE TO BE DISTURBED BY THE CONSTRUCTION OPERATIONS SHALL BE REFERENCED AND PROPERLY RESET AT THE CONTRACTOR'S EXPENSE FOLLOWING CONSTRUCTION UNDER THE SUPERVISION OF A PROFESSIONAL SURVEYOR REGISTERED IN THE STATE OF OHIO.

#### DISPOSAL OF WASTE CONSTRUCTION MATERIALS:

THE CONTRACTOR SHALL MAKE HIS OWN ARRANGEMENTS FOR THE DISPOSAL OF SURPLUS EXCAVATED MATERIAL AND WASTE CONSTRUCTION MATERIALS. TREES, LIMBS, BRUSH AND STUMPS REMOVED BY THE CONTRACTOR'S OPERATION SHALL BE REMOVED FROM THE CONSTRUCTION SITE AND DISPOSED OF BY THE CONTRACTOR FOLLOWING OEPA REGULATIONS.

#### ITEMS TO BE INCLUDED:

THE CONTRACTOR SHALL FURNISH ALL TOOLS, MATERIAL, LABOR AND INCIDENTALS AND APPURTENANCES TO COMPLETE IN EVERY DETAIL AND LEAVE IN WORKING ORDER ALL ITEMS OF WORK CALLED FOR AND/OR SHOWN IN THE DRAWINGS. MATERIAL OR WORK NOT SPECIFICALLY MENTIONED OR SHOWN IN THE DRAWINGS, BUT NECESSARY TO COMPLETE THE WORK SHALL BE FURNISHED,

#### DRAINAGE TILE:

FIELD DRAINAGE TILE, STORM DRAINS, UNDER DRAINS, DRIVE CULVERTS AND FIELD TILE MAY BE ENCOUNTERED DURING THE COURSE OF EXCAVATION UNDER THIS CONTRACT. THE CONTRACTOR SHALL REPAIR, REPLACE OR REROUTE THE AFFECTED TILE SO AS TO LEAVE THE DRAINAGE SYSTEM IN ORIGINAL CONDITION OR BETTER AND THE SYSTEM IN GOOD WORKING ORDER. THE COST OF WORK THIS SHALL BE INCLUDED IN THE RELATED BID ITEMS.

UNLESS OTHERWISE NOTED, THE CONTRACTOR SHALL BE RESPONSIBLE FOR OBTAINING ALL APPLICABLE PERMITS EXCEPT OHIO EPA PERMIT TO INSTALL FOR THE PROPOSED FACILITIES AND RIGHT OF WAY PERMITS FOR THE AREAS DESIGNATED ON THE DRAWINGS.

THE CONTRACTOR SHALL BE RESPONSIBLE FOR PERFORMING ALL DETAIL SURVEYS NEEDED FOR CONSTRUCTION.

#### **ELEVATION DATUM:**

ALL ELEVATIONS ARE BASED ON U.S.G.S. 1988 DATUM.

#### **WORK LIMITS**

THE CONTRACTOR SHALL CONFINE HIS ACTIVITIES TO THE PROJECT SITE UNDER DEVELOPMENT, THE EXISTING RIGHTS-OF-WAY, OR CONSTRUCTION AND PERMANENT EASEMENTS AND SHALL NOT TRESPASS UPON OTHER PRIVATE PROPERTY WITHOUT WRITTEN CONSENT OF THE OWNER. EXISTING PROPERTY LINES AND RIGHTS OF WAY SHOWN ON THE DRAWINGS ARE APPROXIMATE. CONTRACTOR TO FIELD VERIFY EXACT LOCATION IN ADVANCE OF CONSTRUCTION OPERATIONS.

#### **EROSION CONTROL DEVICES AND MEASURES:**

THE CONTRACTOR SHALL PROVIDE EROSION AND SEDIMENT CONTROL DEVICES AND MEASURES SO THAT THE SITE COMPLIES WITH THE REQUIREMENTS AND RECOMMENDATIONS OF THE OHIO DEPARTMENT OF NATURAL RESOURCES; RAINWATER AND LAND DEVELOPMENT MANUAL; OHIO STANDARDS FOR STORM WATER MANAGEMENT AND LAND DEVELOPMENT AND URBAN STREAM

THE CONTRACTOR SHALL RESTRICT THE EMISSION OF ALL FUGITIVE DUST AND PARTICULATE, AIRBORNE OR OTHERWISE, THAT ARISES FROM HIS OPERATION AND ACTIVITIES RELATIVE TO THIS PROJECT. DUST CONTROL MEASURES SHALL BE IMPLEMENTED AND MAINTAINED PURSUANT TO THE APPLICABLE REQUIREMENTS OF THE OHIO ADMINISTRATIVE CODE (OAC) SECTION 3745-17-08 IN EFFECT AT THE TIME OF THE CONTRACT. SUCH MEASURES SHALL APPLY TO ACTIVITIES ON-SITE AS WELL AS OFF-SITE.

#### ROCK EXCAVATION AND DISPOSAL:

THE COST OF ALL ROCK REMOVAL AND DISPOSAL SHALL BE INCLUDED IN THE UNIT PRICES BID FOR THE VARIOUS PIPELINE ITEMS. BLASTING WILL NOT BE PERMITTED. NO SEPARATE PAYMENT WILL BE MADE FOR ROCK EXCAVATION.

#### ESTIMATED QUANTITIES:

ALL ITEMS OF WORK CALLED FOR ON THE PLAN FOR WHICH NO SPECIFIC METHOD OF PAYMENT IS PROVIDED, SHALL BE PERFORMED BY THE CONTRACTOR AND THE COST OF THE SAME SHALL BE INCLUDED IN THE RELATED VARIOUS BID ITEMS FOR PAYMENT.

#### **EXISTING WATER DISTRIBUTION SYSTEM:**

UNLESS OTHERWISE INDICATED, THE EXISTING WATERLINES SHOWN ON THESE DRAWINGS ARE OWNED AND OPERATED BY PIKE WATER, INC.

#### **OPERATION OF EXISTING VALVES:**

OPERATION OF EXISTING VALVES SHALL ONLY BE DONE BY THE OWNER OR OWNER'S REPRESENTATIVE.

ALL BENDS, JOINT DEFLECTIONS AND FITTINGS SHALL BE BACKED WITH CONCRETE IN ACCORDANCE WITH THE SPECIFICATIONS AND BACKING DETAILS.

#### WATER MAINS SHALL BE LAID WITH A MINIMUM OF 4'-0" COVER FROM FINISHED GRADE TO THE TOP OF THE WATER MAIN, UNLESS OTHERWISE NOTED.

LOWERED AT THE TIME OF CONSTRUCTION.

GRADE CONFLICT: IN CASE OF CONFLICT IN GRADE BETWEEN WATER MAINS AND SEWERS, THE WATER MAINS SHALL BE

UNLESS OTHERWISE APPROVED BY THE ENGINEER, WATER MAINS SHALL BE DEFLECTED AROUND STRUCTURES WITHOUT THE USE OF SPECIAL FITTINGS AND WITHOUT EXCEEDING THE MANUFACTURER'S ALLOWABLE DEFLECTION.

IF THE TOP OF THE OPERATING NUT FOR ANY VALVE IS MORE THAN 36" BELOW THE FINISHED GRADE, AN EXTENSION STEM SHALL BE PROVIDED TO PLACE THE OPERATING NUT BETWEEN 24" AND 36" OF THE FINISHED GRADE.

#### GRANULAR BACKFILL:

EXCAVATION AT ALL STREETS, DRIVES, WALKS, PARKING AREAS AND OTHER ROADWAYS SHALL BE BACKFILLED AND COMPACTED WITH GRANULAR MATERIAL CONFORMING TO THESE DRAWINGS. ADDITIONAL GRANULAR MATERIAL SHALL BE STOCKPILED AT SELECT LOCATION (APPROVED BY OWNER) FOR USE WHEN SETTLEMENT OCCURS. ALL GRANULAR MATERIAL SHALL BE MECHANICALLY COMPACTED IN 8" LAYERS. THE COST OF ALL GRANULAR BACKFILL AND PLACEMENT SHALL BE INCLUDED IN THE BID PRICE OF THE RESPECTIVE WATERLINE ITEMS. SEPARATE PAYMENT WILL NOT

ALL LEAKS ENCOUNTERED DURING TESTING AND CONSTRUCTION SHALL BE LOCATED AND REPAIRED AT THE CONTRACTOR'S EXPENSE.

#### MINIMUM PRESSURE:

THE NORMAL WORKING PRESSURE MAINTAINED AT SERVICE CONNECTIONS SHALL NOT BE LESS THAN 35 P.S.I.. SYSTEM OPERATION SHALL MAINTAIN A MINIMUM PRESSURE OF 20 P.S.I. AT GROUND LEVEL AT ALL POINTS IN THE DISTRIBUTION SYSTEM UNDER ALL CONDITIONS OF FLOW.

#### WATER SERVICE INTERRUPTIONS:

INTERRUPTION OF EXISTING WATER SERVICE IS PROHIBITED WITHOUT THE AUTHORIZATION OF THE OWNER AND ENGINEER. WATER SERVICE INTERRUPTIONS THAT ARE REQUIRED AS PART OF THIS PROJECT SHALL BE COORDINATED WITH THE OWNER AND ENGINEER AND A MINIMUM NOTICE OF 72 HOURS SHALL BE PROVIDED.

#### WATERLINE BREAKS:

IN THE EVENT THAT THE CONTRACTOR'S OPERATIONS CAUSE A BREAK IN THE EXISTING WATER MAINS OR SERVICE LINE, THE CONTRACTOR SHALL CEASE CONSTRUCTION OPERATIONS AND REPAIR THE BREAK AT HIS OWN COST. ONCE THE BREAK HAS BEEN REPAIRED TO SATISFACTION OF THE OWNER OR ENGINEER, CONSTRUCTION OPERATIONS MAY RESUME.

#### MATERIAL STANDARDS

ALL MATERIALS UTILIZED IN THE CONSTRUCTION OF THIS PROJECT THAT WILL COME IN CONTACT WITH POTABLE WATER SHALL BE AWWA AND/OR NSF 60/61 APPROVED. PIPE AND MATERIALS INCORPORATED INTO THIS PROJECT SHALL ALSO CONFORM TO THE LATEST REVISION OF THE APPROPRIATE STANDARDS AS FOLLOWS:

AWWA C900 PIPE: FITTINGS: AWWA C-153 VALVES: AWWA C-509

SERVICE LINE: AWWA C-901 APPURTENANCES: AWWA/NSF STANDARDS AS APPLICABLE

#### INDIVIDUAL BOOSTER PUMPS: CONNECTION OF INDIVIDUAL BOOSTER PUMPS TO THE PROPOSED WATERLINE IS PROHIBITED.

SERVICE CONNECTIONS: THE SERVICE CONNECTION LOCATIONS SHOWN ON THE PLANS ARE APPROXIMATE AND ARE FOR

#### REFERENCE ONLY.

SUBSURFACE CONDITIONS: IT IS THE OBLIGATION AND RESPONSIBILITY OF THE CONTRACTOR TO MAKE HIS OWN

INVESTIGATIONS OF SUBSURFACE CONDITIONS PRIOR TO SUBMITTING HIS BID PROPOSAL.

#### FITTINGS REQUIRED FOR CONSTRUCTION:

THE CONTRACTOR SHALL FURNISH ALL FITTINGS REQUIRED, WHETHER SHOWN ON THE DRAWINGS OR NOT, NECESSARY TO ACHIEVE THE DESIRED HORIZONTAL/VERTICAL ALIGNMENT AND COMPLETE CONSTRUCTION. COST FOR THE REQUIRED FITTINGS SHALL BE INCLUDED IN THE VARIOUS WATERLINE ITEMS BID.

#### **EQUIPMENT MOVEMENT**

NO NON RUBBER-TIRED VEHICLES SHALL BE MOVED ON ANY STREETS. EXCEPTIONS MAY BE GRANTED BY THE OWNER WHERE SHORT DISTANCES AND SPECIAL CIRCUMSTANCES ARE INVOLVED AND PROTECTION IS PROVIDED. THE CONTRACTOR SHALL BE RESPONSIBLE FOR REPAIRING ANY PAVEMENT DAMAGED AS A RESULT OF THE CONTRACTOR'S ACTIVITIES, WITH NO EXCEPTIONS.

#### WATER FOR CONSTRUCTION:

WATER USED FOR FILLING, FLUSHING, AND TESTING WILL BE COORDINATED WITH AND SUPPLIED BY THE OWNER. IF THE CONTRACTOR REQUESTS WATER FROM A HYDRANT, THE CONTRACTOR MUST COORDINATE THAT WITH THE OWNER AND PROVIDE THE REQUIRED BACKFLOW PREVENTION DEVICE. THE OWNER SHALL PROVIDE A QUANTITY OF WATER THAT IS DEEMED REASONABLE FOR COMPLETION OF THE WORK AND MAY ADJUST THE POINT WHERE WATER IS MADE AVAILABLE AT

#### SERVICE LINE INSTALLATION:

ALL NEW SERVICE LINES TO BE INSTALLED UNDER EXISTING PAVEMENT, CURBS AND SIDEWALK SHALL BE BORED. OPEN TRENCHING FOR SERVICE LINES IN UNPAVED AREAS IS ACCEPTABLE.

#### WATERLINE TESTING:

THE CONTRACTOR SHALL THOROUGHLY CLEAN, FLUSH, AND TEST THE WATER MAINS IN ACCORDANCE WITH THE PROJECT SPECIFICATIONS PRIOR TO ACCEPTANCE AND PLACEMENT INTO SERVICE. ALL COSTS ASSOCIATED WITH THE PRESSURE AND DISINFECTION TESTING SHALL BE BORNE BY THE CONTRACTOR. TESTING LAB MUST BE ON OHIO EPA APPROVED LIST.

THE CONTRACTOR SHALL SUPPLY ALL EQUIPMENT, MATERIALS, TAPS, AND LABOR NECESSARY FOR CONDUCTING TESTING.

PRESSURE TESTING SHALL BE IN ACCORDANCE WITH A.W.W.A. C-600 AND AWWA C-605 FOR DUCTILE IRON AND PVC MAINS RESPECTIVELY.

DISINFECTION SHALL BE IN ACCORDANCE WITH A.W.W.A. C-651.

#### **FINAL GRADING AND RESTORATION:**

ALL AREAS DISTURBED DURING CONSTRUCTION SHALL BE RESTORED TO THEIR ORIGINAL CONDITION AND ELEVATION. ALL UNPAVED AREAS SHALL BE SEEDED AND MULCHED.

ALL SIGNS, MAILBOXES, FENCES, GUARDRAILS, ROADSIDE DITCHES, OR OTHER PHYSICAL FEATURES DISTURBED OR DAMAGED DURING WORK UNDER THIS CONTRACT SHALL BE RESTORED TO THEIR ORIGINAL CONDITION BY THE CONTRACTOR. THE COST OF ALL SUCH WORK SHALL BE INCLUDED IN BID FOR VARIOUS ITEMS.

TREES, SHRUBS AND THE OTHER PLANTINGS DISTURBED OR DESTROYED IN EASEMENT AREAS OR WORK AREAS WHICH ARE OUTSIDE ROAD RIGHT-OF-WAY SHALL BE REPLACED AS NECESSARY IN LIKE KIND. THE OWNER SHALL BE GIVEN NOTICE OF INTENT TO REMOVE TREES IN THE RIGHT-OF-WAY A MINIMUM OF 48 HOURS BEFORE REMOVAL. NO TREES SHALL BE REMOVED OR DISTURBED WITHOUT PRIOR CONSENT OF THE ENGINEER AND OWNER,

ALL DISTURBED AREAS NOT SUBJECT TO TRAFFIC SHALL BE ROUGH GRADED WITHIN SEVEN DAYS OF PIPE INSTALLATION AND FINISH GRADED, SEEDED AND MULCHED WITHIN ONE MONTH OF PIPE INSTALLATION. TRENCH IN THESE AREAS MAY BE MOUNDED TO 12" HIGH OVER EXCAVATED AREAS AFTER ROUGH GRADING TO ACCOUNT FOR SETTLEMENT, FINISH GRADING SHALL BE BROUGHT TO ORIGINAL GRADE.

#### **EXISTING SERVICE LINES**

EXISTING WATER SERVICES MAY NOT BE SHOWN. CONTRACTOR SHALL COORDINATE EXCAVATION PROCEDURES TO IDENTIFY LOCATION OF THESE FACILITIES AND TO LIMIT DAMAGE. REPAIR OF DAMAGED FACILITIES SHALL BE THE RESPONSIBILITY OF THE CONTRACTOR.

UNLESS OTHERWISE DESIGNATED WATER SERVICES SHALL INCORPORATE 3/4" SERVICE LINE.

#### EXPOSURE OF UTILITY CROSSINGS

CONTRACTOR SHALL CAREFULLY REVIEW DRAWINGS FOR LOCATIONS WHERE THE PROPOSED WATERLINE CROSSES EXISTING UNDERGROUND FACILITIES. CROSSING LOCATIONS SHALL BE EXPOSED BY CONTRACTOR IN ADVANCE OF PIPE INSTALLATION ACTIVITIES TO AVOID GRADE CONFLICT AND POTENTIAL DELAY.

#### FEDERAL ENVIRONMENTAL REQUIREMENTS:

WHEN CONSTRUCTING A PROJECT INVOLVING TRENCHING AND/OR OTHER RELATED EARTH EXCAVATIONS, CONTRACTOR SHALL COMPLY WITH THE FOLLOWING ENVIRONMENTAL CONSTRAINTS:

WETLANDS - WHEN DISPOSING OF EXCESS, SPOIL, OR OTHER CONSTRUCTION MATERIALS ON PUBLIC OR PRIVATE PROPERTY. CONTRACTOR SHALL NOT FILL IN OR OTHERWISE CONVERT

FLOODPLAINS - WHEN DISPOSING OF EXCESS, SPOIL, OR OTHER CONSTRUCTION MATERIALS ON

PUBLIC OR PRIVATE PROPERTY, CONTRACTOR SHALL NOT FILL IN OR OTHERWISE CONVERT 100

YEAR FLOODPLAIN AREAS DELINEATED ON THE LATEST FEDERAL EMERGENCY MANAGEMENT AGENCY FLOODPLAIN MAPS, OR OTHER APPROPRIATE MAPS, I.E., ALLUVIAL SOILS ON NRCS SOIL SURVEY MAPS. HISTORIC PRESERVATION - ANY EXCAVATION BY CONTRACTOR THAT UNCOVERS AN HISTORICAL

OR ARCHAEOLOGICAL ARTIFACT SHALL BE IMMEDIATELY REPORTED TO OWNER AND A REPRESENTATIVE OF AGENCY. CONSTRUCTION SHALL BE TEMPORARILY HALTED PENDING THE NOTIFICATION PROCESS AND FURTHER DIRECTIONS ISSUED BY AGENCY AFTER CONSULTATION WITH THE STATE HISTORIC PRESERVATION OFFICER (SHPO).

ENDANGERED SPECIES - CONTRACTOR SHALL COMPLY WITH THE ENDANGERED SPECIES ACT, WHICH PROVIDES FOR THE PROTECTION OF ENDANGERED AND/OR THREATENED SPECIES AND CRITICAL HABITAT. SHOULD ANY EVIDENCE OF THE PRESENCE OF ENDANGERED AND/OR THREATENED SPECIES OR THEIR CRITICAL HABITAT BE BROUGHT TO THE ATTENTION OF CONTRACTOR, CONTRACTOR WILL IMMEDIATELY REPORT THIS EVIDENCE TO OWNER AND A REPRESENTATIVE OF AGENCY. CONSTRUCTION SHALL BE TEMPORARILY HALTED PENDING THE NOTIFICATION PROCESS AND FURTHER DIRECTIONS ISSUED BY AGENCY AFTER CONSULTATION WITH THE U.S. FISH AND WILDLIFE SERVICE.

MITIGATION MEASURES - IF THE PROJECT HAD AN ENVIRONMENTAL REPORT, ENVIRONMENTAL ASSESSMENT, OR ENVIRONMENTAL IMPACT STATEMENT TO MEET THE REQUIREMENTS OF THE NATIONAL ENVIRONMENTAL POLICY ACT, COMPLIANCE WITH THE MITIGATION MEASURES, IF ANY, IN THAT DOCUMENT ARE HEREBY INCLUDED AS A CONDITION OF THIS CONTRACT. THESE MITIGATION MEASURES INCLUDE BUT MAY NOT BE LIMITED TO, THE FOLLOWING:

CONSTRUCTION - CONSTRUCTION SPECIFICATIONS AND OTHER CONTRACT PROVISIONS WILL REQUIRE: (1) LIMITING NORMAL CONSTRUCTION TO DAYLIGHT HOURS TO MINIMIZE DISTURBANCE FROM NOISE AND LIGHTS, (2) CONTROL OF UNNECESSARY NOISE, (3) DUST CONTROL, (4) TEMPORARY SILTATION CONTROL, INCLUDING MINIMIZING DISTURBED AREAS AND USING PROMPT TEMPORARY SEEDING WHEN NEEDED AND THE USE OF SILT FENCES, (5) RESTORATION OF DISTURBED PIPELINE AREAS TO PRE-CONSTRUCTION CONDITIONS, (6) ROAD SURFACES WILL BE RESTORED TO PRE-CONSTRUCTION CONDITIONS, AND (7) LINES CROSSING UNDER COUNTY HIGHWAYS WILL BE BORED.

FLOODPLAIN - CONSTRUCTION WITHIN FLOODPLAIN AREAS WILL HAVE TO BE APPROVED BY THE LOCAL FLOODPLAIN MANAGEMENT COORDINATOR AND COMPLY WITH ALL LOCAL FLOODPLAIN MANAGEMENT REGULATIONS.

CULTURAL RESOURCES/VISUAL AESTHETICS - CONTRACTOR SHALL AVOID DISRUPTION TO ANY EXISTING CEMETERIES ADJACENT TO THE PROJECT CORRIDOR.

TAKEN DOWN BETWEEN APRIL 1ST AND SEPTEMBER 30TH.

BIOLOGICAL RESOURCES - NO TREES THAT ARE SUITABLE HABITAT FOR THE INDIANA BAT CAN BE

WATER QUALITY - IMPACTS TO WATER QUALITY DUE TO RUNOFF AND EROSION WILL BE MITIGATED THROUGH COMPLIANCE WITH THE OHIO DEPARTMENT OF NATURAL RESOURCE'S MANUAL OF RAINWATER AND LAND DEVELOPMENT.

INDIANA BAT HABITAT - IF SUITABLE INDIANA BAT HABITAT OCCURS WITHIN THE PROJECT AREA, THESE TREES MUST BE CONSERVED. IF SUITABLE HABITAT OCCURS ON THE PROJECT AREA AND TREES MUST BE CUT, CUTTING MUST OCCUR BETWEEN OCTOBER 1 AND MARCH 31. IF SUITABLE HABITAT MUST BE CUT DURING THE SUMMER MONTHS, A NET SURVEY MUST BE CONDUCTED BETWEEN JUNE 15 AND JULY 31, PRIOR TO CUTTING. NET SURVEYS SHALL INCORPORATE EITHER TWO NET SITES PER SQUARE KILOMETER OF PROJECT AREA WITH EACH NET SITE CONTAINING A MINIMUM OF TWO NETS USED FOR TWO CONSECUTIVE NIGHTS, OR ONE NET SITE PER KILOMETER OF STREAM WITHIN THE PROJECT LIMITS WITH EACH NET SITE CONTAINING A MINIMUM OF TWO NETS USED FOR TWO CONSECUTIVE NIGHTS.

#### UNDERGROUND UTILITIES:

THE INFORMATION SHOWN CONCERNING EXISTING UTILITIES IS NOT REPRESENTED, WARRANTED OR GUARANTEED TO BE COMPLETE OR ACCURATE. IT SHALL BE THE CONTRACTOR'S RESPONSIBILITY TO PHYSICALLY LOCATE AND VERIFY, IN THE FIELD, ALL UTILITY LOCATIONS AND ELEVATIONS, PRIOR TO THE BEGINNING OF HIS CONSTRUCTION OPERATIONS. THE CONTRACTOR SHALL SUPPORT, PROTECT, AND RESTORE ALL EXISTING UTILITIES AND THEIR ASSOCIATED ITEMS.

THE IDENTITY AND LOCATION OF THE EXISTING UNDERGROUND UTILITY FACILITIES KNOWN TO BE LOCATED IN THE CONSTRUCTION AREA HAVE BEEN SHOWN ON THE DRAWINGS AS ACCURATELY AS PROVIDED BY THE OWNER OF THE UTILITY. THE OWNER AND/OR ENGINEER ASSUME NO RESPONSIBILITY AS TO THE ACCURACY OR THE DEPTHS OF THE UNDERGROUND FACILITIES SHOWN ON THESE DRAWINGS.

THE CONTRACTOR SHALL NOTIFY ALL UTILITY OWNERS, IN ACCORDANCE WITH SECTION 153.64, OHIO REVISED CODE, AT LEAST FORTY-EIGHT (48) HOURS PRIOR TO THE BEGINNING OF ANY WORK, COORDINATE HIS WORK WITH THEM, AND KEEP THE UTILITY OWNERS APPRAISED OF HIS SCHEDULE AND REQUIREMENTS UNTIL ALL WORK IS COMPLETED. THE CONTRACTOR SHALL PROVIDE THE OWNER WITH EVIDENCE OF HAVING NOTIFIED THE UTILITIES AND PROVIDING THEM WITH HIS WORK SCHEDULE PRIOR TO BEGINNING ANY WORK. NOTICE SHALL BE GIVEN TO THE OHIO UTILITIES PROTECTION SERVICE AND TO THE OIL AND GAS PRODUCERS UNDERGROUND PROTECTION

THE FOLLOWING IS A PARTIAL LIST OF UTILITY REGISTRATION SERVICES AND UTILITY OWNERS WHO MUST BE NOTIFIED. THE CONTRACTOR SHALL COMPLY WITH THE REGULATIONS SET FORTH BY THE RESPECTIVE PUBLIC SERVICE CORPORATIONS AS LISTED:

PIKE WATER INC.

ATTN: FARON YOUNG

PIKETON, OH 45661

(740) 947-2524

2277 BOSWELL RUN RD

OHIO UTILITIES PROTECTION SERVICE FRONTIER COMMUNICATIONS 4740 BELMONT AVE 1315 ALBERT ST. YOUNGSTOWN, OH 44505 PORTSMOUTH, OH 45662 (800) 362-2764 (740) 204-2259

OHIO OIL AND GAS PRODUCERS UNDERGROUND PROTECTION SERVICE PO BOX 535 GRANVILLE OH, 43023 (800) 925-0988

AMERICAN ELECTRIC POWER COLUMBIA GAS OHIO 3225 SCIOTO TRAIL 2315 17TH ST. PORTSMOUTH, OH 45662 PORTSMOUTH, OH 45662 (800) 672-2231 (740) 354-4761

#### INTERFACE WITH EXISTING UTILITIES:

THE CONTRACTOR SHALL MAINTAIN AND PROTECT ALL PUBLIC OR PRIVATE UTILITY FACILITIES DURING CONSTRUCTION. SHOULD IT BECOME NECESSARY TO MOVE, ADJUST, OR TEMPORARILY RELOCATE ANY SUCH FACILITY, THE WORK SHALL BE DONE BY THE OWNER OF THE UTILITY FACILITY. ANY DAMAGE TO UTILITY FACILITIES BY THE CONTRACTOR OR HIS SUBCONTRACTORS WILL BE REPAIRED BY THE OWNER OF SAID UTILITY, AND THE COST OF SAID REPAIRS WILL BE PAID BY THE CONTRACTOR, THE CONTRACTOR SHALL SEND PROOF OF PAYMENT TO THE UTILITY FOR THE REPAIR TO THE OWNER, PRIOR TO FINAL PAYMENT.

IT IS UNDERSTOOD AND AGREED THAT THE CONTRACTOR HAS CONSIDERED IN HIS BID ALL OF THE PERMANENT AND TEMPORARY UTILITY APPURTENANCES IN THEIR PRESENT OR RELOCATED POSITIONS AND THAT NO ADDITIONAL COMPENSATION WILL BE ALLOWED FOR ANY DELAYS. INCONVENIENCE, OR DAMAGE SUSTAINED BY HIM DUE TO ANY INTERFERENCE FROM THE SAID UTILITY APPURTENANCES OR THE OPERATION OF MOVING THEM.

CONTRACTOR SHALL ENSURE ALL POWER POLES, ELECTRICAL SERVICES AND ANY OTHER UTILITIES ARE SUPPORTED AS NECESSARY WHILE CONSTRUCTION THE PROPOSED IMPROVEMENTS. COST FOR THIS WORK SHALL BE INCLUDED IN THE VARIOUS BID ITEMS FOR PAYMENT.



DATE	3/20/2025				
REVISION	REVISED FOR CONSTRUCTION				
ON	1				
BIDDING	2/6/2025	AS SHOWN	RAB	RAB	BRA
ISSUED FOR:	ISSUE DATE:	SCALE:	DESIGNED BY:	DRAWN BY:	CHECKED BY:


PROJECT NO. 220239 DISCIPLINE SHEET NAME


**GEN NOTE** 29




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		your trusted advisor	consultants	1	
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	ISSUE DATE: 2/6	2/6/2025	-	REVISED FOR CONSTRUCTION
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	DESIGNED BY:	RAB		
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	CHECKED BY:	BRA		



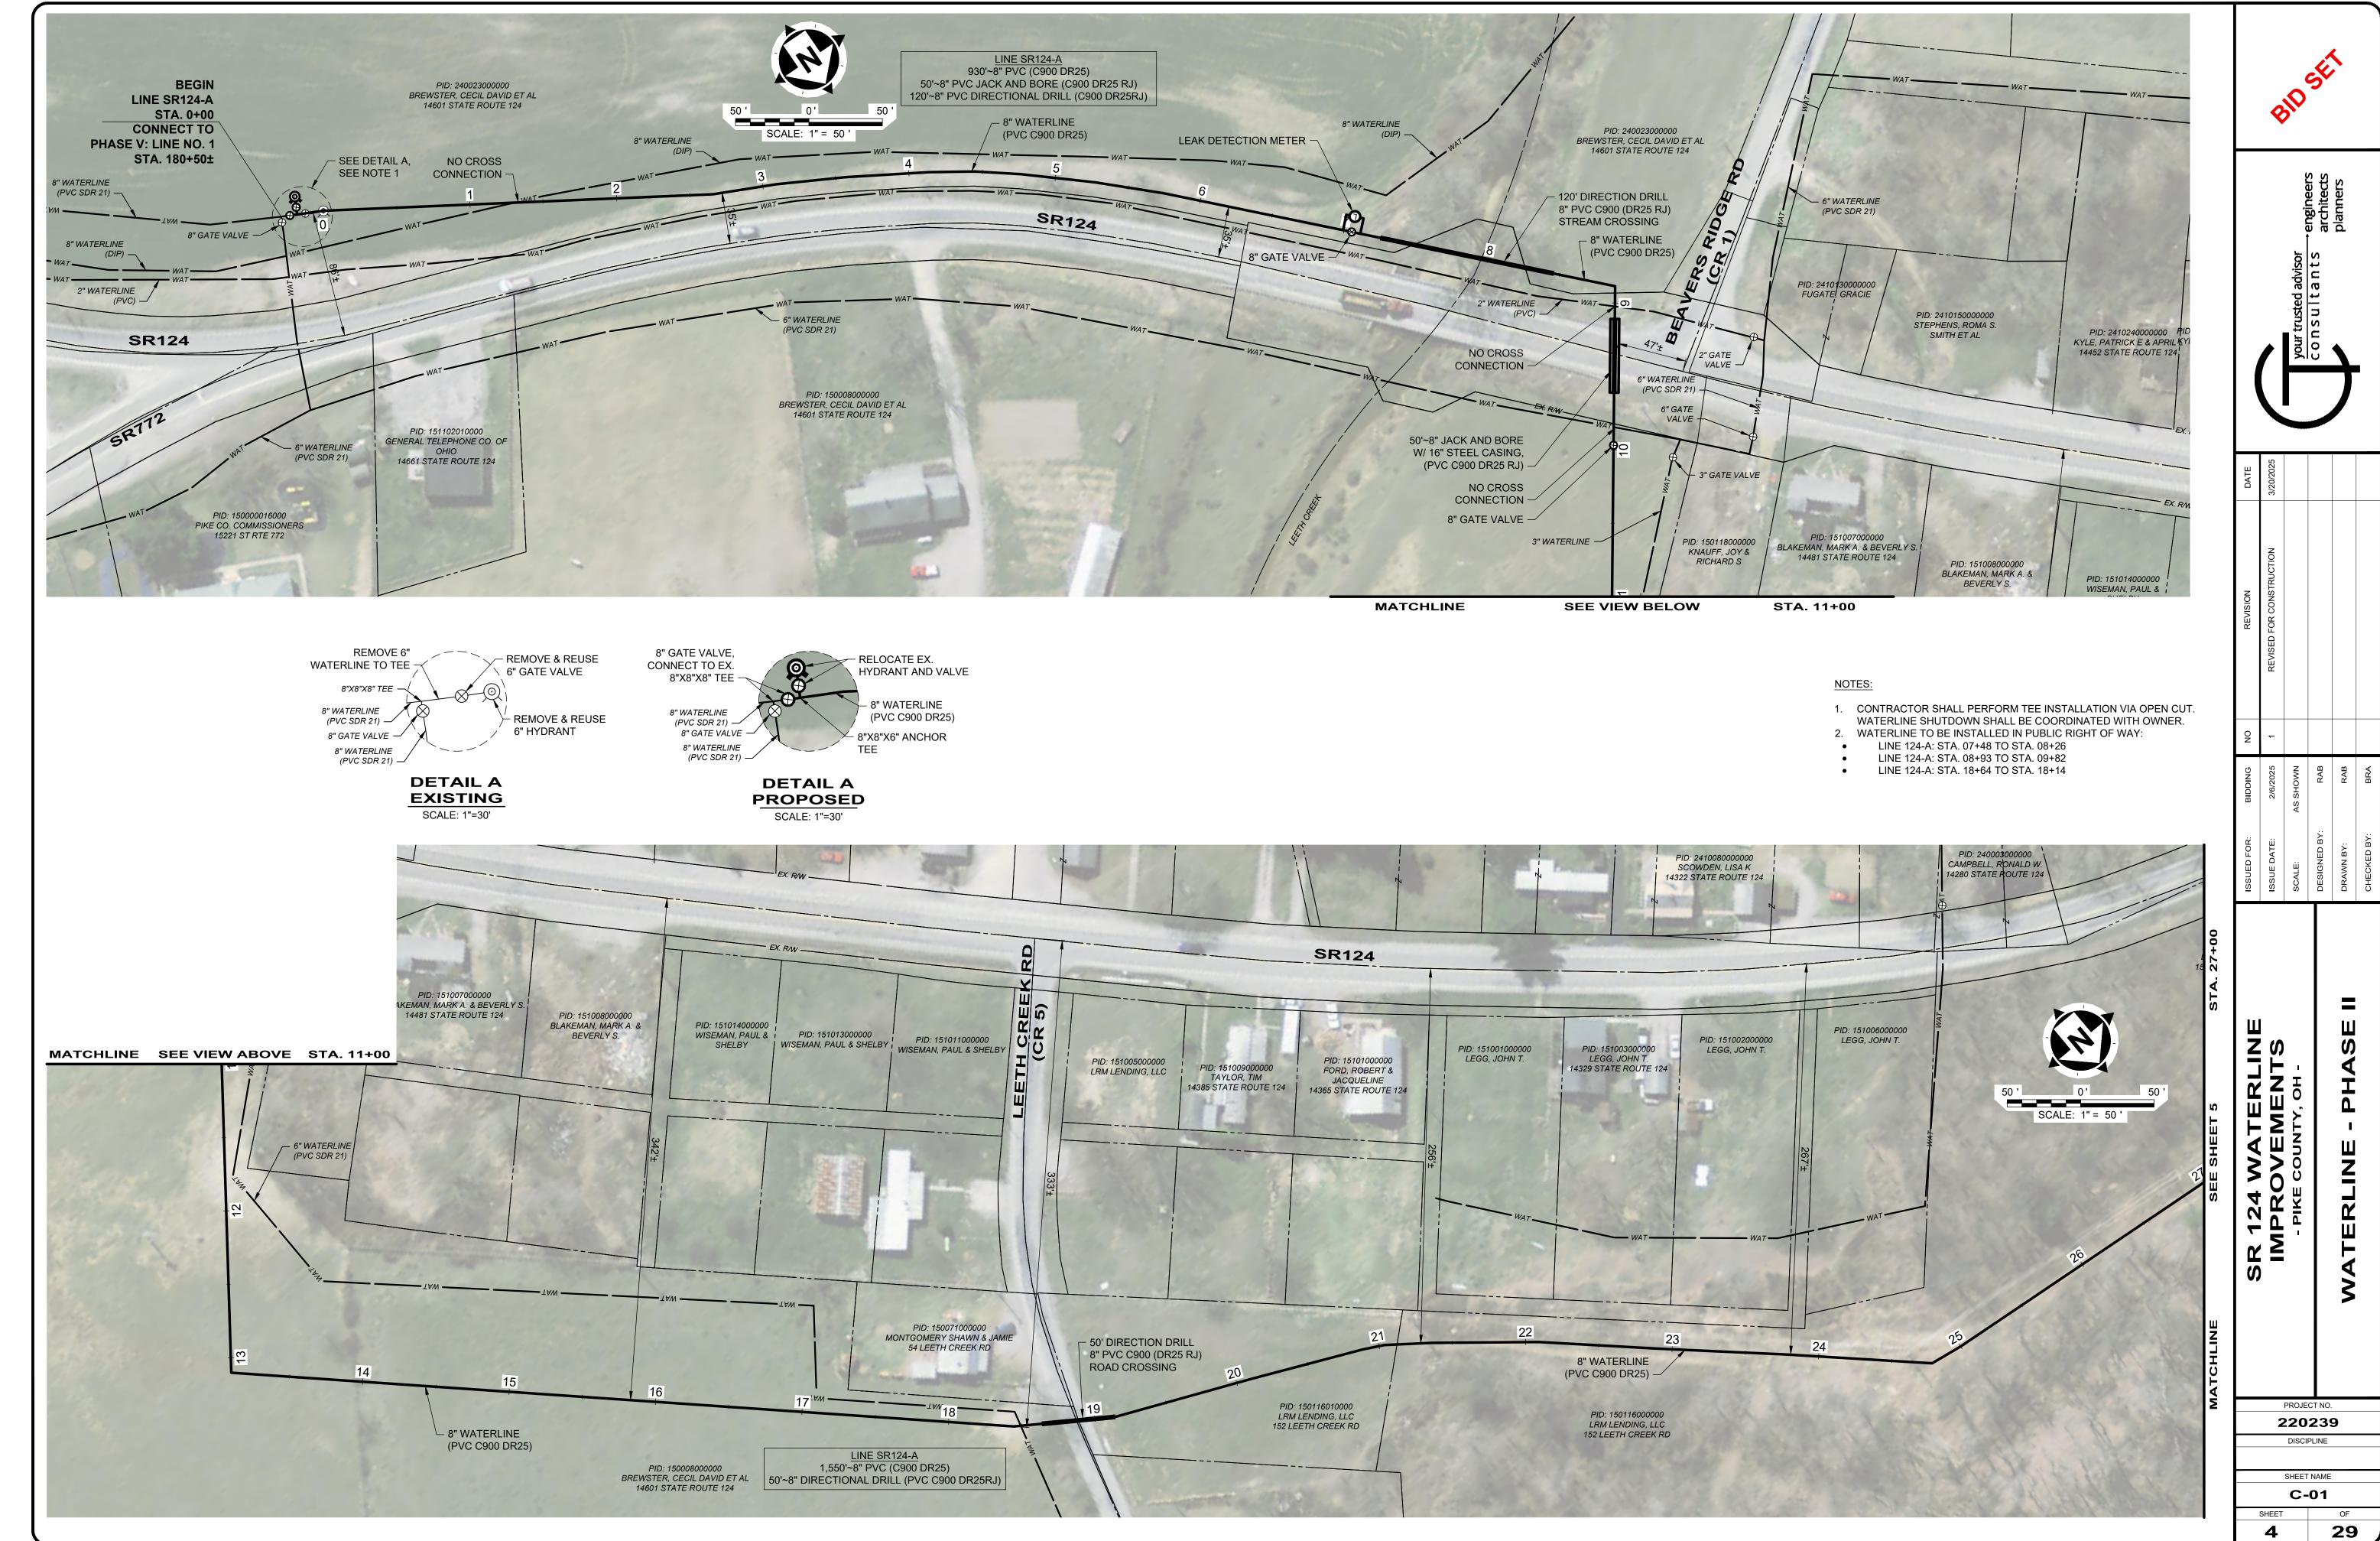

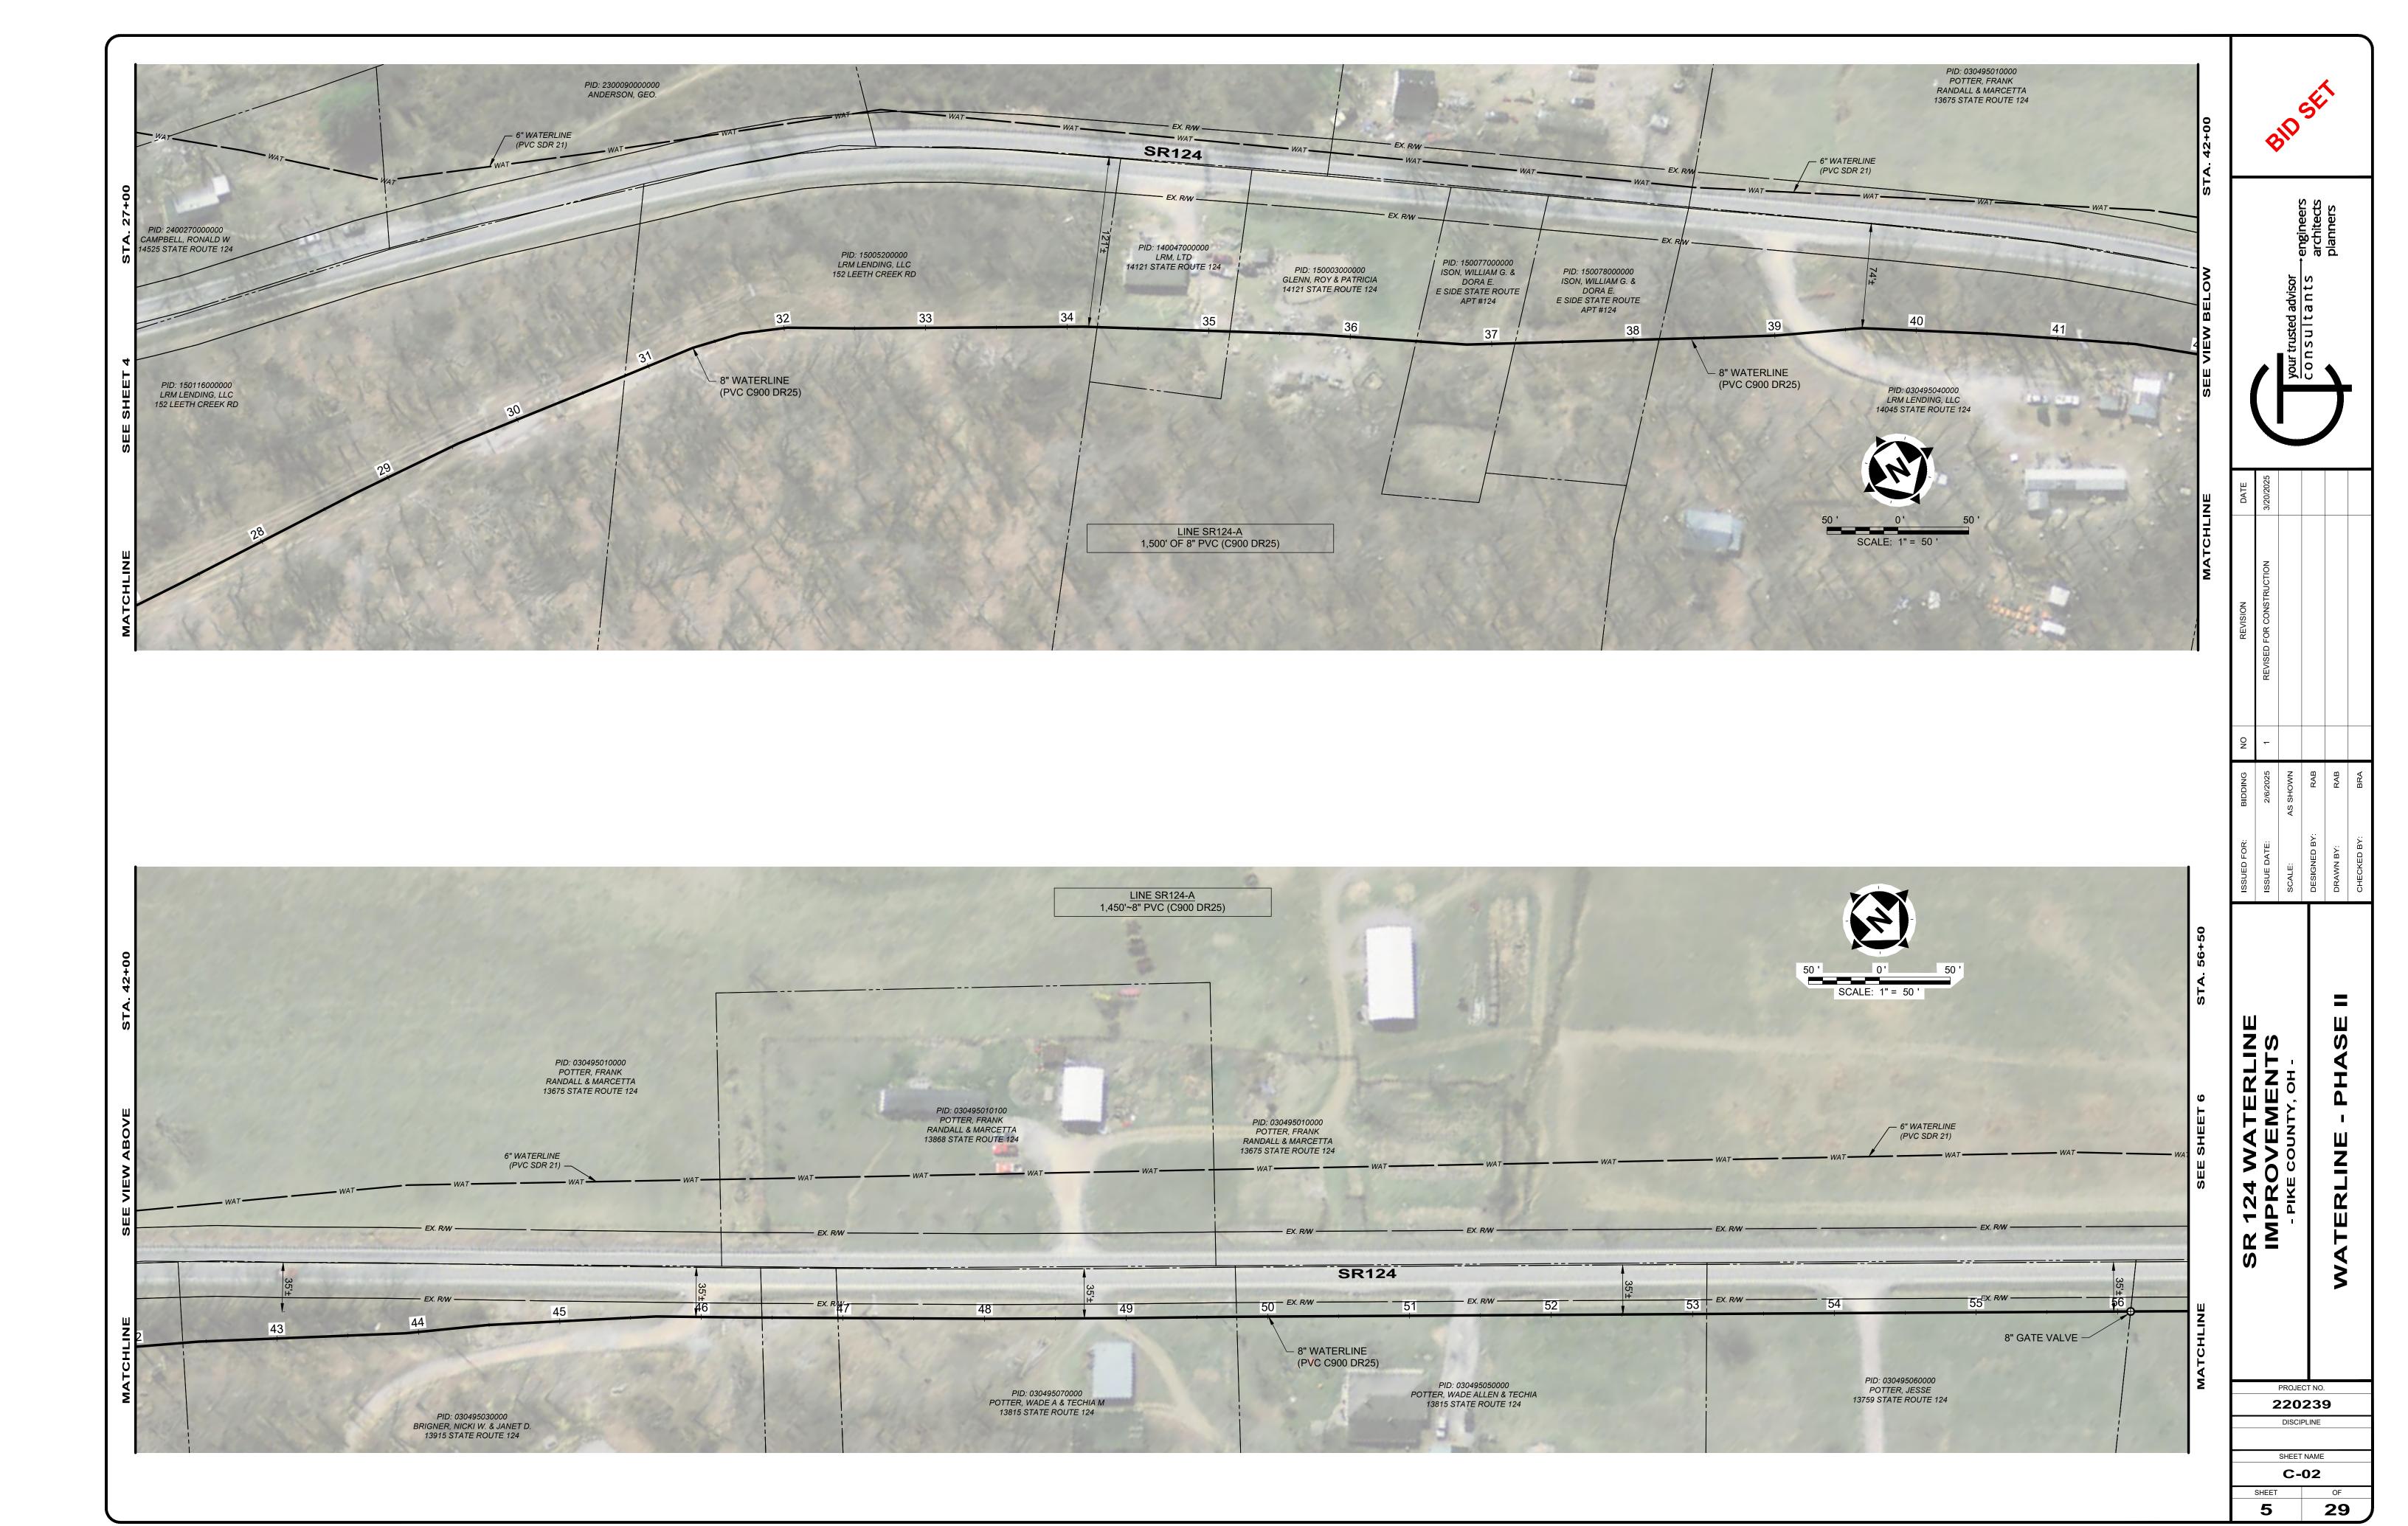
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1. WATERLINE TO BE INSTALLED IN PUBLIC RIGHT OF WAY:

• LINE 124-A: STA. 77+66 TO STA. 79+42

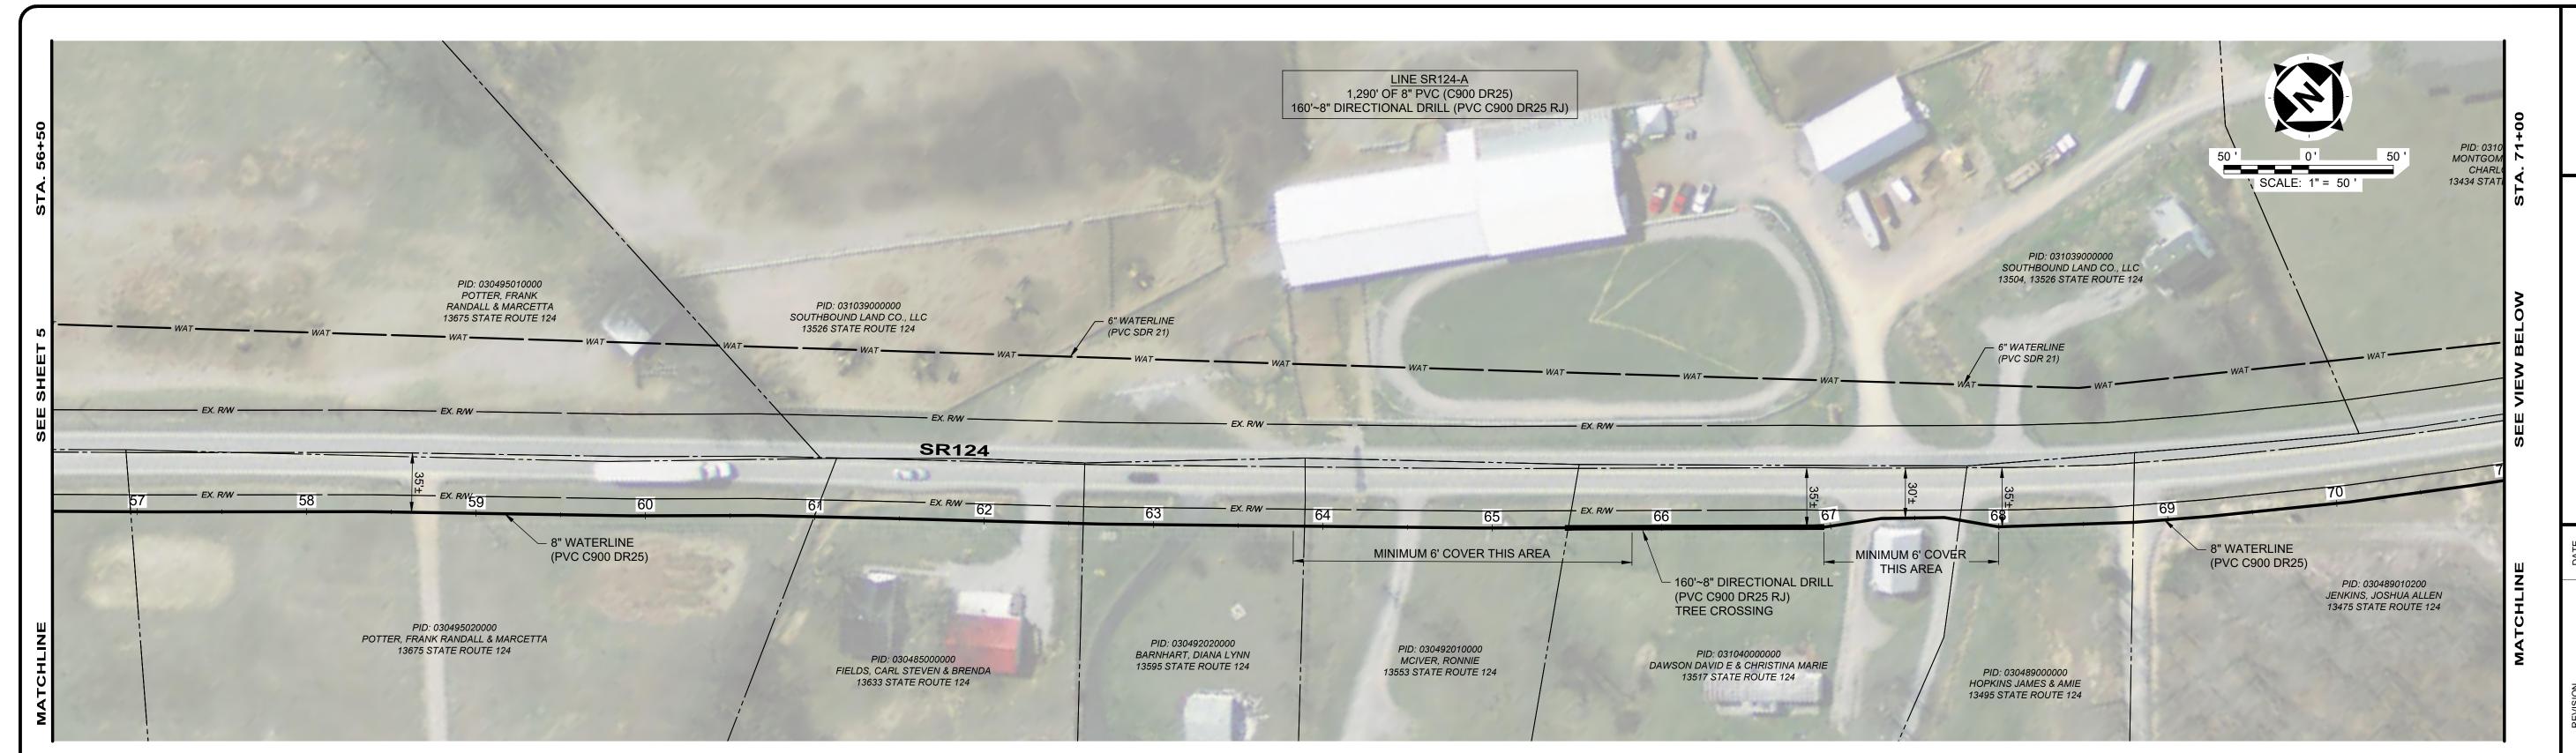



		SR 124 WATERLINE	ISSUED FOR:	BIDDING	ON	REVISION
	2	IMPROVEMENTS	ISSUE DATE:	2/6/2025	1	REVISED FOR CONSTR
SHEET	DISCI	- PIKE COUNTY, OH -	SCALE:	AS SHOWN		
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	9	WATERLINE - PHASE II	DRAWN BY:	RAB		
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SHEET

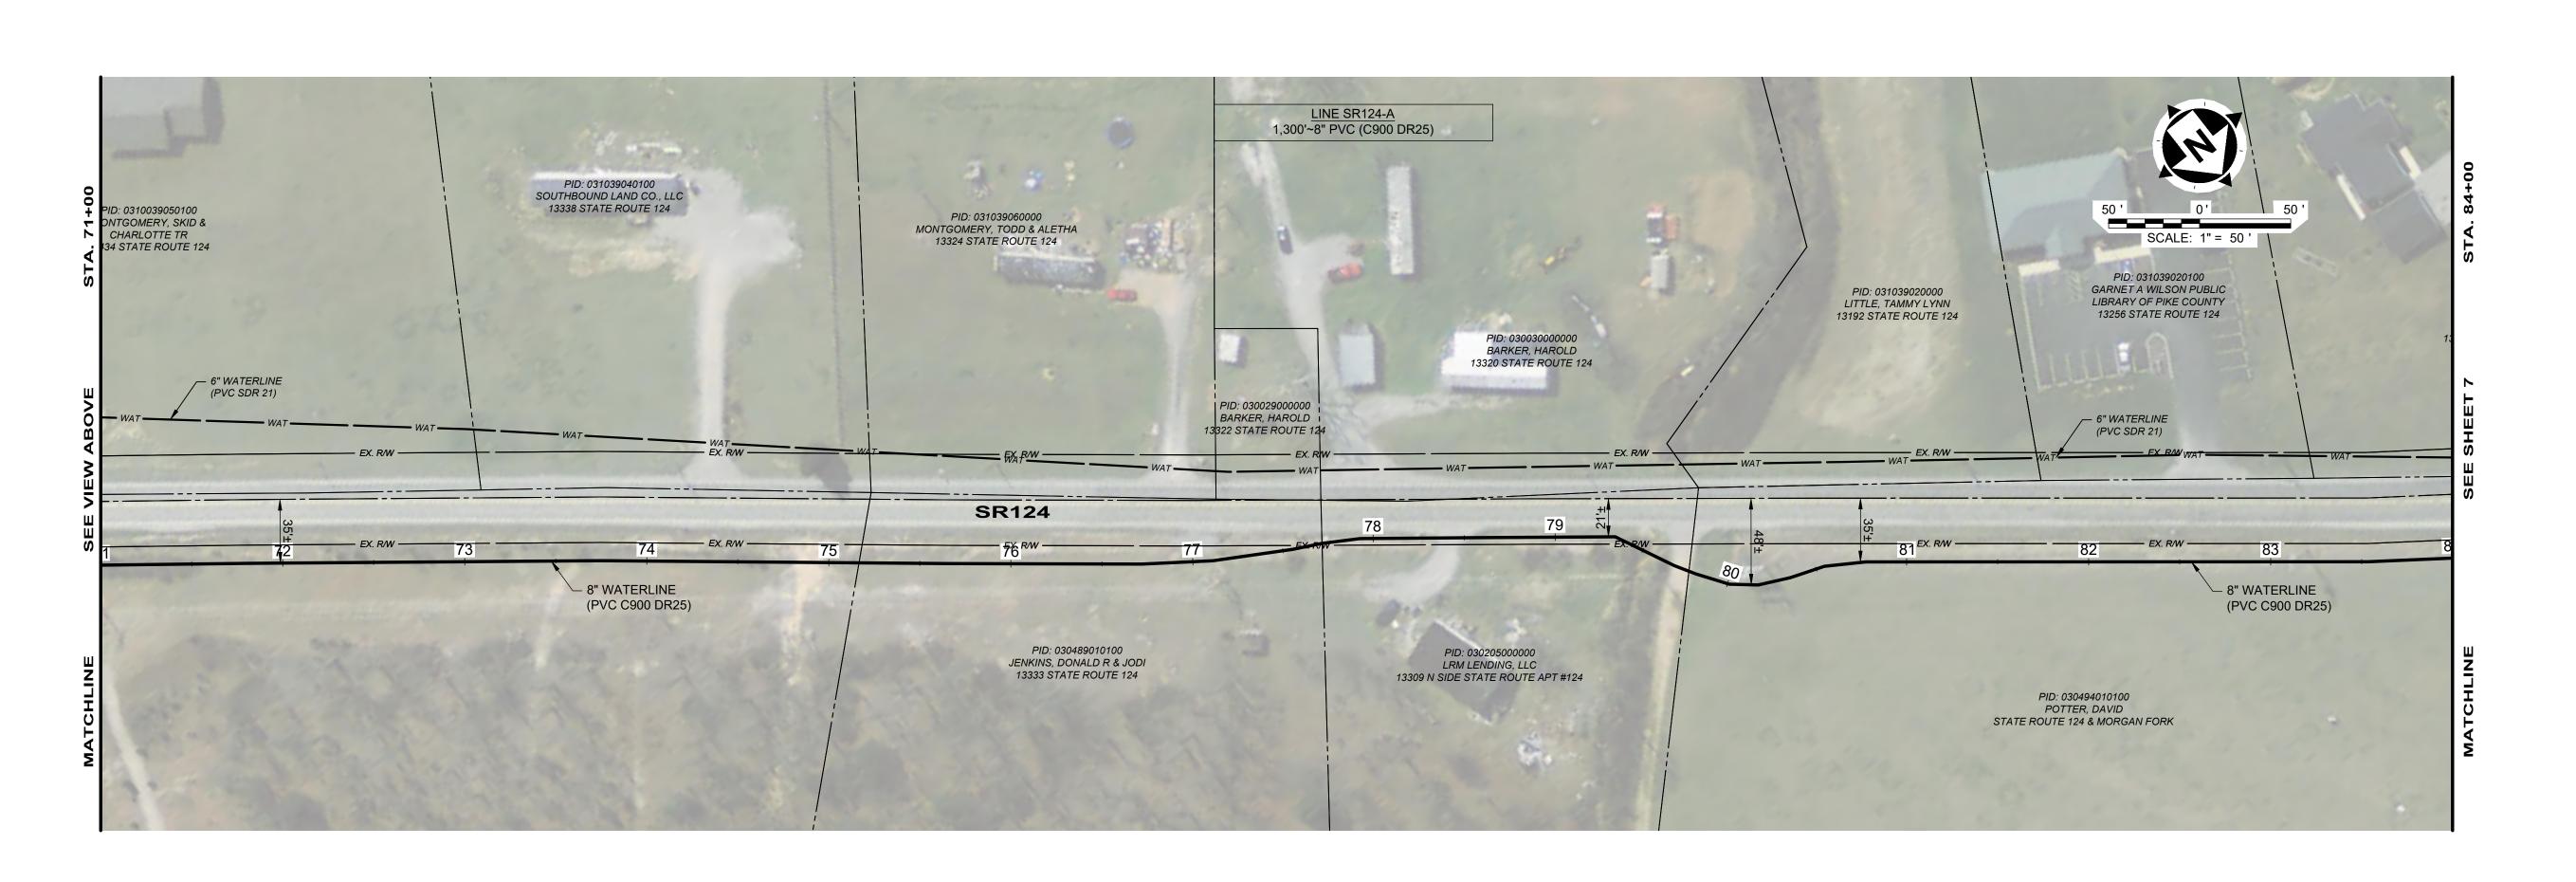



6" WATERLINE

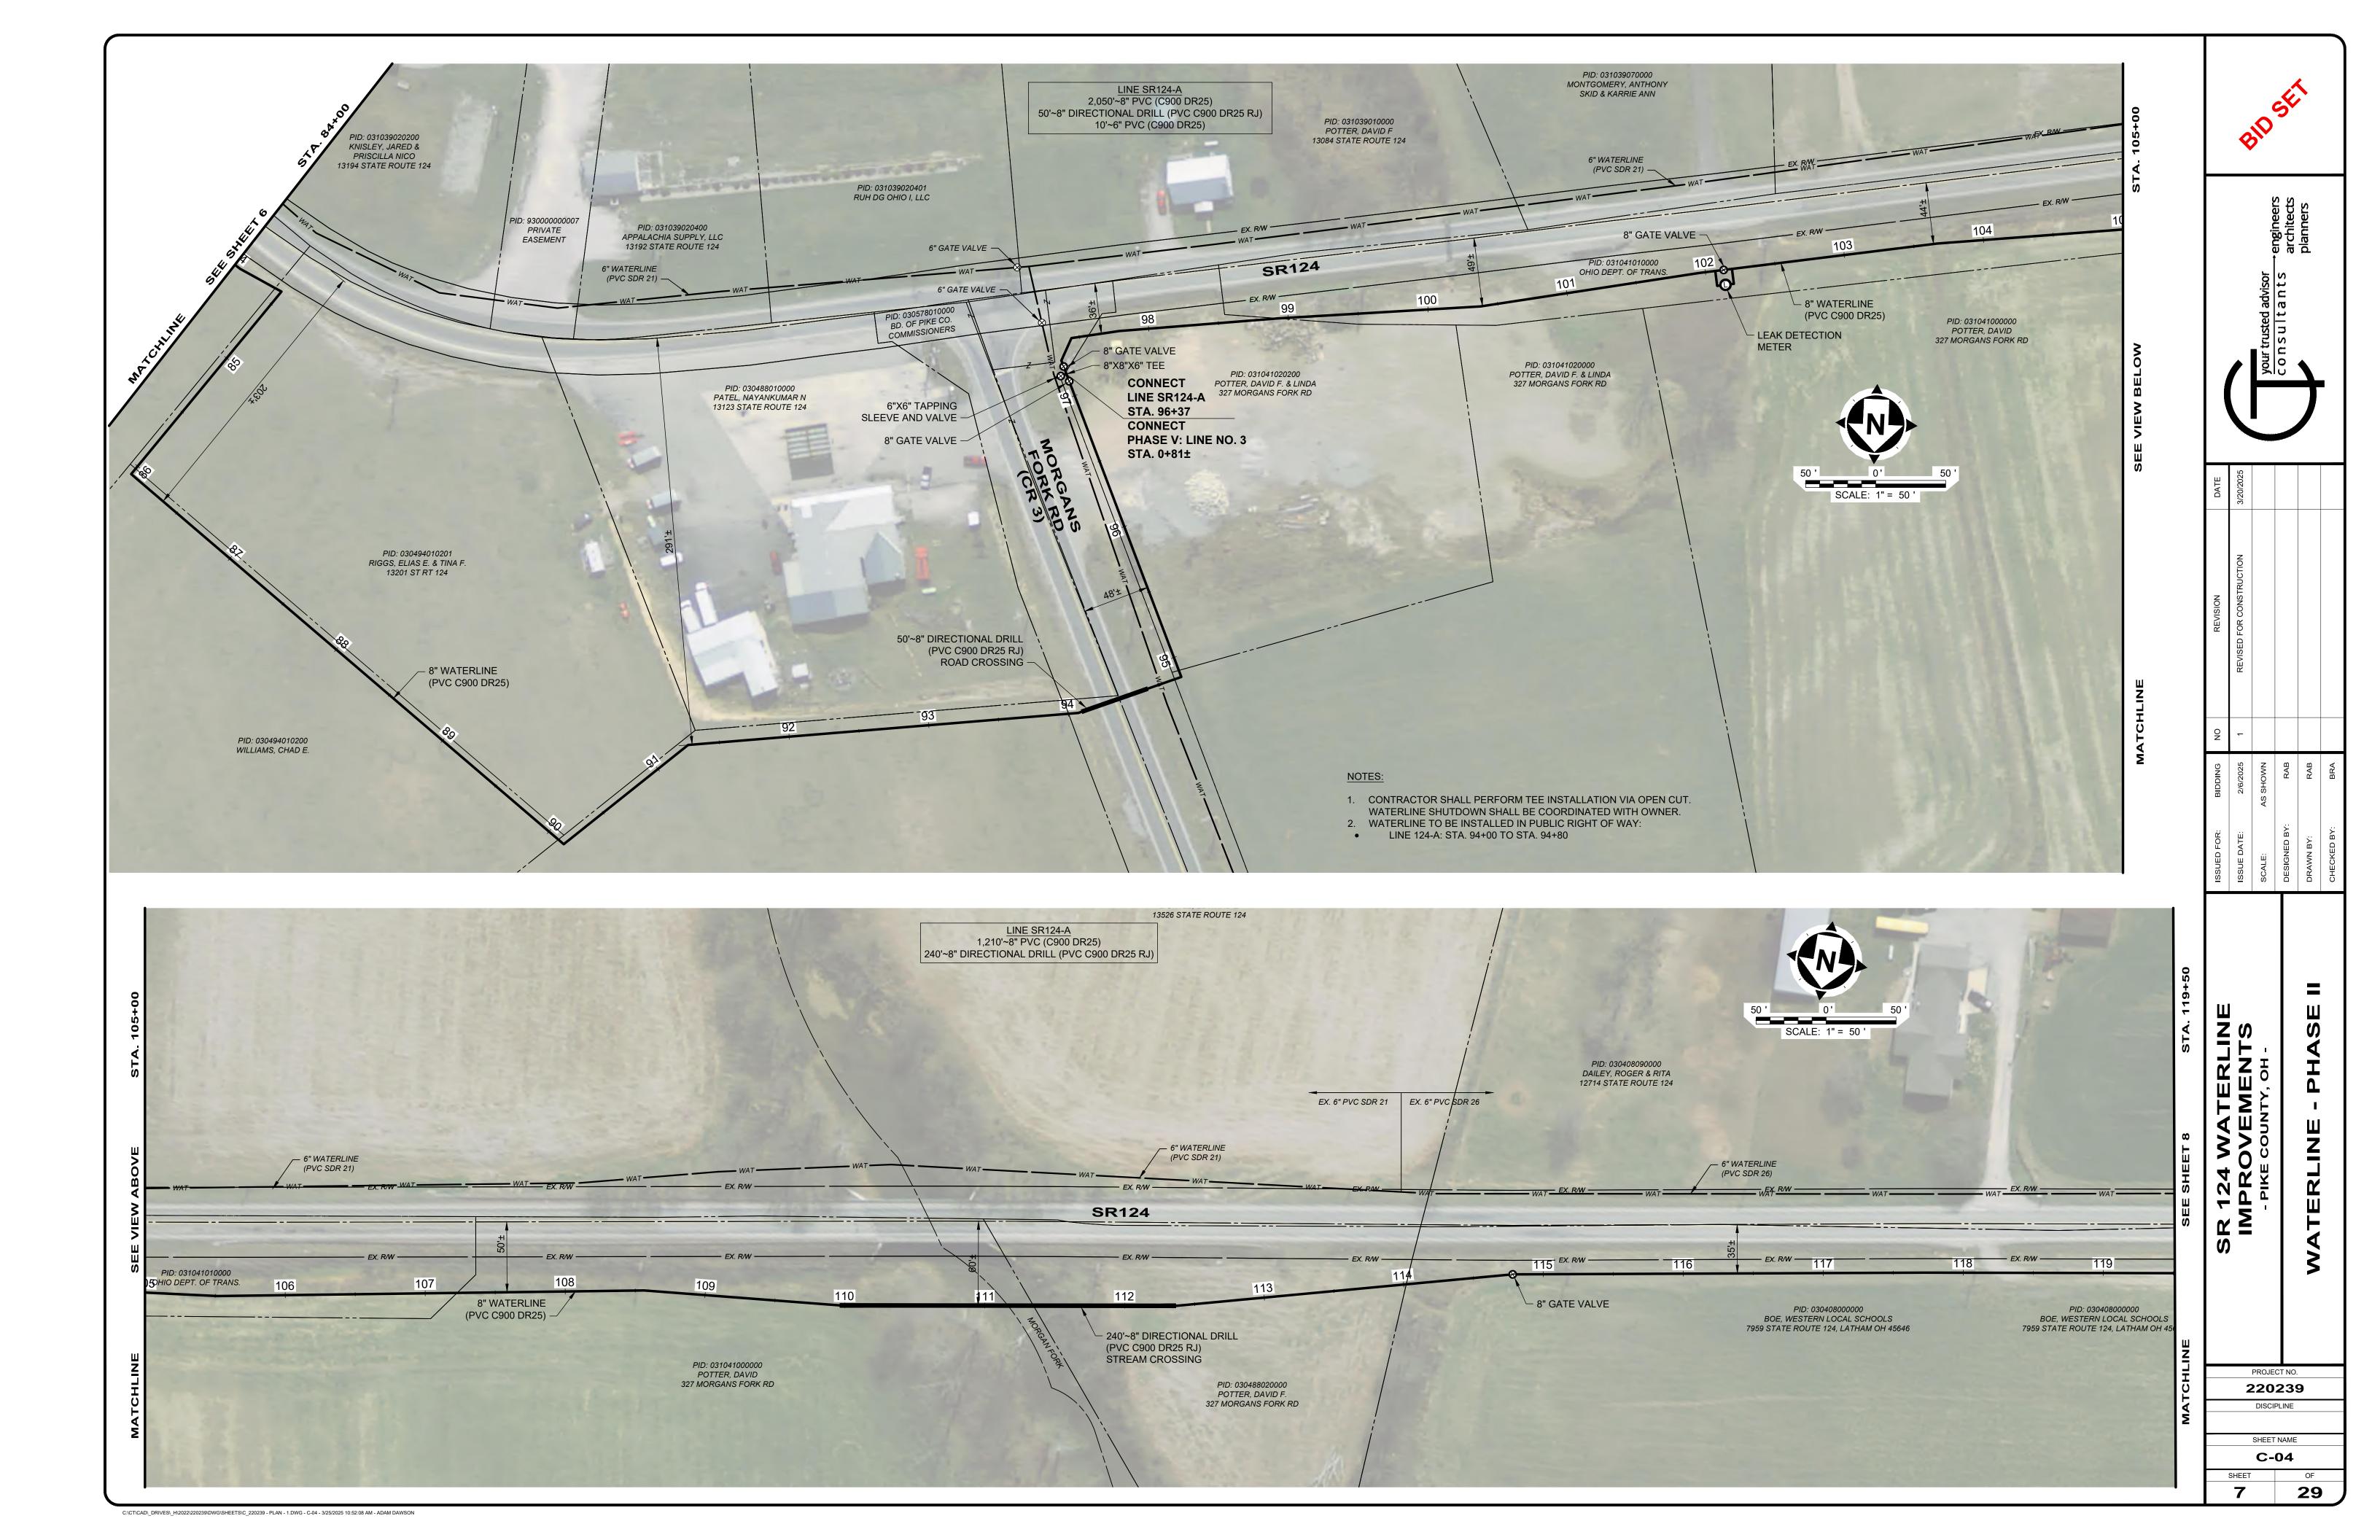(PVC SDR 26) —

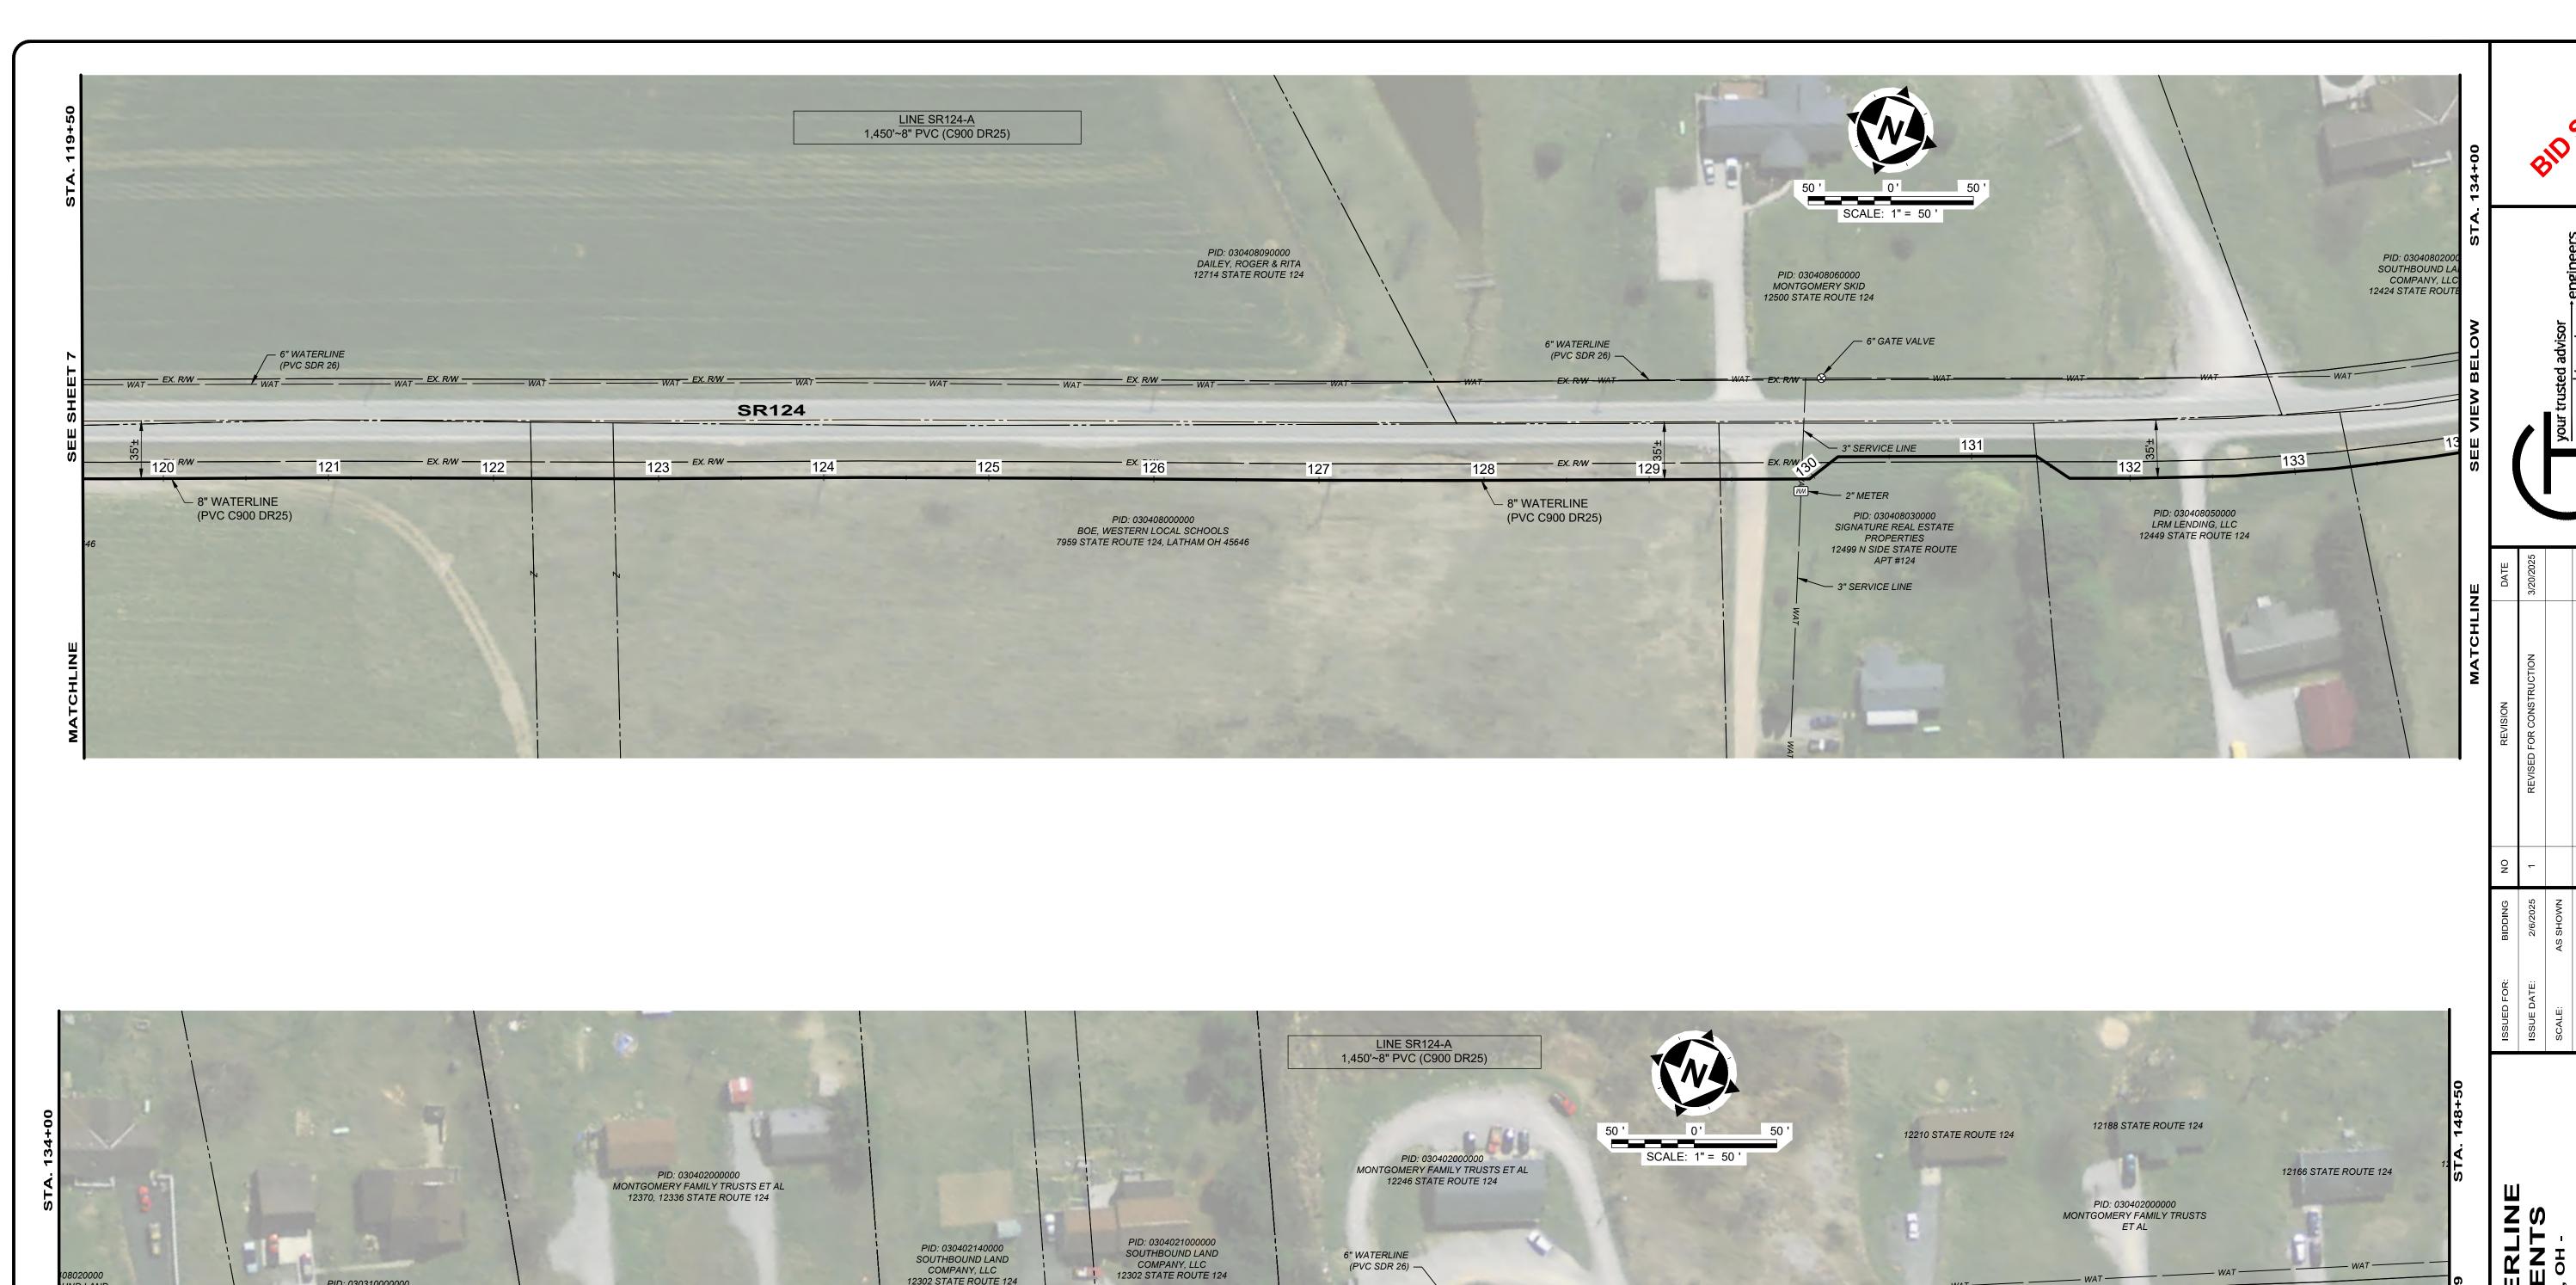PID: 030495030000 SOUTHBOUND LAND COMPANY LLC 12257 STATE ROUTE 124


PID: 030402140000

SOUTHBOUND LAND COMPANY, LLC

12302 STATE ROUTE 124

SR124

PID: 030402060000 SOUTHBOUND LAND CO LLC 12331 STATE ROUTE APT #124

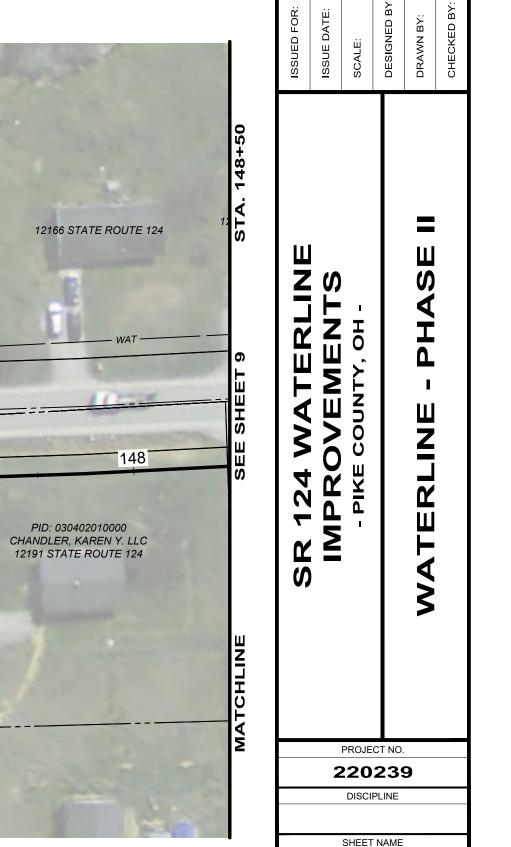

C-05

29

SHEET

PID: 030402040000 CHANDLER, K<mark>AREN Y. LLC</mark> 12175 STATE ROUTE 124

- 8" WATERLINE

PID: 030402000000 MONTGOMERY FAMILY TRUSTS

ET AL

12221 STATE ROUTE 124

(PVC C900 DR25)

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IND LAND NY, LLC > E ROUTE 124

> 6" WATERLINE (PVC SDR 26) —


PID: 030408040100 IRVIN, JOHNNIE L 2425 STATE ROUTE 124 PID: 030310000000 CAMPBELL, CHARLES L JR 12406 STATE ROUTE 124

PID: 030495030000


PINKERTON, TERESA A. & CHAD W.

N SIDE STATE ROUTE 124 - 8" WATERLINE

(PVC C900 DR25)

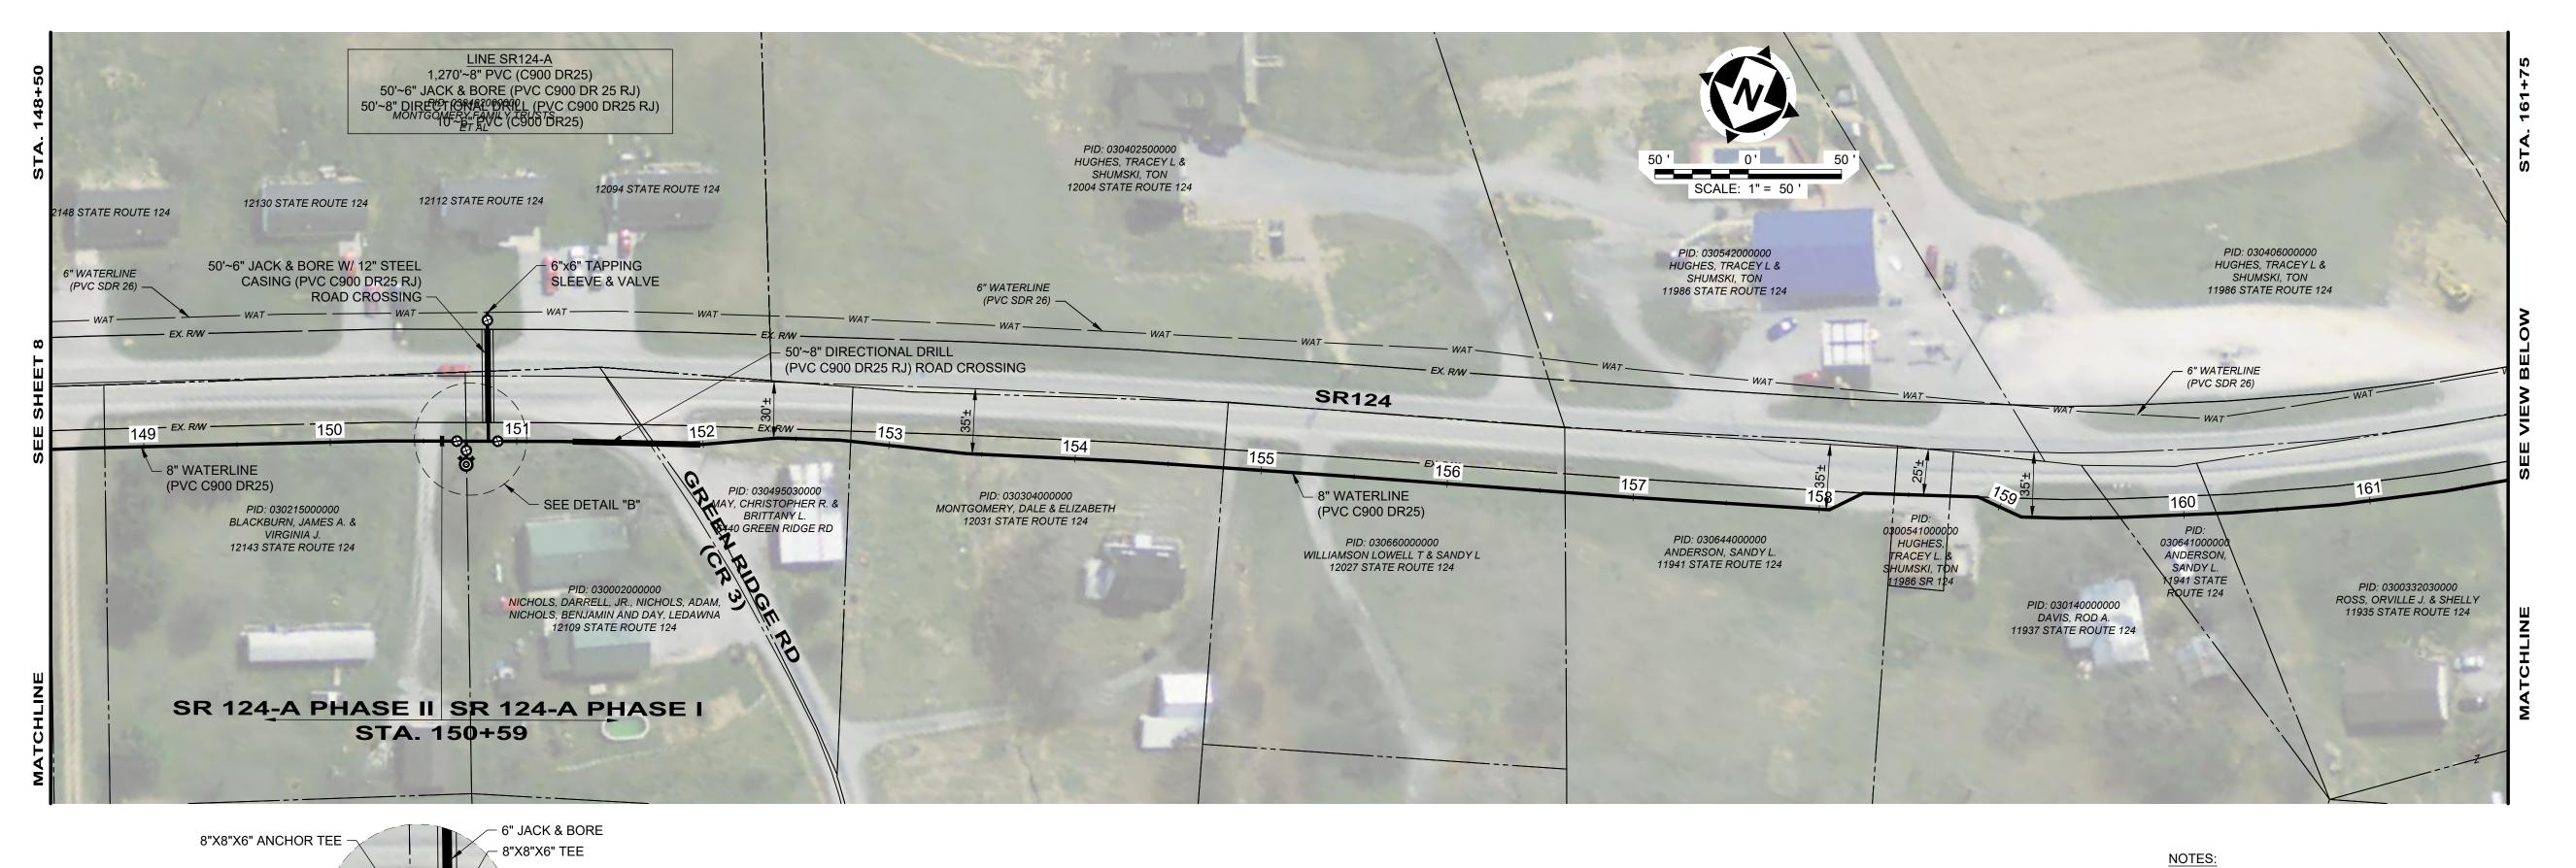

- 1. WATERLINE TO BE INSTALLED IN PUBLIC RIGHT OF WAY:
- LINE 124-A: STA. 158+26 TO STA. 158+87 LINE 124-A: STA. 169+46 TO STA. 176+07

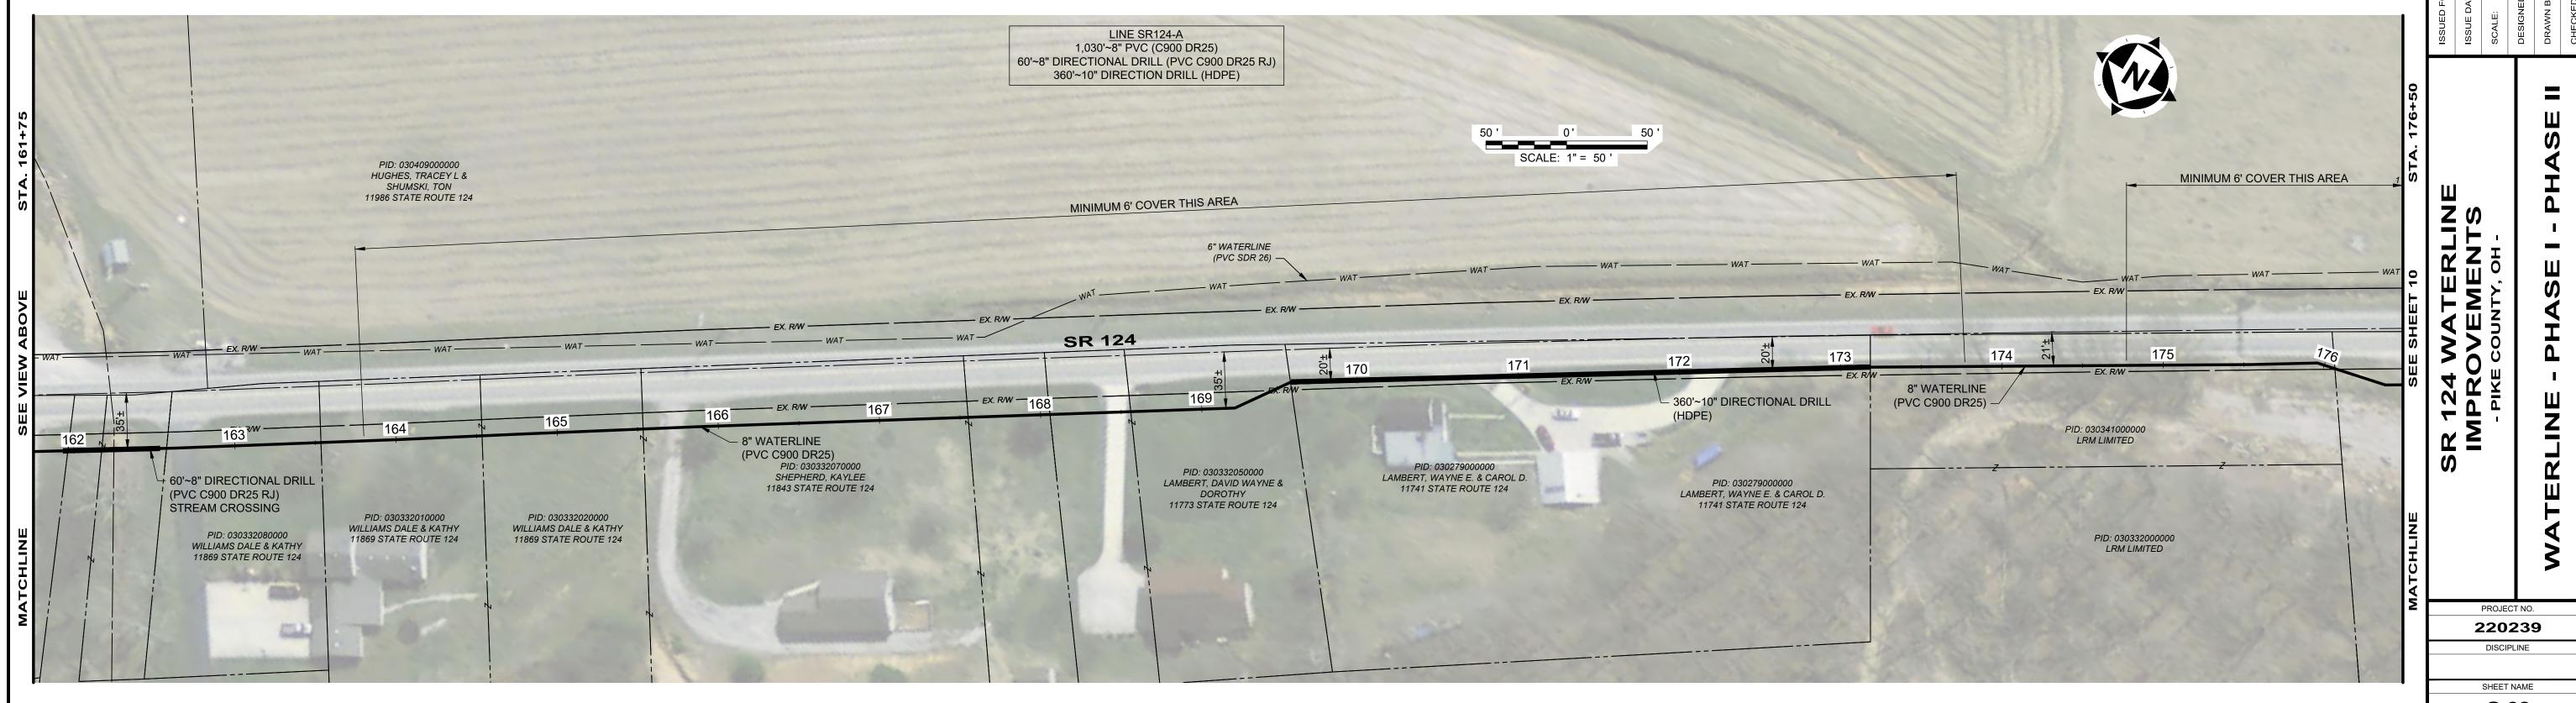

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SHEET NAME C-06

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SHEET

- 8" GATE VALVE

6" GATE VAVLE


6" HYDRANT

**DETAIL B** SCALE: 1"=30'


- 8" WATERLINE

8" WATERLINE -

8" VALVE

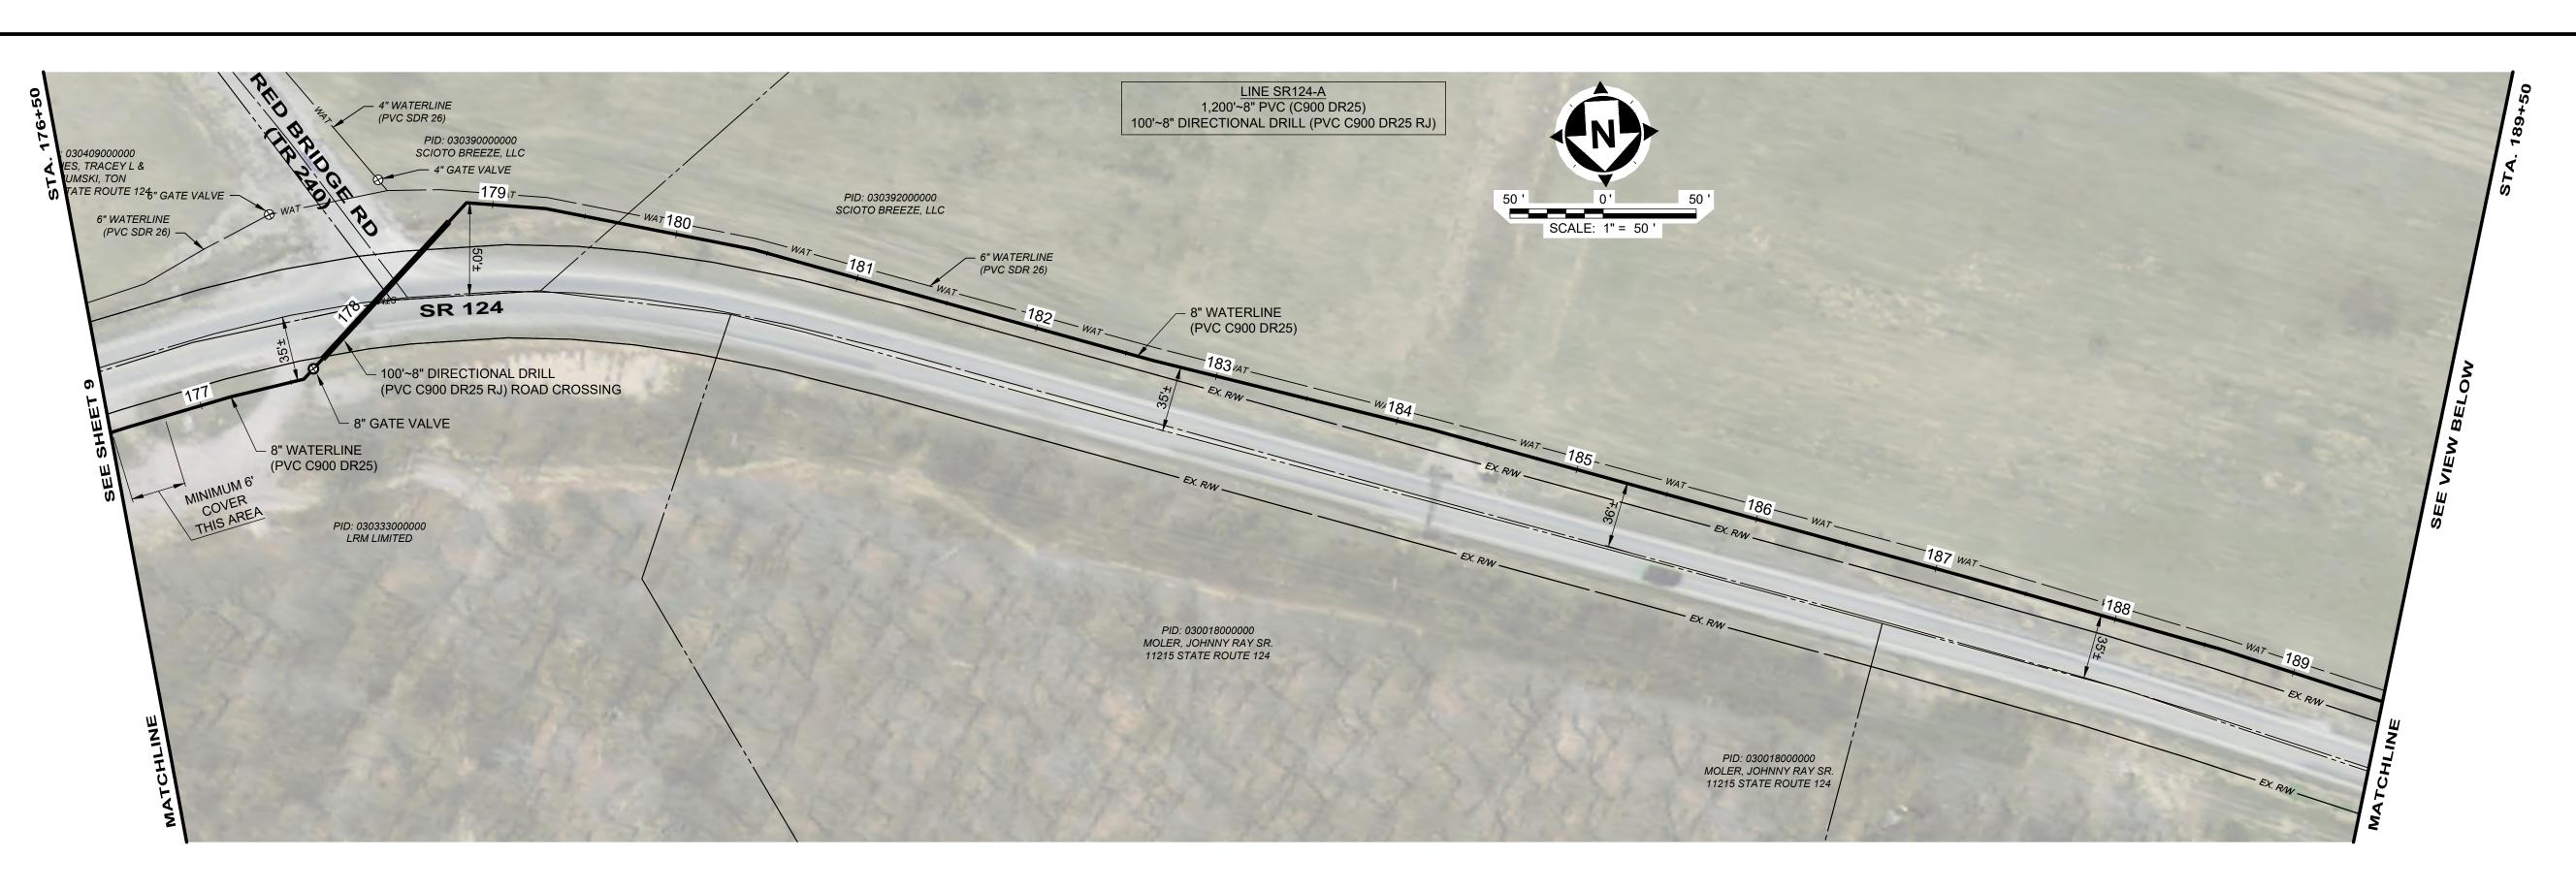

- 1. WATERLINE TO BE INSTALLED IN PUBLIC RIGHT OF WAY:
- LINE 124-A: STA. 177+73 TO STA. 178+51

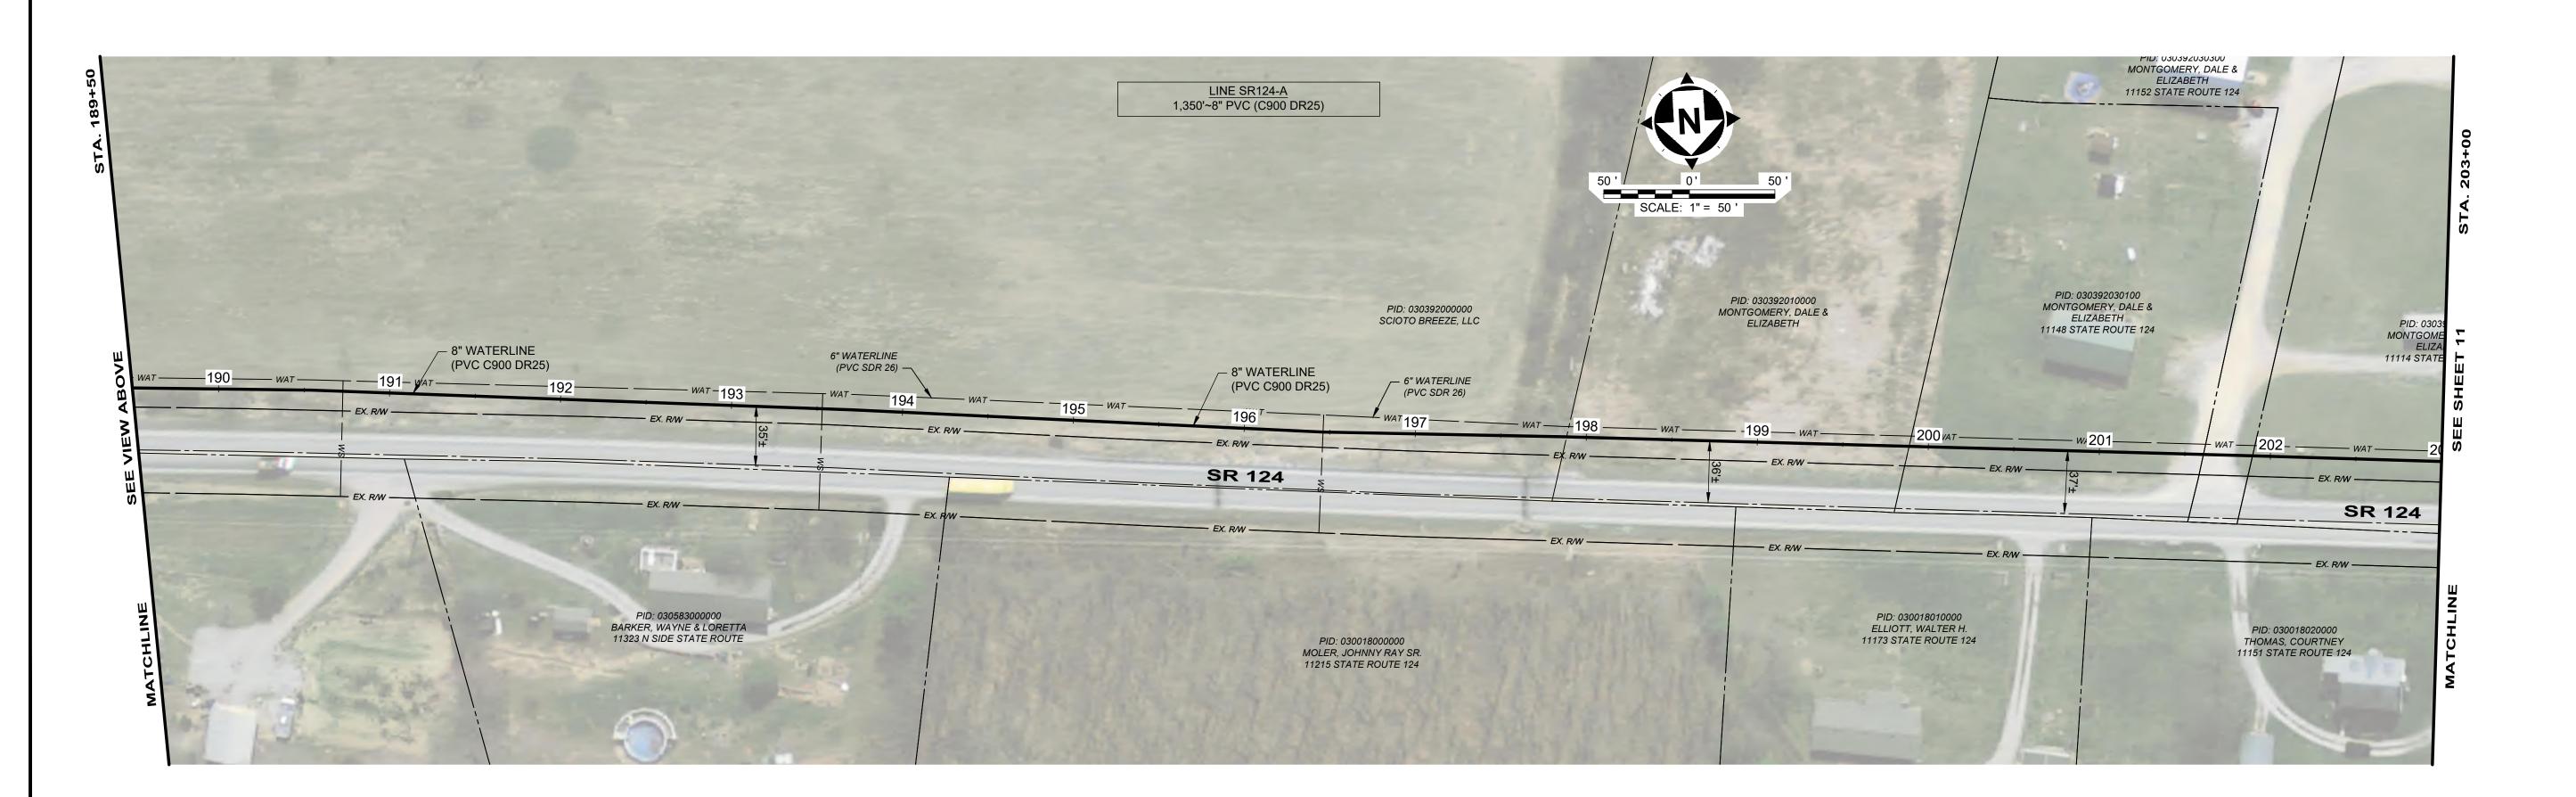


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			ISSUE DATE: 2/6/2025	٢	REVISED FOR CONSTRUCTION	3/20/2025	
		- PIKE COUNTY, OH -	SCALE: AS SHOWN				your trusted advisor
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		WATERLINE - PHASE I	DRAWN BY: RAB				)
			CHECKED BY: BRA				


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WATERLINE TO BE INSTALLED IN PUBLIC RIGHT OF WAY:
LINE 124-A: STA. 213+67 TO STA. 216+21



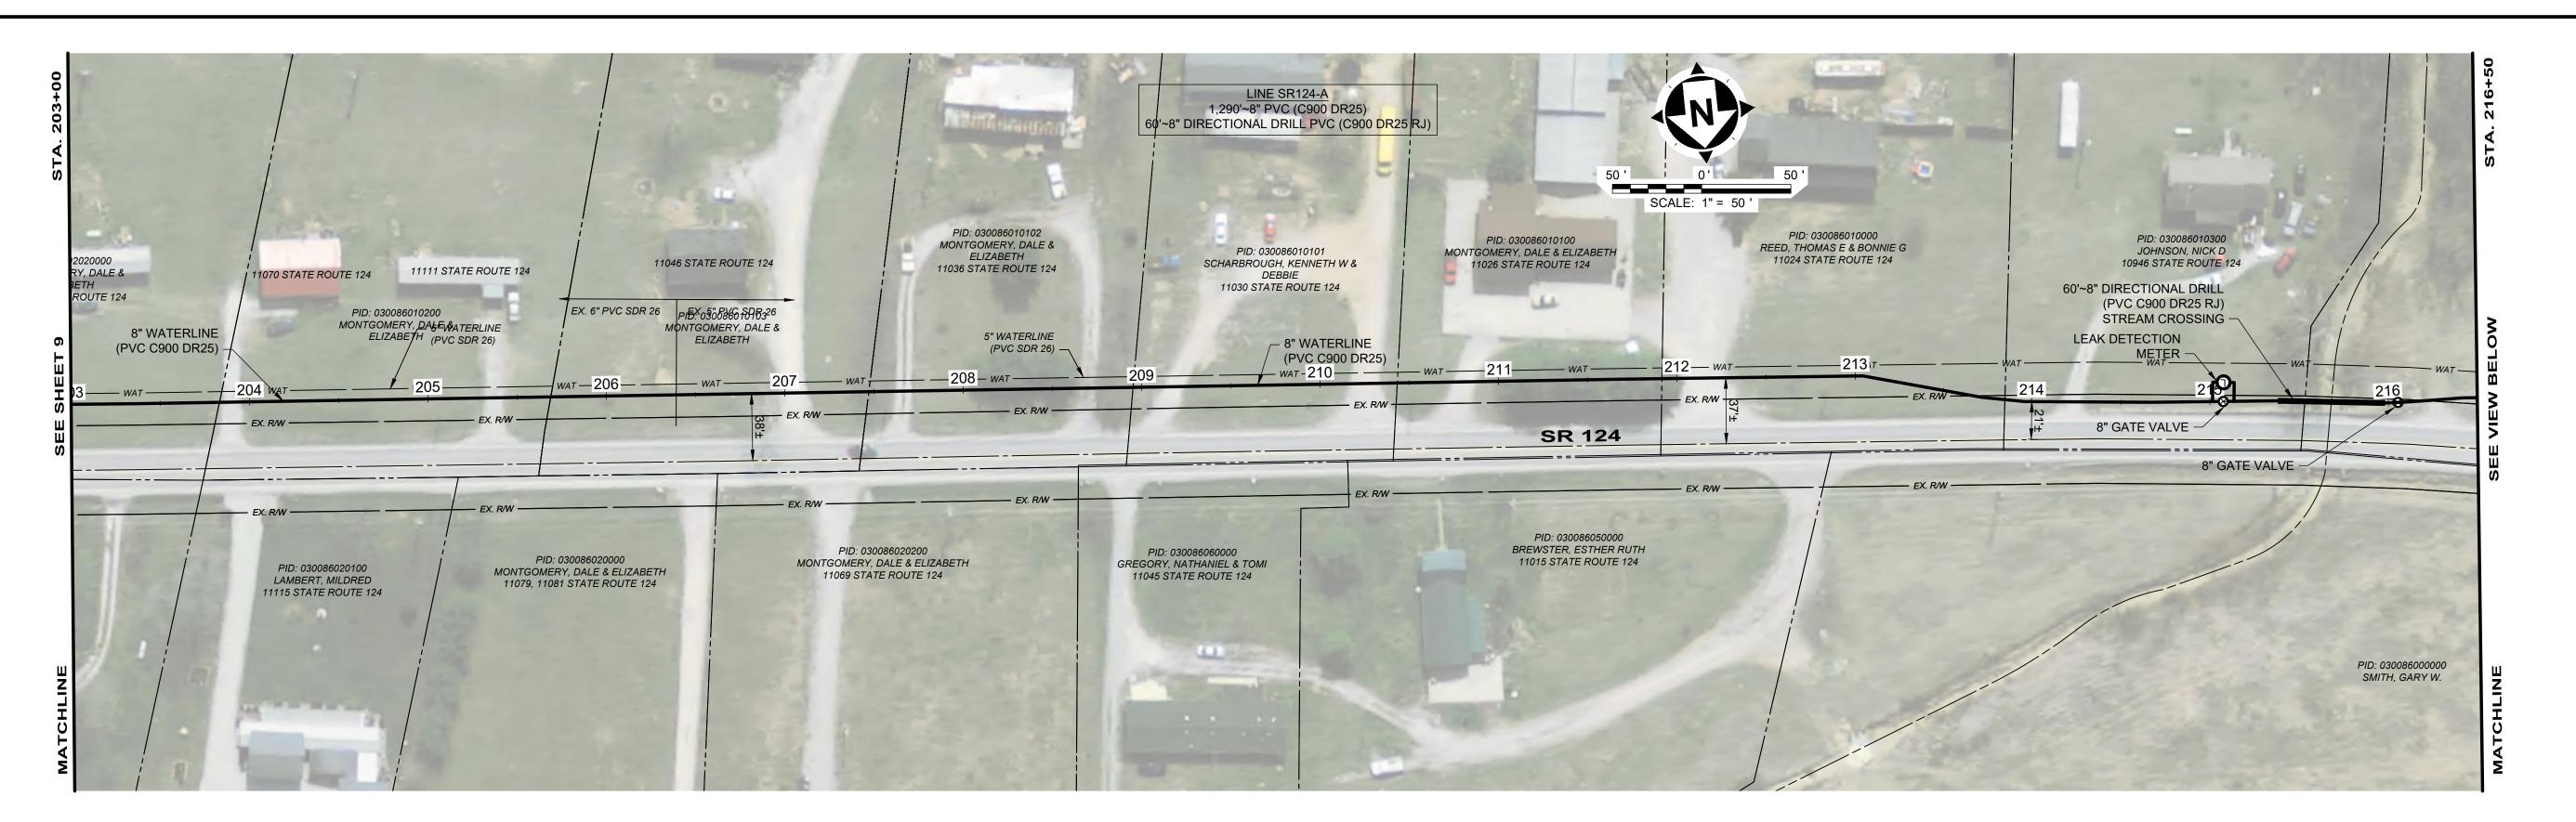

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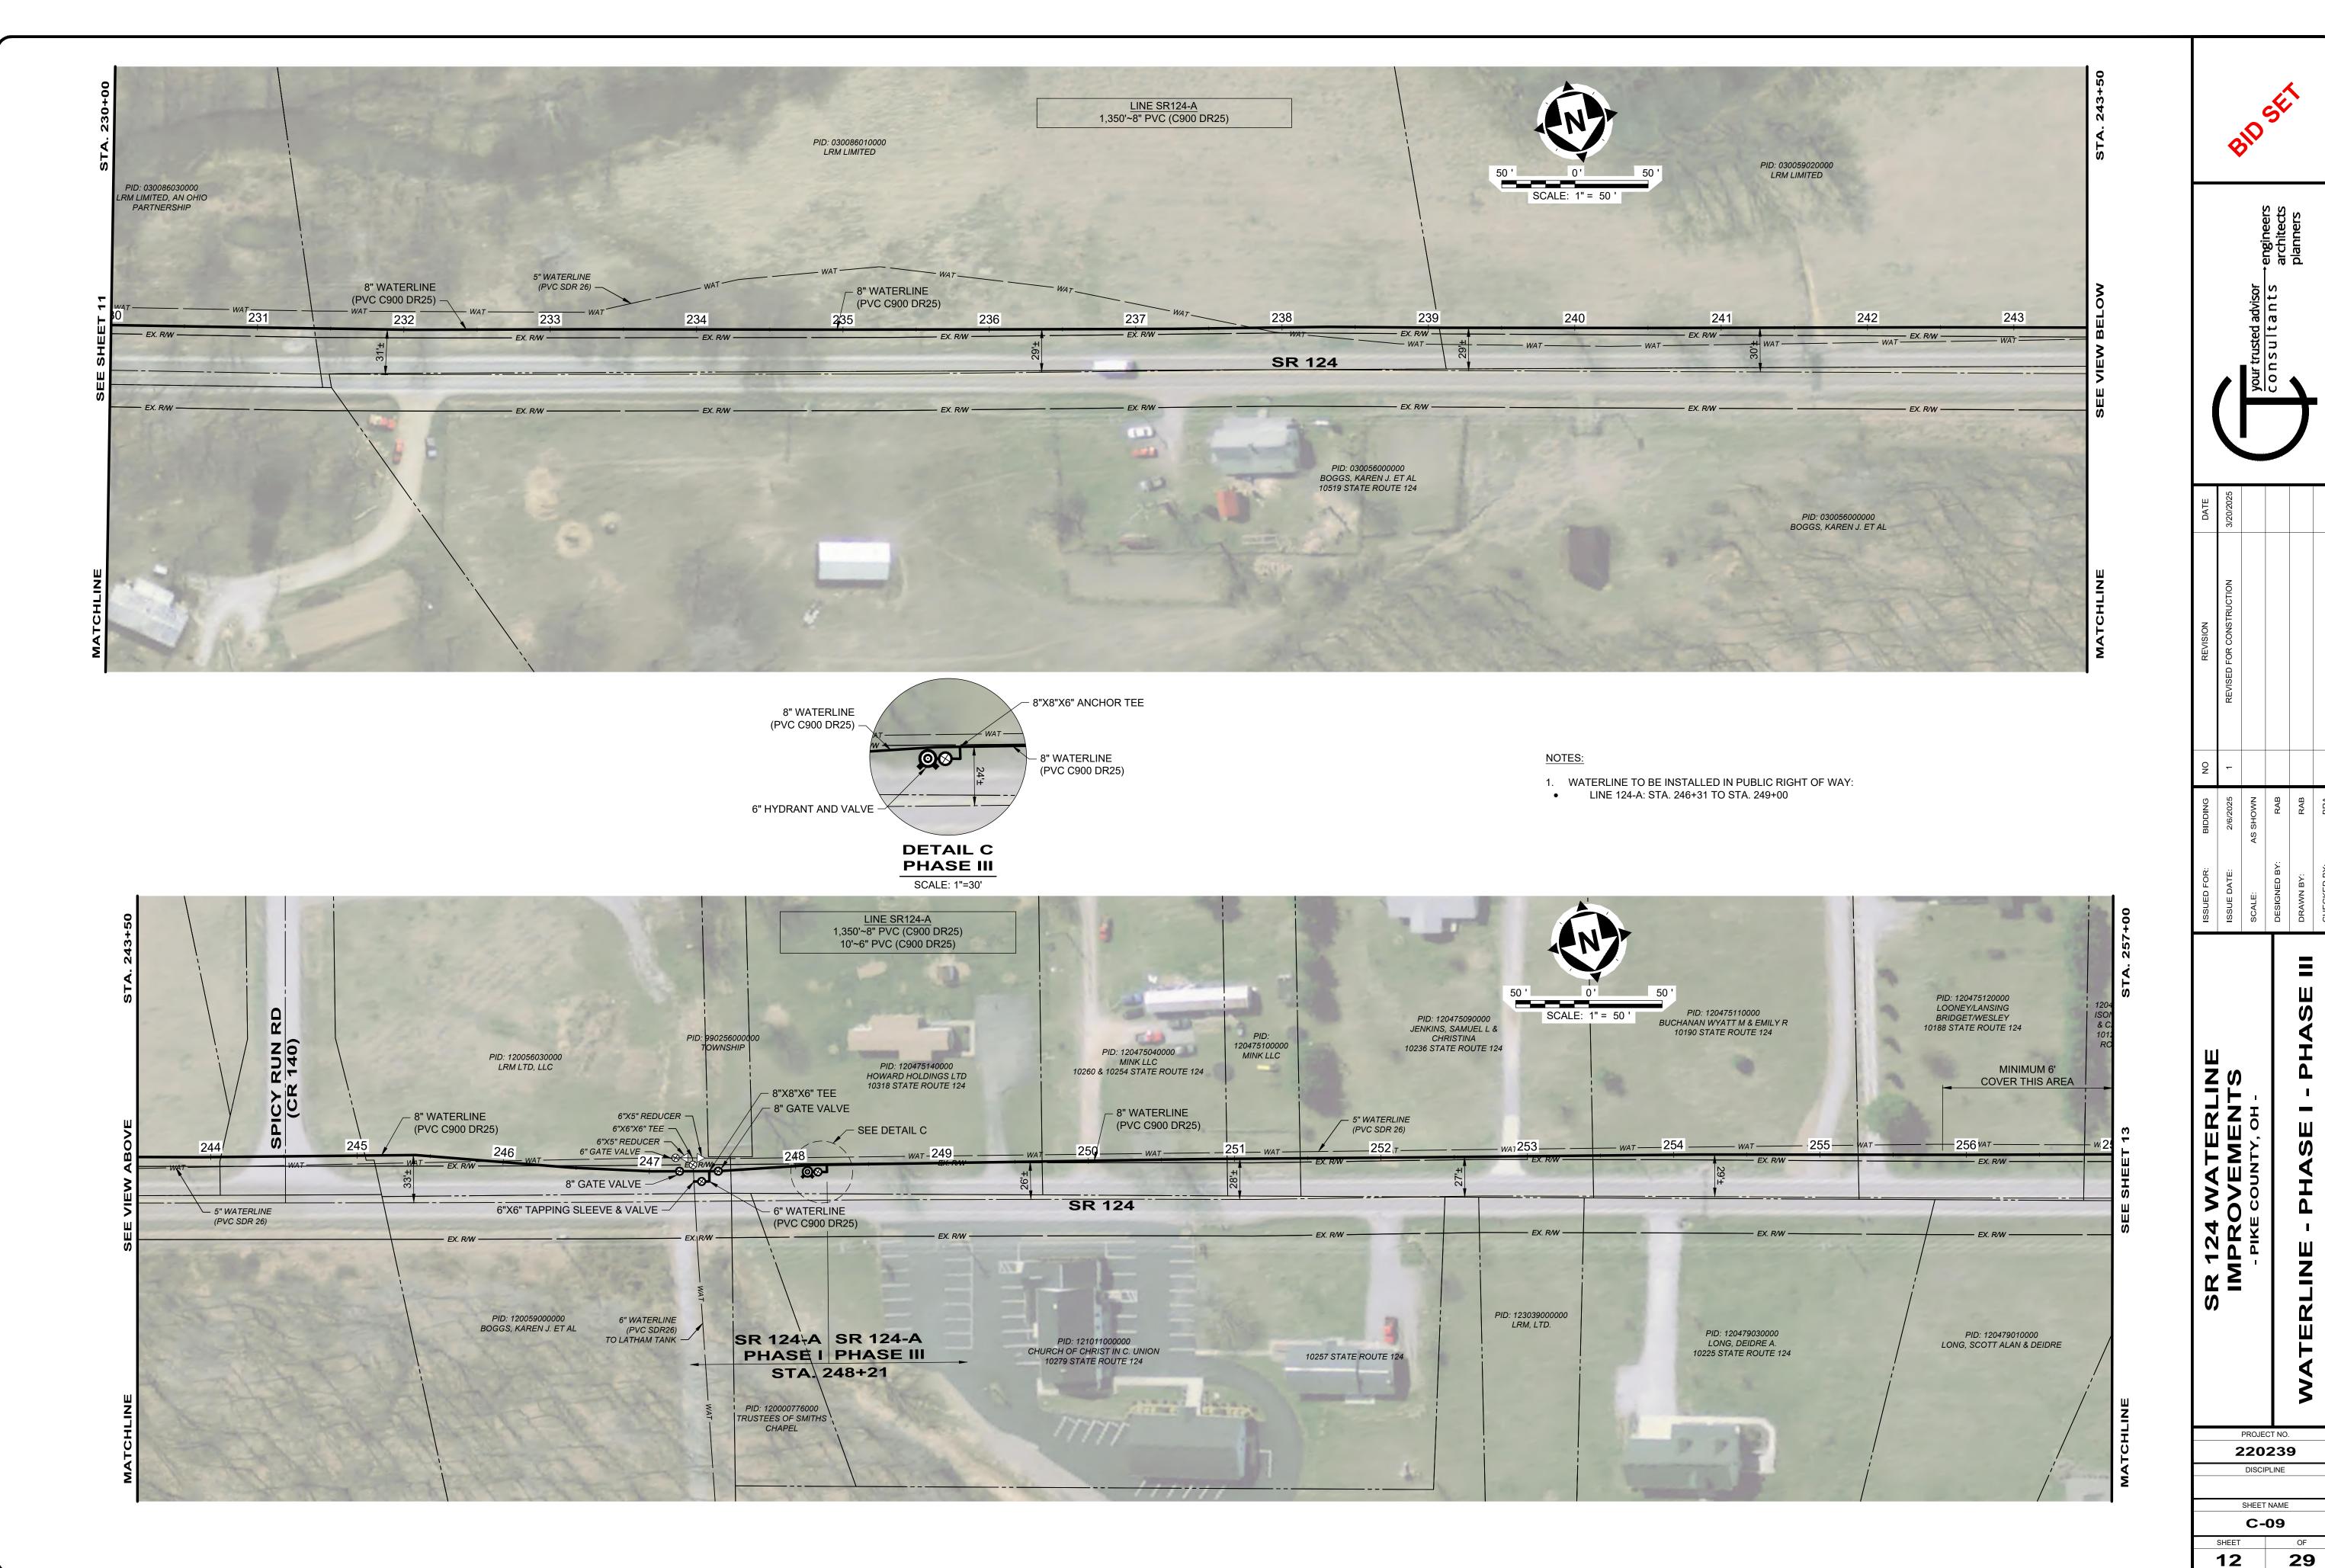
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**220239**DISCIPLINE

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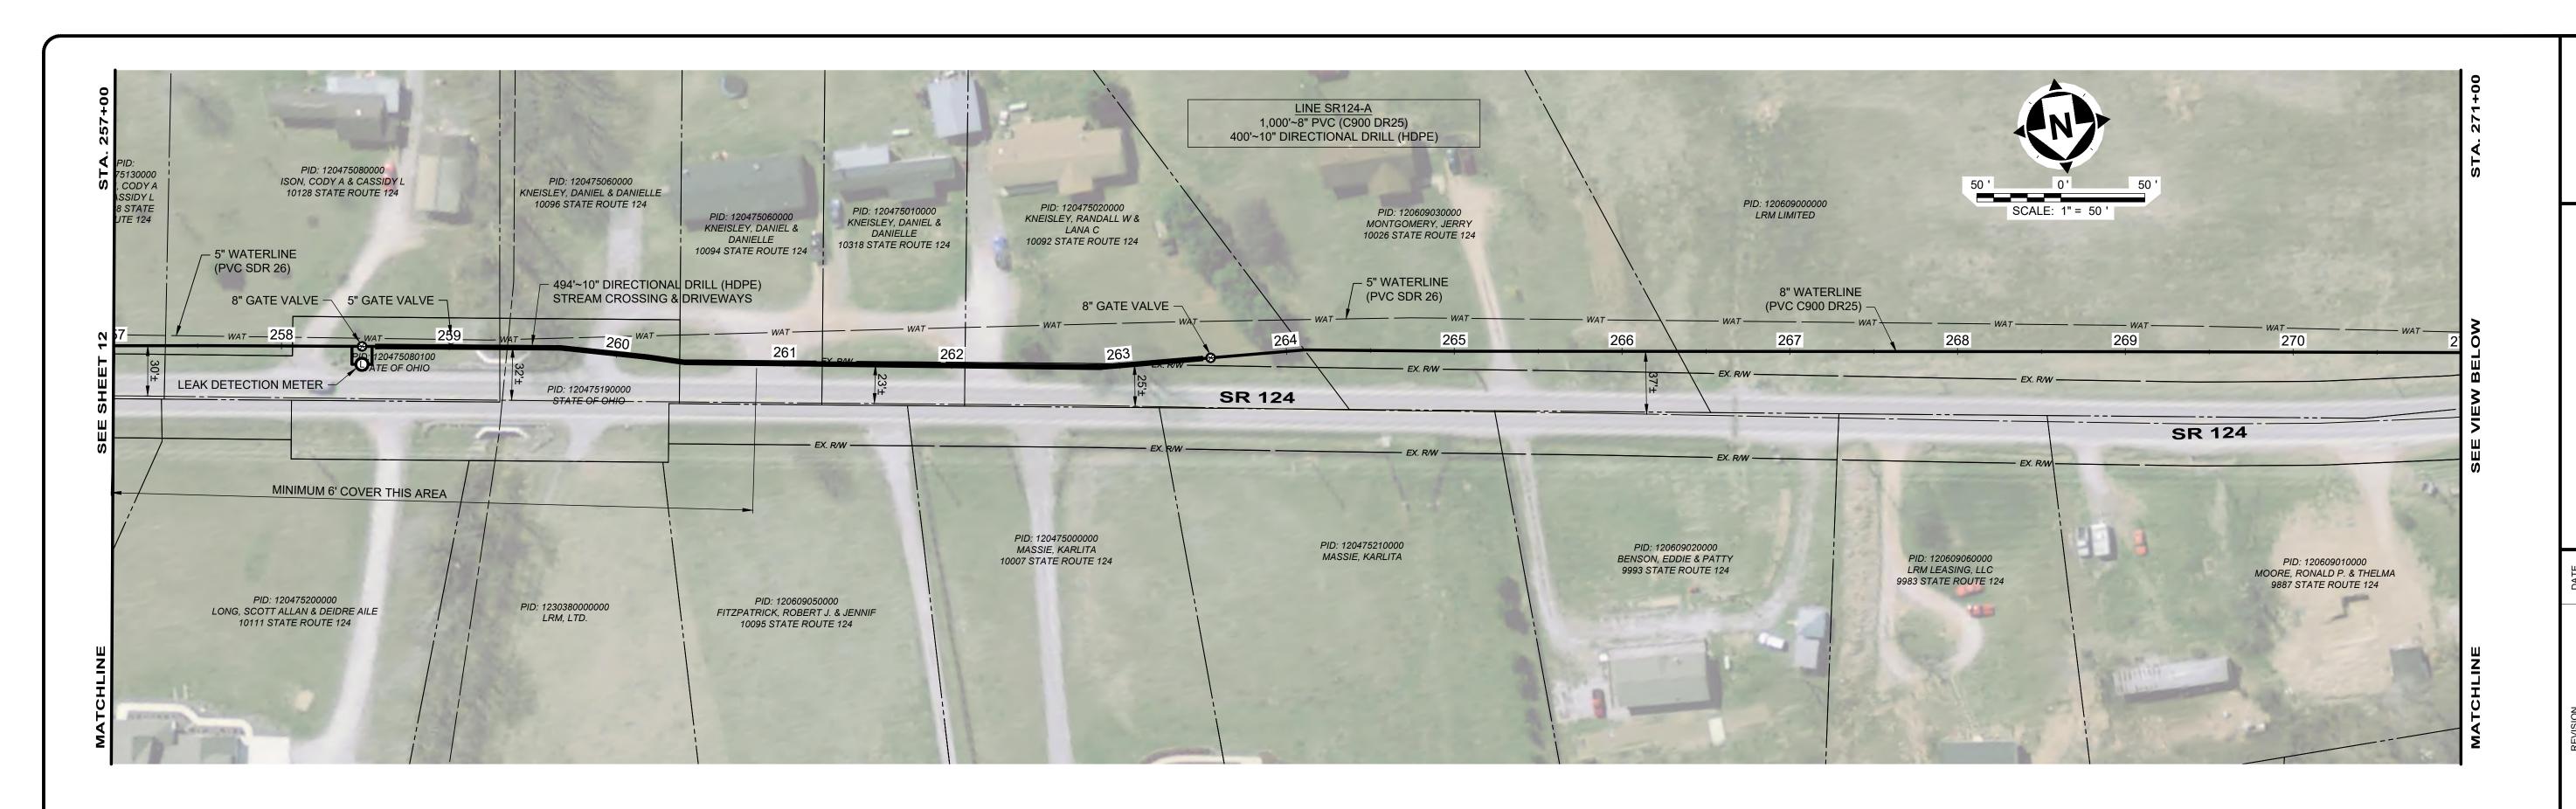


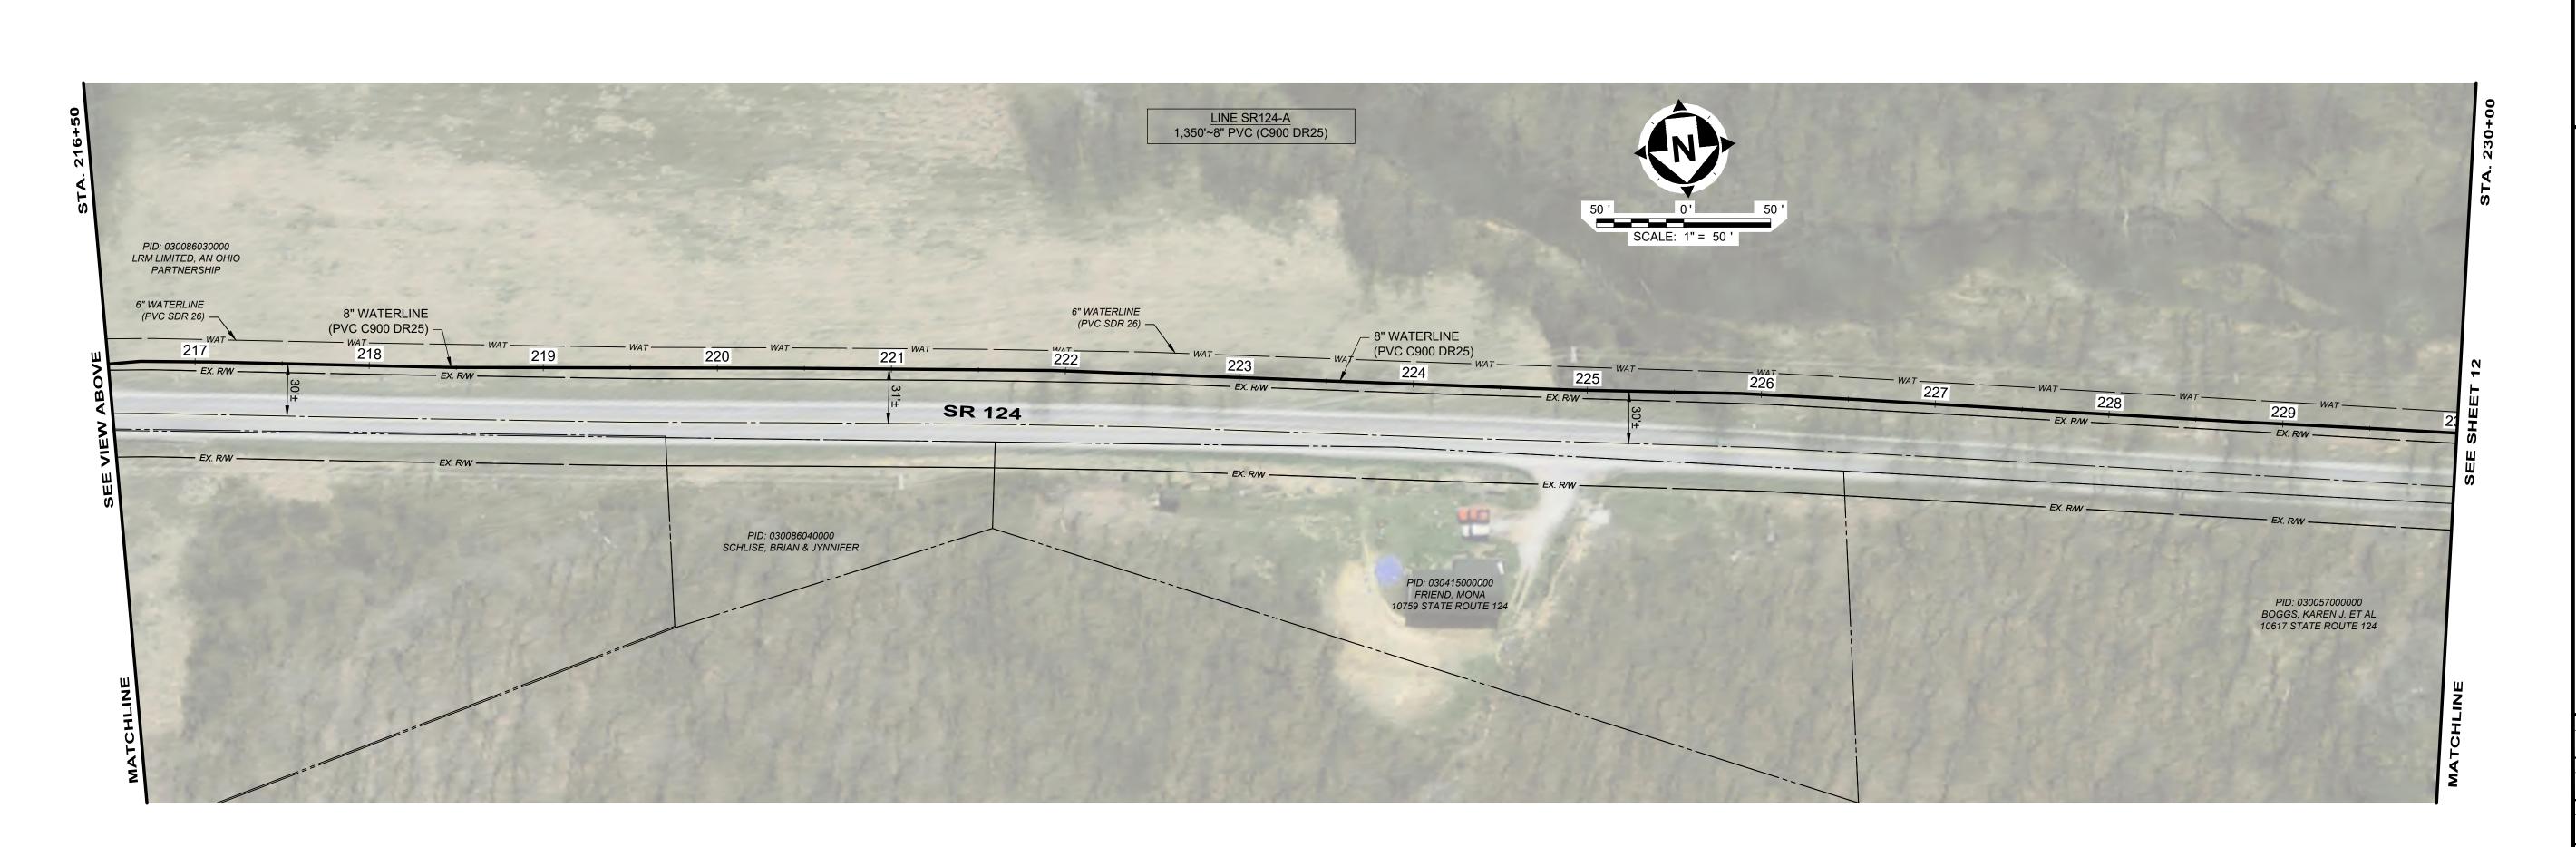PROJECT NO. DISCIPLINE

220239 SHEET NAME


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 $\hbox{C:} \\ \hbox{CT:} \\ \hbox{CAD} \\ \\ \hbox{DRIVES} \\ \\ \hbox{H:} \\ \hbox{2022:} \\ \hbox{220239:} \\ \hbox{DWG:} \\ \hbox{SHEETS:} \\ \hbox{C.220239:} \\ \hbox{PLAN-3.DWG-C-09-3/24/2025:} \\ \hbox{10:} \\ \hbox{29:} \\ \hbox{05-AM-ADAM DAWSON.} \\ \hbox{C.2003:} \\ \hbox{C.2003:}$ 




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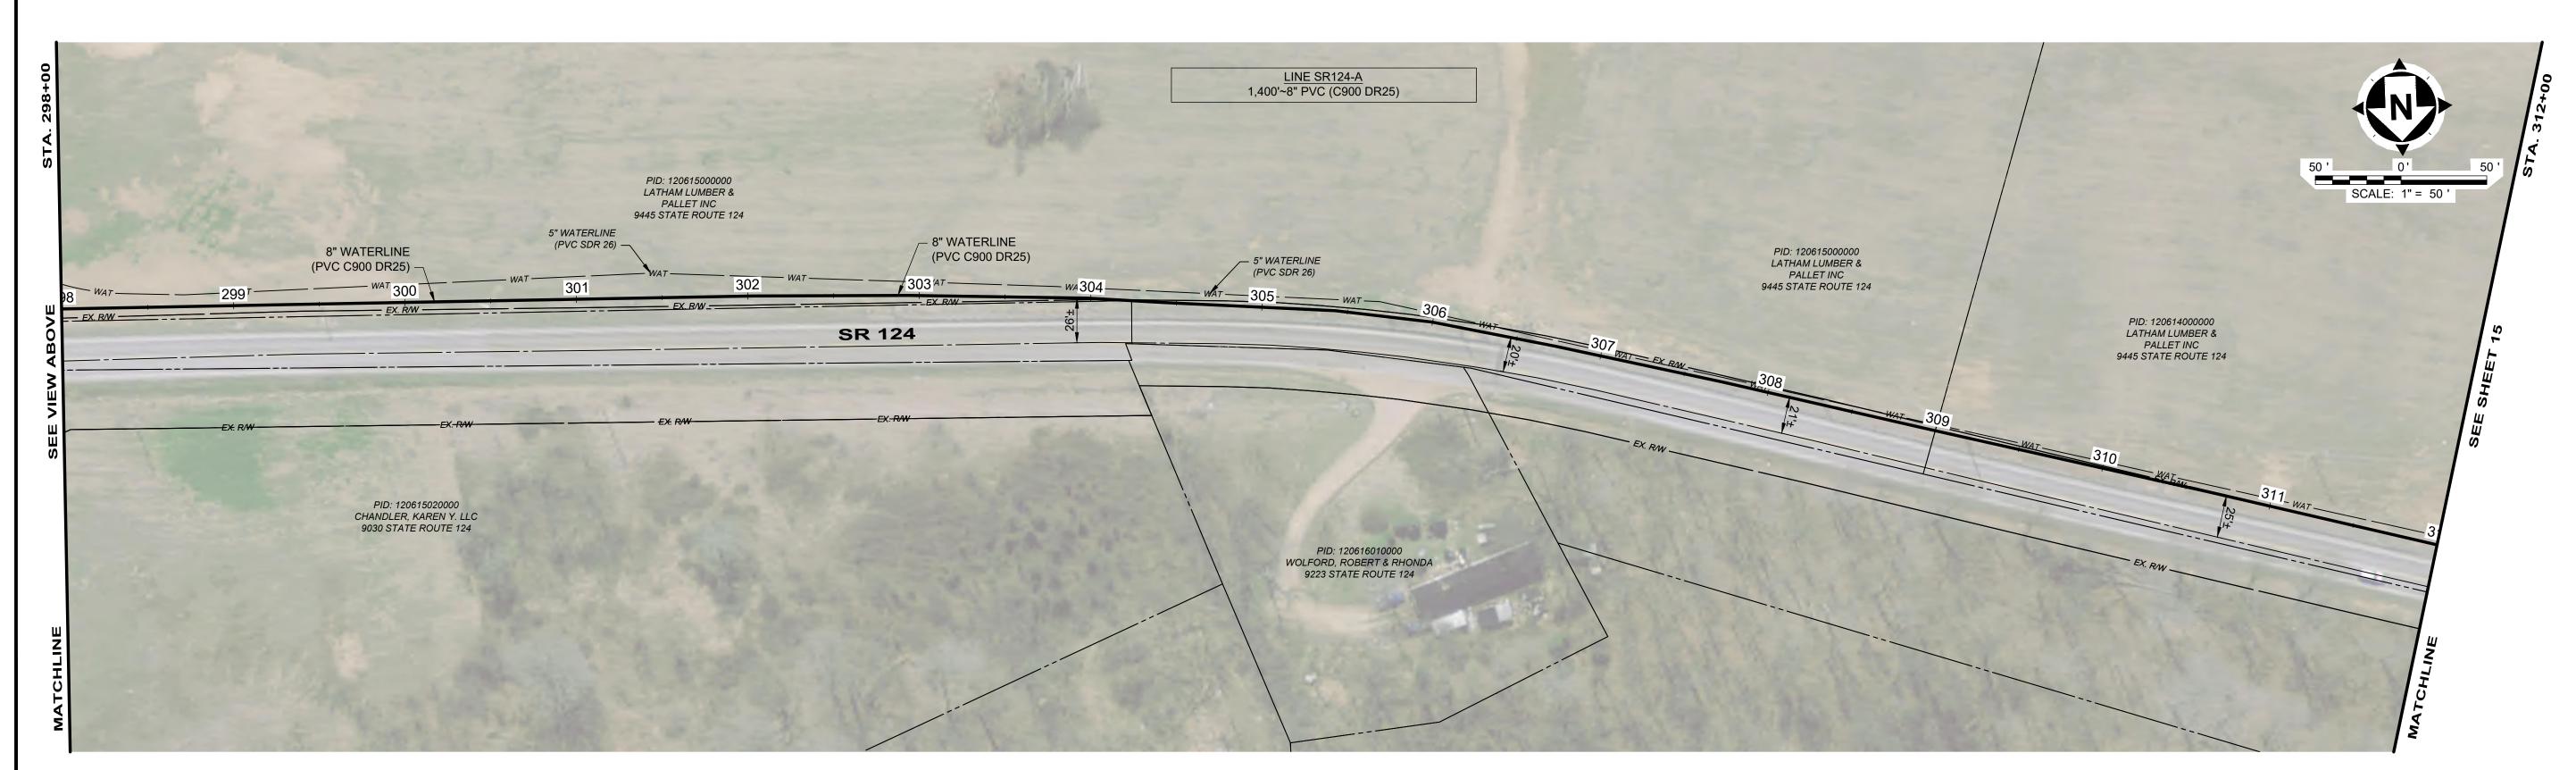
- 1. WATERLINE TO BE INSTALLED IN PUBLIC RIGHT OF WAY:
- LINE 124-A: STA. 258+06 TO STA. 263+09
  LINE 124-A: STA. 272+21 TO STA. 284+50



SCALE: AS SHOW AND	MPROVEMENTS 1/6/2025 1	0/2025
WATERLINE - PHASE III  CHECKED BY:  CHECKED BY:	- PIKE COUNTY, OH -	
WATERLINE - PHASE III CHECKED BY:	DESIGNED BY:	
CHECKED BY:	WATERLINE - PHASE III	
	CHECKED BY:	

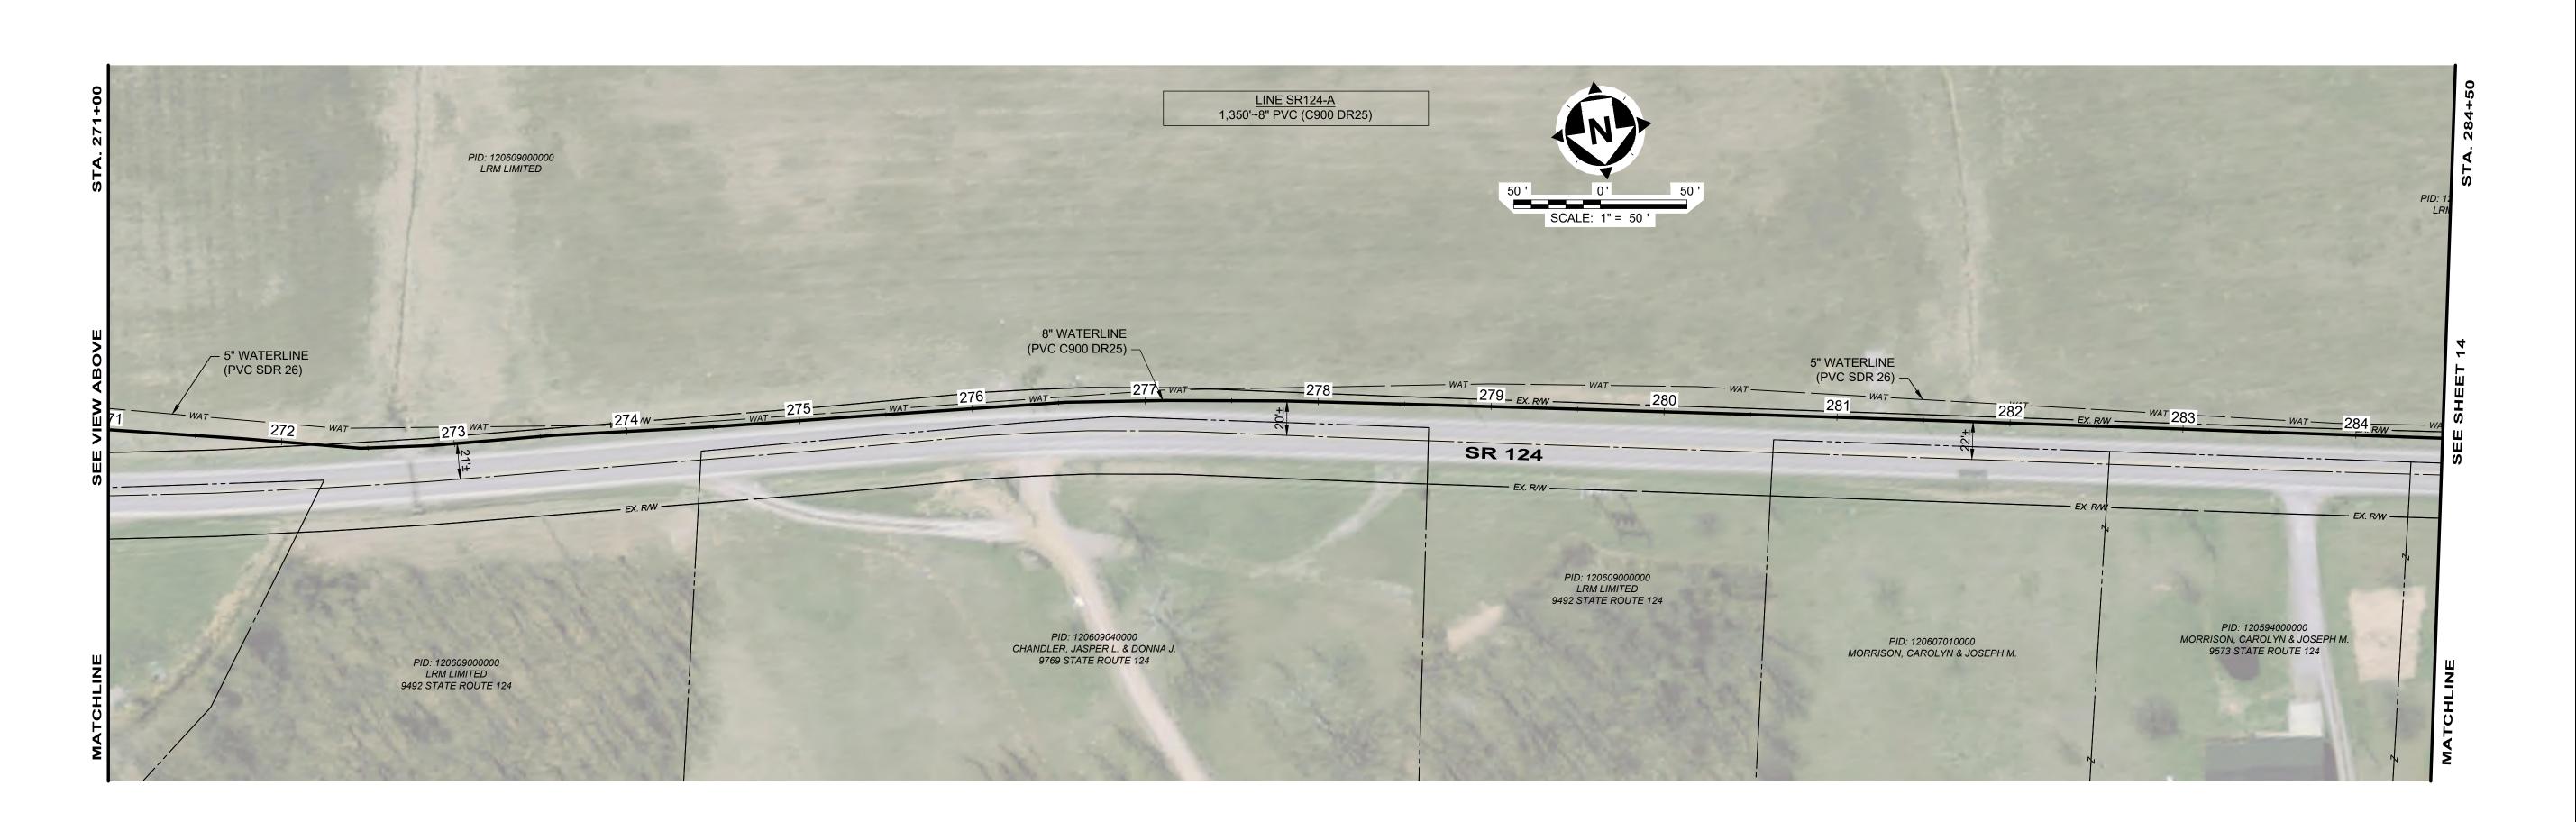


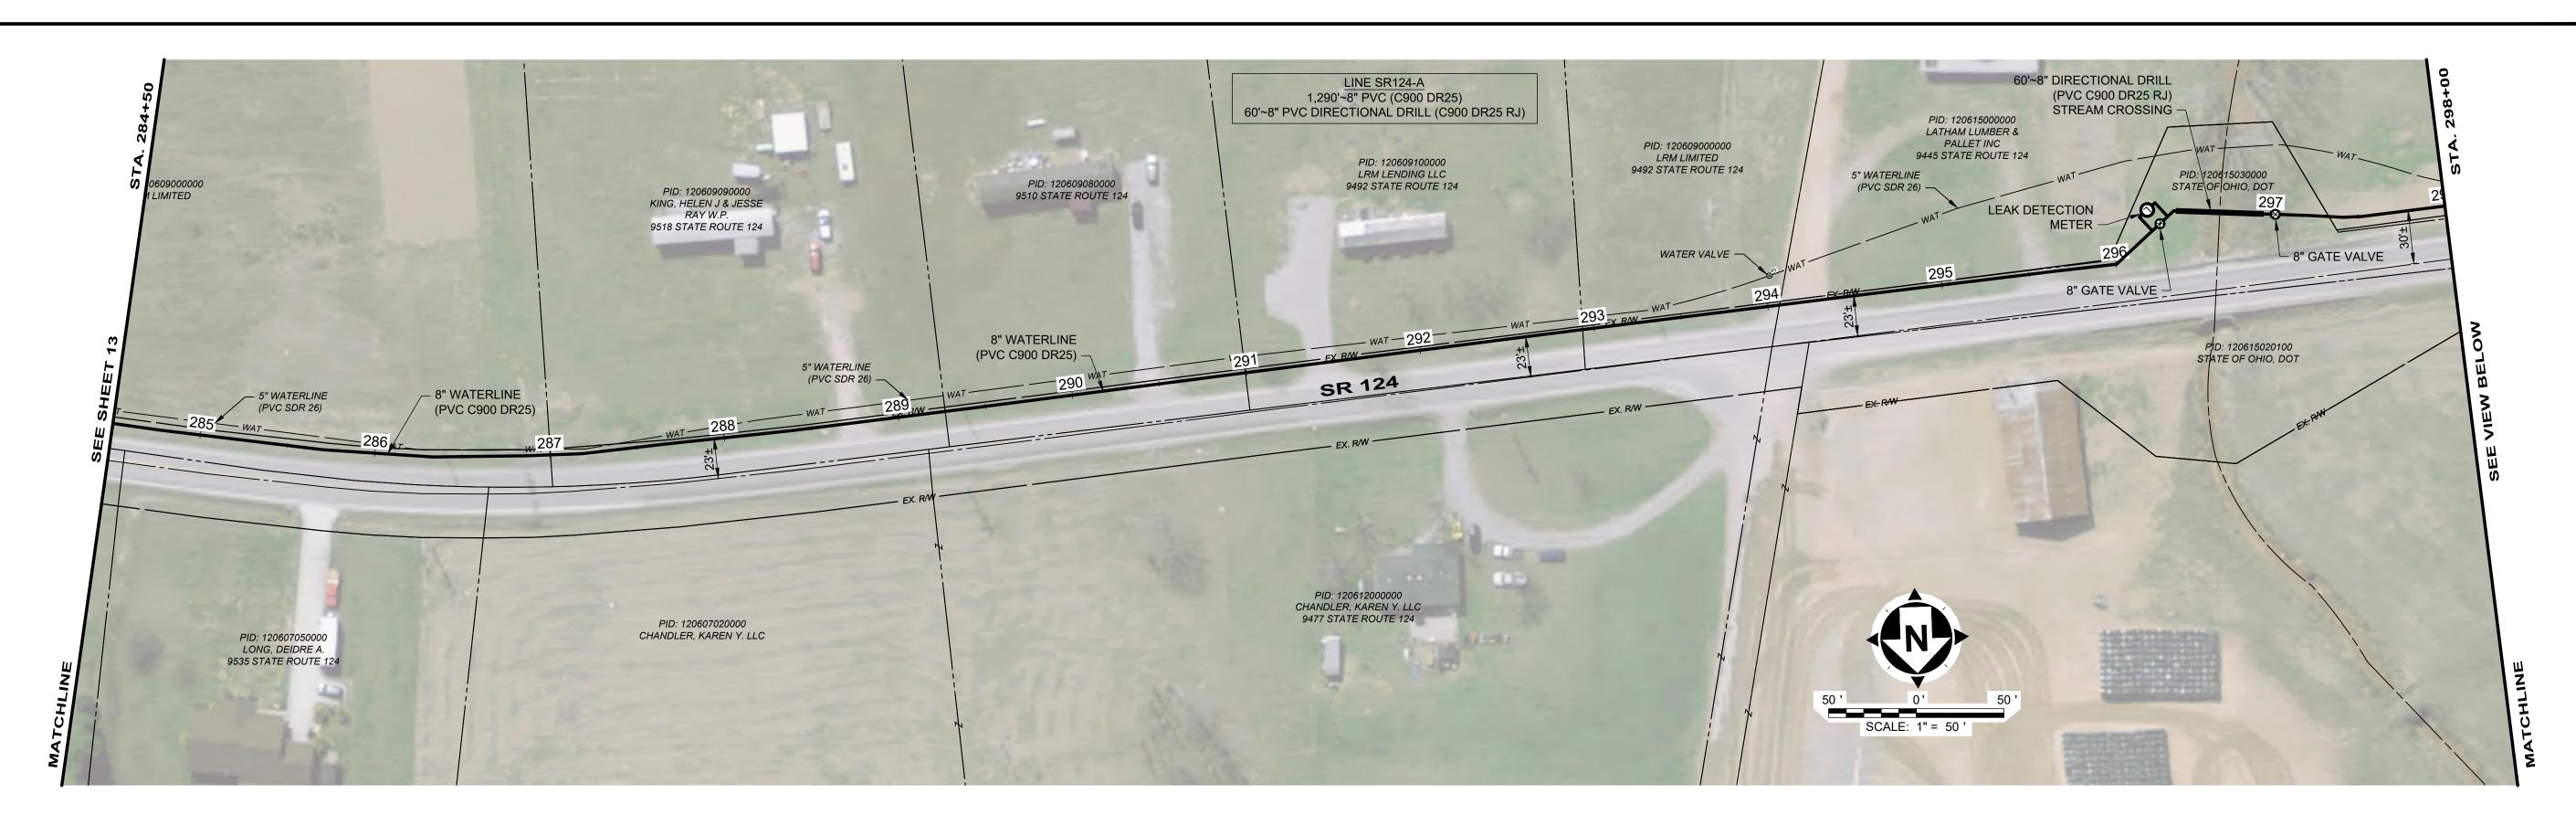- 1. WATERLINE TO BE INSTALLED IN PUBLIC RIGHT OF WAY:
- LINE 124-A: STA. 284+50 TO STA. 297+43
  LINE 124-A: STA. 304+15 TO STA. 312+00





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C-11

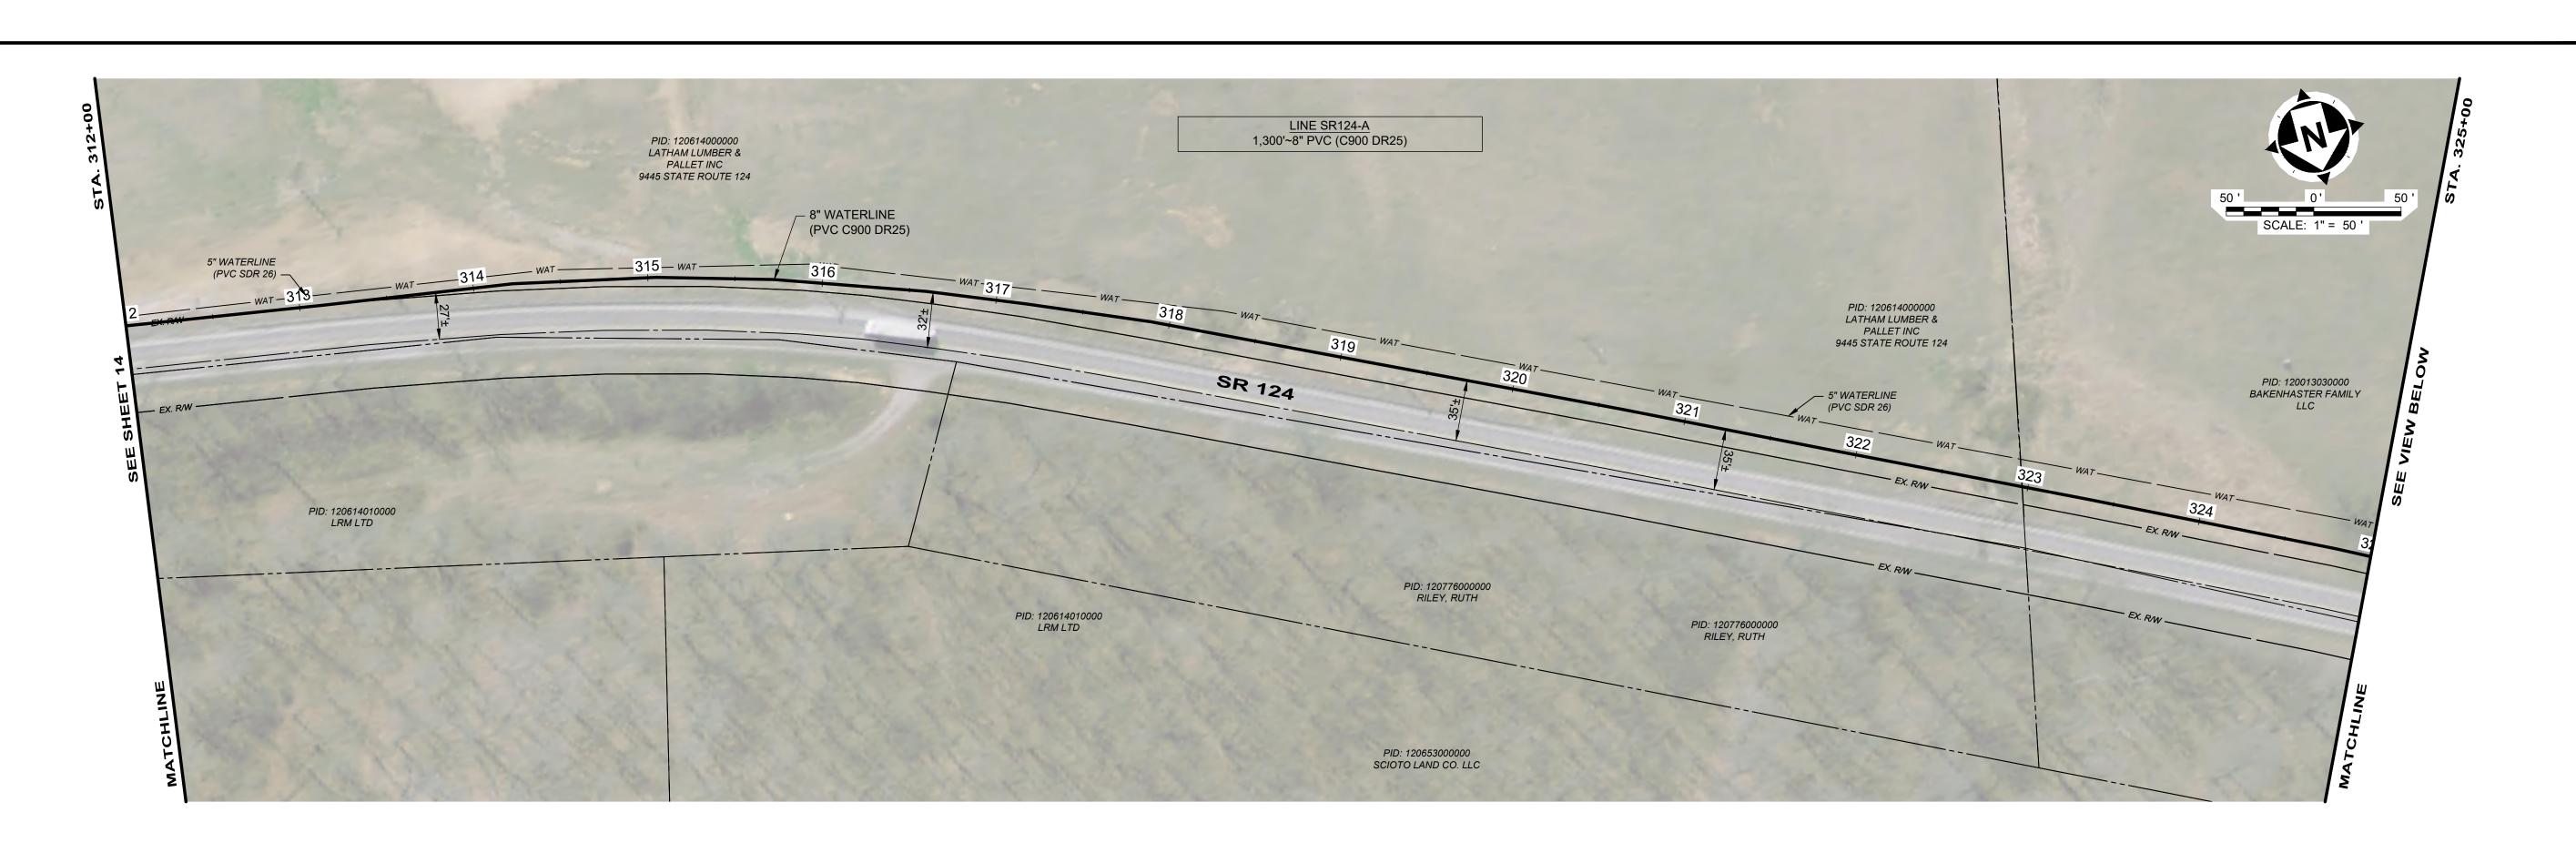

- 1. WATERLINE TO BE INSTALLED IN PUBLIC RIGHT OF WAY:
- LINE 124-A: STA. 312+00 TO STA. 313+00
- LINE 124-A: STA. 328+97 TO STA. 329+47
  LINE 124-A: STA. 334+31 TO STA. 337+20



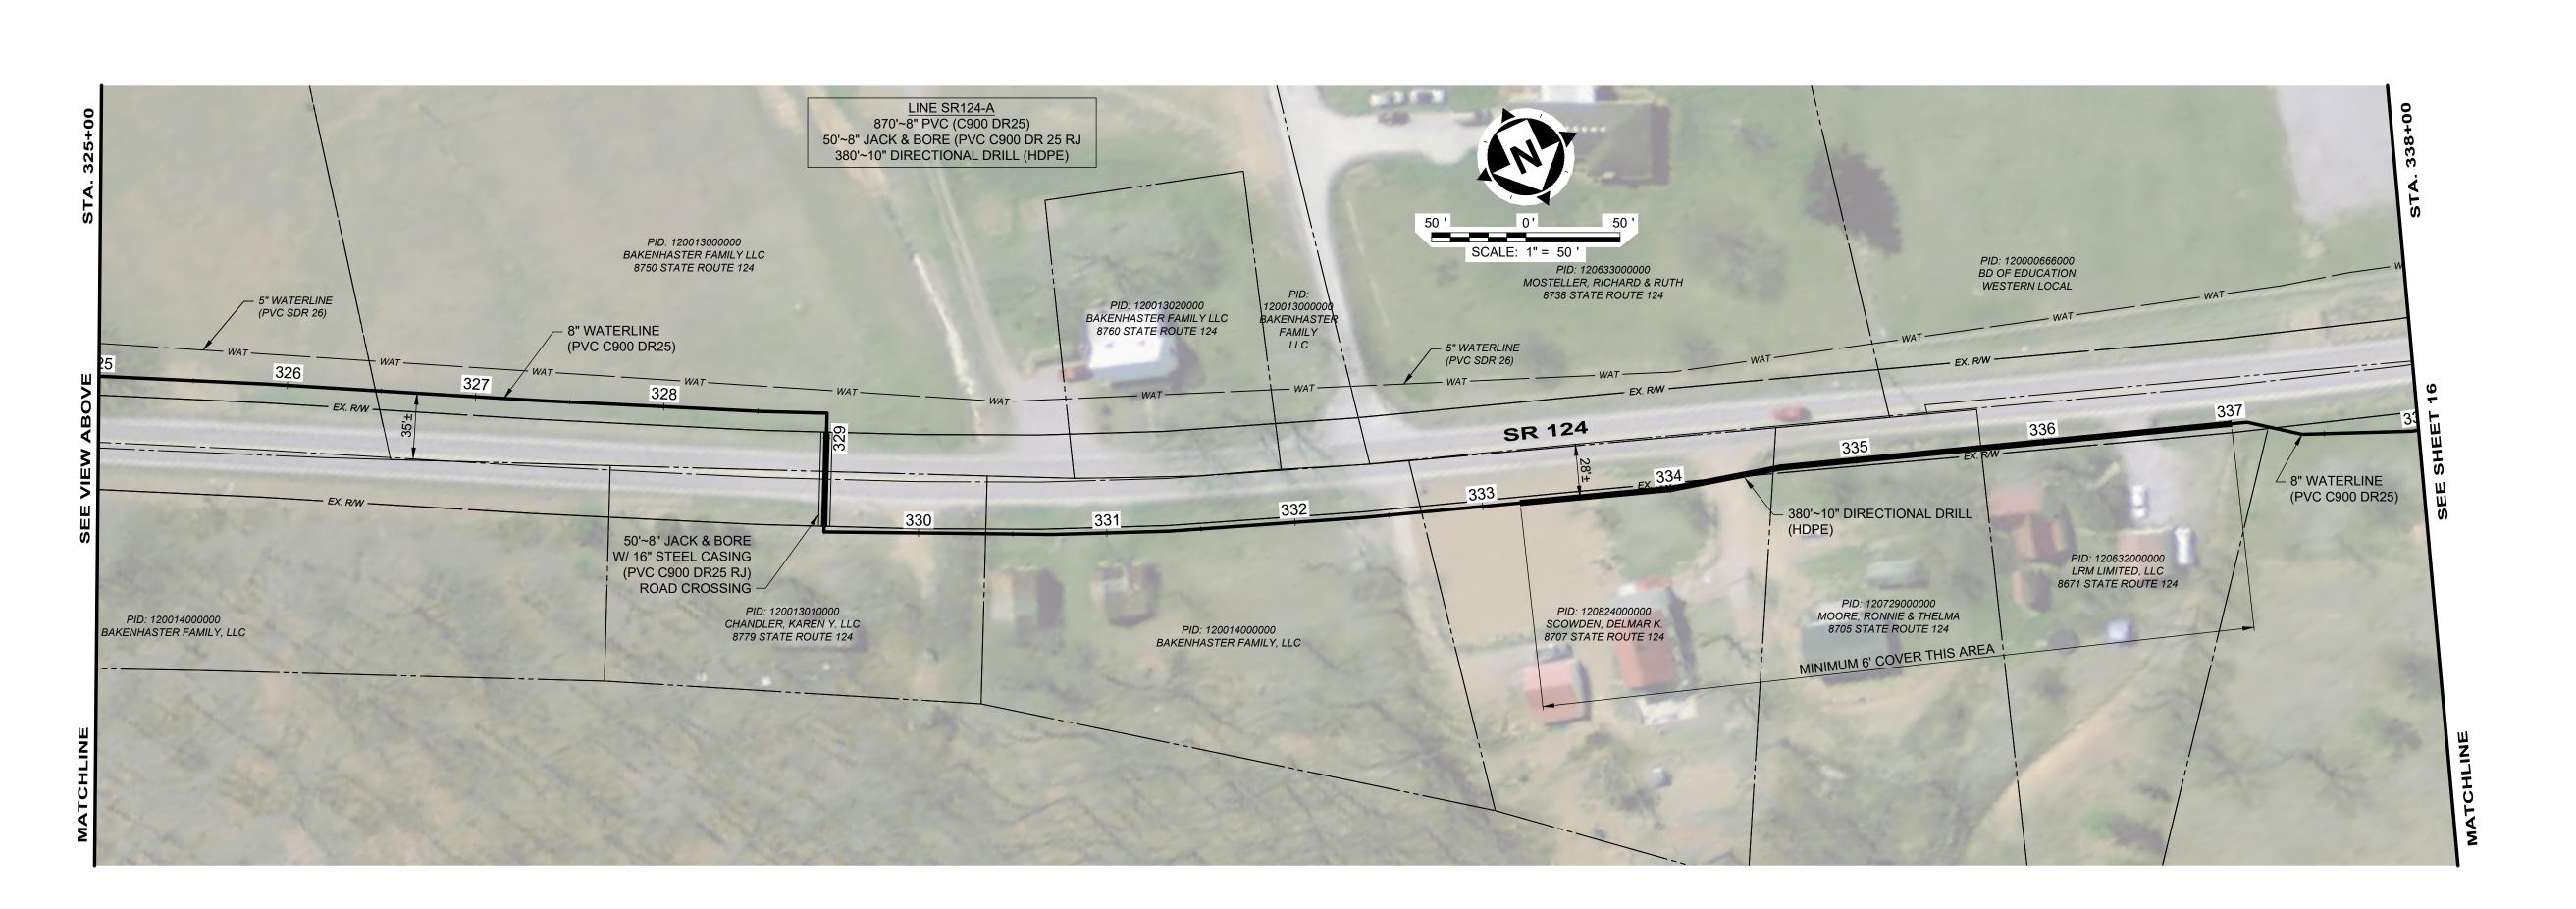

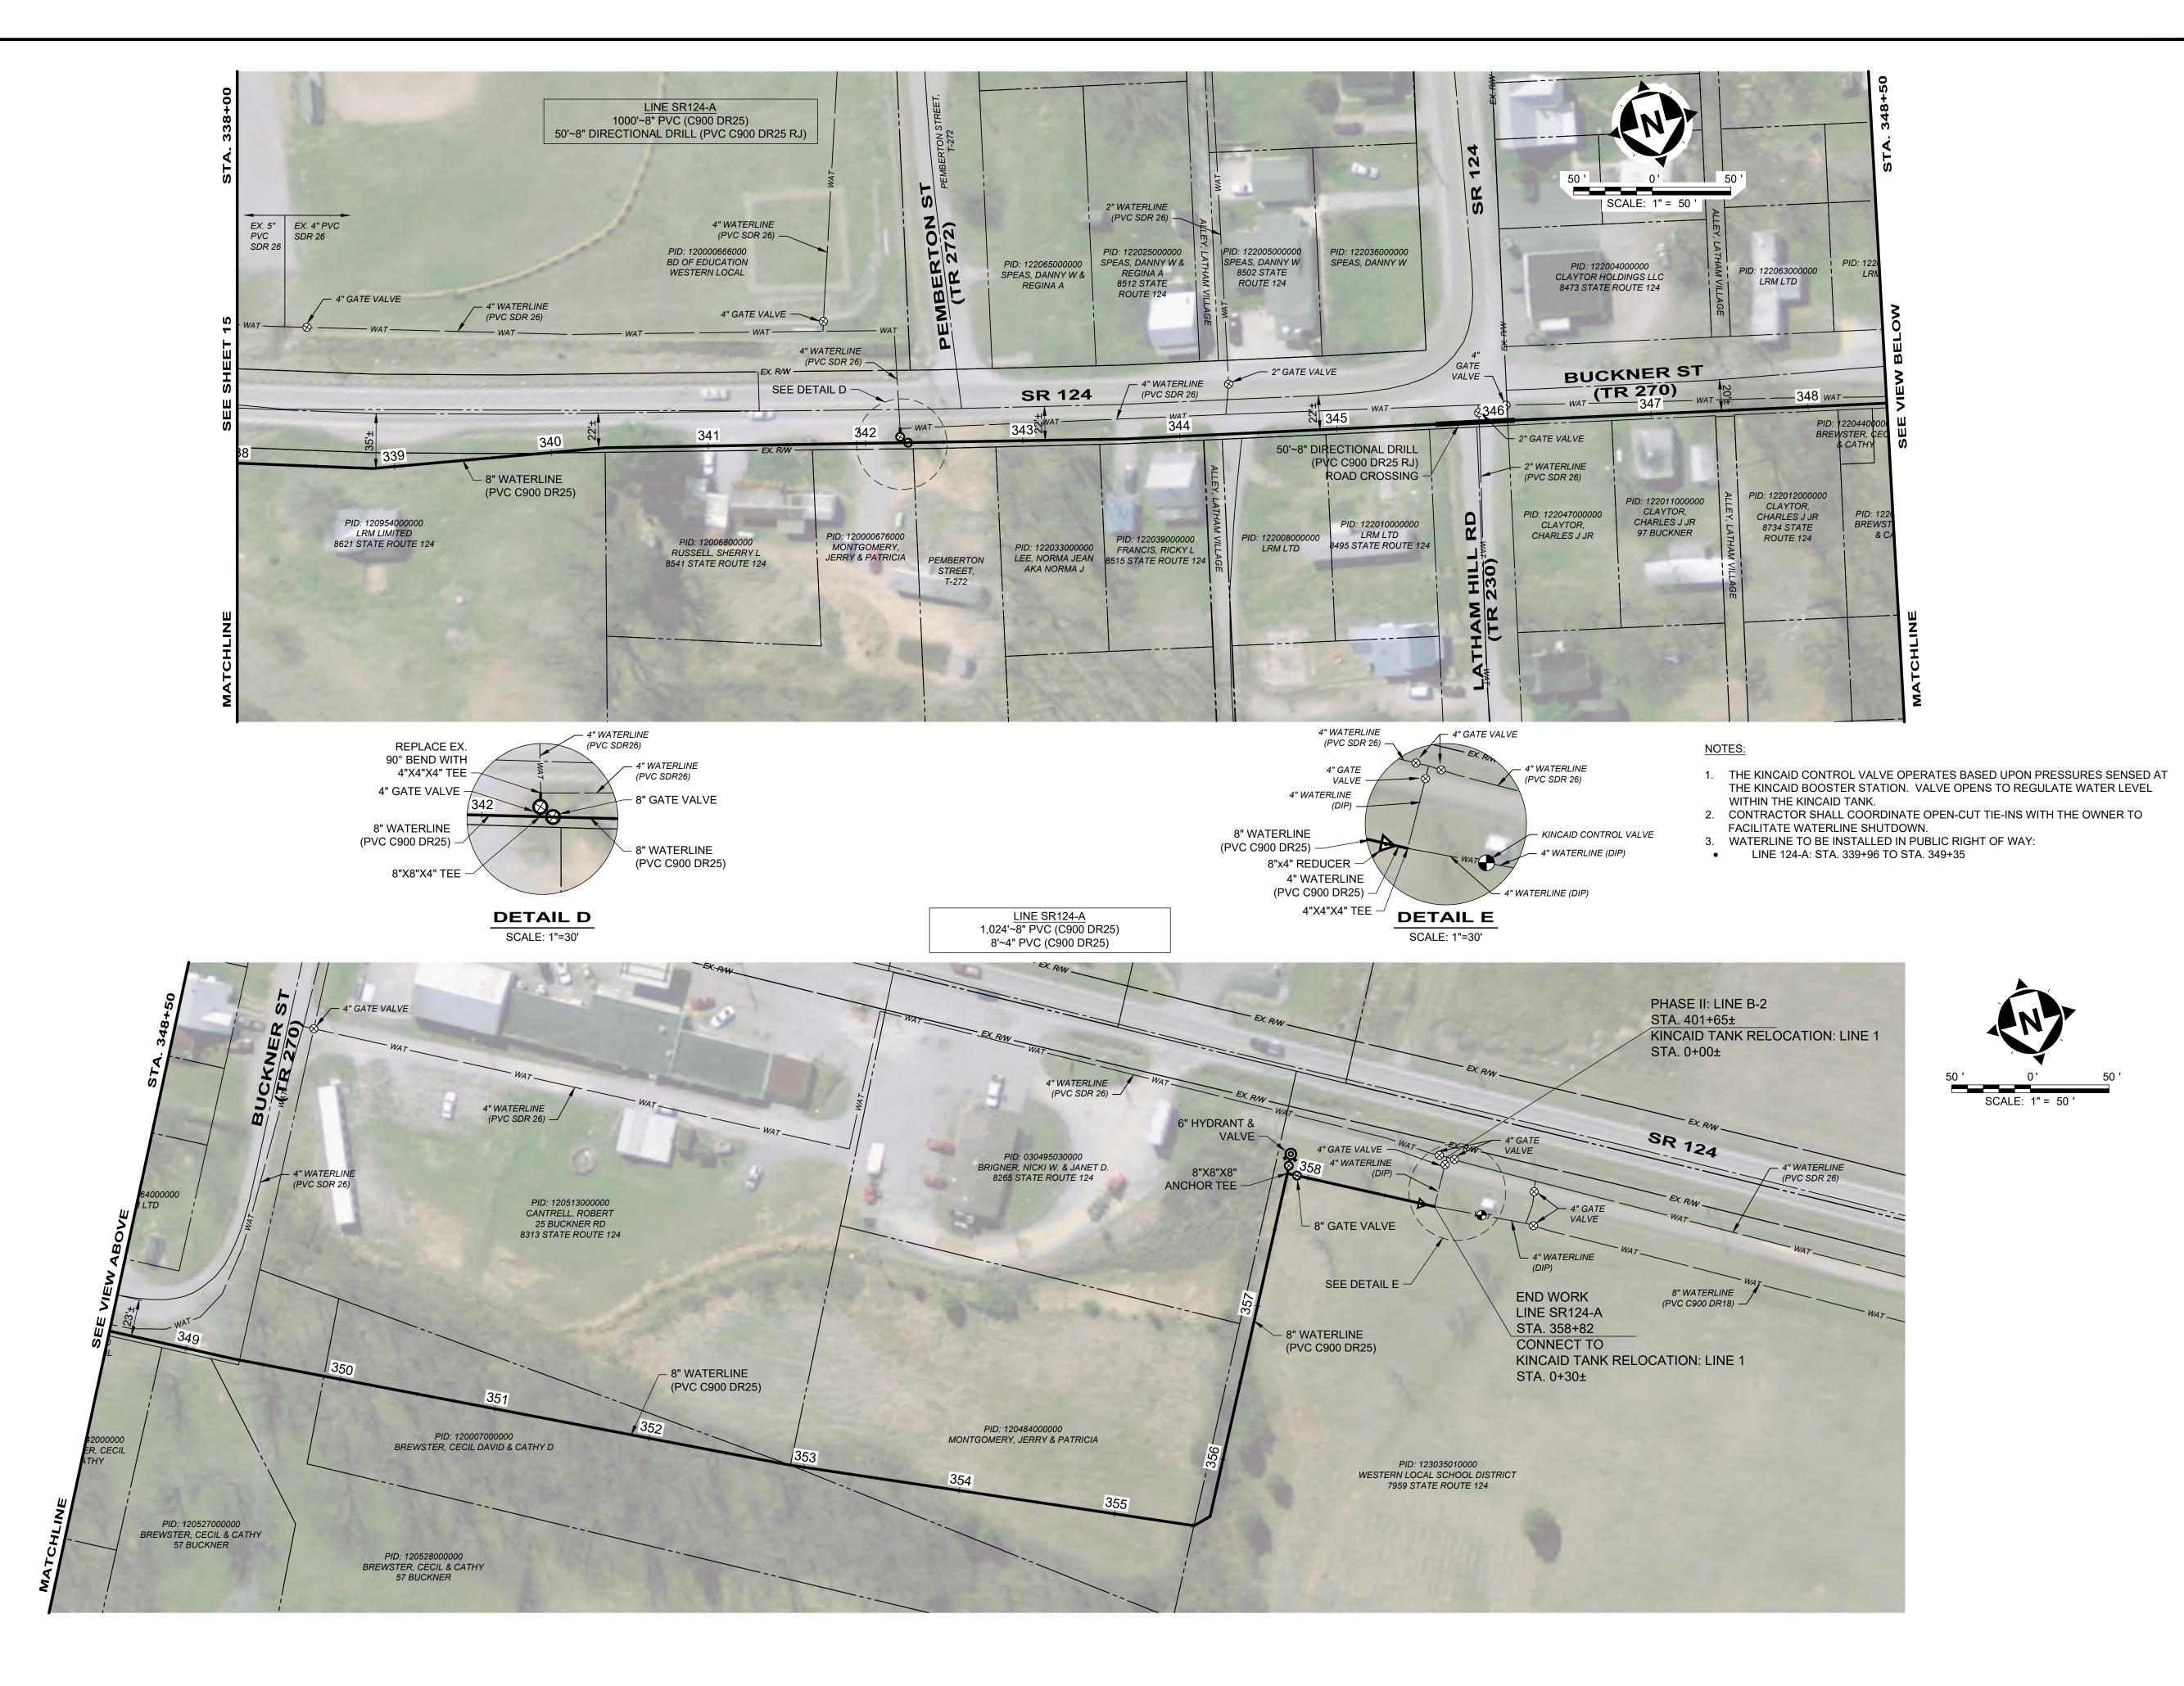

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your trusted advisor	consultants	<u> </u>
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PROJECT NO.

220239


DISCIPLINE

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PROJECT NO.

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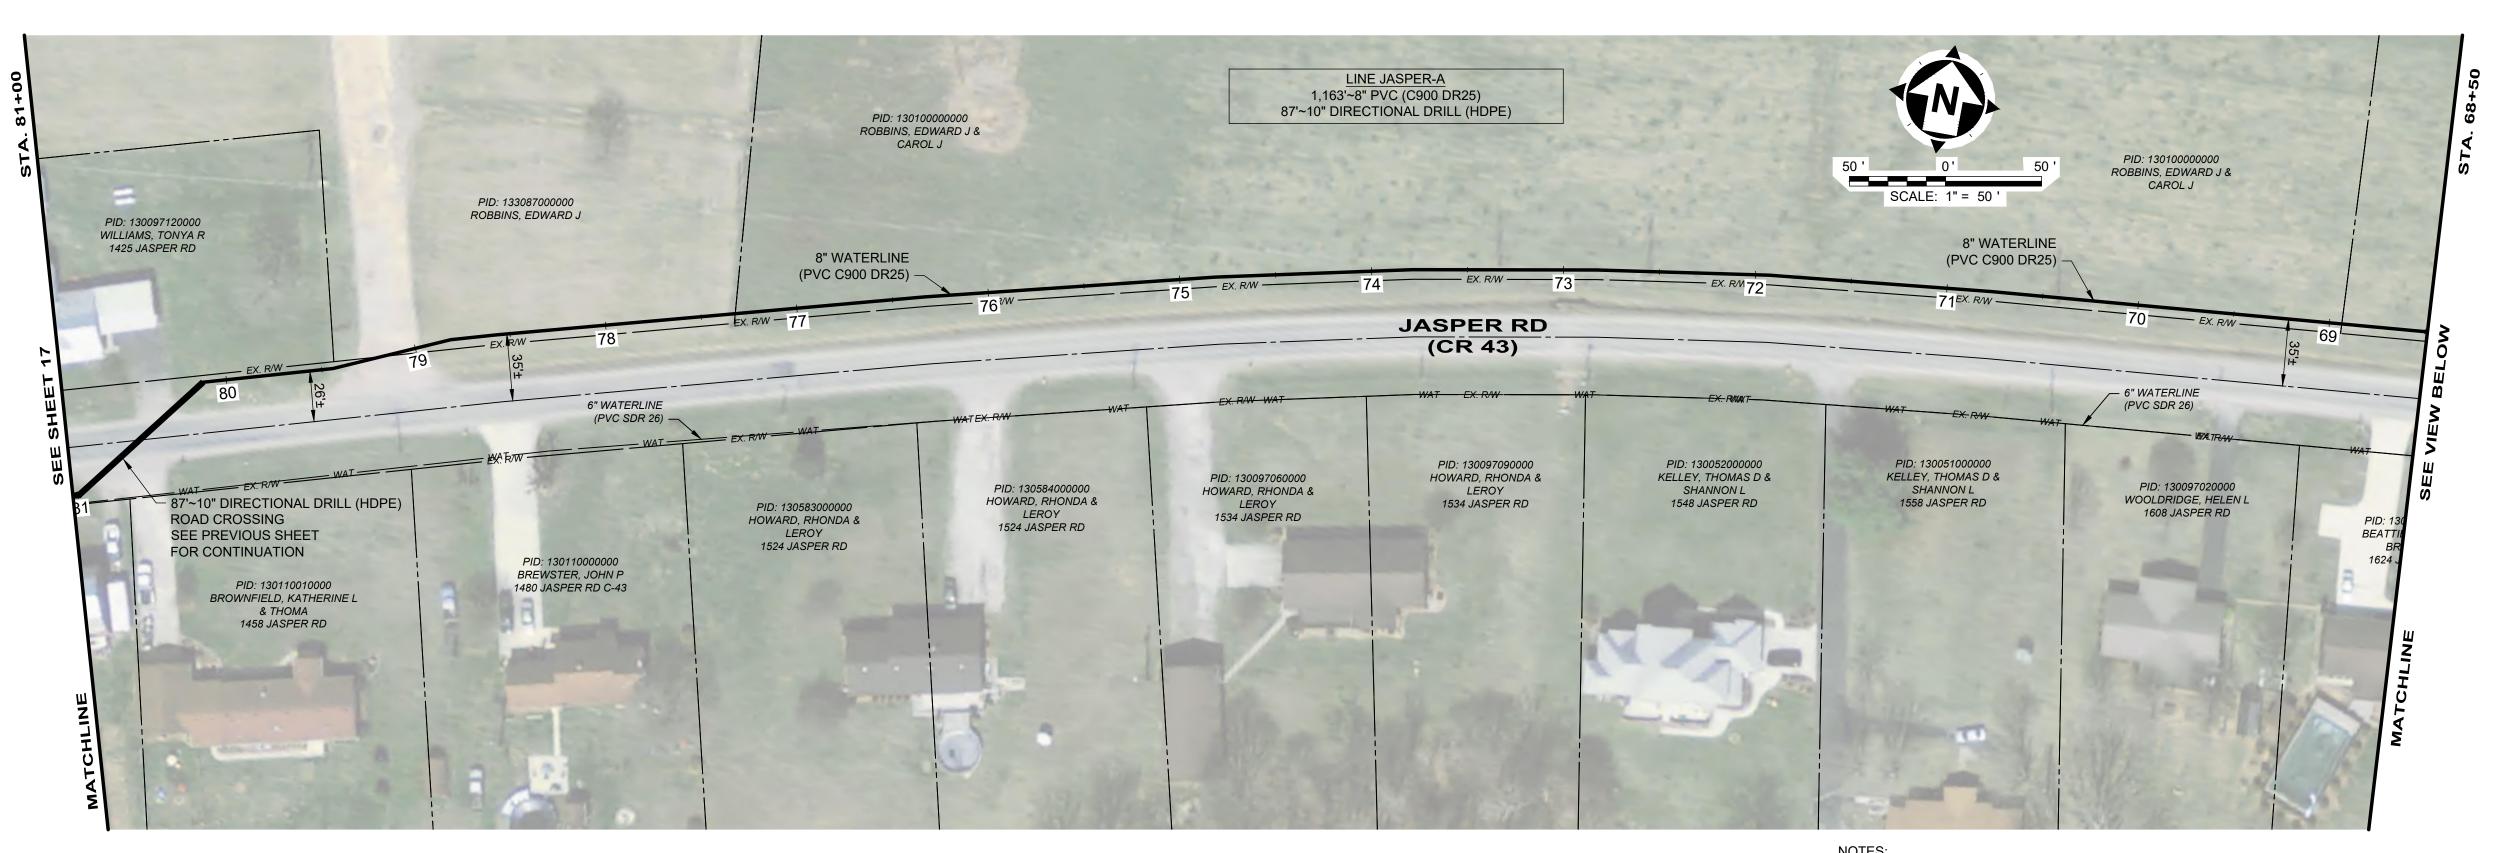
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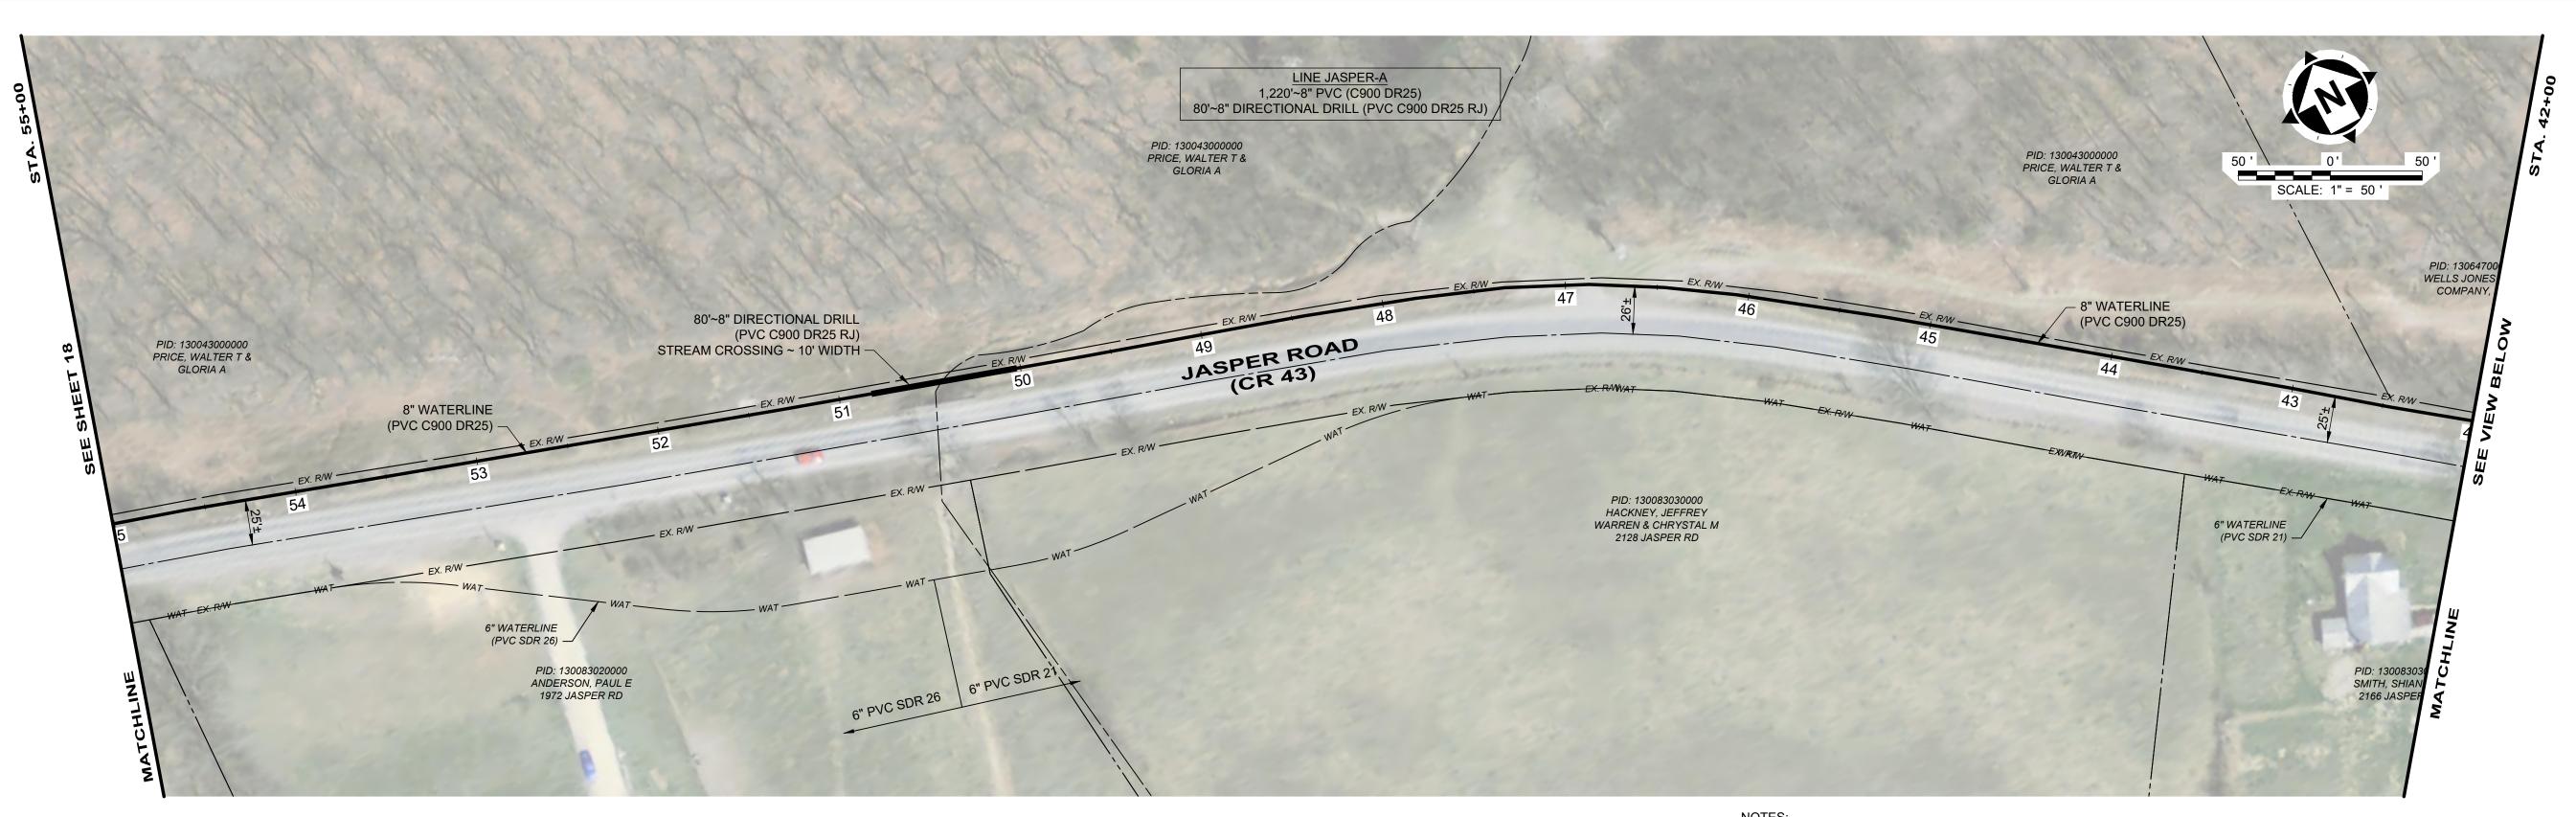


- 1. WATERLINE TO BE INSTALLED IN PUBLIC R/W: LINE JASPER-A: STA. 81+00 TO STA. 79+18
- LINE JASPER-A: STA. 66+22 TO STA. 55+00

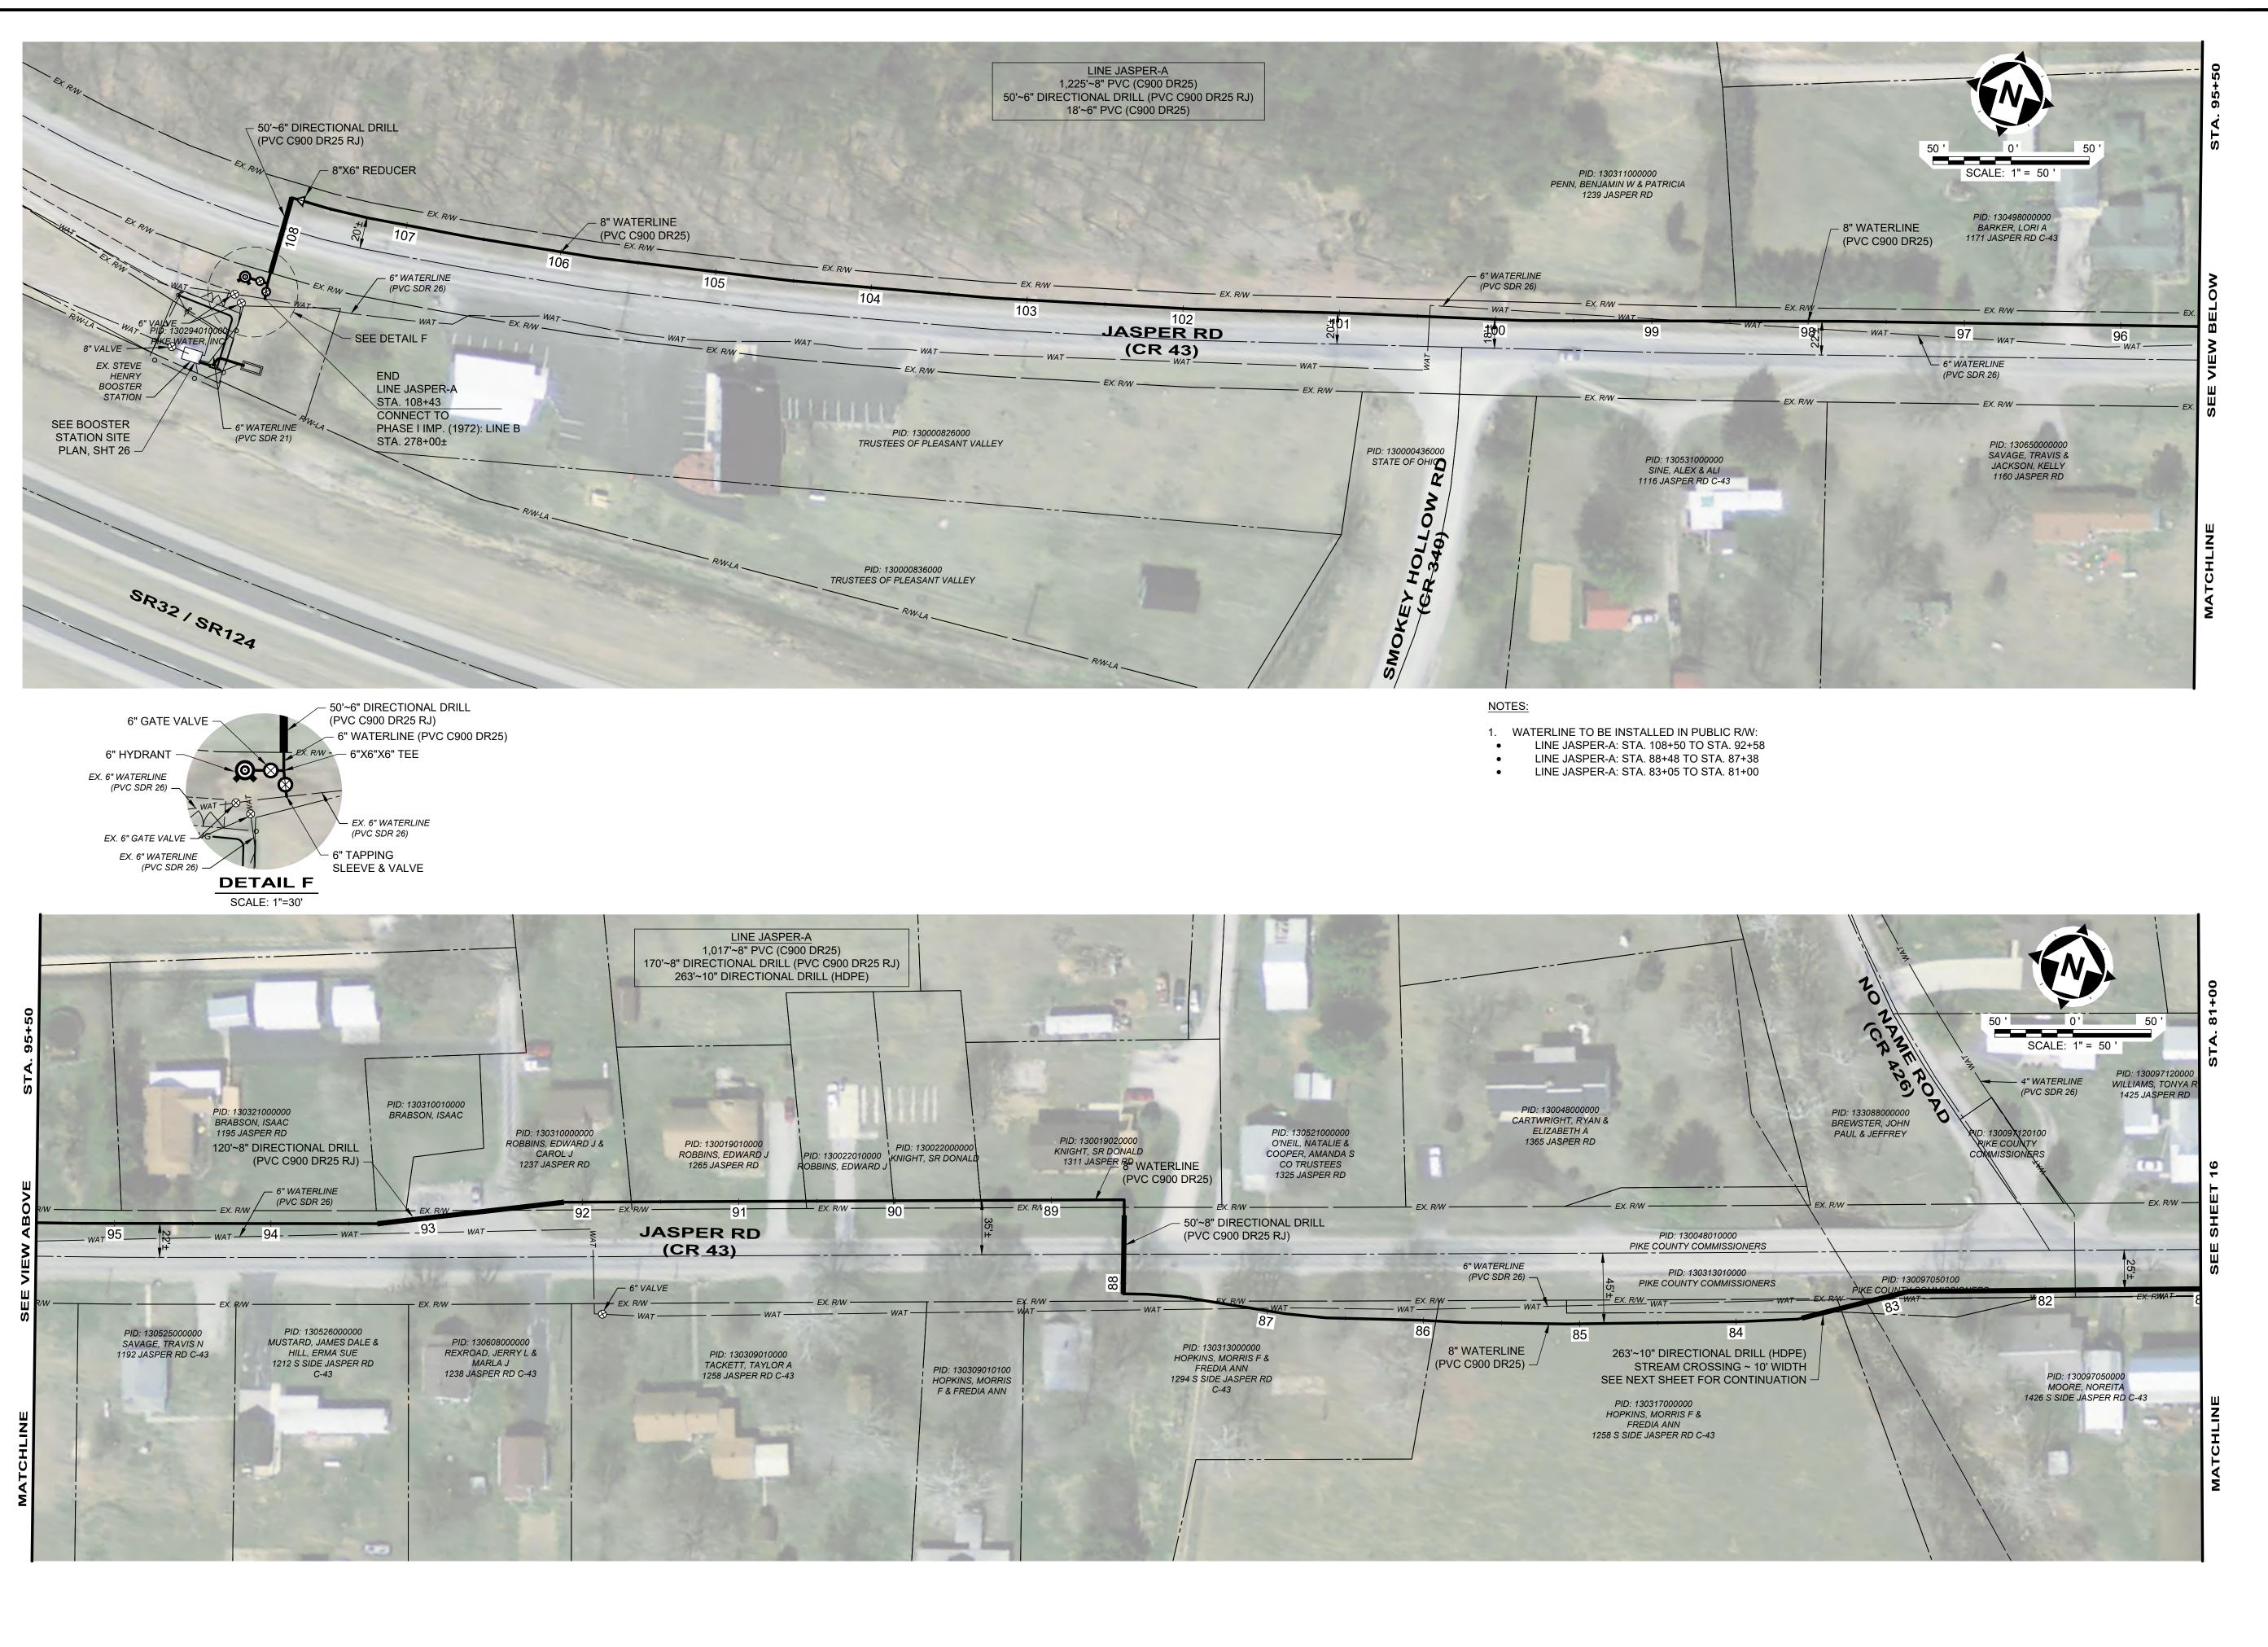

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•engineers architects	

JECT NO. 0239	202	IMPROVEMENTS 1/6/2025 1	SR 124 WATERLINE ISSUED FOR: BIDDING NO	REVISED	BIDDING 2/6/2025 AS SHOWN RAB RAB	ISSUED FOR: ISSUE DATE: SCALE: DESIGNED BY: DRAWN BY:
CHECKED BY: BRA	MATERLINE - PHASE II  DESIGNED BY:  DRAWN BY:	SCALE: AS SHOOM TY, OH -  BESIGNED BY:  WATERLINE - PHASE II  DRAWN BY:	ISSUE DATE: 2/6/2025 1		BRA	CHECKED BY:



- WATERLINE TO BE INSTALLED IN PUBLIC R/W:LINE JASPER-A: STA. 55+00 TO STA. 29+00
- LINE JASPER-A 1,300'~8" PVC (C900 DR25) PID: 1300440000000 ROBBINS, ARTHUR SCALE: 1" = 50 ' PID: 130647000000 WELLS JONES LAND COMPANY, LLC PID: 130185000000 FORD, MIKE 2321 JASPER RD PID: 130691000000 HENRY, CHARLES W SR & WILLA C PID: 130647000000 WELLS JONES LAND COMPANY, LLC 8" WATERLINE - 8" WATERLINE (PVC C900 DR25) (PVC C900 DR25) -PID: 130050010000 HENRY, CHARLES W SR & WILLA C 8" GATE VALVE JASPER ROAD (CR 43) ← 6" WATERLINE (PVC SDR 21) 6" WATERLINE (PVC SDR 21) PID: 130442000000 BREWSTER, GILBERT & BETTY PID: 130442000000 BREWSTER, GILBERT & BETTY PID: 130789000000 HARRIS, KAY STARR 2202 JASPER RD PID: 130789020000 STIFF, MARK & DOROTHY PID: 130105000000 STIFF, MARK & DOROTHY 2292 JASPER RD PID: 130789010000 STIFF, MARK & DOROTHY

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C-16



SEE DETAIL H -

STA. 10+00

LINE B

CONNECT TO

STA. 180+93±

PID: 130858000000 BREWSTER, GILBERT & BETTY

DALTON, DANNY

2717 JASPER RD

8" WATERLINE

(PVC C900 DR25) -

PID: 130008000000

KEETON LARISSA 2739 JASPER RD


ARNETT, ADAM

2665 JASPER RD


6" WATERLINE (PVC SDR 21) - PID: 1

BOYD, EARL

PID: 130109000000 BREWSTER, PAUL D & SANDY L 2652 & 2676 JASPER RD

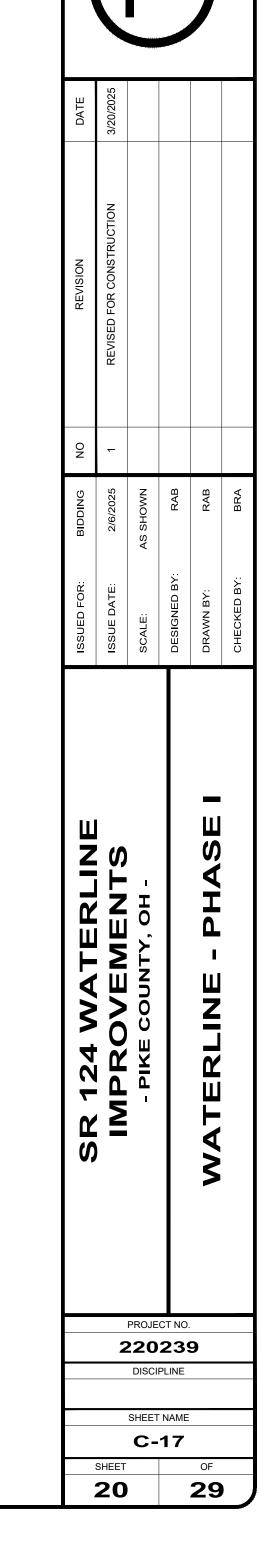


SCALE: 1" = 50 '

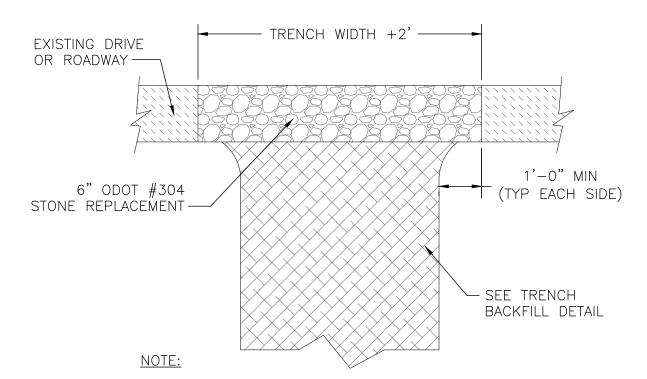


1. EXISTING SUBBASE MATERIAL SHALL BE RE-USED UNLESS OTHERWISE DIRECTED BY THE ENGINEER.

## GRAVEL DRIVE REPLACEMENT NOT TO SCALE

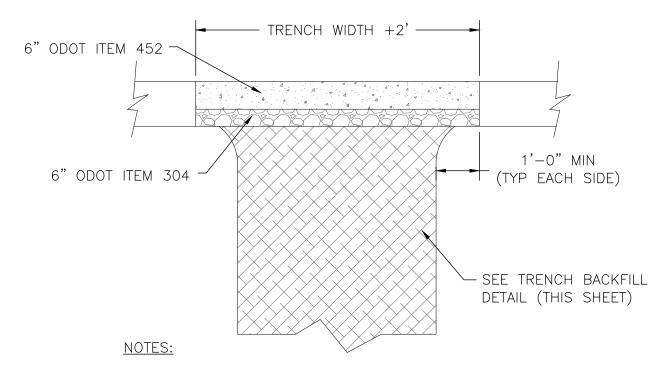

- 1. EXISTING SUBBASE MATERIAL SHALL BE RE—USED UNLESS OTHERWISE DIRECTED BY THE ENGINEER.
- 2. EXISTING PAVEMENT EDGES SHALL BE NEATLY SAWCUT
- 3. APPLY (2) COATS OF ANTI-SPALLING COMPOUND 3 WEEKS AFTER CONCRETE IS PLACED. ALLOW DRYING TIME BETWEEN COATS.
- 4. IN NO CASE SHALL THICKNESS OF CONCRETE DRIVE REPLACEMENT BE LESS THAN EXISTING DRIVEWAY THICKNESS.

# CONCRETE DRIVE REPLACEMENT NOT TO SCALE

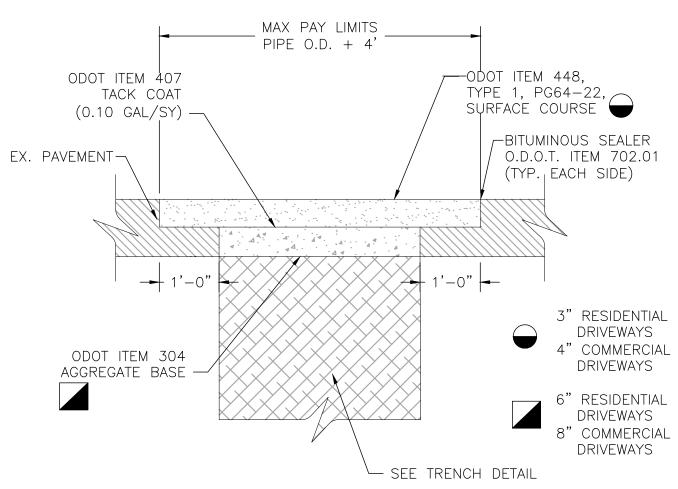


#### NOTES:

- 1. EXISTING DRIVEWAY PAVEMENT SHALL BE NEATLY SAW CUT. TRENCH EDGES DAMAGED BY EXCAVATION ACTIVITIES SHALL BE EXTENDED BACK TO ALLOW FOR NEAT EDGE. MAXIMUM PAY LIMITS FOR ASPHALT RESTORATION SHALL BE AS SHOWN.
- RESTORATION SHALL BE AS SHOWN.

  2. IN NO CASE SHALL THICKNESS OF DRIVEWAY REPLACEMENT BE LESS THAN EXISTING DRIVEWAY
- THICKNESS.

  3. ASPHALT SHALL BE PLACED IN LIFT THICKNESSES IN ACCORDANCE WITH ODOT REQUIREMENT.

## ASPHALT DRIVE REPLACEMENT NOT TO SCALE

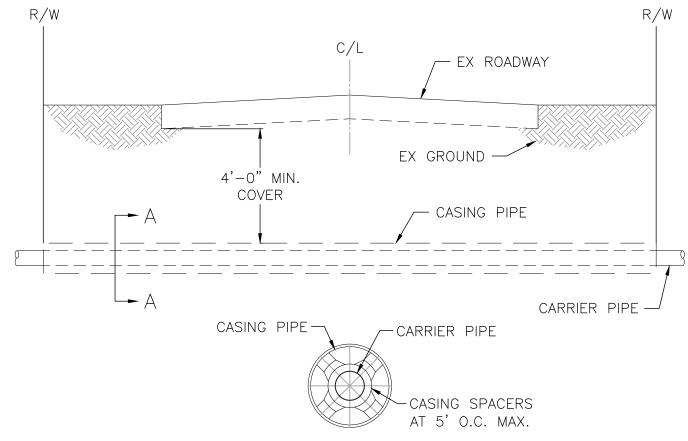


#### SECTION A-A

CASING PIPE SCHEDULE								
CARRIER PIPE DIA.	2"	3"	4"	6"	8"	10"	12"	14"
CASING PIPE DIA.	5"	6"	8"	14"	16"	18"	20"	24"

#### NOTES:

- 1. CARRIER PIPE INSTALLED WITHIN & 5'-0" OF EITHER SIDE OF ROAD BORE CASING SHALL BE RESTRAINED JOINT PVC OR D.I. WITH FIELD LOCK GASKETS IN ACCORDANCE WITH THE SIZE & CLASS SPECIFIED. NON-RESTRAINED PUSH-ON JOINT PIPE SHALL NOT BE USED.
- 2. CASING PIPE SHALL BE STEEL PIPE IN ACCORDANCE WITH ODOT CMS ITEM 748.06, UNLESS AN ALTERNATE MATERIAL HAS BEEN AUTHORIZED BY THE GOVERNING HIGHWAY AUTHORITY.
- 3. CASING ENDS SHALL BE SEALED. UTILIZING COMMERCIALLY MANUFACTURED SEALS AS OUTLINED IN THE SPECIFICATIONS.
- 4. CARRIER PIPE INSTALLATION SHALL INCORPORATE ONE INSULATED NO. 12 GAUGE, SOLID COPPER WIRE INSTALLED WITH THE PIPE FOR LOCATING PURPOSES. REFER TO SPECIFICATIONS FOR ADDITIONAL REQUIREMENTS.

# CASING PIPE FOR ROADWAY BORE NOT TO SCALE

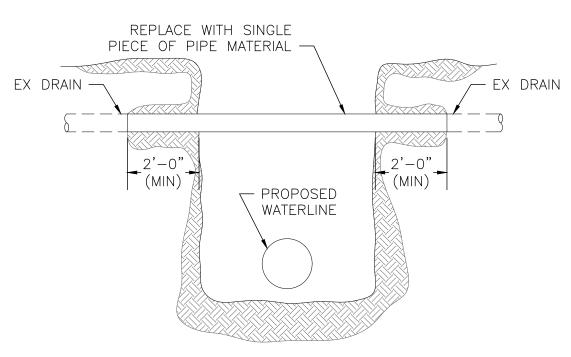


#### NOTES:

- 1. INSIDE DIAMETER OF REPLACEMENT PIPE SHALL BE EQUAL TO OR GREATER THAN INSIDE DIAMETER OF EXISTING PIPE.
- 2. REPLACEMENT MATERIAL USED SHALL BE EQUAL TO OR BETTER THAN THE EXISTING MATERIAL AS DIRECTED BY THE ENGINEER OR HIS REPRESENTATIVE.
- 3. PROVIDE RUBBER FLEXIBLE PIPE COUPLING WHERE EXISTING TILE OR UNDERDRAIN HAS WATERTIGHT JOINTS. PROVIDE 30# FELT OR CONCRETE MORTAR OVER THE UPPER HALF OF THE JOINT WHERE OPEN JOINTS ARE ENCOUNTERED.
- 4. BACKFILL BETWEEN WATERLINE AND REPLACEMENT TILE OR UNDERDRAIN SHALL BE COMPACTED GRANULAR.
- 5. MINIMUM ROAD AND CURB UNDERDRAIN REPLACEMENT MATERIAL SHALL BE:
- PERFORATED CONCRETE: ODOT ITEM 706.06
- CONCRETE DRAIN TILE: ODOT ITEM 706.07VITRIFIED CLAY: ODOT ITEM 706.08
- PERFORATED PVC: ODOT ITEM 707.41


  PROVIDENCE PROVIDENCE TO THE PROPERTY OF THE PROPERTY OF THE PROPERTY OF THE PROVIDENCE TO THE PROPERTY OF THE
- POLYETHYLENE DRAINAGE TUBING (PERFORATED): ODOT ITEM 707.31
- 6. MINIMUM DRAIN TILE REPLACEMENT MATERIAL SHALL BE:
- PVC: ASTM-D 2241, SDR 26
- DUCTILE IRON: AWWA C151, PC 350
- STEEL PIPE: ASTM—A 139 GRADE BCONCRETE: ODOT ITEM 706.02

# DRAIN TILE AND UNDERDRAIN REPLACEMENT NOT TO SCALE

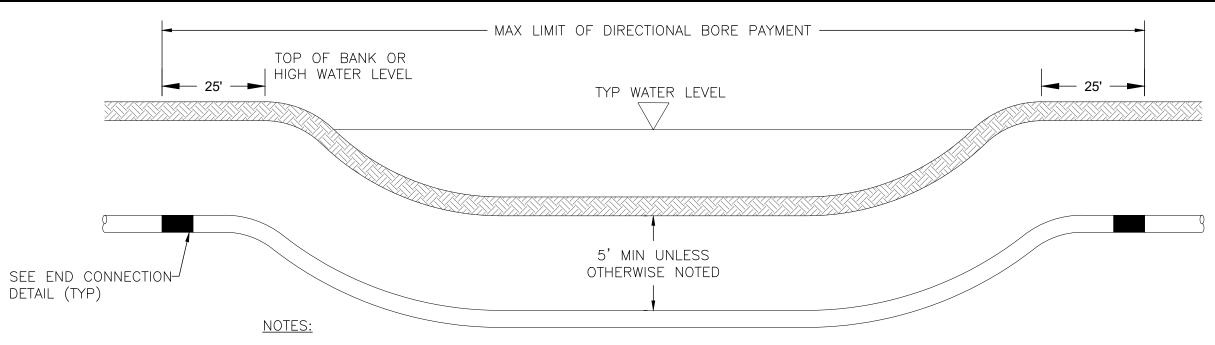

- 1. WHERE DIRECTIONAL BORE INCORPORATES RESTRAINED JOINT PVC PIPE, OMIT PE/MJ ADAPTER.
- 2. DIRECTIONAL BORE SHALL INCORPORATE TWO INSULATED NO 12 GAUGE, SOLID, COPPER WIRES INSTALLED WITH THE PIPE FOR LOCATING PURPOSES. REFER TO SPECIFICATIONS FOR ADDITIONAL REQUIREMENTS.

## HORIZONTAL DIRECTIONAL DRILLING @ STREAM CROSSING

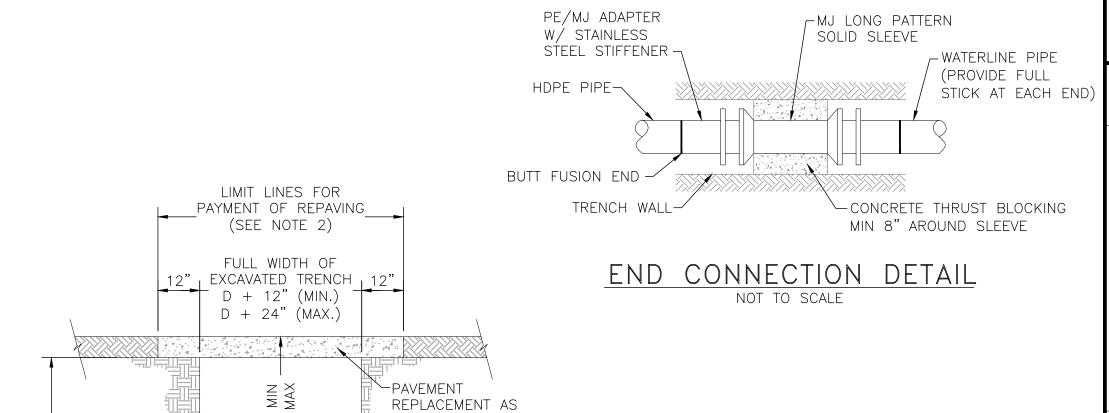

1. PAVED AREAS INCLUDE:

• ANY ROAD (ASPHALT, CONCRETE, GRAVEL)

• ANY DRIVEWAY

• ANY PARKING LOT

- SUBGRADE

DETAILED

-MARKING TAPE


-12 GAUGE WIRE

ANY PARKING LOT
ANY OTHER AREA SUBJECT TO TRAFFIC
2. IN AREAS WHERE DISTANCE BETWEEN CENTERLINE OF

PIPE AND FACE OF CURB/GUTTER EXCEEDS "D"+2',
PAVEMENT RESTORATION QUANTITIES SHALL BE
COORDINATED WITH THE ENGINEER TO ALLOW SURFACE
REPAIR TO EXTEND TO THE FACE OF CURB/GUTTER.

# TRENCH DETAIL FOR WATERLINE INSTALLED UNDER OR WITHIN 5' OF PAVED AREAS

TYPE A COMPACTED GRANULAR BACKFILL

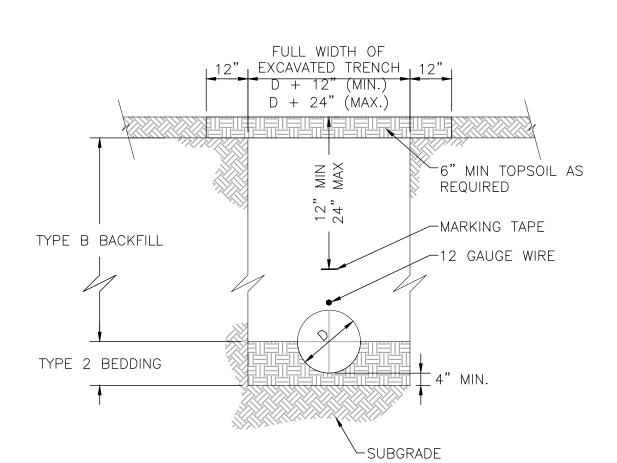

# TRENCH DETAIL FOR WATERLINE INSTALLED IN NON-PAVED AREAS


#### BACKFILL:

- 1. TYPE A, SHALL BE COMPACTED GRANULAR MATERIAL AS SPECIFIED IN ODOT CMS ITEM 304.
- 2. TYPE B SHALL BE NATURAL SOIL FREE FROM STONES LARGER THAN 2 INCHES ACROSS THEIR GREATEST DIMENSION, TOPSOIL, VEGETATION, DEBRIS, RUBBISH OR FROZEN MATERIAL.
- 3. TYPE C SHALL BE LOW STRENGTH MORTAR BACKFILL, TYPE 1 AS SPECIFIED IN ODOT CMS ITEM 613.

#### BEDDING:

- 1. TYPE 1-GRANULAR MATERIAL No. 57,6,8,67,68 OR 7 PER ODOT CMS TABLE 703.01-1.
- 2. TYPE 2-NATIVE SOIL FREE FROM STONES LARGER THAN 2 INCHES ACROSS THEIR GREATEST DIMENSIONS, TOP SOIL, VEGETATION, DEBRIS OR FROZEN MATERIAL.
- 3. TYPE 3-CONCRETE BEDDING, CLASS QC1 CONCRETE PER ODOT CMS 499.

PROJECT NO. 220239 DISCIPLINE SHEET NAME SD-01 SHEET 29 21

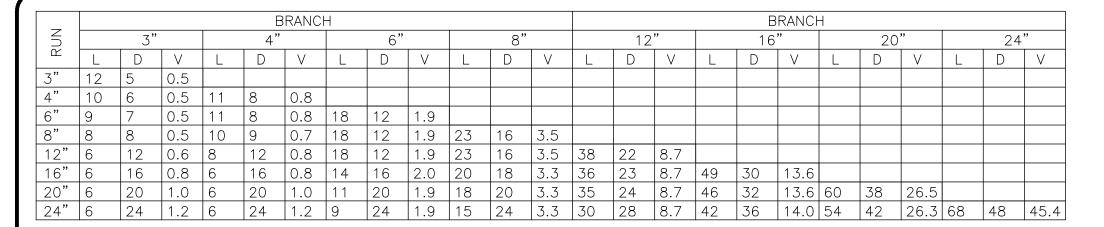


1. CONCRETE FOR BACKING SHALL BE ODOT CLASS "QC1".

5. PROVIDE CLEARANCE FOR REMOVAL OF BOLTS.


2. BACKING SHALL BE DESIGNED FOR 3000 PSF SOIL BEARING.

4. CONCRETE SHALL BE PLACED AGAINST UNDISTURBED EARTH.

NOT HAVE DIRECT CONTACT WITH TEE AND/OR FITTINGS.

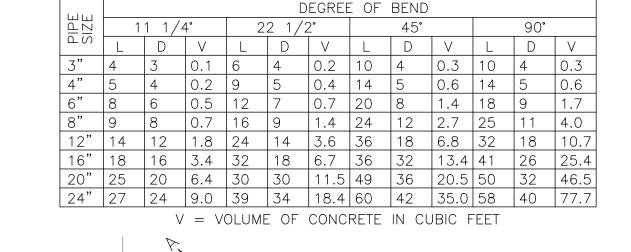



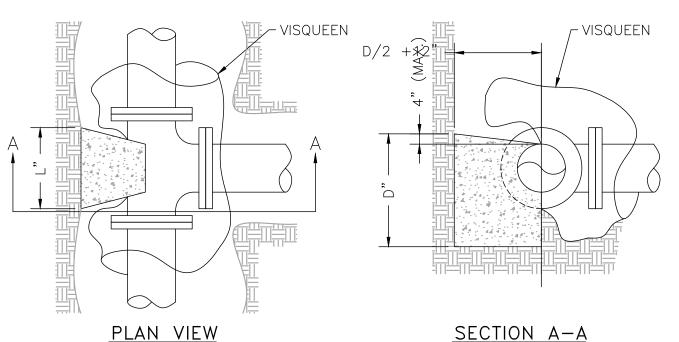

3. REINFORCING STEEL SHALL BE USED AS DIRECTED BY THE CONTRACT ADMINISTRATOR.

6. VISQUEEN SHALL BE PLACED IN A MANNER SUCH THAT CONCRETE BLOCKING DOES

BACKING FOR TEES

NOT TO SCALE

LIFTING RING -

HARDWOOD OR

STOP -


VISQUEEN -

1/2" STEEL PLATE -


3/4" CORPORATION




- NOTES:
- BEARING. 3. REINFORCING STEEL SHALL BE USED AS DIRECTED BY
- 4. CONCRETE SHALL BE PLACED AGAINST UNDISTURBED

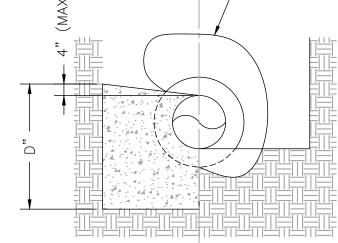

BACKING FOR BENDS

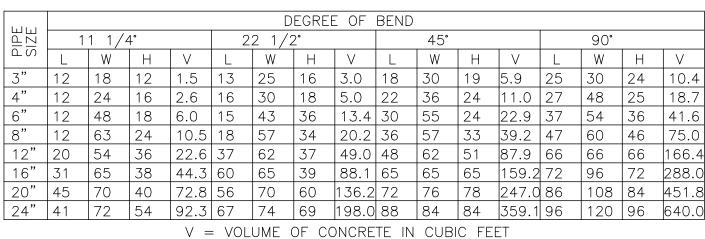


- CONCRETE FOR BACKING SHALL BE ODOT CLASS "QC1". BACKING SHALL BE DESIGNED FOR 3000 PSF SOIL BEARING.
- REINFORCING STEEL SHALL BE USED AS SHOWN. CONCRETE SHALL BE PLACED AGAINST UNDISTURBED EARTH. 5. VISQUEEN SHALL BE PLACED IN A MANNER SUCH THAT CONCRETE BLOCKING DOES NOT HAVE DIRECT CONTACT WITH FITTINGS.

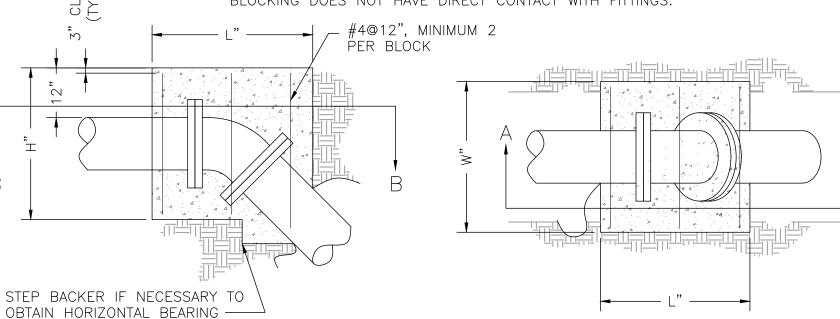

SECTION A-A

BACKING FOR VERTICAL BENDS NOT TO SCALE

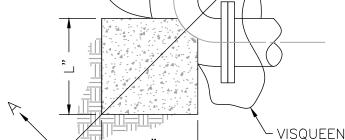

VISQUEEN


BENDS LESS THAN 90°

- 1. CONCRETE FOR BACKING SHALL BE ODOT CLASS "QC1". 2. BACKING SHALL BE DESIGNED FOR 3000 PSF SOIL
- THE CONTRACT ADMINISTRATOR.
- 5. PROVIDE CLEARANCE FOR REMOVAL OF BOLTS.
- 6. VISQUEEN SHALL BE PLACED IN A MANNER SUCH THAT CONCRETE BLOCKING DOES NOT HAVE DIRECT CONTACT WITH TEE AND OR FITTINGS.

# PLAN VIEWS - VISQUEEN

SECTION A-A

SECTION B-B

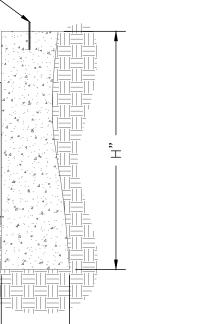

PLAN VIEW

2' (MIN.)

#### NOTES:

VALVE


- CONCRETE FOR BACKING SHALL BE ODOT CLASS "QC1".
   BACKING SHALL BE DESIGNED FOR 3000 PSF SOIL
- 3. CONCRETE SHALL BE PLACED AGAINST UNDISTURBED EARTH.

NOTES:

- MECHANICAL JOINT

RESTRAINT SYSTEM

- 4. PROVIDE CLEARANCE FOR REMOVAL OF BOLTS. 5. VISQUEEN SHALL BE PLACED IN A MANNER SUCH THAT CONCRETE BLOCKING DOES NOT HAVE DIRECT CONTACT WITH TEE AND OR FITTINGS.
- 6. END OF PIPE SHALL BE CAPPED OR PLUGGED. 7. STEEL PLATE SHALL BE GREASED WHERE IN CONTACT WITH CONCRETE BACKING.
- , 8. PLUG POLES SHALL BE INSTALLED AT ALL END-OF-LINE STUBS AT THE THRUST BLOCK.

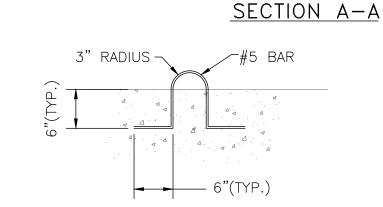


#### LIFTING RING DETAIL

SIZE OF PIPE	Ι	В	L (PVC)	L (DIP)	V
			( , , , ,	(2)	•
6"	8	1	20	18	2.52
8"	12	1	20	18	4.00
12"	23	3	20	18	8.64
16"	37	3	20	18	15.39
	OF PIPE 6" 8" 12"	OF PIPE H 6" 8 8" 12 12" 23	OF PIPE     H     B       6"     8     1       8"     12     1       12"     23     3	OF PIPE     H     B     L (PVC)       6"     8     1     20       8"     12     1     20       12"     23     3     20	OF PIPE     H     B     L (PVC)     L (DIP)       6"     8     1     20     18       8"     12     1     20     18       12"     23     3     20     18

V = VOLUME OF CONCRETE IN CUBIC FEET.

THRUST BLOCK NOT TO SCALE

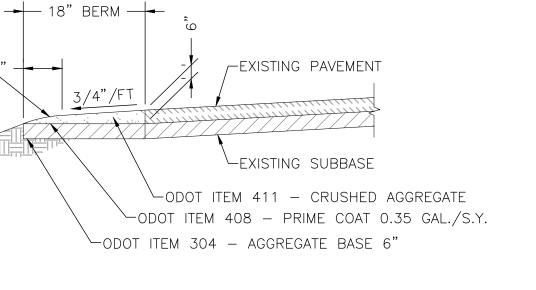


#### NOTES:

LAST 6" TO

BE ROUNDED -

- 1. BERM REPLACEMENT SHALL BE REQUIRED WHERE PROPOSED WATERLINE IS LOCATED WITHIN 3' OF EXISTING EDGE OF PAVEMENT.
- 2. COST FOR THE RESTORATION OF BERM SHALL BE INCLUDED IN THE COST BID FOR INSTALLATION OF THE PIPE.

TYPICAL BERM REPLACEMENT NOT TO SCALE

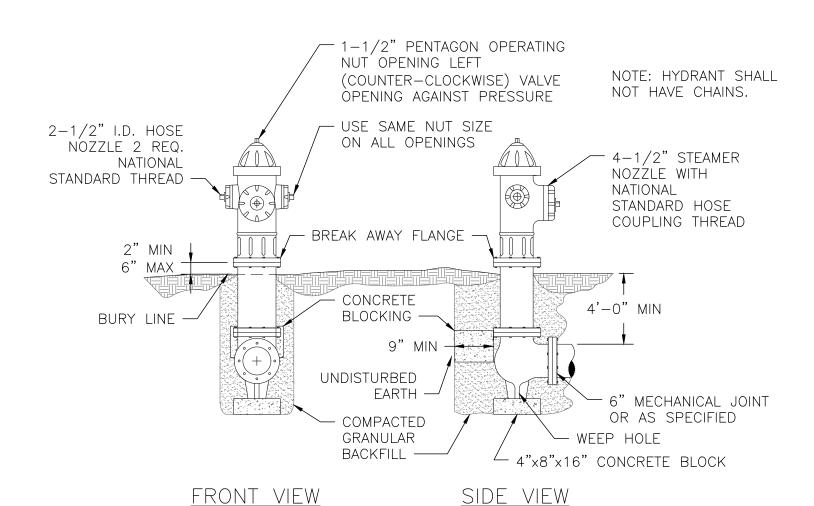

CONCRETE BACKING -CONCRETE VALVE SUPPORT 6" M.J. (MIN) GATE VALVE 6"x13" SWIVEL & SWIVEL ADAPTER HYDRANT CONCRETE BACKING

<u>Plan view</u>

AGAINST UNDISTURBED

BY CONCRETE PROVIDED FOR BLOCKING.

EARTH

NOTES:

- 1. BACKFILL SHALL BE GRANULAR MATERIAL CONFORMING TO (ODOT #57 STONE). ITEM 703.11 TYPE 2, GRADE A, OR APPROVED SUITABLE EXCAVATED MATERIAL POWER TAMPED IN LAYERS NOT EXCEEDING 4" IN THICKNESS, LOOSE MEASUREMENT. BACKFILL SHALL EXTEND FROM THE BOTTOM OF THE PIT OR TRENCH TO 6" BELOW THE EXISTING OR PROPOSED SURFACE. COST OF FURNISHING AND PLACING BACKFILL SHALL BE INCLUDED IN THE PRICE BID FOR EACH HYDRANT.
- 2. ALL HYDRANTS SHALL BE INSTALLED WITH HARDWOOD OR CONCRETE BLOCKING AGAINST UNDISTURBED EARTH.
- 3. DRAIN ROCK AROUND AND ABOVE HYDRANT SHALL BE 2" OR LARGER. CLOTH FILTER MATERIAL SHALL BE PLACED BETWEEN DRAIN AND FILL. 4. CONNECTIONS SHALL BE WRAPPED IN VISQUEEN TO PROTECT BOLTS FROM ENCASEMENT


TYPICAL 6" HYDRANT SETTING - TYPE A



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Ш	1			S	
SR 124 WATERLINE		PROJE			
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SHEET NAME **SD-02** 

**22** 

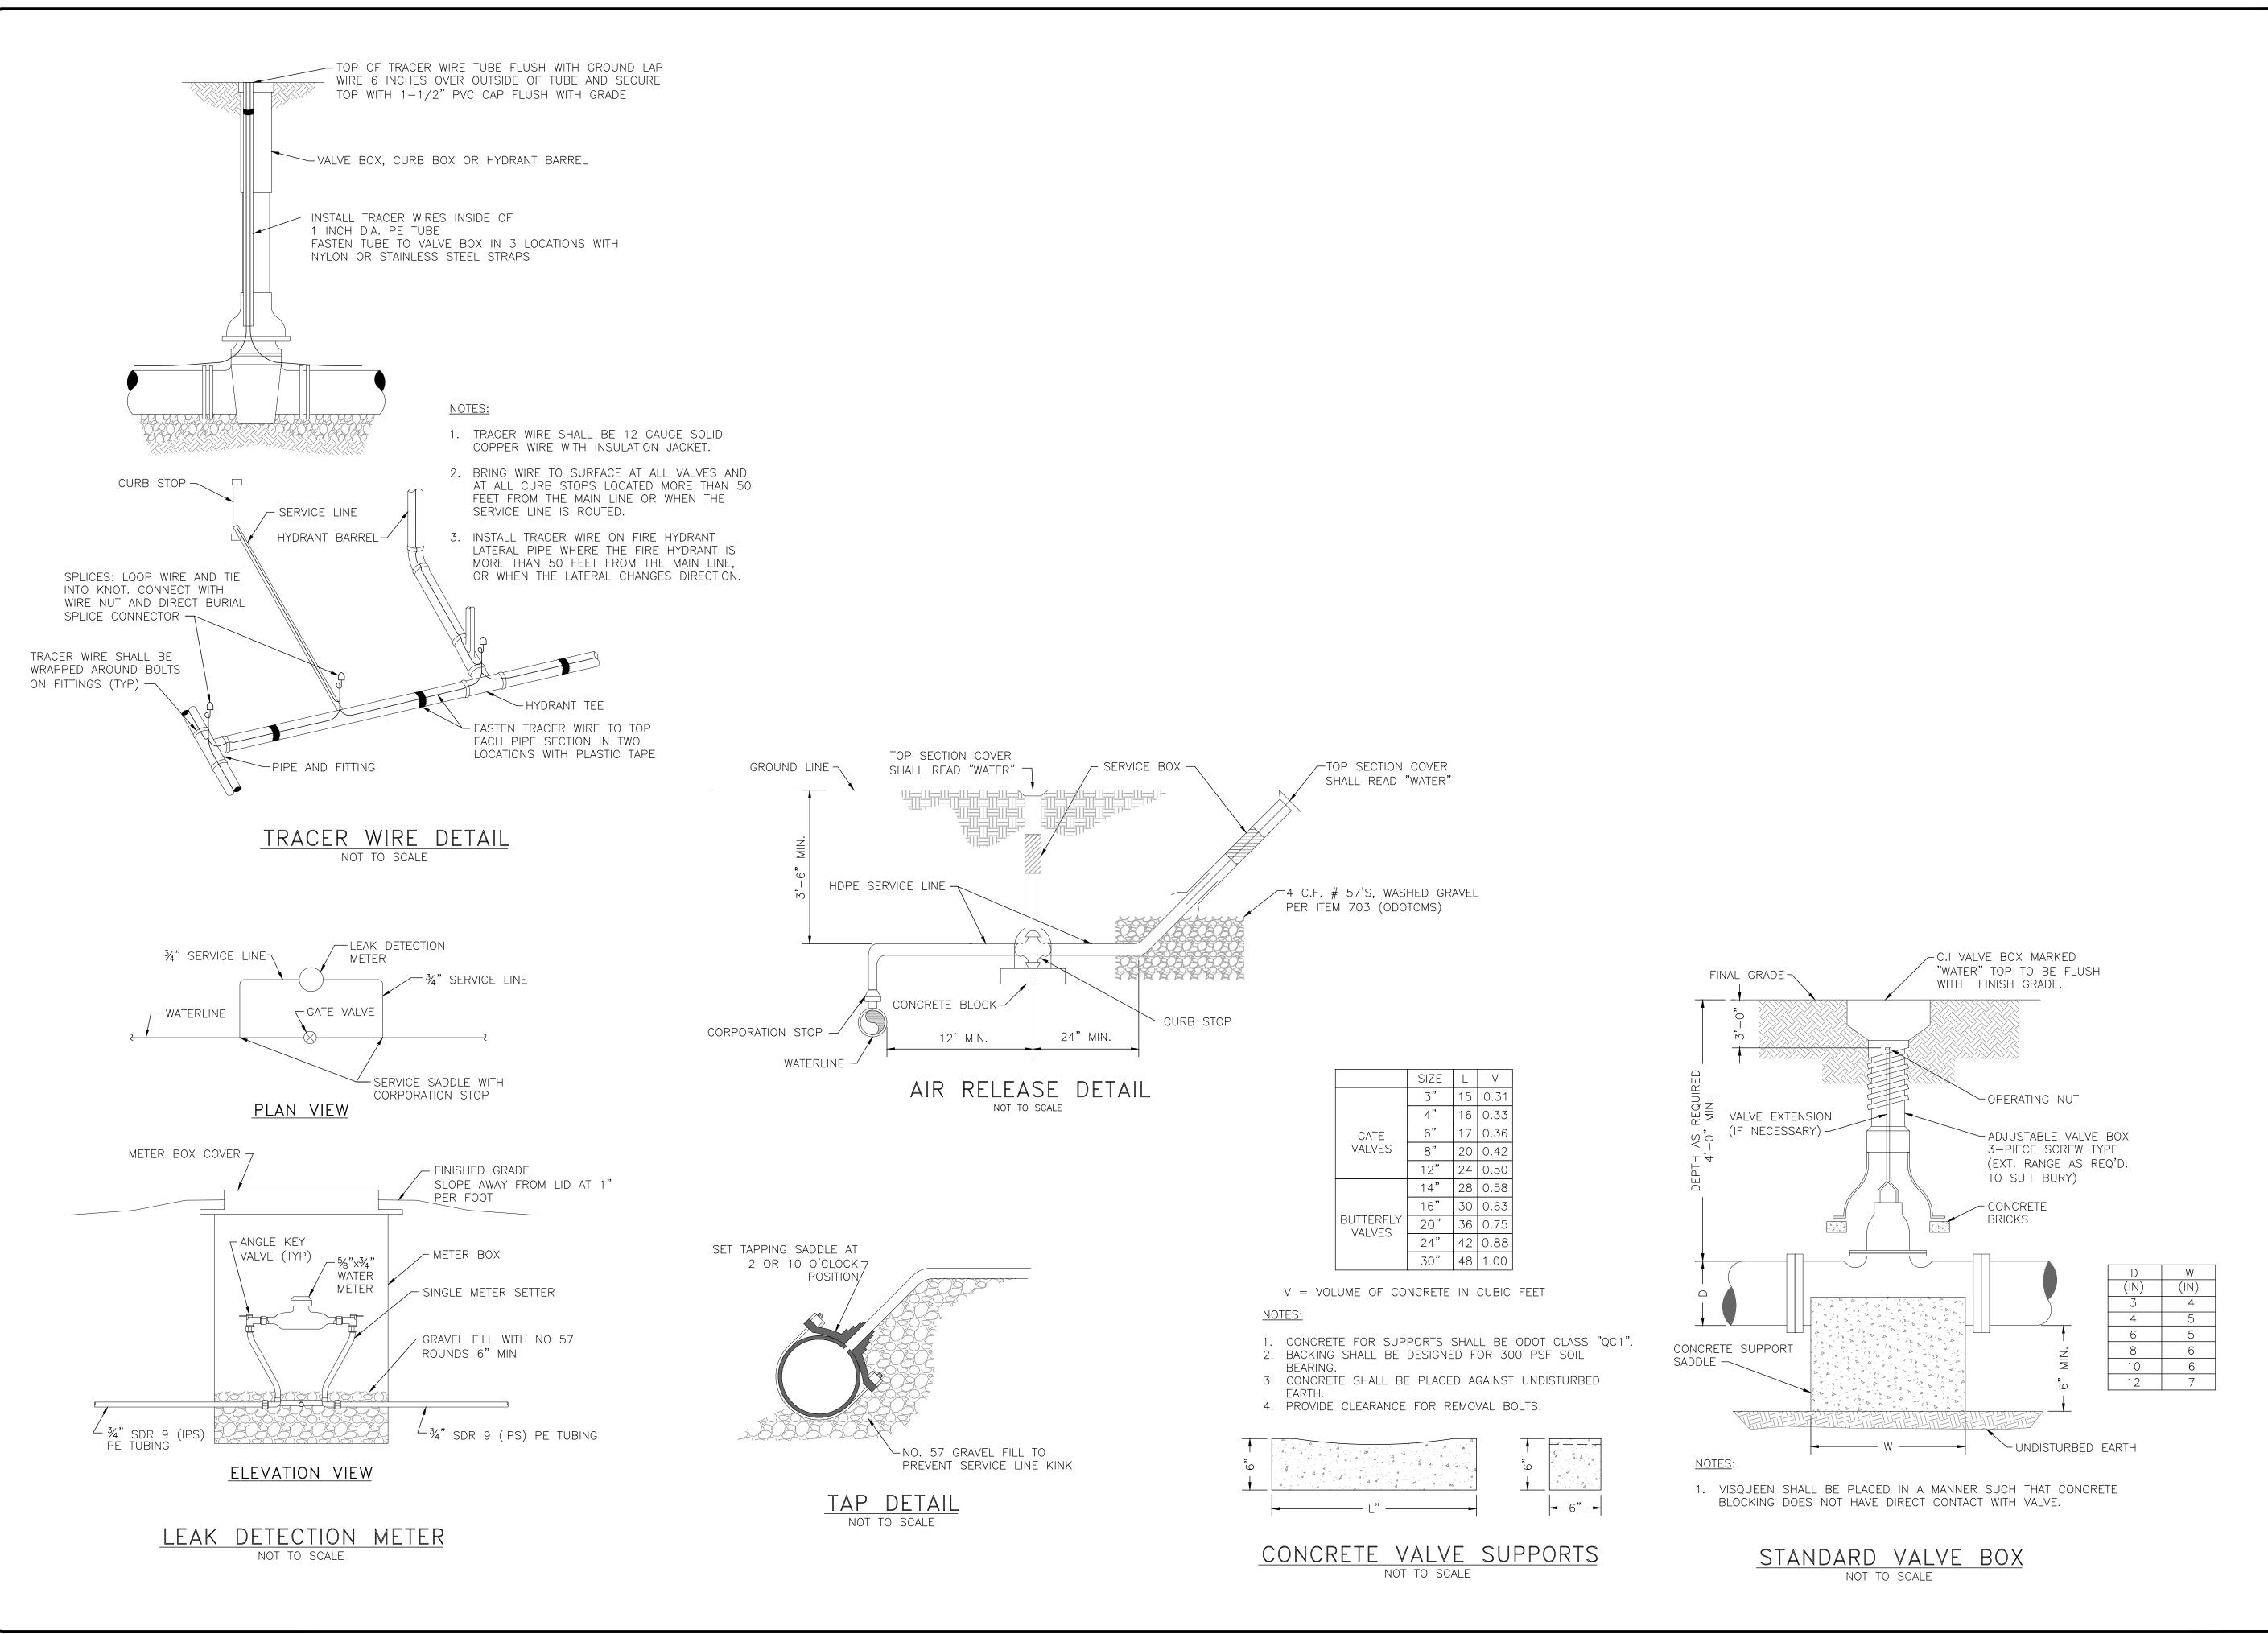

PROJECT NO. **220239** 

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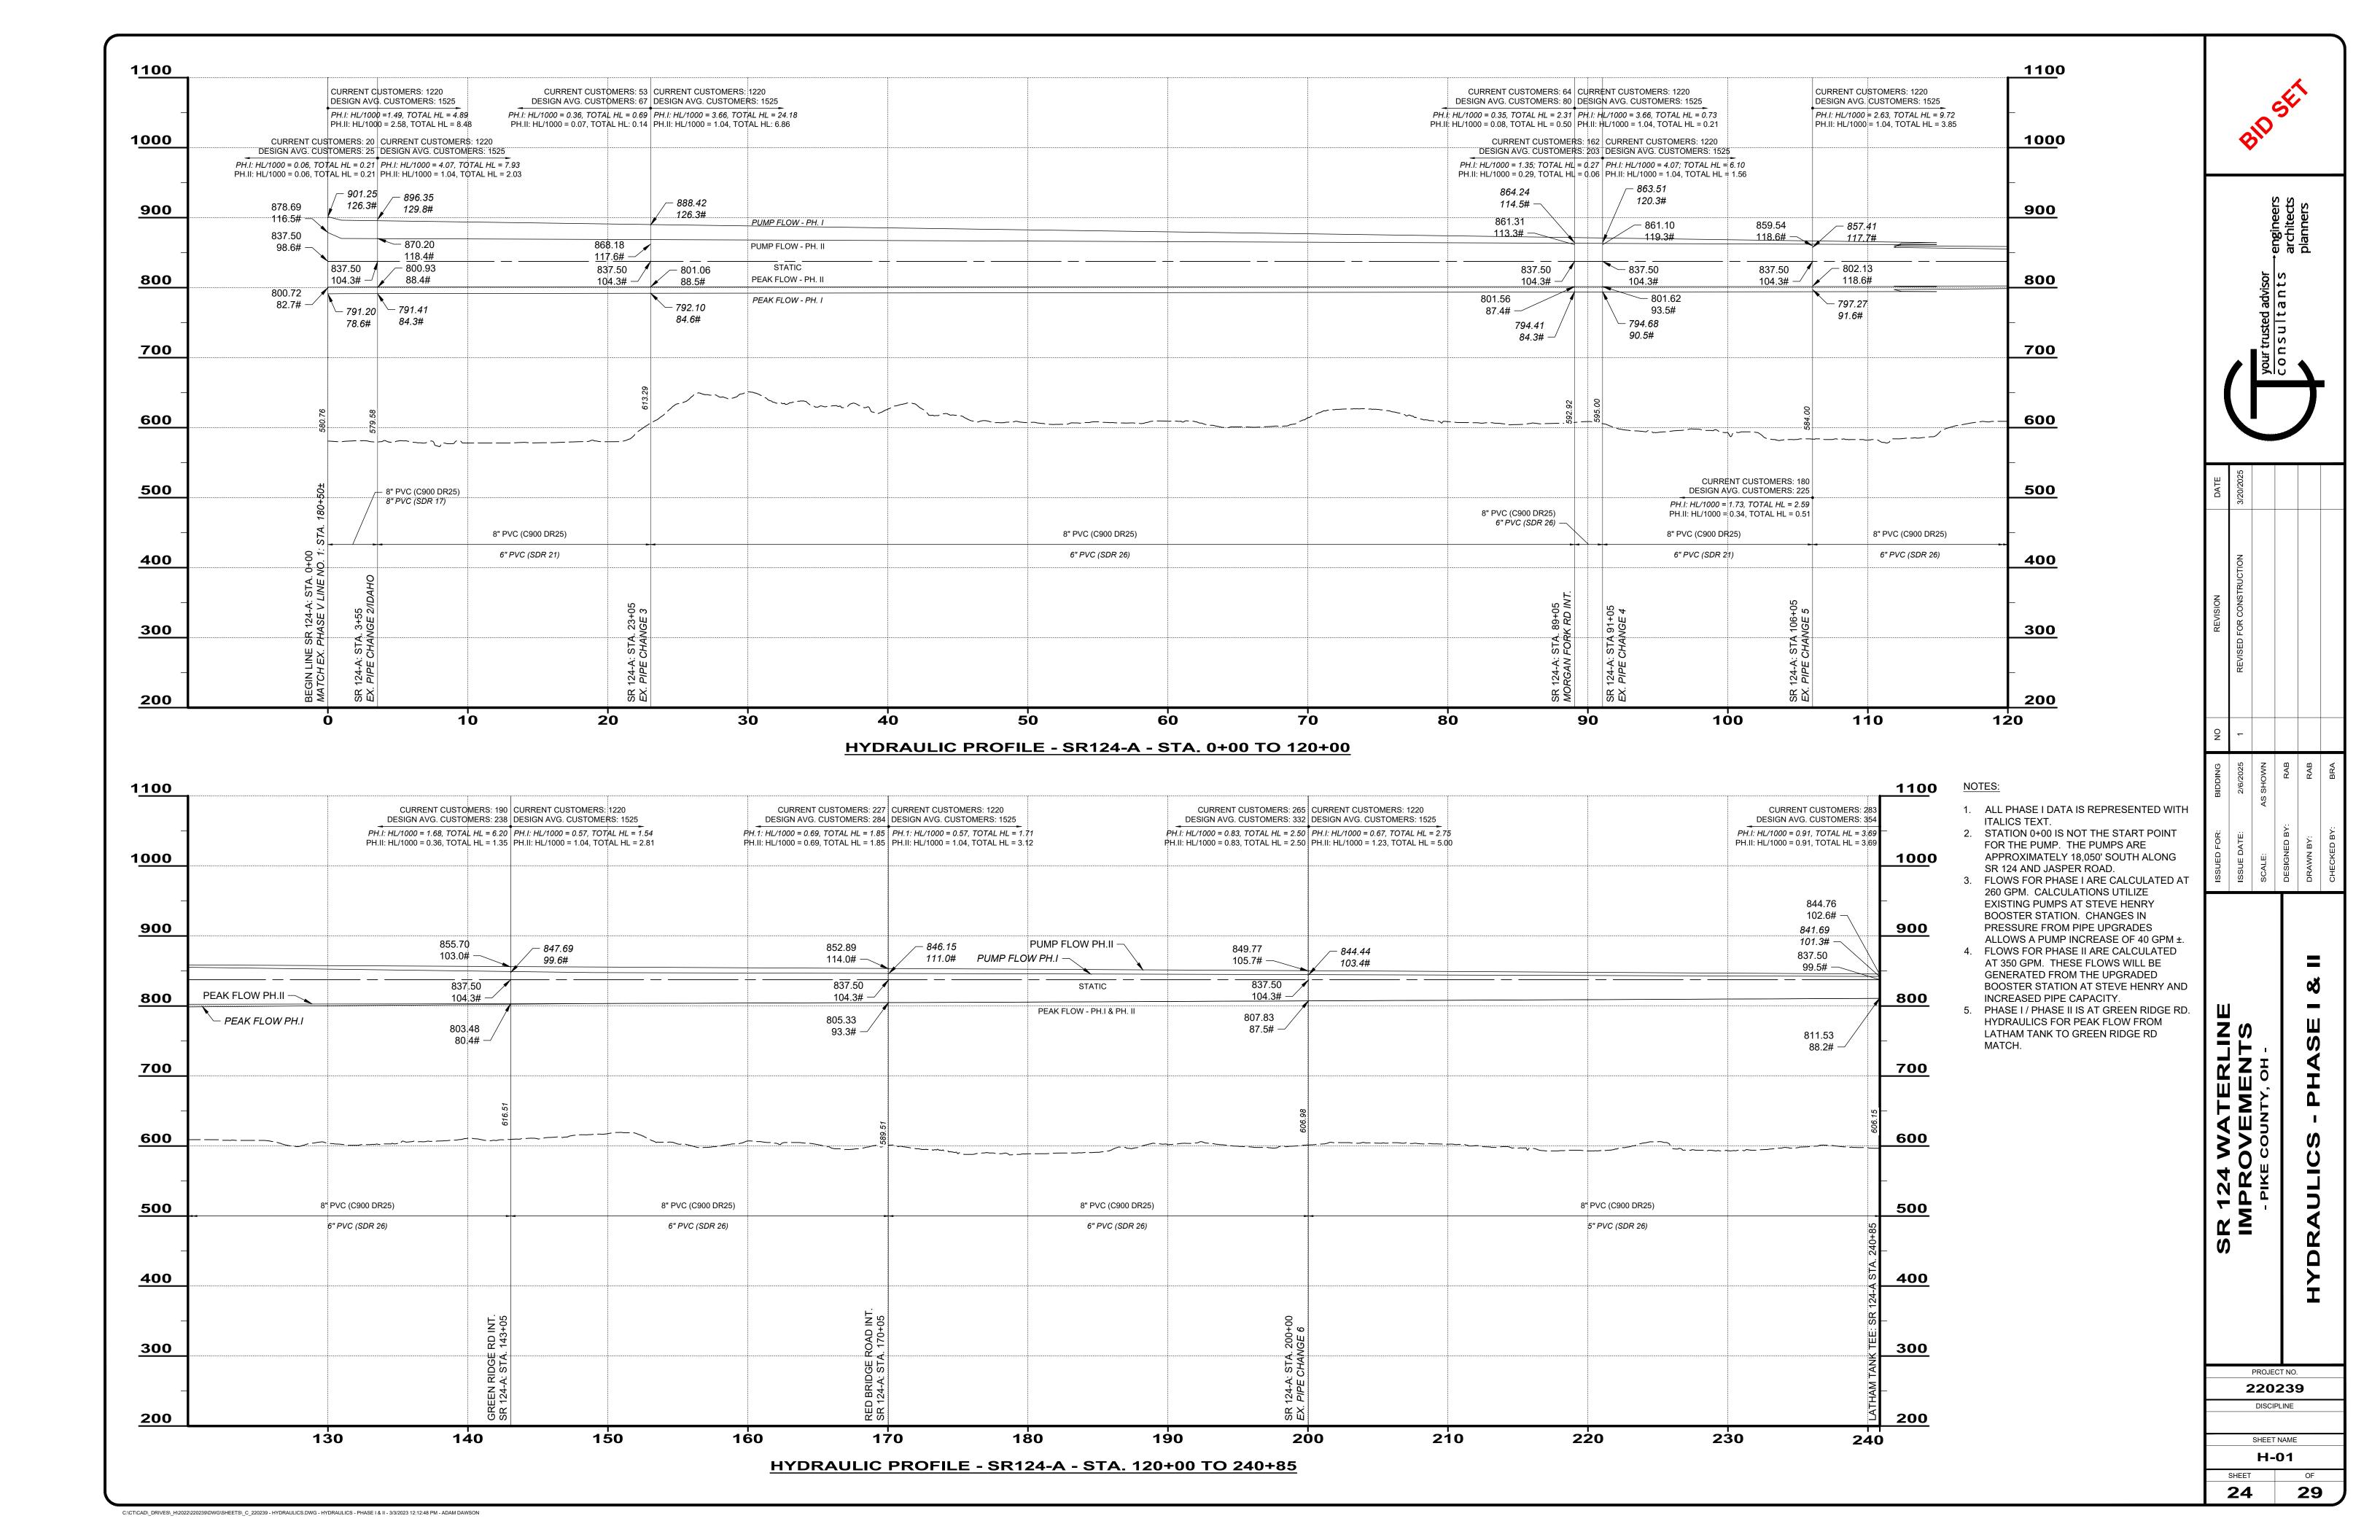
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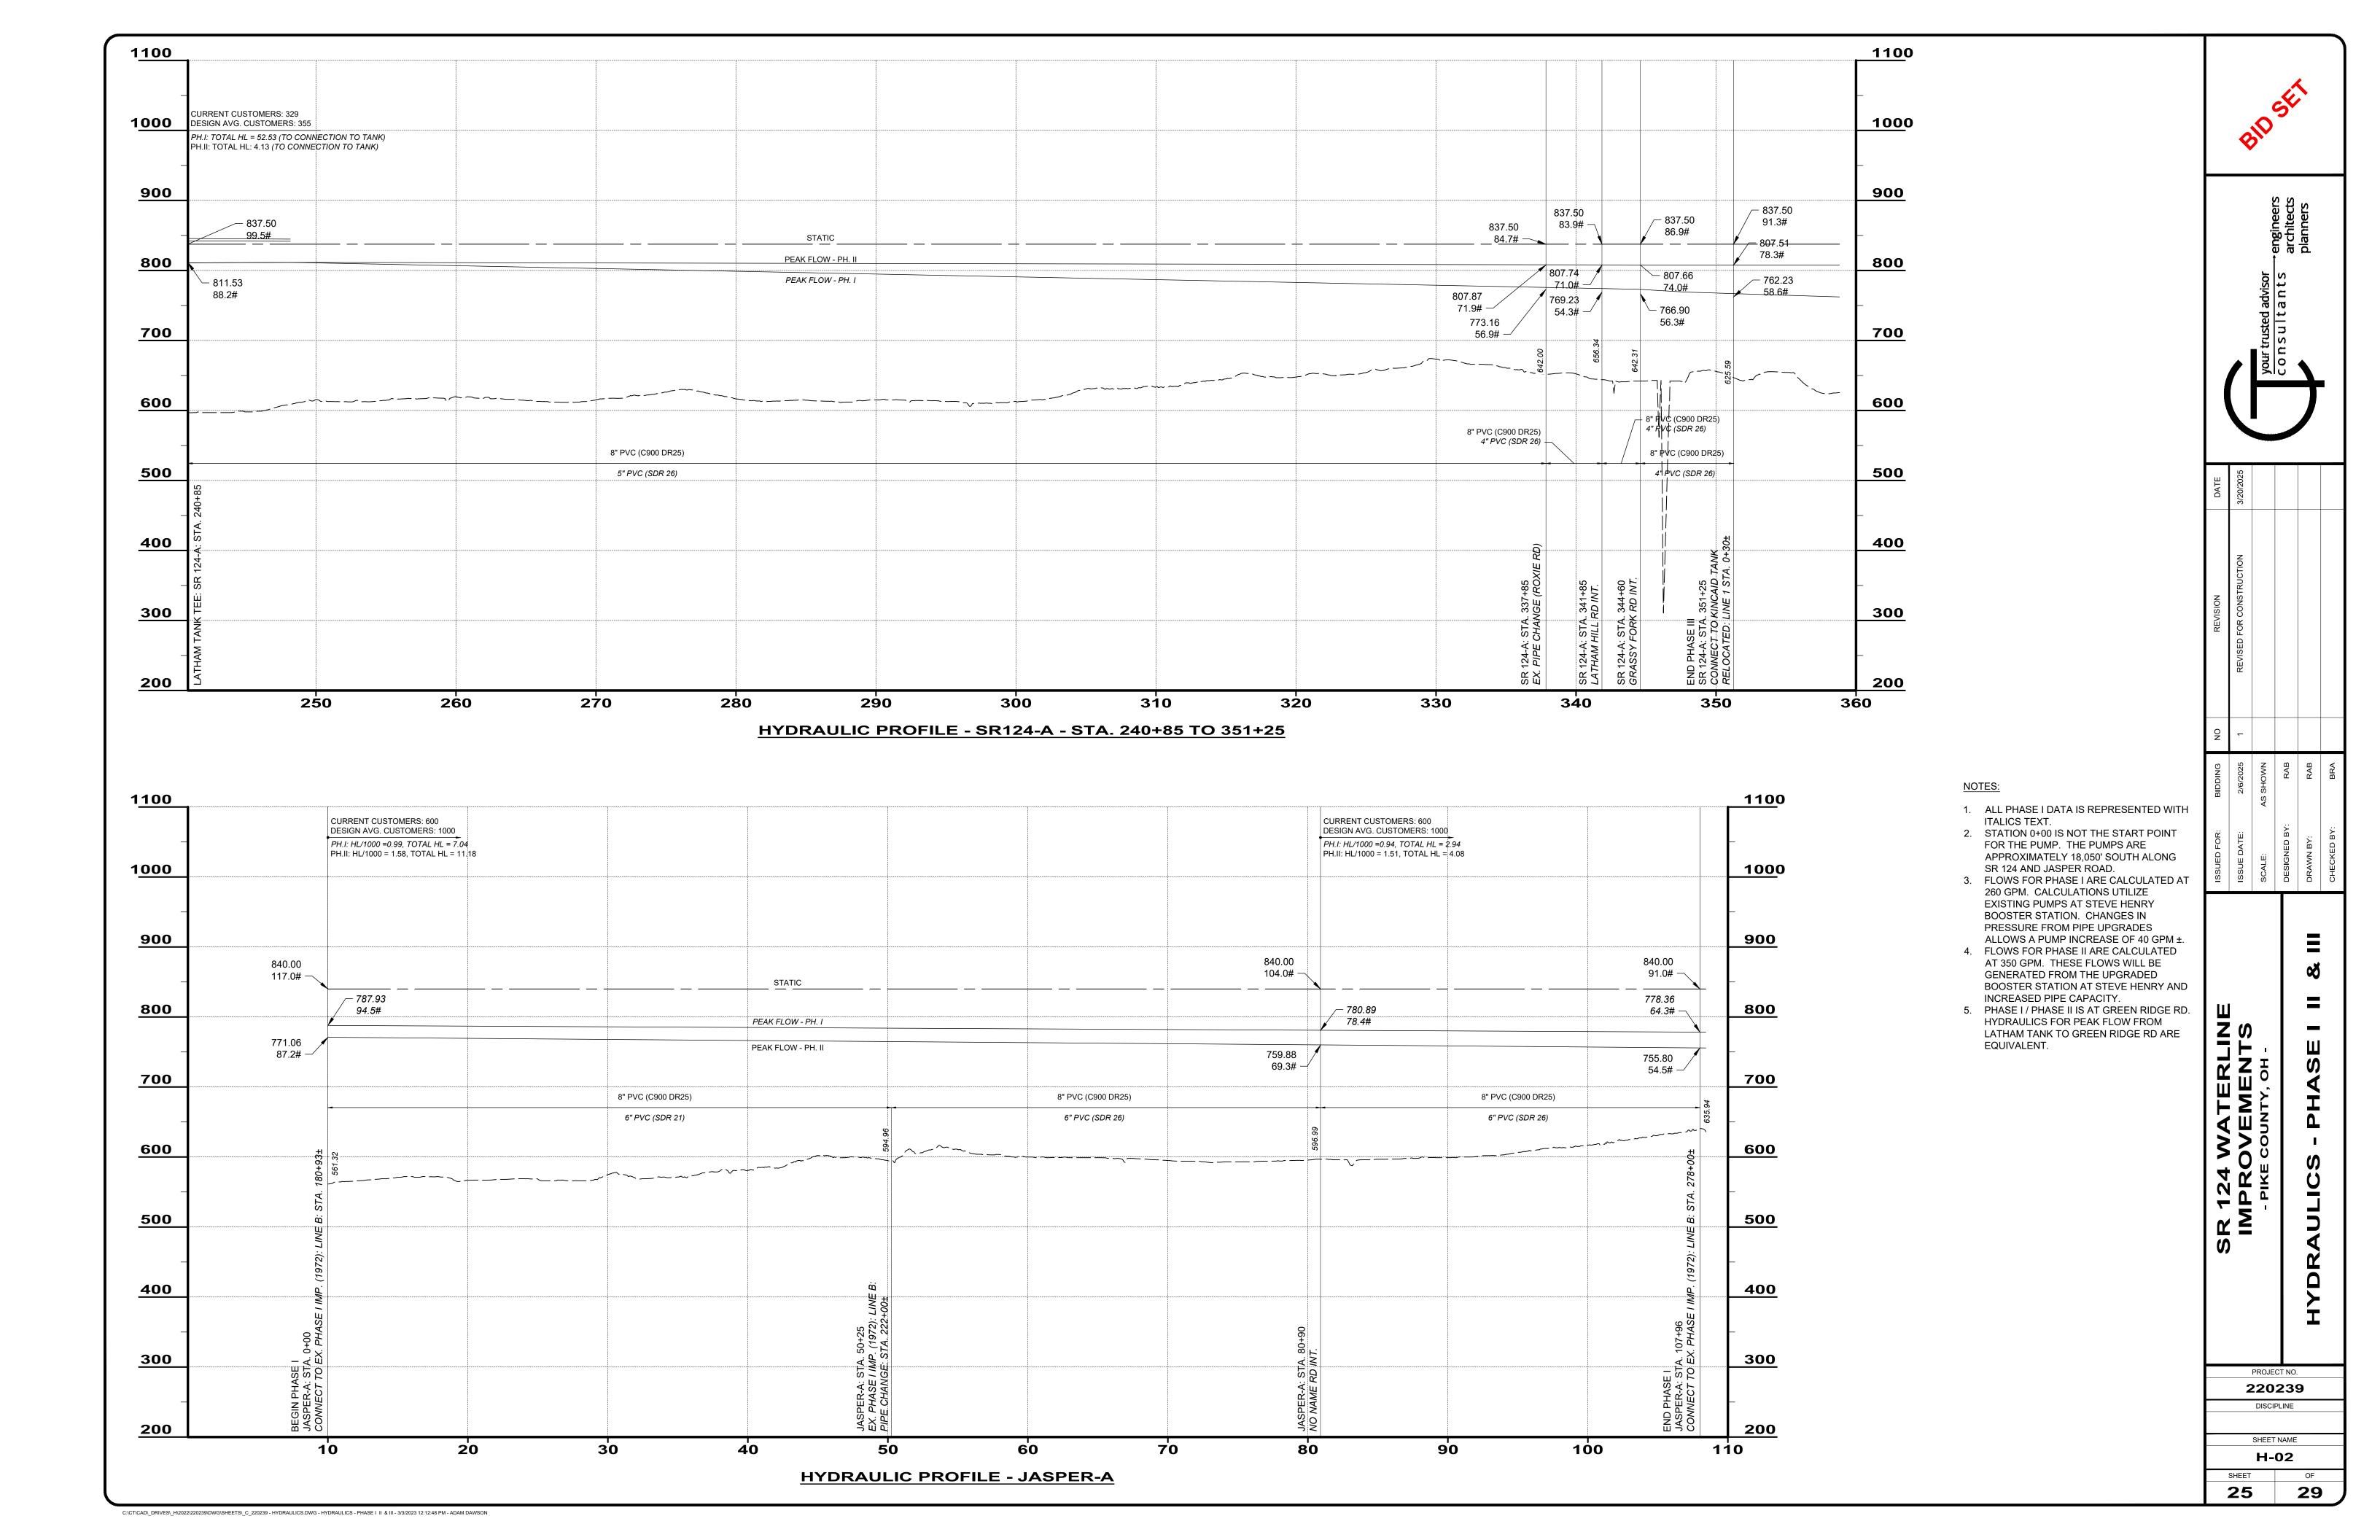
SD-03


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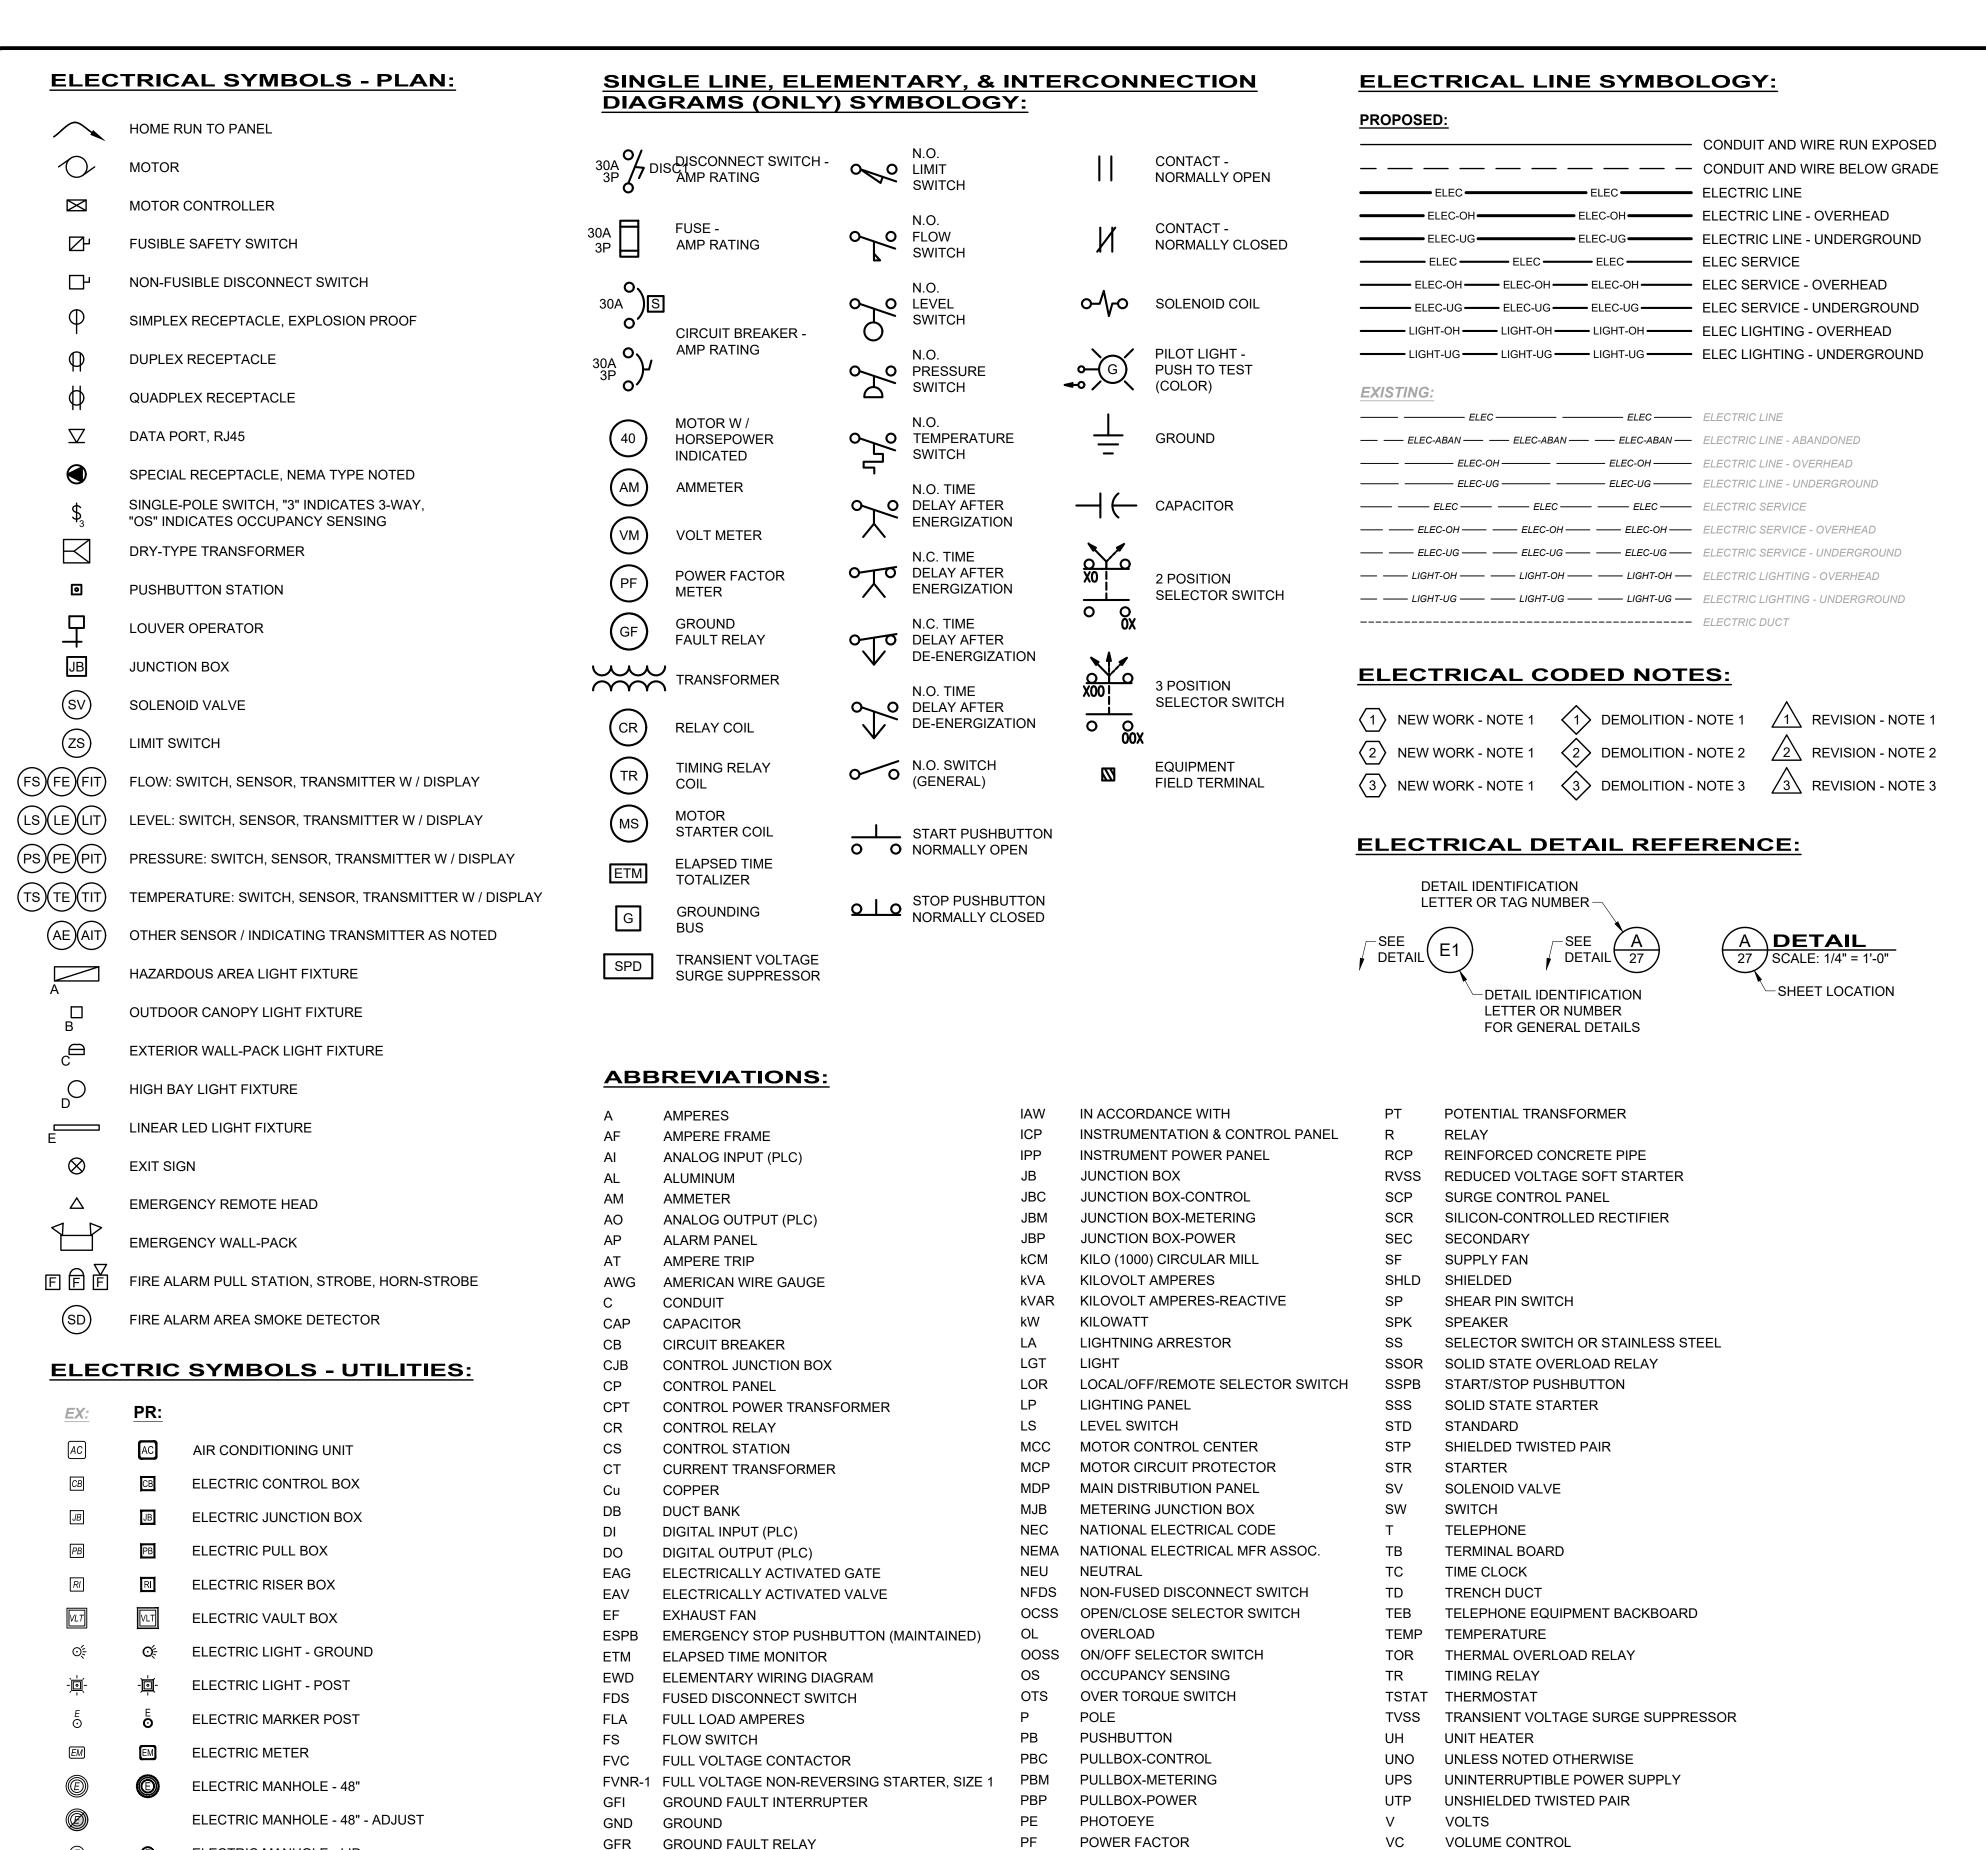
**23** 

C:\CT:\CAD\\_DRIVES\\_H:2022\220239\DWG\SHEETS\C\_220239 - STANDARD DETAILS.DWG - SD-03 - 3/3/2023 12:13:14 PM - ADAM DAWSON







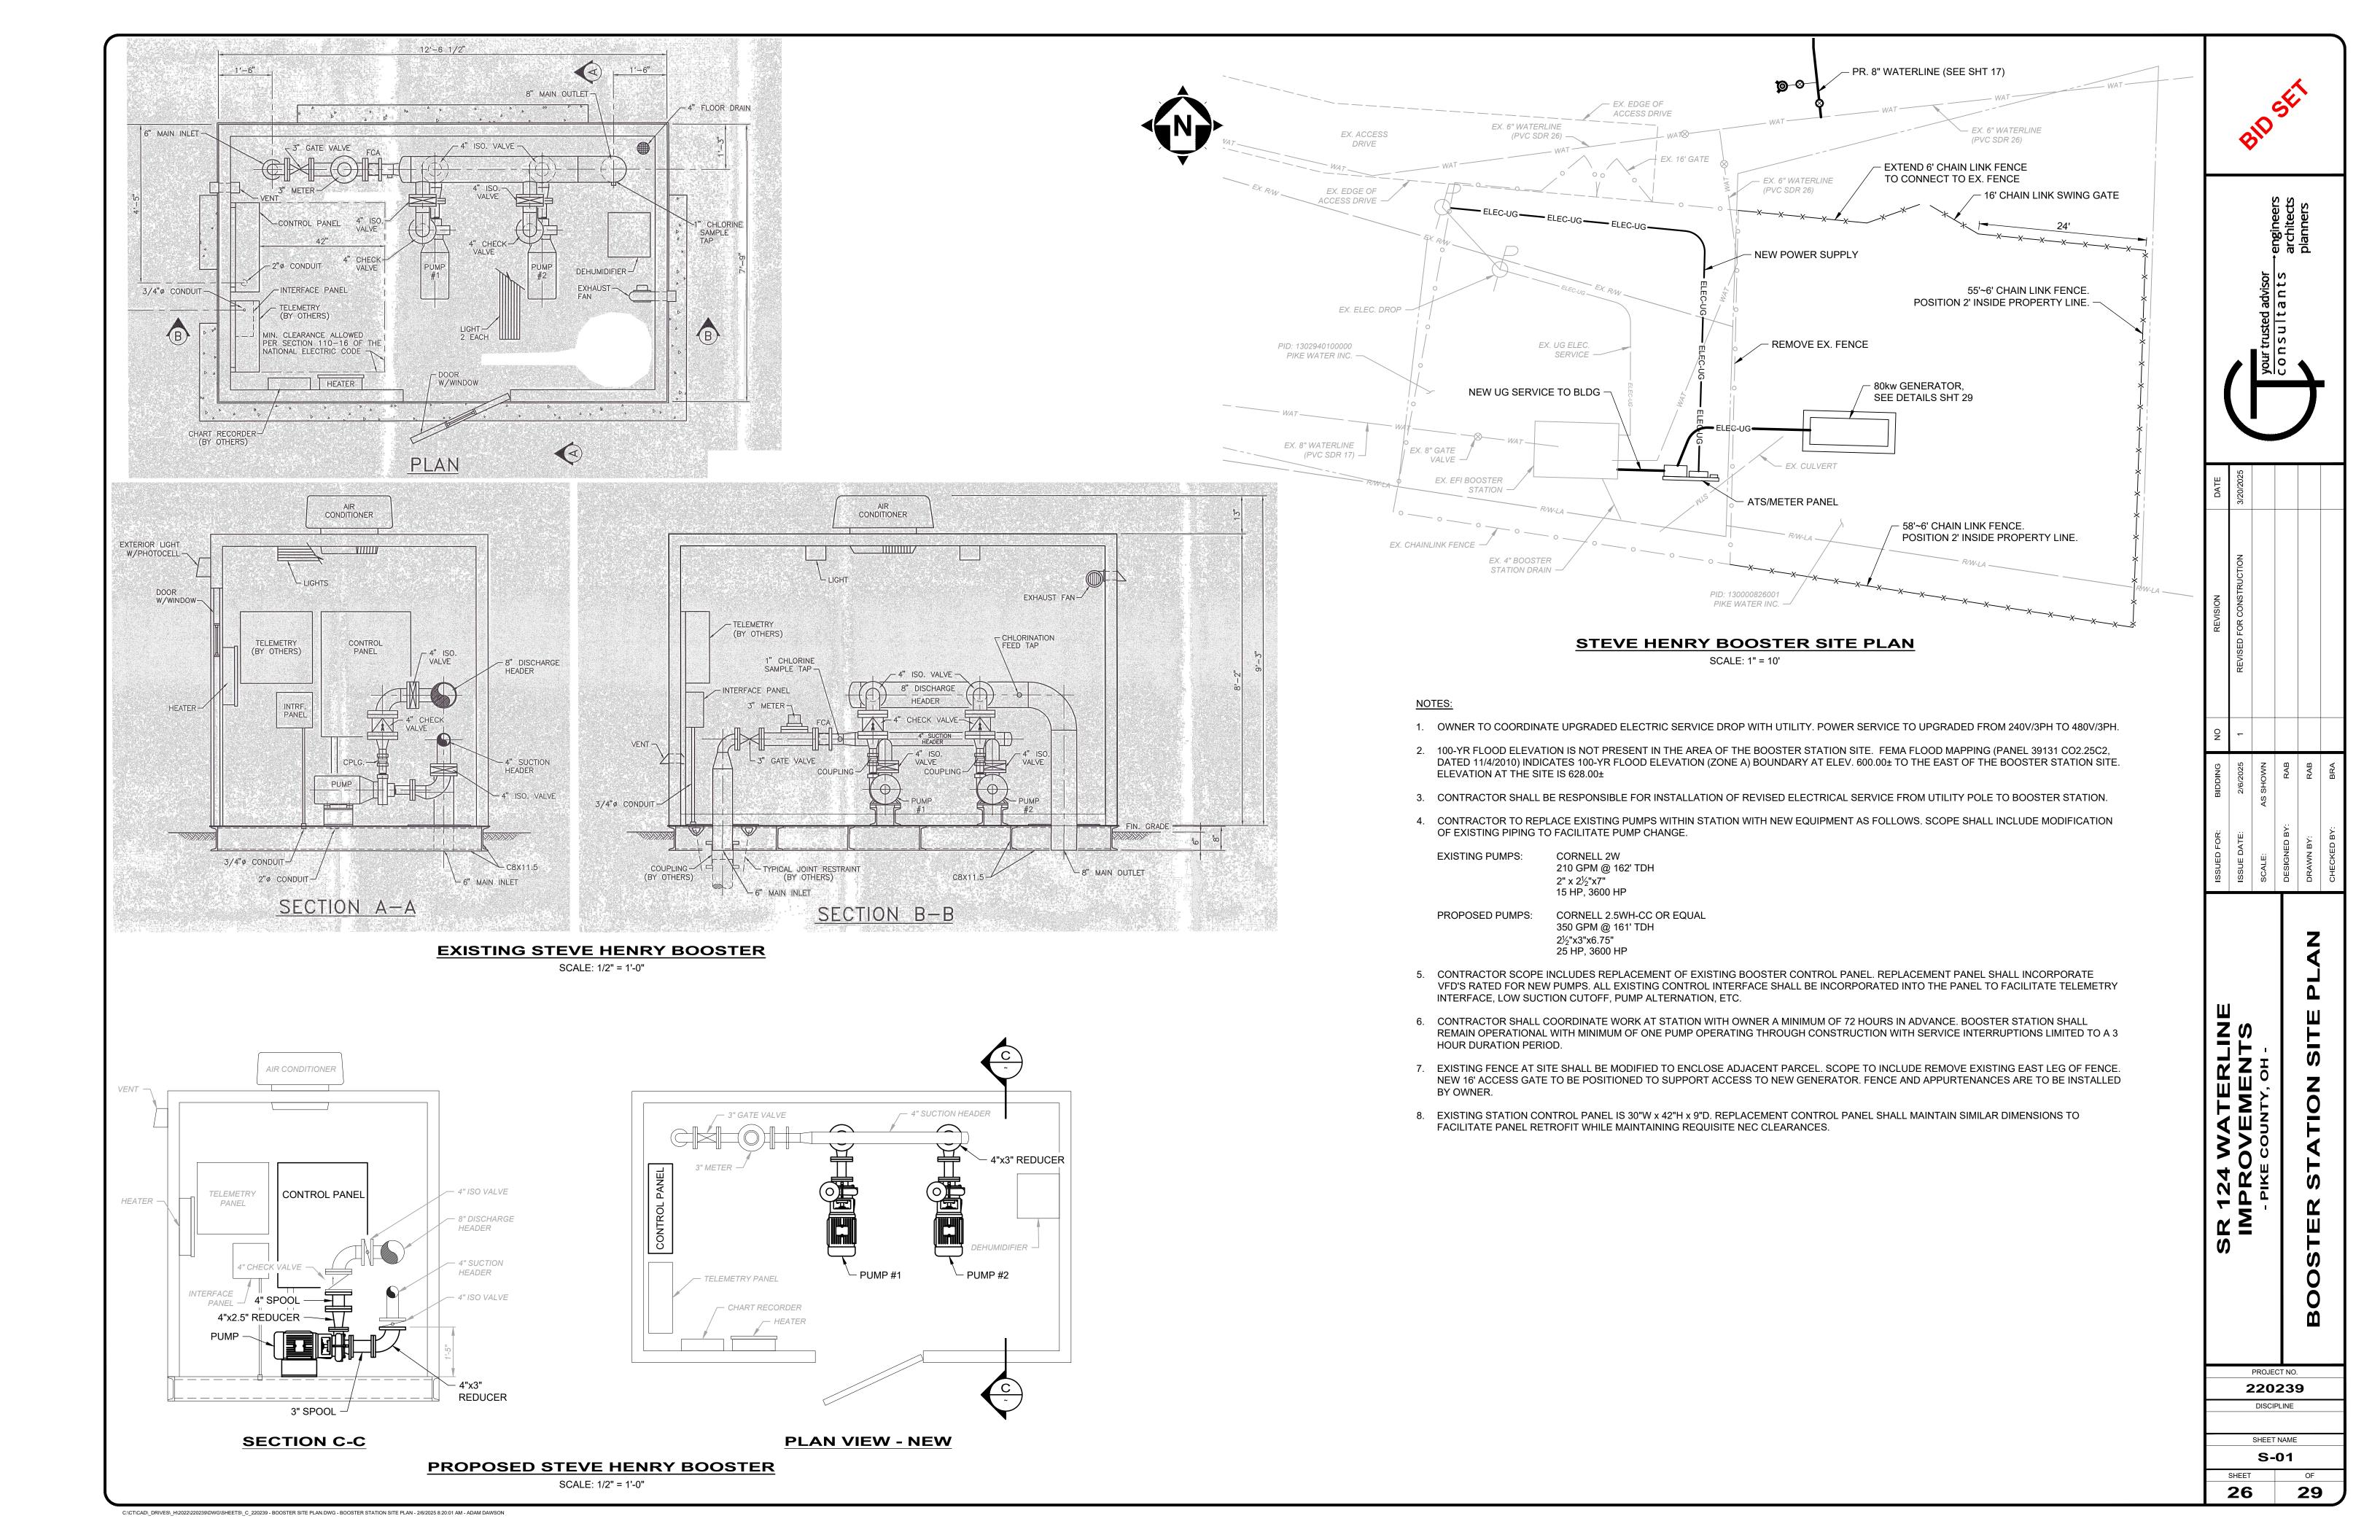

PHASE

PROGRAMMABLE LOGIC CONTROLLER

POWER JUNCTION BOX

PRESSURE SWITCH

**POWER PANEL** 

PRIMARY

VARIABLE FREQUENCY DRIVE

VOLT METER

**EXPLOSION PROOF** 

TRANSFORMER

WATERPROOF

LIMIT SWITCH

VM

#### **ELECTRICAL GENERAL NOTES:**


- 1. ALL ELECTRICAL EQUIPMENT AND MATERIALS WILL BE SELECTED AND INSTALLED IN COMPLIANCE WITH ALL APPLICABLE NATIONAL, STATE, AND LOCAL FIRE CODES, INCLUDING BUT NOT LIMITED TO ALL PERTINENT NFPA REGULATIONS. IT IS THE ELECTRICAL CONTRACTOR'S RESPONSIBILITY TO ENSURE COMPLIANCE WITH THESE CODES.
- 2. DO NOT INSTALL DEVICES SCALED FROM THESE DRAWINGS. ALL DEVICES SHALL BE INSTALLED AT LOCATIONS SHOWN IN THE APPROVED CONDUIT/DEVICE LAYOUT DRAWINGS AND WITH DIMENSIONS TAKEN IN THE FIELD.
- 3. ELECTRICIAN TO VISIT SITE AND VERIFY ALL EXISTING CONDITIONS PRIOR TO BID.
- 4. NO DUCTWORK OR PIPING TO BE RUN ABOVE ELECTRICAL PANELS OR THROUGH ELECTRICAL EQUIPMENT ROOMS. ELECTRICIAN SHALL COORDINATE WITH ALL TRADES FOR EQUIPMENT LAYOUTS PRIOR TO ROUGH-IN OF ALL SYSTEMS.
- 5. MANUFACTURERS AND CATALOG NUMBERS SHOWN IN THE LIGHT FIXTURE SCHEDULE ARE PROVIDED TO INDICATE DESIRED LIGHT FIXTURE CHARACTERISTICS. IT IS THE INTENT OF THE DOCUMENTS TO ALLOW ALTERNATE MANUFACTURERS TO PROVIDE LIGHTING PRODUCTS FOR THE PROJECT, AS LONG AS PROPOSED ALTERNATES PROVIDE THE SAME GENERAL DESIGN AND LIGHTING CHARACTERISTICS AS NOTED IN THE LIGHT FIXTURE DESCRIPTION.
- 6. ELECTRICIAN TO CONFIRM LOCATIONS OF ALL ELECTRICAL EQUIPMENT AND ELECTRICAL CHARACTERISTICS OF PROCESS EQUIPMENT PROVIDED BY OTHER TRADES PRIOR TO INSTALLING ROUGH-INS AS SHOWN ON THE ELECTRICAL PLANS. ALL SHOP DRAWING REQUIREMENTS WILL BE CONSIDERED AS THE MEANS AND METHODS OF INSTALLATION.
- 7. THIS PROJECT INVOLVES WORK AT AN INDUSTRIAL FACILITY AND THE CONTRACTOR IS EXPECTED TO PROVIDE CRAFTSMANSHIP REFLECTING THE NATURE OF THE FACILITY. CONDUITS IN PROCESS AREAS ARE TO BE SURFACE MOUNTED RIGID GALVANIZED STEEL (RGS). IN CLASSIFIED AREAS SEAL ALL CONDUITS TO RESTRICT THE PASSAGE OF GASSES AND VAPORS, AND ARRANGE SEALING FITTING DRAINS IN CONDUIT SYSTEMS TO PREVENT ACCUMULATION OF CONDENSATE ABOVE SEALS. ALL CONDUITS ENTERING OR LEAVING A MOTOR CONTROL CENTER, CONTROL PANEL, VALVE ACTUATOR, INSTRUMENT, A BUILDING, OR A PANELBOARD SHALL BE MADE WATERTIGHT USING AN INFLATABLE SEALED BLADDER DUCT SEALING SYSTEM, RAYCHEM 'RAYFLATE' DUCT SEALING SYSTEM RDSS OR APPROVED EQUAL. ALL HARDWARE IS TO BE STAINLESS STEEL UNLESS OTHERWISE DIRECTED.

#### ALL ENCLOSURES ARE TO BE RATED AS FOLLOWS (UON):

- OUTDOORS: NEMA 4X (STAINLESS STEEL)
- CLASSIFIED AREAS: NEMA 7
- INDOORS (CORROSIVE AREAS): NEMA 4X (STAINLESS STEEL)
- INDOORS (CONTROLLED ENVIRONMENT) NEMA 12
- 8. ELECTRICIAN SHALL REVIEW ALL OTHER TRADES' CONSTRUCTION DOCUMENTS AND/OR COORDINATE WITH OTHER TRADES AND VERIFY IF THERE ARE ANY ADDITIONAL ELECTRICAL REQUIREMENTS NOT SHOWN ON ELECTRICAL DRAWINGS. COST FOR WORK SHOWN ON OTHER TRADES' DRAWINGS SHALL BE INCLUDED IN BASE BID. ALL FIELD WIRING AND TERMINATIONS OF PROCESS EQUIPMENT AND INSTRUMENTATION AND CONTROLS SHALL BE THE RESPONSIBILITY OF THE ELECTRICIAN. ALL CABLES AND WIRES PROVIDED BY VENDORS SHALL BE INSTALLED AND TERMINATED BY THE ELECTRICIAN. WIRE ALL MISCELLANEOUS POWER AND CONTROLS AS REQUIRED TO PROVIDE A COMPLETE FUNCTIONING SYSTEM.
- 9. ELECTRICAL WIRES SHALL BE MINIMUM #12 AWG, COPPER, 600 V RATED. #14 AWG COPPER SHALL BE PERMISSIBLE FOR CONTROL CIRCUITRY. AMPACITY RATINGS SHALL BE BASED UPON 75°C RATINGS.

  A. #14, #12, AND #10 AWG CONDUCTORS SHALL BE "THHN/THWN".
  - B. #8 AND LARGER SHALL BE STRANDED "THHN/THWN".
- 10. A 4-20mA SIGNAL IS AN ANALOG SIGNAL USED TO TRANSMIT DATA (LEVEL, FLOW, ETC.) FOR PROCESS CONTROLS. THE ELECTRICIAN SHALL PROVIDE, INSTALL, AND TERMINATE SHIELDED TWISTED PAIRS (STP) WIRING IN RIGID GALVANIZED STEEL CONDUIT (RGS). RGS IS USED IN AN ATTEMPT TO REDUCE THE DISTORTION AFFECT FROM EMI AND RFI. BELOW GRADE CONDUITS SHALL BE PVC SCHED-40. PARALLEL RUNS OF DATA CONDUITS AND POWER CONDUITS SHALL BE SEPARATED BY 2 FEET. THE STP SHIELD SHALL BE GROUNDED AT THE CONTROL PANEL ONLY (DO NOT GROUND AT BOTH ENDS).
- 11. THE ELECTRICIAN SHALL BE RESPONSIBLE FOR LAYOUT AND COORDINATION OF OPENINGS AND CHASES AND SHALL PERFORM ALL CUTTING AND PATCHING AS REQUIRED TO INSTALL THEIR WORK. ALL CONCRETE HOUSE KEEPING PADS SHALL BE FRAMED AND POURED BY THE ELECTRICIAN. PADS SHALL HAVE A 45 DEGREE, 1" CHAMFER AROUND UPPER EDGE.
- 12. THE ELECTRICIAN SHALL INSTALL & DISTRIBUTE TEMPORARY POWER SERVICE FOR THE DURATION OF THIS PROJECT AS DEFINED IN DIVISION 1 SPECIFICATIONS. ALL COSTS ASSOCIATED WITH THE INSTALLATION, DISTRIBUTION AND MAINTENANCE OF THE TEMPORARY POWER IS THE RESPONSIBILITY OF THE ELECTRICIAN. THERE SHALL BE 480/277V,3PH,4W; 208/120V,3PH,4W; AND 120/240V,1PH,3W POWER AVAILABLE AT ALL LOCATIONS OF CONSTRUCTION AS DIRECTED IN FIELD AND AS SPECIFIED. ALL TEMPORARY EQUIPMENT, CONDUITS & CONDUCTORS SHALL BE COMPLETELY REMOVED AT COMPLETION OF PROJECT.
- 13. ALL ELECTRICAL EQUIPMENT, DEVICES, LIGHTING FIXTURES, CONDUIT, AND WIRING SHOWN ON THE ELECTRICAL DRAWINGS IS NEW UNLESS CLEARLY CALLED OUT AS EXISTING. ALL EXISTING ELECTRICAL EQUIPMENT THAT IS CALLED OUT TO BE REUSED SHALL BE INSPECTED IN THE FIELD BY THE ELECTRICIAN AND THE CONSTRUCTION MANAGER TO DETERMINE ITS CONDITION PRIOR TO STARTING ANY WORK. PROVIDE DOCUMENTATION TO OWNER INDICATING CONDITION OF THE EXISTING EQUIPMENT, AND REUSE EXISTING EQUIPMENT ONLY IF ALL PARTIES AGREE THE CONDITION IS ACCEPTABLE. ALL EXISTING EQUIPMENT DETERMINED TO BE UNUSABLE SHALL BE REPLACED WITH LIKE KIND AS DIRECTED BY THE OWNER. ANY OF THE OWNERS EQUIPMENT DETERMINED TO BE REUSED THAT IS DAMAGED BY ANY CONTRACTOR DURING SWITCHOVER SHALL BE REPLACED BY THAT CONTRACTOR. ALL EXISTING EQUIPMENT IS THE PROPERTY OF THE OWNER (NOT THE CONTRACTOR) AND SHALL BE TREATED ACCORDINGLY.
- 14. THE ELECTRICIAN SHALL BE HELD RESPONSIBLE TO ENSURE ALL CONTROLLERS TO BE INSTALLED ARE CAPABLE OF LOCKOUT / TAGOUT PRIOR TO INSTALLATION.
- 15. CONFORM TO THE NEC, OSHA, FIRE MARSHAL, BUILDING DEPARTMENT AND OTHER APPLICABLE CODES AND REGULATIONS. OBTAIN PERMITS, PAY ALL FEES, AND ARRANGE FOR REQUIRED INSPECTIONS.
- ALL LIGHTING AND RECEPTACLE WIRING TO BE #12 XHHW WITH EQUIPMENT GROUND IN 3/4" C UNLESS OTHERWISE NOTED.
- 17. DO NOT MOUNT ANY LIGHT FIXTURE DIRECTLY OVER PIPING OR EQUIPMENT THAT WILL INTERFERE WITH NORMAL LIGHTING DISTRIBUTION.
- 18. SIZE JUNCTION BOXES AS REQUIRED PER NEC. PROVIDE BARRIER TYPE TERMINAL STRIPS, AND ALL WIRING TO BE IN CONDUIT.
- 19. SIZE PULL BOXES (PB) AS REQUIRED PER NEC.
- 20. PROVIDE SEPARATE PB'S FOR CONTROL AND POWER.
- 21. MOTOR OVERLOAD SETTING SHALL BE FIELD SELECTED PER MOTOR NAME PLATE CURRENT AND INSTALLED ACCORDINGLY.
- 22. MOUNT LOCAL CONTROLS AND SERVICE DISCONNECTS ON WALL NEAREST EQUIPMENT WHERE POSSIBLE. (MAXIMUM 60" ABOVE FINISHED FLOOR OR FINAL GRADE, MAXIMUM LATERAL DISTANCE FROM WALL TO EQUIPMENT 10 FEET).
- 23. ALL FEEDERS RUN BELOW GRADE SHALL BE RUN IN PVC CONDUIT AT MINIMUM 3'-0" BELOW FINISHED GRADE, TRANSITION TO ABOVE GRADE SHALL BE MADE USING FACTORY PVC COATED RIGID STEEL CONDUIT SWEEPS.



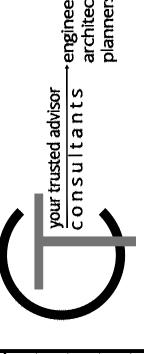

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ISSUED FOR:	ISSUE DATE:	SCALE:	DESIGNED BY:	DRAWN BY:	CHECKED BY:
	MENTS	NTY, OH -		ELECTRICAL LEGEND	NO ES
SR 124 WATERLINE					& GENERAL NOIES
SR 124 WAT		PROJE 220	CT NO. <b>23</b>		& GENEKAL
	2	PROJE	CT NO. 239 PLINE	9	
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	2	PROJE  220  DISCII  CT  SHEET	CT NO.  239  PLINE  RIC  NAME	9	

ELECTRIC MANHOLE - LID

**ELECTRIC PAINT MARK** 

ELECTRIC TRANSFORMER

ELECTRIC PEDESTAL

HOA

HP

HTS

Hz


HAND/OFF/AUTO SELECTOR SWITCH


**HORSEPOWER** 

HIGH TORQUE SWITCH

HEATER

HERTZ

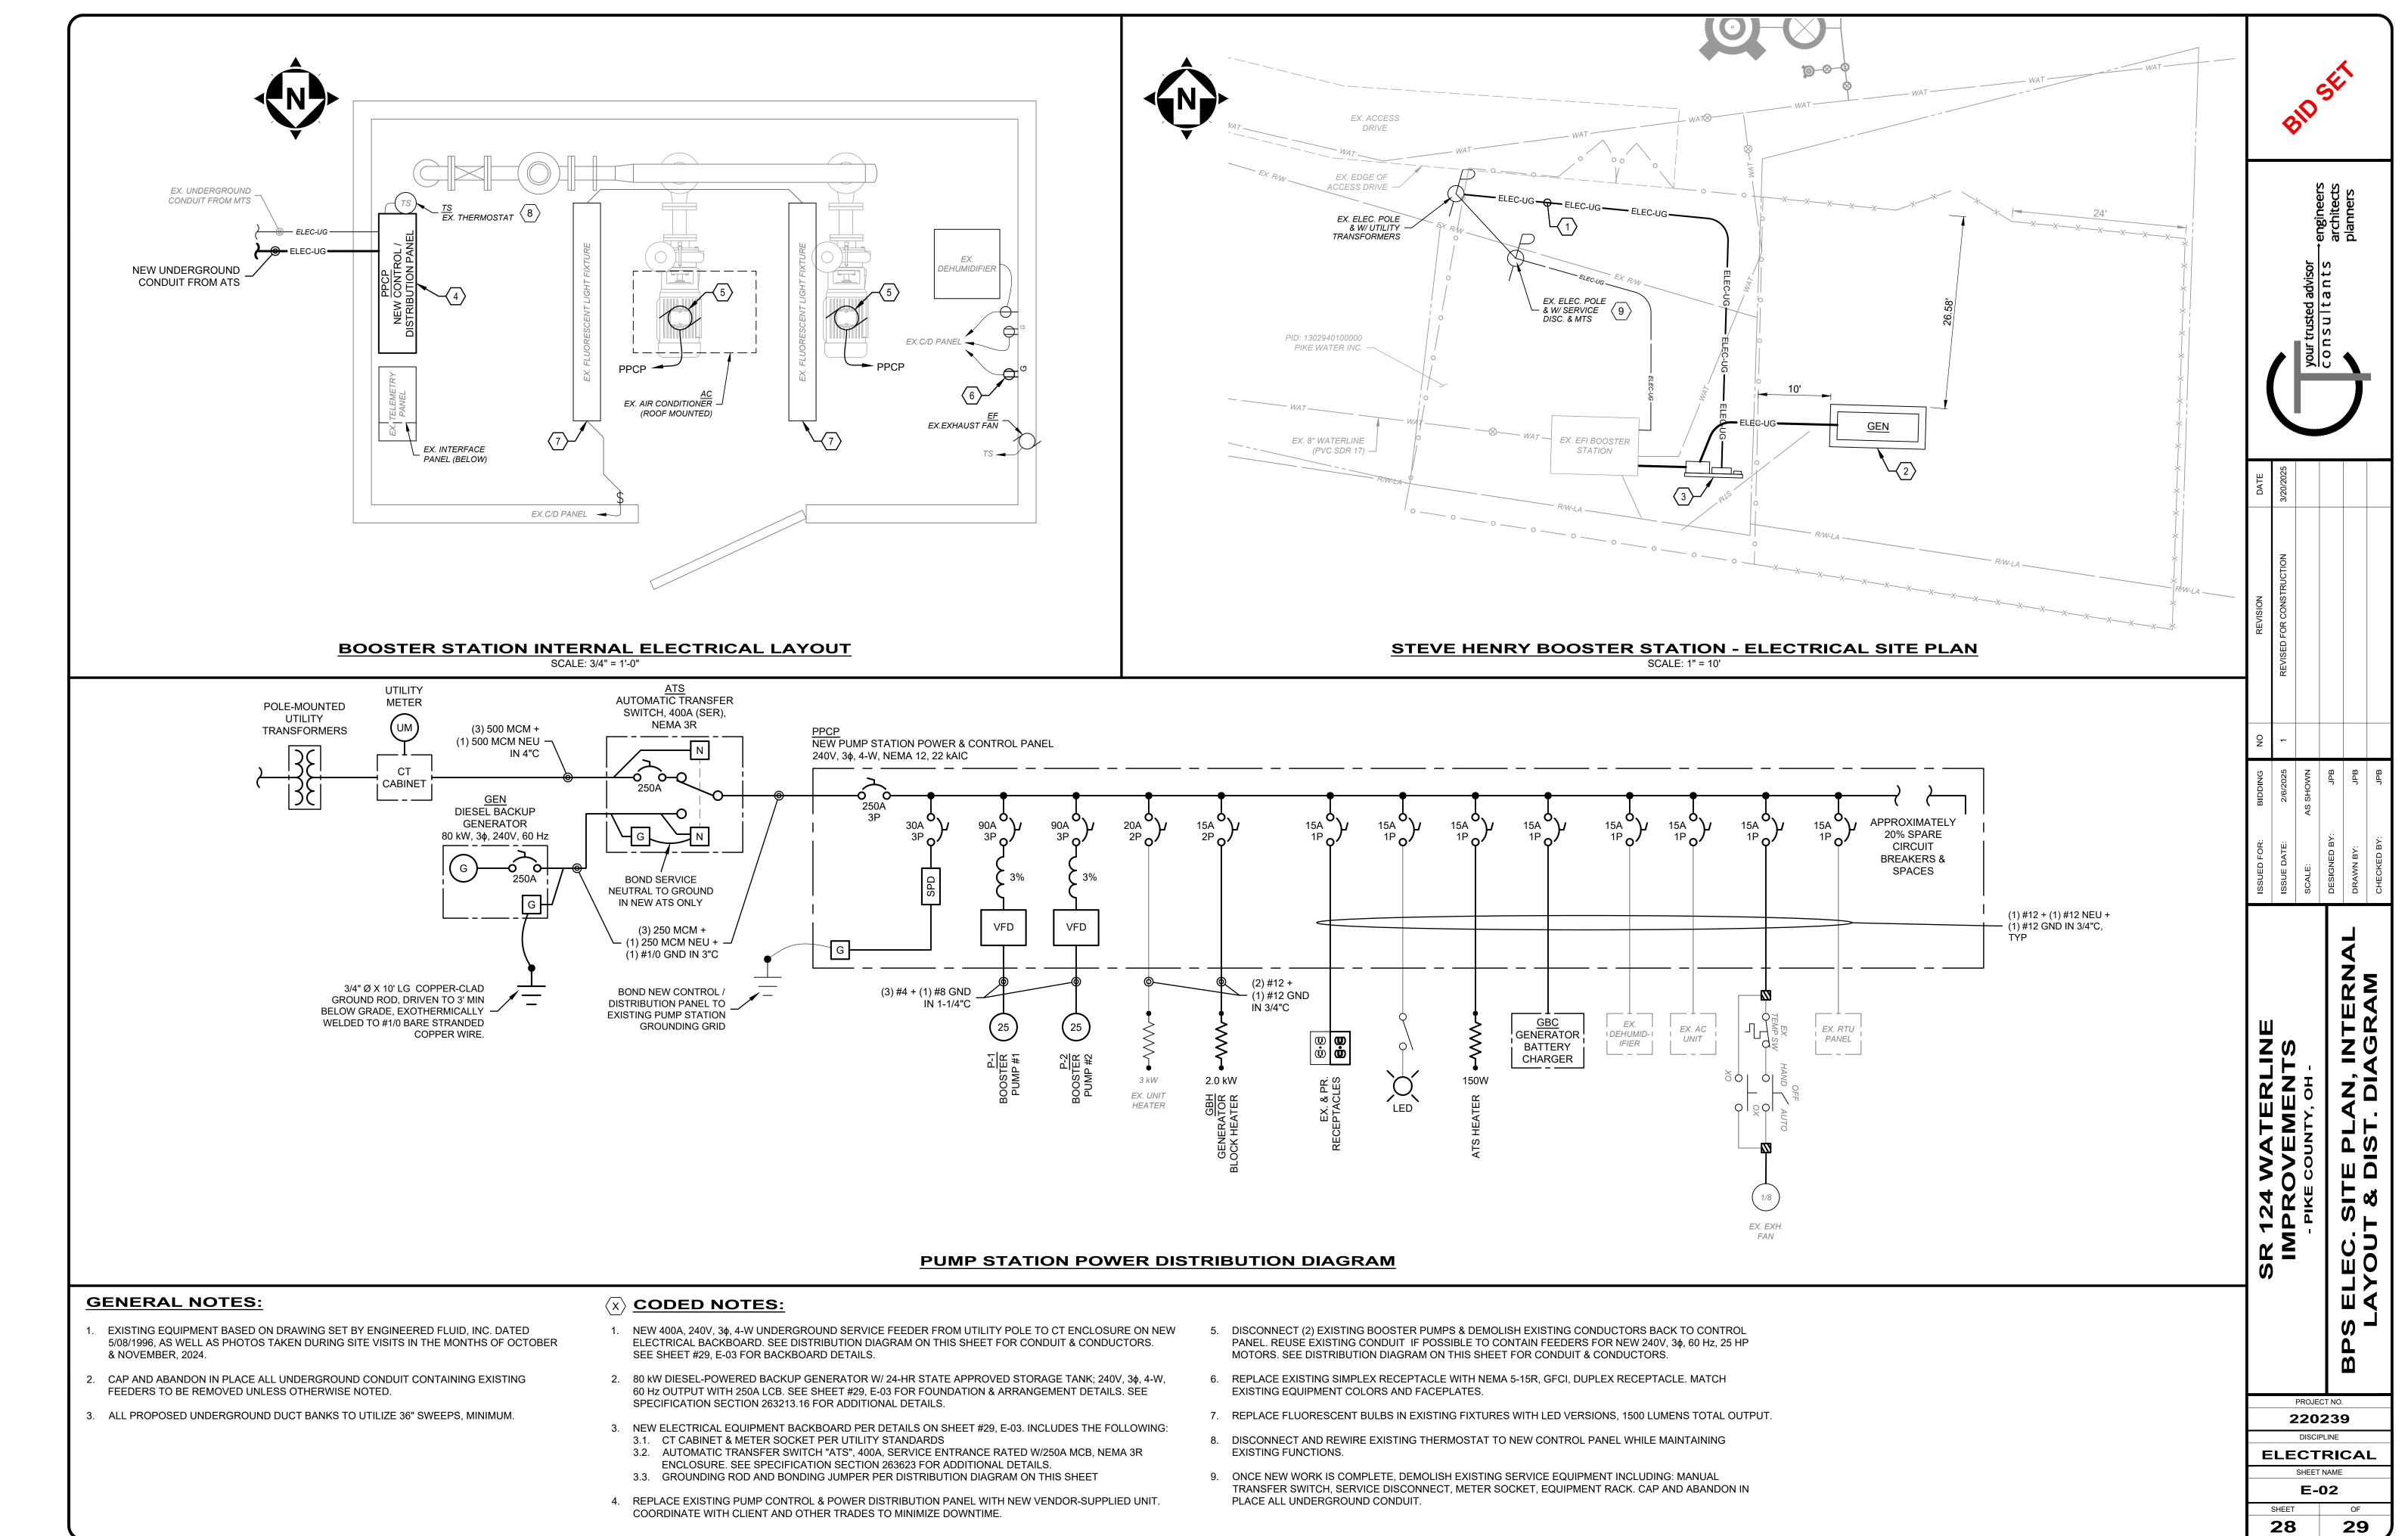

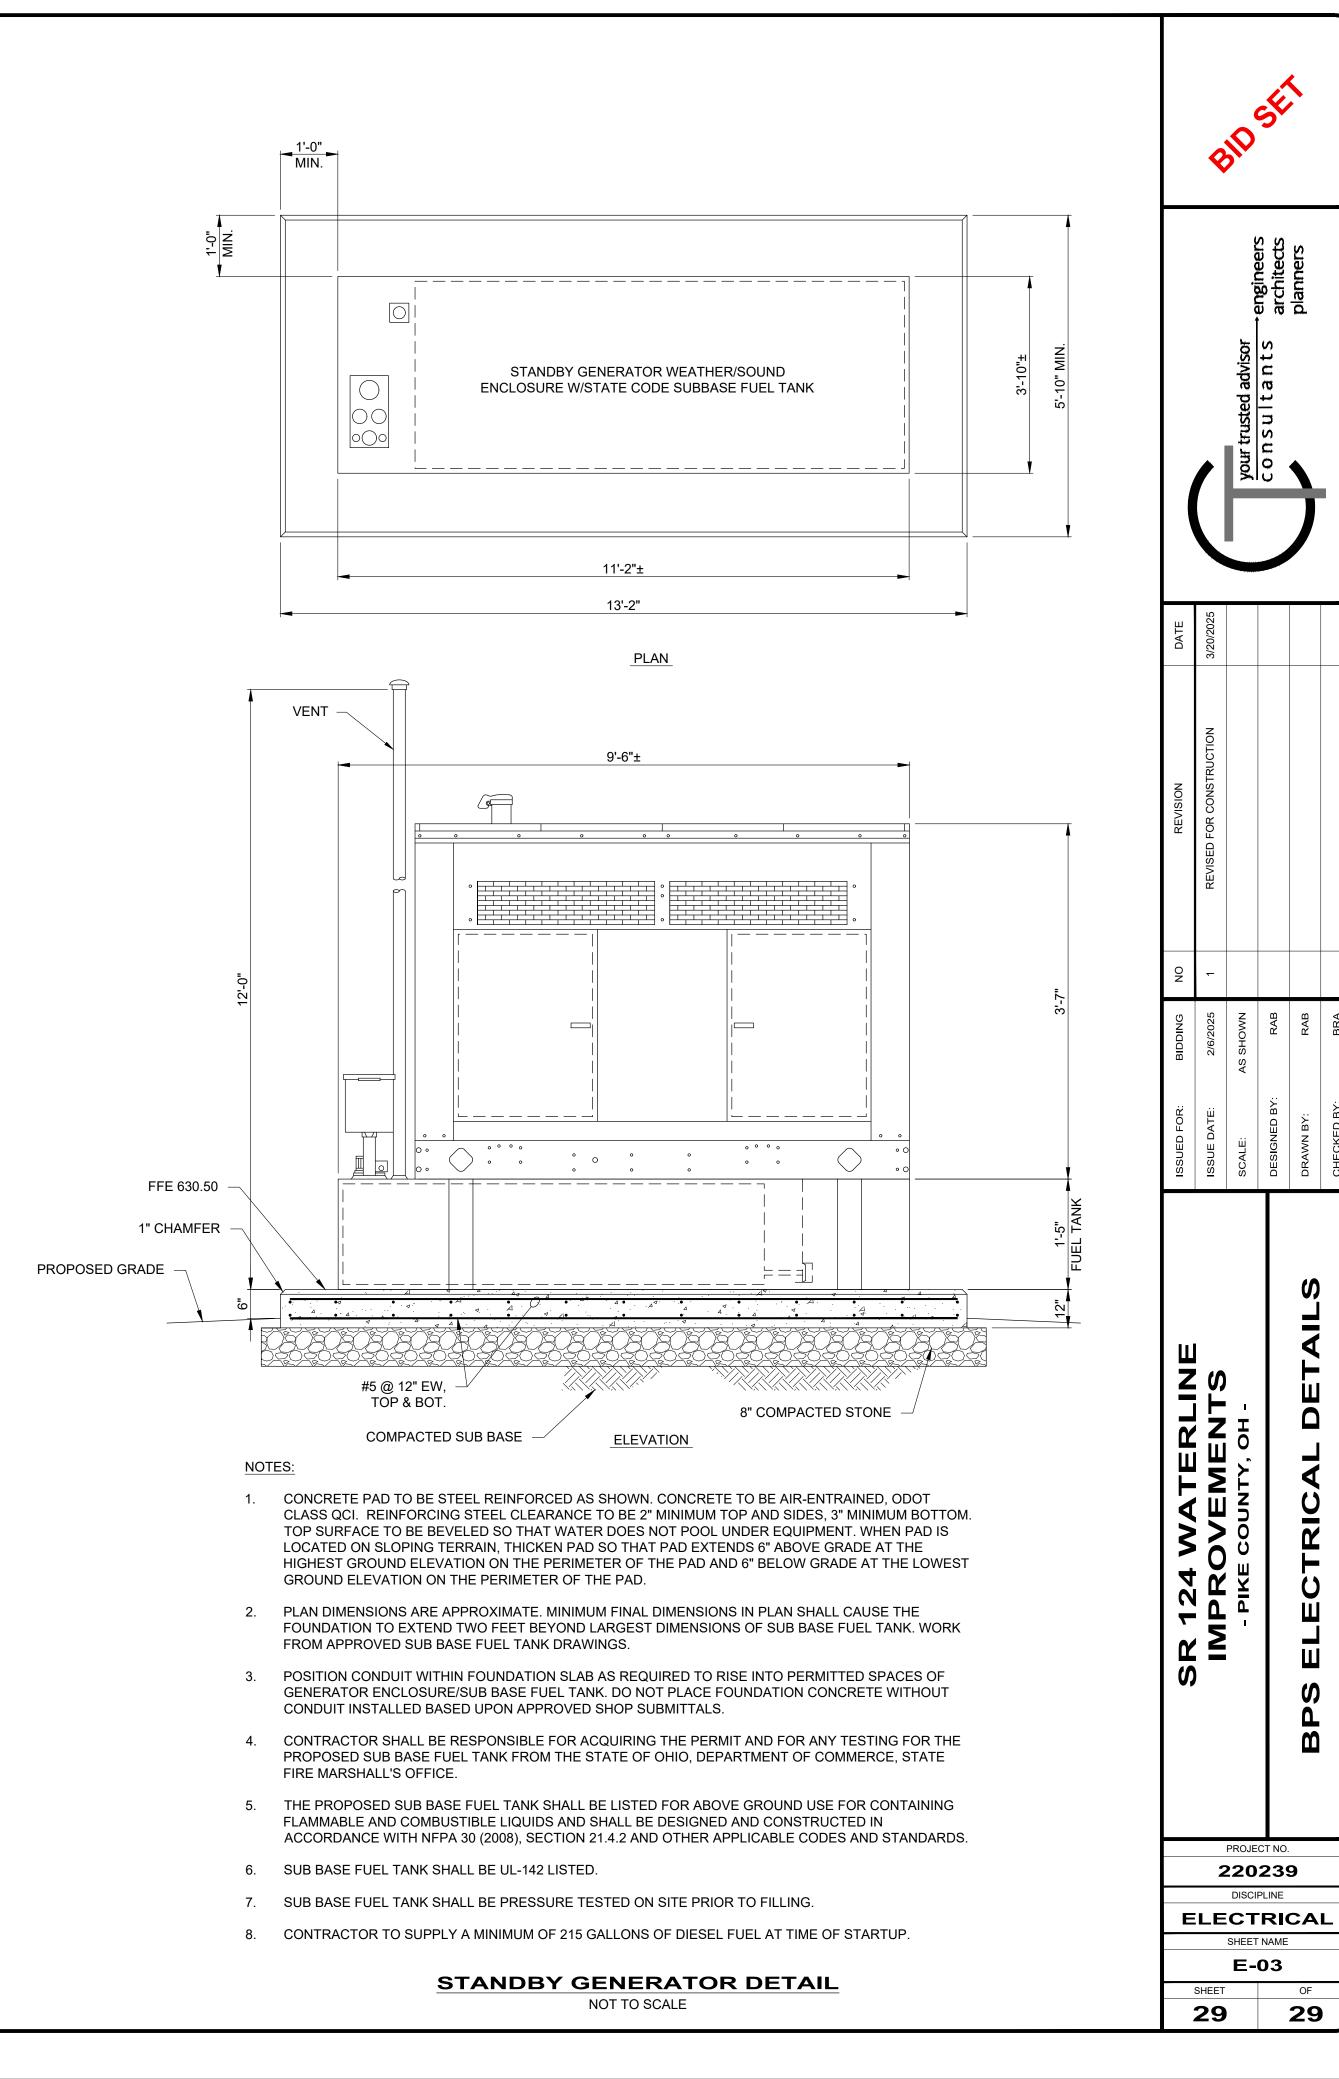

PROJECT NO.

220239


DISCIPLINE

**ELECTRICAL** 

SHEET NAME E-03

29

**29** 

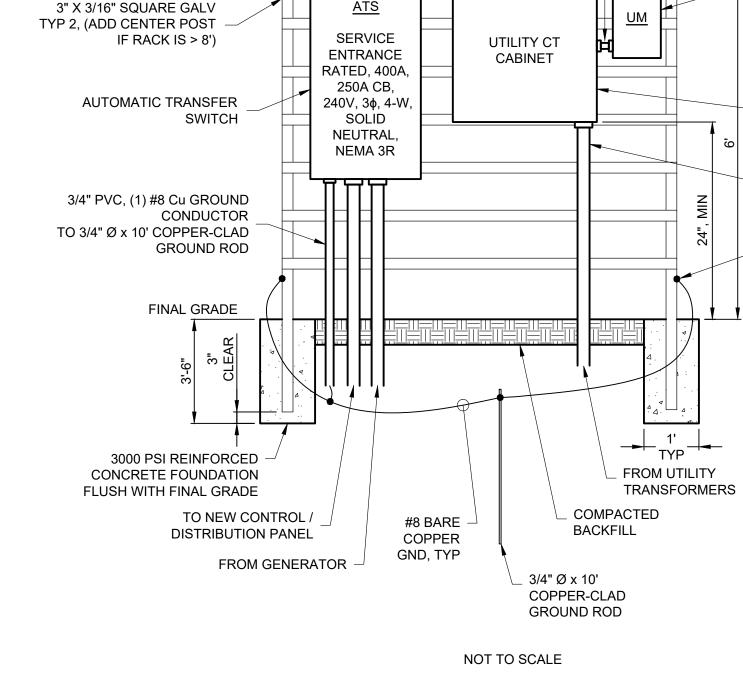

CAP AND WELD UNISTRUT GALV, MFR # P3301

(SPACING AS PER MANUFACTURER)

TYP 2

#### **ELECTRICAL BACKBOARD DETAILS**

NOTE: ALL UTILITY EQUIPMENT SUBJECT TO APPROVAL BY AES OHIO. SEE AES SPECIFICATIONS FOR REFERENCE.

UTILITY METER ENCLOSURE,

3φ, 20A, NEMA 3R, SQUARE-D #USTS131C

UTILITY CT CABINET,

(36" x 36" x 12", MIN.)

- 3"C, TYPICAL, UON

#8 BARE COPPER

GND CONDUCTOR

CONNECTION, TYP

THERMITWELD

NEMA 3R,

OR APPROVED EQUAL

**ELECTRICAL TRENCH DETAIL** NOT TO SCALE

UNDISTURBED \_

ROCK OR SOIL

FINISHED GRADE

SUITABLE BACKFILL

ELECTRICAL WARNING

SCHEDULE 40 PVC

ON DRAWING

CONDUITS. NUMBER OF

CONDUITS AS INDICATED

C:\CT\CAD\\_DRIVES\\_H\2022\220239\DWG\SHEETS\\_C\_220239 - BOOSTER DETAILS.DWG - BOOSTER STATION ELECTRICAL DETAILS - 11/27/2024 2:34:45 AM - ADAM DAWSON