NASON BASIN TO GROVE AVENUE STORM SEWER IMPROVEMENTS PHASE 1

ADMINISTRATION

ROBERT A. FIALA, MAYOR

MICHAEL C. LUCAS, DIRECTOR OF LAW

CHER HOFFMAN, DIRECTOR OF FINANCE

RICH PALMISANO, DIRECTOR OF PUBLIC SERVICE

JUDEAN KELLER, DIRECTOR OF PARKS AND RECREATION

TIM LANNON P.E., CITY ENGINEER

COUNCIL

ROBERT E. CARR, WARD 4 & COUNCIL PRESIDENT

JOHN TOMASELLI, WARD 3 & COUNCIL VICE PRESIDENT

KRISTIE SIEVERS, WARD 1

KEN J. KARY, WARD 2

MIKE L. MERHAR, WARD 5

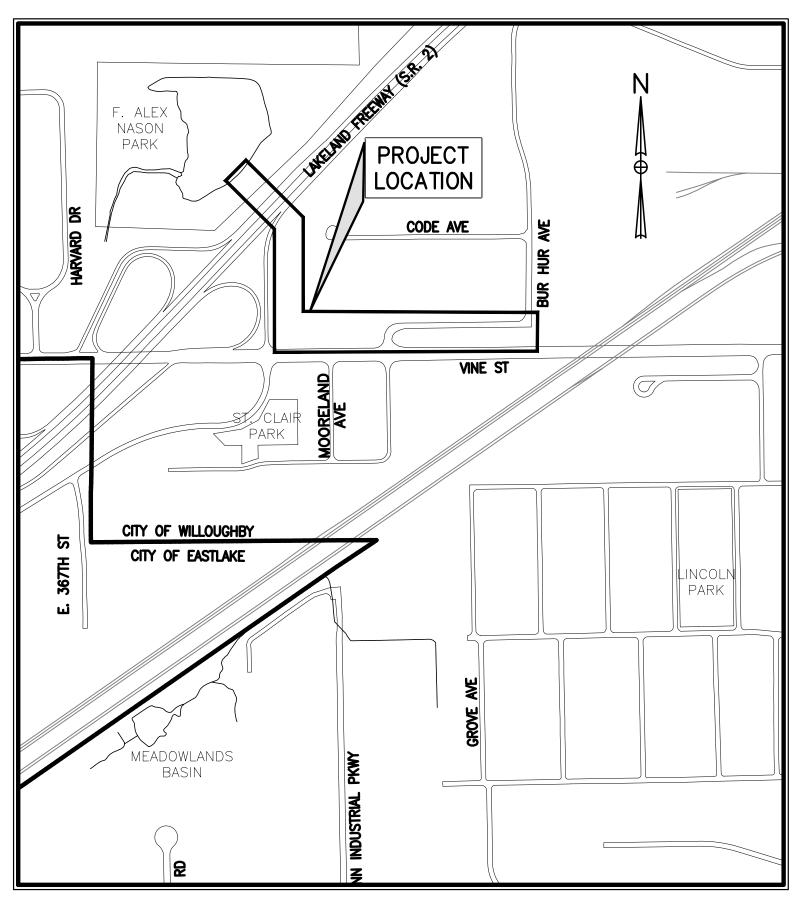
DANIEL J. GARRY, WARD 6

DANIEL J. ANDERSON, COUNCILMAN—AT—LARGE

ALISA NOVAK, CLERK OF COUNCIL

IN THE CITY OF WILLOUGHBY BY THE CITY OF WILLOUGHBY LAKE COUNTY, OHIO

FEBRUARY 2025



LOCATION MAP

NO

THE SURVEY SHOWN ON THESE PLANS WAS OBSERVED IN THE FIELD FOR CONSTRUCTION PURPOSES ONLY AND MAY NOT BE SUITABLE FOR PROPERTY LINE SURVEYS OR ANY OTHER PURPOSE.



2/6/2025

LENE C. HILL. P.I

- E - 6601/

DATE

OHIO811
Before You Dig
1-800-362-2764

CALL TWO WORKING DAYS BEFORE YOU DIG (NON MEMBERS MUST BE CALLED DIRECTLY)

	NO	REVISION
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CITY OF WILLOUGHBY

NASON BASIN TO GROVE AVENUE STORM SEWER IMPROVEMENTS PHASE 1

LAKE COUNTY WILLOUGHBY, OHIO

ISSUED FOR:	BID
ISSUE DATE:	02/07/25
SCALE:	AS SHOWN
DESIGNED BY:	MPC
DRAWN BY:	TJM
CHECKED BY:	LCH

COVER SHEET

PROJECT NO.		
150772		
DISCIPLINE		
CIVIL		
SHEET NAME		
COVER		
SHEET	OF	
01	43	

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NO REVISION DATE

CITY OF WILLOUGHBY

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GENERAL

THE CONTRACTOR SHALL PERFORM ALL OF THE WORK AND FURNISH ALL OF THE LABOR AND MATERIALS NECESSARY FOR THE FINAL COMPLETION OF THIS CONTRACT IN THE MANNER AND UNDER THE CONDITIONS HEREIN SPECIFIED AND PROVIDED AND IN ACCORDANCE WITH THE CONTRACT DRAWINGS.

A PRE-CONSTRUCTION MEETING SHALL BE SCHEDULED BY THE CITY OF WILLOUGHBY ENGINEER PRIOR TO THE COMMENCEMENT OF ANY WORK. IN ADDITION, THE CONTRACTOR SHALL PROVIDE 48 HOUR NOTICE TO THE CITY OF WILLOUGHBY PRIOR TO THE COMMENCEMENT OF WORK.

ACCESS TO ALL DRIVEWAYS WILL BE MAINTAINED AT ALL TIMES EXCEPT THE TIME WHEN SEWER INSTALLATION AND PAVEMENT REPLACEMENT WILL NOT PERMIT.

THE CONTRACTOR SHALL BE RESPONSIBLE FOR SECURING A SITE FOR DISPOSAL OF ALL EXCAVATED MATERIAL THAT IS UNSUITABLE FOR USE AS BACKFILL AND ALL OTHER EXCESS EXCAVATED MATERIALS. THE CONTRACTOR SHALL PROVIDE THE ENGINEER WITH THE LOCATION OF THE DISPOSAL SITE AND WRITTEN PERMISSION FOR USE OF THE SITE FROM THE PROPERTY OWNER. THE CONTRACTOR IS ALSO GIVEN THE OPTION TO USE THE FORMER PELTON ROAD LANDFILL FOR THE DISPOSAL OF REMOVED SOIL. NO OTHER MATERIAL OR WASTE SHALL BE DUMPED AT THIS LOCATION. THE CONTRACTOR WILL PROVIDE EQUIPMENT AND LABOR TO EVENLY SPREAD MATERIAL DISPOSED AT THE PELTON ROAD SITE. THE COST FOR SECURING AND MAINTAINING THE DISPOSAL SITE WILL BE INCLUDED IN THE UNIT PRICES STIPULATED PER LINEAL FOOT OF SEWER.

ALL OVER-THE-ROAD VEHICLES USED ON THE PROJECT BY ALL CONTRACTORS AND SUB-CONTRACTORS WILL BE CLEARLY MARKED SHOWING ITS COMPANY SYMBOL.

BEFORE THE CITY OF WILLOUGHBY WILL APPROVE AND ACCEPT THE WORK AND RELEASE THE GUARANTY RETAINER, THE CONTRACTOR WILL FURNISH THE CITY OF WILLOUGHBY A WRITTEN REPORT INDICATING THE RESOLUTION OF ANY AND ALL PROPERTY DAMAGE CLAIMS FILED WITH THE CONTRACTOR BY ANY PARTY DURING THE CONSTRUCTION PERIOD. THE INFORMATION TO BE SUPPLIED SHALL INCLUDE, BUT NOT BE LIMITED TO, NAME OF CLAIMANT, DATE FILED WITH CONTRACTOR, NAME OF INSURANCE COMPANY AND/OR ADJUSTOR HANDLING CLAIM, HOW CLAIM WAS RESOLVED AND IF CLAIM WAS NOT RESOLVED FOR THE THE FULL AMOUNT, AND A STATEMENT INDICATING THE REASON FOR SUCH ACTION.

THE SURVEY SHOWN ON THESE PLANS WAS OBSERVED IN THE FIELD FOR CONSTRUCTION PURPOSES ONLY, AND MAY NOT BE SUITABLE FOR PROPERTY LINE SURVEYS OR ANY OTHER PURPOSE.

THE CONTRACTOR IS TO TAKE CARE DURING EXCAVATION, PIPE INSTALLATION AND BACKFILLING, IN AREAS IMMEDIATELY ADJACENT TO TREES, TO MINIMIZE THE DISTURBANCE OF ROOT SYSTEMS AND TREE LIMBS. THE COST OF ANY EXTRA EFFORT SUCH AS HAND EXCAVATION IS TO BE INCLUDED IN THE UNIT PRICE BID FOR PIPE INSTALLATION.

MATERIALS FOR "AS-DIRECTED" ITEMS SHALL NOT BE ORDERED OR DELIVERED TO THE PROJECT SITE OR WORK PERFORMED UNTIL AUTHORIZED BY THE ENGINEER.

ALL SHOP DRAWINGS WILL BE SUBMITTED TO THE ENGINEER FOR CHECKING.

THE CONTRACTOR SHALL IMMEDIATELY PROVIDE A CELLULAR PHONE TO ANY RESIDENT OR BUSINESS WHICH MAY LOSE PHONE SERVICE DUE TO CONSTRUCTION ACTIVITIES.

SEWER INSTALLATION

MANHOLE SECTION JOINTS MUST MEET ASTM C-443.

THE CONTRACTOR SHALL INFORM THE ENGINEER WHEN ENCOUNTERING EXISTING STORM AND SANITARY CONNECTIONS NOT SHOWN ON THE PLANS OR CONNECTIONS THAT MAY PRESENT A CONFLICT WITH THE INTENT OF THE PROPOSED SEWER LINES. IT SHALL BE THE CONTRACTOR'S RESPONSIBILITY TO PROVIDE THE ENGINEER WITH INFORMATION ON ELEVATION AND NATURE OF CONNECTIONS IN QUESTION. ROOF DRAINS, FOUNDATION DRAINS AND OTHER CLEAN WATER CONNECTIONS TO THE SANITARY SEWER SYSTEM ARE PROHIBITED.

THE COST FOR FURNISHING ALL MATERIAL AND LABOR TO PERFORM ALL WORK STATED IN THE SEWER INSTALLATION NOTES SHALL BE INCLUDED IN THE BID PRICES STIPULATED FOR VARIOUS ITEMS IN THE BID PROPOSAL.

MATERIAL AND TESTING PERMITS

THE CONTRACTOR SHALL BE RESPONSIBLE FOR THE COST OF ALL MATERIAL AND EQUIPMENT TESTING. THE CONTRACTOR SHALL BE RESPONSIBLE FOR OBTAINING ALL PERMITS REQUIRED FOR THIS PROJECT. THE EXECUTED PROJECT CONTRACT SHALL SERVE TO FULFILL THE CITY OF WILLOUGHBY'S PERMITTING REQUIREMENTS.

EXISTING GAS MAINS

ONE FOOT MINIMUM VERTICAL AND HORIZONTAL CLEARANCE MUST BE MAINTAINED BETWEEN ENBRIDGE'S (FORMERLY DEO) AND THE NORTHEAST OHIO NATURAL GAS CORPORATION'S EXISTING PIPELINE(S) AND ALL OTHER IMPROVEMENTS. IT IS THE CONTRACTOR'S RESPONSIBILITY TO MAINTAIN THE LATERAL AND SUBJACENT SUPPORT OF THE PIPELINE(S), IN COMPLIANCE TO 29 CFR, PART 1926, SUBPART P, (SAFE EXCAVATION & SHORING). EXTREME CARE SHOULD BE TAKEN NOT TO HARM ANY NATURAL GAS FACILITY OR APPURTENANCE. NOTIFY ENBRIDGE AND/OR THE NORTH EAST OHIO NATURAL GAS CORPORATION IMMEDIATELY IF ANY HARM HAS BEEN INFLICTED UPON THEIR RESPECTIVE FACILITIES (PIPELINES, ETC.) OR APPURTENANCES THERETO (PIPE COATING, TRACER WIRE, CATHODIC PROTECTION WIRES AND DEVICES, TEST SITES, VALVE BOXES, ETC.).

ENBRIDGE / NORTH EAST OHIO NATURAL GAS CORPORATION SHALL BE RESPONSIBLE FOR ALL RELOCATIONS OF THEIR GAS MAIN FACILITIES AS REQUIRED, INCLUDING HOUSE CONNECTIONS AND VALVE BOX RELOCATIONS. THE CONTRACTOR SHALL BE RESPONSIBLE FOR VALVE BOX AND ALL OTHER GAS MAIN APPURTENANCE ADJUSTMENTS TO GRADE. THE CONTRACTOR SHALL BE RESPONSIBLE FOR COORDINATING HIS WORK WITH BOTH GAS SUPPLIERS SO THAT COMPLETION OF HIS WORK IS NOT DELAYED BY THE SUPPLIERS' WORK. THE CONTRACTOR SHALL NOTIFY ENBRIDGE AND/OR THE NORTH EAST OHIO NATURAL GAS CORPORATION AT LEAST 48 HOURS IN ADVANCE OF ANY WORK WHICH MAY AFFECT THEIR SYSTEMS.

EXISTING UTILITIES

THE LOCATIONS OF THE UNDERGROUND UTILITIES SHOWN ON THE PLANS HAVE BEEN OBTAINED BY DILIGENT FIELD CHECKS AND SEARCHES OF AVAILABLE RECORDS. IT IS BELIEVED THAT THEY ARE ESSENTIALLY CORRECT, BUT THE CITY OF WILLOUGHBY DOES NOT GUARANTEE THEIR ACCURACY OR COMPLETENESS. PRIVATE UTILITY CONNECTIONS TO BUILDINGS MAY NOT BE SHOWN, I.E. GAS, WATER, STORM, ELECTRIC.

BEFORE ANY WORK IS STARTED THAT WILL INTERFERE WITH THE EXISTING UTILITIES, THE CONTRACTOR SHALL CALL THE "OHIO UTILITIES PROTECTION SERVICE" AT 1-800-362-2764, FORTY-EIGHT (48) HOURS IN ADVANCE OF WORK. NON-MEMBER UTILITIES MUST BE CONTACTED DIRECTLY. THE CONTRACTOR SHALL TAKE ALL NECESSARY PRECAUTIONS, AT NO ADDITIONAL EXPENSE TO THE CITY OF WILLOUGHBY, TO AVOID DAMAGE TO EXISTING UNDERGROUND AND OVERHEAD UTILITY LINES DURING THE ENTIRE PROJECT. IN THE EVENT OF DAMAGE TO EXISTING PUBLIC AND/OR PRIVATE UTILITIES, THE AGENCY CONCERNED SHALL BE NOTIFIED IMMEDIATELY AND ALL REPAIR WORK SHALL BE EXECUTED IN ACCORDANCE WITH THE SPECIFICATIONS OF THE RESPECTIVE AGENCY AT NO ADDITIONAL EXPENSE TO THE CITY OF WILLOUGHBY INCLUDING ANY INSPECTION FEES OR MAINTENANCE CREWS.

WHERE EXISTING POWER OR TELEPHONE POLES ARE IN CLOSE PROXIMITY TO WORK, THE CONTRACTOR SHALL COORDINATE HIS WORK EFFORTS WITH THOSE OF THE UTILITY COMPANIES SUCH THAT THEIR EXISTING FACILITIES CAN BE MAINTAINED AND PROTECTED DURING THE TIME WORK IS GOING ON ADJACENT TO THE POLE. THE COST FOR ANY REQUIRED PROTECTION OR RELOCATION OF EXISTING POWER OR TELEPHONE POLES SHALL BE THE RESPONSIBILITY OF THE CONTRACTOR AND NOT BE THE RESPONSIBILITY OF THE CITY.

DELAYS TO THE CONTRACTOR AS A RESULT OF TIMING OF POLE RELOCATION OR PROTECTION SHALL NOT BE CONSIDERED COMPENSABLE DELAYS, AS IT SHALL BE THE CONTRACTOR'S RESPONSIBILITY TO COORDINATE HIS WORK IN CONFORMANCE TO THE UTILITY COMPANY'S SCHEDULE.

THE CONTRACTOR SHALL ANTICIPATE ONE SERVICE CONNECTION FOR EACH UTILITY SHOWN TO EACH PROPERTY. IF ANY OF THE EXISTING SERVICE CONNECTIONS ARE DISTURBED OR DAMAGED DURING CONSTRUCTION THE CONTRACTOR IS TO REPLACE THEM AT NO ADDITIONAL COST TO THE OWNER. IF ANY WATER SERVICE CONNECTIONS ARE DISTURBED OR DAMAGED DURING CONSTRUCTION THE CONTRACTOR SHALL REPLACE THE SERVICE CONNECTION WITH TYPE "K" COPPER FROM THE CORPORATION STOP TO THE CURB STOP.

THE UTILITY OWNERSHIPS ARE AS FOLLOWS:

THE CITY OF WILLOUGHBY
ATTN: RICH PALMISANO, PUBLIC SERVICE DIR.
ONE PUBLIC SQUARE
WILLOUGHBY, OHIO 44094
PHONE: (440) 953-4110
RPALMISANO@WILLOUGHBYOHIO.COM

THE ILLUMINATING COMPANY 6896 MILLER ROAD, SUITE 110 BRECKSVILLE, OHIO 44141 PHONE: (440) 717-6845 CELL: (440) 550-9001

AT&T
ATTN: JAMES JANIS
13630 LORAIN ROAD, 2ND FLOOR
CLEVELAND, OHIO 44111
PHONE: (216) 476-6142

OHIO UTILITY PROTECTION SERVICE PHONE: 1(800) 362-2764

LAKE COUNTY DEPARTMENT OF UTILITIES ATTN: RANDY ROTHLISBERGER
105 MAIN STREET
PAINESVILLE, OHIO 44077
PHONE: (440) 350-2645

ENBRIDGE GAS OHIO 320 SPRINGSIDE DRIVE, SUITE 320 AKRON, OHIO 44333 PHONE: (330) 664–2409

NORTHEAST OHIO NATURAL GAS CORPATTN: TIM REILLY, EIS COORDINATOR 8470 STATION STREET MENTOR, OHIO 44060 PHONE: (440) 701-5100 CELL: (440) 728-0575

AIR PRODUCTS
ATTN: JIM JONES
1940 AIR PRODUCTS BOULEVARD
ALLENTOWN, PA 18106
PHONE: (610) 481-4911

TIME WARNER CABLE ATTN: DAVE DETORE 7820 DIVISION DRIVE MENTOR, OHIO 44060 PHONE: (440) 361-0023

SERVICE CONNECTIONS

1. ALL EXISTING UTILITY SERVICE CONNECTIONS (SANITARY, STORM, WATER, GAS, ELECTRIC, TELEPHONE, ETC.) WHICH ARE DAMAGED DURING CONSTRUCTION OPERATIONS SHALL BE REPAIRED WITH LIKE MATERIALS OR REPLACED, AS REQUIRE. THE COST OF UTILITY SERVICE CONNECTION REPAIR/REPLACEMENT SHALL BE INCLUDED IN THE UNIT PRICES FOR ALL ITEMS IN THE PROPOSAL.

2. ALL UTILITY LINES CROSSING THE NEW TRENCH SHALL BE PROTECTED AND SUPPORTED WITH HARDWOOD PLANKS; OR REMOVED, REPLACED, RECONNECTED AND SUPPORTED ACROSS THE ENTIRE WIDTH OF THE TRENCH. IF ANY OF THESE LINES ARE DAMAGED DURING CONSTRUCTION, THEY SHALL BE REPLACED IN—KIND.

3. THE CONTRACTOR SHALL BE REQUIRED TO BYPASS AND MAINTAIN THE FLOW TO/FROM ALL HOUSE UTILITY CONNECTIONS DURING CONSTRUCTION.

4. THE CONTRACTOR SHALL EXPECT ONE UNDERGROUND STORM SEWER, SANITARY SEWER, GAS AND WATER CONNECTION FOR EACH LOT (INCLUDING CORNER AND VACANT LOTS) ON BOTH SIDES OF THE STREET FOR THE ENTIRE PROJECT LENGTH, EXCEPT AS NOTED ON THE PLANS.

5. THE COST OF UTILITY RELOCATION, REPLACEMENT, AND/OR SUPPORT SHALL BE INCLUDED IN THE COST PER LINEAL FOOT OF PROPOSED STORM SEWER.

DATE

LAKE COUNTY

STORM SEWER LATERAL CONNECTIONS

EXISTING STORM SEWER LATERAL CONNECTIONS TO BE TIED IN TO THE PROPOSED STORM SEWER SHALL BE TIED IN USING INSERTA—TEES AND RE—CONNECTED TO EXISTING LATERALS USING FERNCO TRI—BAND COUPLINGS. INSERTA—TEES AND COUPLINGS TO BE INCLUDED IN THE UNIT BID PRICE FOR 6" STORM STORM SEWER. THE PAY LIMIT FOR SAID RE—CONNECTIONS SHALL BE THE SPAN OF THE PROPOSED STORM SEWER TRENCH.

TREE/VEGETATION PROTECTION

ANY LANDSCAPING AND LAWNS DISTURBED BY CONSTRUCTION WORK SHALL BE RESTORED TO ITS ORIGINAL CONDITION AT NO ADDITIONAL COST TO THE CITY.

NO TREE REMOVAL WILL BE PERMITTED WITHOUT PERMISSION OF THE CITY.

TREES WHICH ARE NOT REMOVED WILL BE PROTECTED.

THE COST FOR REMOVAL AND/OR PROTECTION OF TREES THAT ARE IN CONFLICT WITH THE INSTALLATION OF THE SEWER AND LATERALS SHALL BE INCLUDED IN THE UNIT PRICE BID FOR SEWER.

THE CONTRACTOR'S ARBORIST SHALL REPAIR ALL INJURIES TO BARK, LIMBS AND ROOTS OF REMAINING VEGETATION BY PROPERLY DRESSING, CUTTING BRACING AND PAINTING, USING ONLY APPROVED TREE SURGERY METHODS, TOOLS AND MATERIALS.

TREE REMOVAL WILL BE LIMITED TO THAT NECESSARY FOR CONSTRUCTION AND WILL BE LIMITED FURTHER TO THE PERMANENT EASEMENT WHEREVER POSSIBLE.

NO TREE REMOVAL WILL BE PERMITTED OUTSIDE THE TEMPORARY EASEMENT WITHOUT PERMISSION OF THE ENGINEER

PRIOR TO CLEARING, THE CONTRACTOR AND ENGINEER SHALL WALK THE ACQUIRED EASEMENTS IN AN EFFORT TO DESIGNATE THE TREES THAT ARE TO BE SAVED. TREES TO BE SAVED WILL BE CLEARLY MARKED BY PAINT WITH THE LETTER "S". TREES TO BE PROTECTED BY AN APPROPRIATE BARRIER SHALL BE MARKED WITH AN "S" ENCLOSED IN A CIRCLE.

SOIL AND OTHER MATERIAL WILL NOT BE STORED NEXT TO OR WITHIN THE DRIPLINE OF TREES.

PRESERVATION OF LANDSCAPING SHOULD TAKE PRECEDENCE OVER REMOVAL. IF REMOVAL OR DAMAGE IS UNAVOIDABLE, EXISTING VEGETATION SHOULD BE REPAIRED OR REPLACED "IN-KIND" UNLESS THE HOMEOWNER SPECIFIES OTHERWISE.

IF TREES/SHRUBS CANNOT BE REPLACED IN THE SAME LOCATION DUE TO THE INSTALLATION OF THE SEWER SYSTEM, RELOCATION SHOULD BE CONSIDERED.

SELECTIVE PRUNING OF TREE LIMBS PRIOR TO INITIATION OF CONSTRUCTION SHOULD ONLY BE USED WITHIN ESTABLISHED EASEMENTS WHERE REMOVAL IS NECESSARY FOR OPERATION OF EQUIPMENT.

LIMIT THE USE OF RIPRAP TO AREAS WHERE STREAM FLOW CONDITIONS PREEMPT VEGETATIVE STABILIZATION.

TREE AND NATURE PRESERVATION SHOULD FOLLOW THE OHIO DEPARTMENT OF NATURAL RESOURCE'S (ODNR) RAINWATER AND LAND DEVELOPMENT MANUAL SECTION 7.3.

TRAFFIC CONTROL

AT LEAST ONE LANE OF TRAFFIC MUST BE MAINTAINED ALONG THE TRAVEL ROUTE TO THE CONSTRUCTION SITE.

ACCESS MUST BE MAINTAINED FOR EMERGENCY VEHICLES AT ALL TIMES.

NO TRENCH WILL BE LEFT OPEN AT THE END OF A WORKDAY, WHERE PRACTICAL; ANY OPEN TRENCH WILL BE PROPERLY IDENTIFIED AND BARRICADED FOR SAFETY PURPOSES.

ANY CONSTRUCTION EQUIPMENT OR EXCAVATIONS NEAR ROADS MUST BE MARKED WITH LIGHTS OR REFLECTORS.

THE CONTRACTOR SHALL PROVIDE, ERECT AND MAINTAIN ALL NECESSARY BARRICADES, WARNING SIGNS, DANGER SIGNALS, FLAG PERSON(S), WATCHERS, AND ALL OTHER APPROPRIATE PRECAUTIONS NECESSARY FOR THE PROTECTION OF THE WORK AND FOR SAFETY.

PRIOR TO CLOSING OFF CLEAR ACCESS TO ANY PUBLIC ALLEY, STREET, ROAD, AVENUE, OR BOULEVARD, THE CONTRACTOR MUST HAVE CONSENT FROM LOCAL OFFICIALS AND THE ENGINEER.

AIR/NOISE CONTROL

CONSTRUCTION ACTIVITIES WILL BE LIMITED TO WEEKDAYS FROM 7 AM TO 9 PM, UNLESS APPROVED IN ADVANCE BY THE CITY.

CONSTRUCTION EQUIPMENT WILL BE PROVIDED WITH INTAKE SILENCERS AND MUFFLERS, AS REQUIRED BY SAFETY STANDARDS.

ALL CONSTRUCTION VEHICLES SHOULD BE EQUIPPED WITH PROPER EMISSIONS CONTROL EQUIPMENT.

PERIODICALLY CHECK EQUIPMENT AND MACHINERY FOR PROPER TUNING TO MINIMIZE EXHAUST EMISSIONS AND NOISE.

UNPAVED AREAS WILL BE WET DOWN (AS NECESSARY) DURING CONSTRUCTION TO MINIMIZE DUST GENERATION.

MONUMENT PROTECTION

PROPERTY PINS AND MONUMENTS ALONG THE ROUTE OF THE IMPROVEMENT, WHICH MAY BE DISTURBED BY THE CONTRACTOR, SHALL BE REFERENCED BY A PROFESSIONAL SURVEYOR, SO THEY CAN BE REPLACED IN THE EVENT THAT THEY ARE DISTURBED DURING CONSTRUCTION. THE CONTRACTOR SHALL TAKE PRECAUTIONS TO PROTECT ALL PINS, MONUMENTS AND REFERENCES. THE CONTRACTOR SHALL BE RESPONSIBLE FOR THE COST OF LOCATING AND REFERENCING AND REPLACING THE PROPERTY PINS AND MONUMENTS DISTURBED AND/OR AS DIRECTED BY THE ENGINEER.

DEWATERING

ALL DEWATERING FLOWS ARE TO BE SETTLED IN SILTATION BASINS OR DIRECTED THROUGH FILTERING DEVICES BEFORE DISCHARGE TO STABILIZED SITES, SUCH AS STREAMS OR STORM SEWERS; NOT ONTO EXPOSED SOILS, STREAM BANKS, OR ANY OTHER SITE WHERE THE FLOW COULD CAUSE EROSION.

SILT FROM CONSTRUCTION OPERATIONS SHALL NOT BE PERMITTED TO ENTER THE STORM SEWER SYSTEM. WHEN CONSTRUCTION OCCURS NEAR STORM SEWER INLETS, EROSION CONTROL MEASURES SUCH AS INLET FILTERS AND HAY BALES SHALL BE USED TO PREVENT SILT FROM ENTERING THE STORM SEWERS.

CONVEY WATER FROM THE CONSTRUCTION SITE IN A CLOSED CONDUIT. DO NOT USE TRENCH EXCAVATIONS AS TEMPORARY DRAINAGE DITCHES.

ARCHAEOLOGICAL/HISTORICAL RESOURCES

CONTRACTORS AND SUBCONTRACTORS ARE REQUIRED UNDER OHIO REVISED CODE (O.R.C.) SECTION 149.53, TO NOTIFY OHIO'S STATE HISTORIC PRESERVATION OFFICE (SHPO), AND TO COOPERATE WITH THAT OFFICE IN ARCHAEOLOGICAL AND HISTORIC SURVEYS AND MITIGATION EFFORTS IF SUCH DISCOVERIES ARE UNCOVERED WITHIN THE PROJECT AREA.

CONTACT: OHIO STATE HISTORIC PRESERVATION OFFICE KRISTEN KOEHLINGER, RESOURCE PROTECTION & REVIEW DEPARTMENT HEAD PHONE: 1-614-298-2000

EMAIL: KKOEHLINGER@OHIOHISTORY.ORG

GROUND WATER/DRINKING WATER PROTECTION

CONSTRUCTION ACTIVITY WILL OCCUR WITHIN A DRINKING WATER SOURCE PROTECTION AREA OR DESIGNATED SOLE SOURCE AQUIFER. A CHEMICAL SPILL IN THIS AREA POSES A THREAT TO THE DRINKING WATER.

MINIMIZE QUANTITIES OF BULK FLUIDS RELATED TO CONSTRUCTION ACTIVITIES IN THE PROJECT AREA AND STORE BULK FLUIDS OUTSIDE OF THE SANITARY ISOLATION RADIUS OF ALL EXISTING DRINKING WATER WELLS IN AN APPROPRIATELY DESIGNED APPARATUS THAT PROVIDES BOTH SAFE STORAGE AND EFFECTIVE SPILL CONTAINMENT.

AVOID EQUIPMENT MAINTENANCE ACTIVITIES WITHIN THE DRINKING WATER SOURCE PROTECTION AREA.

REPORT ALL SPILLS TO THE APPLICANT AND TO THE OHIO EPA SPILL HOTLINE AT 1-800-282-9378.

POST THE OHIO EPA EMERGENCY SPILL HOTLINE NUMBER (1-800-282-9378) AT THE PROJECT SITE.

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RE-60

verdantas No REVISION

CITY OF WILLOUGHBY

NASON BASIN TO GROVE AVENUE STORM SEWER IMPROVEMENTS PHASE 1

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GENERAL NOTES 1

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43

PROJECT CONSTRUCTION ZONE.

THE CONTRACTOR SHALL CLEAN UP ALL DEBRIS AND MATERIALS RESULTING FROM HIS OPERATION AND RESTORE ALL SURFACES, STRUCTURES, DITCHES AND PROPERTY TO ITS ORIGINAL CONDITION TO THE SATISFACTION OF THE ENGINEER.

ALL EXISTING STORM AND SANITARY SEWER FACILITIES, INCLUDING TILE, DAMAGED DURING CONSTRUCTION SHALL BE REPAIRED, REPLACED OR RECONNECTED TO THE EXISTING OR PROPOSED SYSTEM AS DIRECTED BY THE ENGINEER AT NO COST TO THE OWNER.

MATERIAL SPECIFICATIONS

THE MATERIAL SPECIFICATIONS ON THE PLANS REPRESENT THE MINIMUM REQUIRED FOR EACH APPLICATION. THE OWNER MAY REQUEST OR THE CONTRACTOR MAY DESIRE TO SUBSTITUTE ALTERNATE MATERIALS. ANY SUCH SUBSTITUTIONS MUST BE EQUIVALENT IN QUALITY TO THE MATERIAL CALLED FOR AND MUST BE APPROVED IN WRITING BY THE APPROVING AGENCIES AND THE ENGINEER.

ALL STORM SEWER SHALL BE HIGH PERFORMANCE POLYPROPYLENE (HPPP) DUAL WALL, SMOOTH INTERIOR, WT PIPE; UNLESS OTHERWISE SHOWN ON PLANS

- 1. BELL AND SPIGOT JOINTS SHALL MEET ASTM D3212 FOR WATER TIGHT (WT) INSTALLATION.
- 2. MAXIMUM PERMITTED DIAMETER FOR DUAL WALL (PP), (WT) SHALL BE 24 INCHES;
- 3. MAXIMUM PERMITTED DIAMETER EXCEEDING 24 INCH SHALL BE THE TRIPLE WALL, (HPPP), UP TO 60 INCHES OR UNLESS NOTED AS A SPECIFIC PIPE MANUFACTURER CALL OFF i.e. FLOWTITE.
- 4. STORM SEWER MAIN GREATER THAN 60 INCH PIPE SHALL HIGH PERFORMANCE BELL AND SPIGOT DUROMAXX STEEL REINFORCED POLYETHYLENE.
- 5. THE CARRIER PIPE FOR THE ROADWAY RIB & LAGGING TUNNEL SHALL BE HIGH PERFORMANCE BELL AND SPIGOT DUROMAXX STEEL REINFORCED POLYETHYLENE OR APPROVED EQUAL. GROUT PORTS AND ROUND SKID RAIL TUBING AT THE CONTRACTOR'S DISCRETION.
- 6. SANITARY SEWER LATERALS BEING RELOCATED FOR CONFLICTS SHALL BE SDR 26 PVC.

STORM SEWER LATERALS (6 INCH DIA.) AND INLET CROSSOVERS (8 INCH DIA.) SHALL BE PVC SDR 26 WITH VARIOUS BEND CONFIGURATIONS ALLOWING FOR MIN. 1 % FALL ALONG PIPE RUNS.

SEWER MAIN CONNECTIONS TO EXISTING SEWERS SHALL BE MADE WITH EITHER FERNCO COUPLINGS WITH SS SHEAR BANDS TO MATCH PROPOSED/EXISTING PIPE SIZE AND TYPE, OR APPROVED EQUAL.

ALL LATERAL TIE-INS TO EXISTING SEWERS TO BE MADE WITH INSERTA-TEES.

THE CONTRACTOR SHALL PROVIDE Z-LOK SEALS FOR THE NEW PRECAST STRUCTURES THAT FIT-UP WITH THE CORRUGATED HPPP AND RCP. WHERE REQUIRED AND NEEDED AS A RESULT OF THE INABILITY TO USE THE Z-LOK, AN A-LOK COMPRESSION SEAL MAY BE USED ALONG WITH A SMOOTH OUTSIDE WALL PIPE ADAPTER OR BY THE USE OF A POLYPROPYLENE OVER-SLEEVE OR SMOOTH OUTSIDE PIPE WALL.

WHERE PIPE ANGLES AND PIPE CENTERLINE CLEARANCES WILL NOT ALLOW THE USE OF THE Z-LOK AND Z-LOK COMPRESSION SEALS, AT A MINIMUM AN A-LOK WATERSTOP SEAL AND GROUTED JOINT SHALL BE UTILIZED.

EXISTING AND PROPOSED SANITARY SEWER FACILITIES

THE CONTRACTOR SHALL BE RESPONSIBLE FOR ALL RELOCATING, ADJUSTMENTS OR ADDITIONS TO THE EXISTING SANITARY SEWER FACILITIES AS CALLED FOR ON THE PLANS OR REQUIRED BY THE WORK, INCLUDING ALL COSTS ASSOCIATED WITH INSPECTION OF SANITARY SEWER FACILITIES. THE CONTRACTOR SHALL NOTIFY THE CITY OF WILLOUGHBY AT LEAST 48 HOURS IN ADVANCE OF ANY WORK IN THEIR SYSTEM. THE CONTRACTOR SHALL BE RESPONSIBLE FOR SCHEDULING INSPECTION DIRECTLY WITH THE THE ENGINEER'S REPRESENTATIVE.

ALL SANITARY SEWER AND APPURTENANCES SHALL BE CONSTRUCTED IN ACCORDANCE WITH THE RULES, STANDARDS AND SPECIFICATIONS OF THE CITY OF WILLOUGHBY AND SHALL BE REVIEWED, TESTED AND APPROVED BY PLAN SPECIFICATION REQUIREMENTS.

STORM JUNCTION CHAMBERS:

THE CONTRACTOR SHALL FIELD POUR 12 INCH SHAPED FLOW CHANNELS (SHELF) IN EACH JUNCTION CHAMBER. CONCRETE SHALL BE 3000 PSI MINIMUM AND AIR

SOIL EROSION AND SEDIMENT CONTROLS

THE CONTRACTOR SHALL FOLLOW POLLUTION CONTROL MEASURES IN ACCORDANCE WITH SECTION 013543 OF THE DETAILED SPECIFICATIONS.

THE CONTRACTOR SHALL PROVIDE TEMPORARY EROSION CONTROL IN ACCORDANCE WITH THE PLANS, SPECIFICATIONS AND ODOT SUPPLEMENTAL SPECIFICATION 832. STORMWATER POLLUTION PREVENTION PLANS AND DETAILS ARE PROVIDED AS MINIMUM REQUIREMENTS FOR ENVIRONMENTAL PROTECTION.

SOIL STABILIZATION MEASURES SHALL FOLLOW THE OHIO DEPARTMENT OF NATURAL RESOURCE'S (ODNR) RAINWATER AND LAND DEVELOPMENT MANUAL CHAPTERS 4-7.

THE CONTRACTOR IS RESPONSIBLE FOR PROVIDING AN SPW3 FOR ANY DISPOSAL SITE.

ENVIRONMENTAL PROTECTION - PROHIBITED CONSTRUCTION ACTIVITIES

DISPOSING OF EXCESS OR UNSUITABLE EXCAVATED MATERIAL IN WETLANDS OR FLOOD PLAINS, EVEN WITH THE PERMISSION OF THE PROPERTY OWNER AND APPROPRIATE

LOCATING STOCKPILE STORAGE AREAS IN ENVIRONMENTALLY SENSITIVE AREAS.

INDISCRIMINATE, ARBITRARY OR CAPRICIOUS OPERATION OF EQUIPMENT IN ANY STREAM CORRIDORS, WETLANDS, SURFACE WATERS OR OUTSIDE THE EASEMENT LIMITS.

PUMPING OF SEDIMENT-LADEN WATER FROM TRENCHES OR OTHER EXCAVATIONS DIRECTLY INTO ANY SURFACE WATERS, STREAM CORRIDORS, WETLANDS OR STORM SEWERS; ALL SUCH WATER WILL BE PROPERLY FILTERED OR SETTLED TO REMOVE SILT PRIOR TO RELEASE.

DISCHARGING POLLUTANTS SUCH AS CHEMICALS, FUELS, LUBRICANTS, BITUMINOUS MATERIALS, RAW SEWAGE AND OTHER HARMFUL WASTE INTO OR ALONGSIDE OF RIVERS, STREAMS, IMPOUNDMENTS OR INTO NATURAL OR MAN-MADE CHANNELS LEADING THERETO.

PERMANENT OR UNSPECIFIED ALTERATION OF THE FLOW LINE OF ANY STREAM.

DAMAGING ANY VEGETATION OUTSIDE OF THE CONSTRUCTION AREA.

DISPOSAL OF TREES, BRUSH, AND OTHER DEBRIS IN ANY STREAM CORRIDORS, WETLANDS, SURFACE WATERS OR AT UNSPECIFIED LOCATIONS.

OPEN BURNING OF PROJECT DEBRIS WITHOUT A PERMIT.

DISCHARGING INJURIOUS SILICA DUST CONCENTRATIONS INTO THE ATMOSPHERE RESULTING FROM BREAKING, CUTTING, CHIPPING, DRILLING, BUFFING, GRINDING, POLISHING, SHAPING OR SURFACING CLOSER THAN 200 FEET TO PLACES OF RESIDENCES OR COMMERCIAL, PROFESSIONAL, QUASI-PUBLIC OR PUBLIC PLACES OF HUMAN OCCUPATION.

STORING CONSTRUCTION EQUIPMENT AND VEHICLES AND/OR STOCKPILING CONSTRUCTION MATERIALS ON PROPERTY, PUBLIC OR PRIVATE, NOT PREVIOUSLY SPECIFIED ON THE PLANS BY THE ENGINEER FOR SUCH PURPOSES.

RUNNING WELL POINT OR PUMP DISCHARGE LINES THROUGH PRIVATE PROPERTY OR PUBLIC PROPERTY AND RIGHT-OF-WAY WITHOUT THE WRITTEN PERMISSION OF THE OWNER AND THE CONSENT OF THE ENGINEER.

OPERATIONS ENTAILING THE USE OF VIBRATORY HAMMERS OR COMPACTORS OUTSIDE THE HOURS OF 8:00 A.M. AND 5:00 P.M. OR OUTSIDE THE HOURS ALLOWED FOR CONSTRUCTION BY LOCAL ORDINANCES OR REGULATIONS.

CLOSING OFF CLEAR ACCESS TO ANY PUBLIC ALLEY, STREET, ROAD, AVENUE OR BOULEVARD WITHOUT THE PRIOR CONSENT OF MUNICIPAL OFFICIALS AND THE ENGINEER AND CLOSING CLEAR ACCESS:

- 1. BY FIRE PROTECTION EQUIPMENT AND EMERGENCY VEHICLES.
- 2. BY THE PUBLIC TO ANY COMMERCIAL OR PROFESSIONAL PLACE OF BUSINESS. QUASI-PUBLIC OR PUBLIC ESTABLISHMENT, OR PLACE OF RESIDENCE.
- 3. BY VEHICLES TO DRIVEWAYS WITHOUT THE PROVISION OF ALTERNATIVE MEANS OF BUILDING INGRESS AND EGRESS.

PROTECTION AND RESTORATION OF PROPERTY

THE CONTRACTOR SHALL BE RESPONSIBLE FOR THE PRESERVATION OF ALL PUBLIC AND PRIVATE PROPERTY.

THE CONTRACTOR SHALL BE RESPONSIBLE FOR ALL DAMAGE OR INJURY TO PROPERTY AND/OR PERSONS DURING THE PROSECUTION OF THE WORK, RESULTING FROM ANY ACT. OMISSION, NEGLECT OR MISCONDUCT IN HIS MANNER OR METHOD OF EXECUTING THE WORK, OR AT ANY TIME DUE TO DEFECTIVE WORK OR MATERIALS, AND SAID RESPONSIBILITY WILL NOT BE RELEASED UNTIL THE PROJECT HAS BEEN COMPLETED AND

DUST NUISANCE ORIGINATING FROM ANY OF THE CONTRACTOR'S OPERATIONS EITHER INSIDE OR OUTSIDE THE RIGHT-OF-WAY SHALL BE CONTROLLED BY THE CONTRACTOR IN ACCORDANCE WITH LOCAL ORDINANCES AND REGULATIONS AT THE SOLE EXPENSE OF THE CONTRACTOR.

WHEN OR WHERE ANY DIRECT OR INDIRECT DAMAGE OR INJURY IS DONE TO PUBLIC OR PRIVATE PROPERTY BY OR ON ACCOUNT OF ANY ACT, OMISSION, NEGLECT OR MISCONDUCT IN THE EXECUTION OF THE WORK, OR IN CONSEQUENCE OF THE NONEXECUTION THEREOF BY THE CONTRACTOR, HE SHALL RESTORE, AT HIS OWN EXPENSE, SUCH PROPERTY TO A CONDITION SIMILAR OR EQUAL TO THAT EXISTING BEFORE SUCH DAMAGE OR INJURY WAS DONE BY REPAIRING, REBUILDING OR OTHERWISE RESTORING AS MAY BE DIRECTED, OR SHALL MAKE GOOD SUCH DAMAGE OR INJURY IN AN ACCEPTABLE MANNER.

WHEN MAIL BOXES, ROAD OR STREET NAME SIGNS AND SUPPORTS INTERFERE WITH CONSTRUCTION, THE CONTRACTOR SHALL REMOVE AND REERECT THEM IN A TEMPORARY LOCATION DURING CONSTRUCTION IN A MANNER SATISFACTORY TO AND AS DIRECTED BY THE ENGINEER. AFTER COMPLETION OF THE CONSTRUCTION AND BEFORE FINAL ACCEPTANCE OF THE PROJECT, THE CONTRACTOR SHALL ERECT THE MAIL BOXES, ROAD OR STREET NAME SIGNS AND SUPPORTS IN THEIR ORIGINAL LOCATION UNLESS OTHERWISE DIRECTED BY THE ENGINEER. PAYMENT FOR THIS WORK SHALL BE INCLUDED IN THE PRICE BID FOR CLEARING AND GRUBBING.

LANDSCAPING AND DRIVEWAY ITEMS

WHEN THE CONSTRUCTION OPERATIONS ARE IN CLOSE PROXIMITY TO LANDSCAPING FEATURES (TIMBERS, ROCKS, BOULDERS, ETC.), DRIVEWAY TIMBERS, DRIVEWAY CURBING, ETC. THE CONTRACTOR SHALL SAVE, REMOVE AND PLACE THESE ITEMS OUTSIDE THE WORK LIMITS AT A LOCATION ACCEPTABLE TO THE ENGINEER. PAYMENT FOR THIS WORK SHALL BE INCLUDED IN THE PRICE BID FOR THE STORM SEWER.

USE OF PRIVATE PROPERTY

THE CONTRACTOR CAN USE PRIVATE PROPERTY FOR THE STORAGE OF EQUIPMENT AND MATERIALS ONLY WITH A WRITTEN AGREEMENT WITH THE PROPERTY OWNER. THE CONTRACTOR SHALL PROVIDE THIS AGREEMENT TO THE ENGINEER PRIOR TO ANY USE OF PRIVATE PROPERTY.

REMOVAL ITEMS

ALL ITEMS NOTED ON THE PLANS TO BE REMOVED BY THE CONTRACTOR SHALL BECOME THE PROPERTY OF THE CONTRACTOR AND SHALL BE DISPOSED OF IN AN APPROPRIATE MANNER BY THE CONTRACTOR UNLESS OTHERWISE NOTED.

SUBSURFACE INVESTIGATIONS

A LIMITED SUBSURFACE SOIL INVESTIGATIONS WAS PERFORMED FOR THIS PROJECT. HOWEVER, IT IS THE OBLIGATION AND RESPONSIBILITY OF THE CONTRACTOR TO MAKE HIS OWN INVESTIGATION OF SUBSURFACE CONDITIONS INCLUDING AREAS WITHIN THE PAVEMENT AREAS RECEIVING SOIL CEMENT STABILIZATION PRIOR TO SUBMITTING HIS PROPOSAL AND DURING CONSTRUCTION AS DEEMED NECESSARY BY THE CONTRACTOR.

DRIVEWAY AND ROADWAY PAVEMENT INSTALLATION

ALL PAVEMENT INSTALLATION SHOULD BE CONDUCTED UNDER SUITABLE WEATHER CONDITIONS. THE ENGINEER SHALL BE NOTIFIED IN ADVANCE OF ANY PROPOSED PAVEMENT INSTALLATION TO DETERMINE THE SUITABILITY OF WEATHER CONDITIONS FOR PAVEMENT INSTALLATION.

THE CONTRACTOR SHALL BE RESPONSIBLE FOR MAINTENANCE OF ALL ROADWAYS AND DRIVES PRIOR TO FINAL INSTALLATION. THE COST OF ANY TEMPORARY SURFACE MATERIAL SHALL BE INCLUDED IN THE UNIT PRICE BID FOR THE RESPECTIVE ITEM OF WORK.

GARBAGE COLLECTION

THE CONTRACTOR SHALL BE RESPONSIBLE FOR COORDINATING THE TRANSFER OF ALL GARBAGE, GARBAGE CANS, AND RECYCLE BINS FROM DRIVEWAYS WITHIN THE CONSTRUCTION ZONE TO THE OPPOSITE SIDE OF THE ROADWAY. CONTRACTOR TO ALLOW ACCESS TO GARBAGE TRUCKS ONCE THE GARBAGE AND RECYCLABLE MATERIALS HAVE BEEN COLLECTED, ALL GARBAGE CANS AND RECYCLE BINS SHALL BE RETURNED TO THE APPROPRIATE DRIVEWAYS AND OUTSIDE OF THE CONSTRUCTION LIMITS, OR AS DIRECTED BY THE ENGINEER. THE COST FOR THIS WORK SHALL BE INCLUDED IN THE LUMP SUM PRICE BID FOR ITEM 614, MAINTAINING TRAFFIC.

CONTINGENCY ITEMS

THE CONTRACTOR SHALL NOT ORDER MATERIALS OR PERFORM WORK FOR ITEMS DESIGNATED BY PLAN NOTE FOR USE "AS DIRECTED BY THE ENGINEER" UNLESS AUTHORIZED BY THE ENGINEER. THE ACTUAL WORK LOCATIONS AND QUANTITIES USED AT THE ENGINEER'S DISCRETION SHALL BE MADE A MATTER OF RECORD BY INCORPORATION INTO THE FINAL CHANGE ORDER GOVERNING COMPLETION OF THIS PROJECT.

THE FOLLOWING QUANTITIES HAVE BEEN CARRIED OVER TO THE BID PROPOSAL ITEMS AND ARE TO BE USED ONLY AS DIRECTED BY THE ENGINEER:

(611) 6" DIAMETER & SMALLER SEWER & DRAIN REPLACEMENT, CONTINGENCY 50 LF

UTILITY COMPANY CHARGES ALLOWANCE ON THE BID FORM IS INTENDED TO PROVIDE A CONTINGENCY QUANTITY ALLOWANCE TO PAY UTILITY COMPANY FOR HOLDING POLES WHILE EXCAVATION AND PIPE INSTALLATION IS PERFORMED. AN ESTIMATE OF \$7,500 HAS BEEN INCLUDED.

ODOT PERFORMANCE BOND AND PERMIT

THE CONTRACTOR WILL BE REQUIRED TO OBTAIN A PERFORMANCE BOND FOR THE STORM SEWER CROSSING ON STATE ROUTE 2. ODOT WILL REQUIRE A PERFORMANCE BOND IN THE AMOUNT OF \$263,839.36 THAT WILL COVER THIS WORK FOR A PERIOD OF (5) YEARS FROM COMPLETION, AND THAT ANY REPAIRS THAT MAY BE NEEDED ARE COMPLETED BY THE PERMITTEE. IF THE REPAIRS ARE NOT COMPLETED BY THE PERMITTEE, THE PERFORMANCE BOND IS IN PLACE FOR ODOT TO USE THE FUNDS TO COMPLETE ANY NECESSARY REPAIRS. THE PERMIT NUMBER WILL BE 054L23. THE CONTRACTOR SHALL SEND A CERTIFIED COPY OF THE PERFORMANCE BOND TO: OHIO DEPARTMENT OF TRANSPORTATION - ATTN: DISTRICT 12 PERMITS DEPARTMENT, 5500 TRANSPORTATION BOULEVARD, GARFIELD HEIGHTS, OH 44125. ONCE THE BOND HAS BEEN RECEIVED, THEN THE PERMIT WILL BE ISSUED.

LAKE COUNTY RIGHT-OF-WAY

THE CONTRACTOR WILL BE REQUIRED TO FILL OUT A RIGHT-OF-WAY USAGE PERMIT WITH A SURETY BOND AMOUNT OF \$50,000.

LEGEND

BOLD TEXT AND IMAGES ARE PROPOSED WORK, SLANTED TEXT AND **SCREENED IMAGES** ARE EXISTING FEATURES.

SINGLE LINES ARE USED TO SHOW UTILITIES 12" DIA. AND SMALLER. DOUBLE LINES ARE USED FOR THOSE 13" DIA. AND LARGER.

RIGHT-OF-WAY PROPERTY LINE -EX. WATERLINE, VALVE, HYDRANT ASSEMBLY

EX. SANITARY & M.H.-EX. STORM & M.H.

EX. FENCE-EX. RETAINING WALL-EX. OVERHEAD POWERLINE

PROP. SANITARY & M.H. •

PROP. PERM. EASEMENT-PROP. TEMP. EASEMENT

♦ MONUMENT BOX POWER & LIGHT POLE LIGHT POLE POWER POLE WATER OR GAS METER

YARD LIGHT CORPORATION STOP TRAFFIC POLE TREE POLE CONIFER FLAG POLE BUSH

A STUMP

MAILBOX

GUY WIRE

DISCIPLINE

GENERAL NOTES 2

LENE HILL -66017

NO REVISION DATE **LAKE COUNTY**

CITY OF WILLOUGHBY

NASON BASIN TO GROVE AVENUE STORM SEWER IMPROVEMENTS PHASE 1

WILLOUGHBY, OHIO

ISSUE DATE: 02/07/25 SCALE: AS SHOWN **DESIGNED BY** MPO TJM DRAWN BY:

LCH

ISSUED FOR:

CHECKED BY:

PROJECT NO.

150772

SANITARY SEWER NOTES:

- 1. NEW SANITARY SEWERS SHALL BE PVC, SDR 26 ASTM 3034 WITH ASTM D3212, F477 WATER—TIGHT, FLEXIBLE GASKET JOINTS IN ACCORDANCE WITH PLANS AND SPECIFICATION 333100.
- 2. SEWER LATERAL PIPE FITTINGS SHALL BE IN ACCORDANCE WITH CMS 707.44 AND PER SPECIFICATION 333100.
- 3. SEWER MAIN CONNECTIONS TO EXISTING SEWERS SHALL BE MADE WITH FERNCO COUPLINGS WITH SS SHEAR BANDS TO MATCH PROPOSED/EXISTING PIPE SIZES OR AN APPROVED EQUAL.
- 4. INSPECTION TEE RISERS SHALL BE SIX (6) INCH DIAMETER PVC SEWER PIPE PER SPECIFICATIONS WITH A 6" X 6" TEE CONNECTION TO THE LATERAL AND AN E-Z SET LOCATING PLUG CAP PLACED AT THE TOP. AN EAST JORDAN #3675 OR APPROVED EQUAL SHALL BE INSTALLED IF TEE IS IN A PAVEMENT AREA.
- 5. MANHOLES SHALL BE IN ACCORDANCE WITH SPECIFICATION 333100 AND PLAN DETAILS.
- 6. SANITARY SEWER MANHOLE CASTINGS SHALL EAST JORDAN #1710 W/FRAME AND COVER, STAMPED "SANITARY".
- 7. ALL EXISTING UTILITY LINE ELEVATIONS SHOWN ARE ESTIMATED AND MUST BE FIELD DETERMINED BY THE CONTRACTOR. CONFLICTS MUST BE RESOLVED BY THE CONTRACTOR AND THE UTILITY OWNER.
- 8. EXISTING PIPE REMOVED WITHIN TRENCH LIMITS FOR PLACEMENT OF PROPOSED PIPE SHALL BE INCLUDED IN THE PRICE FOR CONDUIT ITEM AND WILL NOT BE PAID FOR SEPARATELY.
- 9. RIM ELEVATION ARE APPROXIMATELY SET. FINAL RIM TO BE FLUSH WITH THE FINAL GRADE.
- 10. THE CONTRACTOR IS RESPONSIBLE FOR MAINTAINING SEWER FLOW AT ALL TIMES.
- 11. THE CONTRACTOR SHALL PROVIDE A FINAL CLEANING OF ALL SANITARY MAIN SEWERS, MANHOLES AND LATERALS AFTER ALL CONSTRICTION ACTIVITIES HAVE BEEN COMPLETED.
- 12. THE CONTRACTOR SHALL PROVIDE A VIDEO RECORDING OF THE INTERIOR OF THE SANITARY MAIN SEWERS AND MAN HOLES AFTER CLEANING HAS BEEN COMPLETED.
- 13. CONTRACTOR SHALL TELEVISE THE MAIN SEWER DOWNSTREAM OF THE MAIN SEWER TO THE NEXT MANHOLE OR 300 FEET, WHICHEVER IS LESS. ALL DEBRIS SO LOCATED SHALL BE REMOVED BY THE CONTRACTOR.
- 14. ALL CLEANING AND DOCUMENTATION COSTS SHALL BE INCLUDED IN THE TABULATED ITEMS FOR SANITARY SEWER, LATERAL AND MANHOLE INSTALLATION OR PAVEMENT INSTALLATION. ALL RECORDINGS SHALL BE TURNED OVER TO THE CITY.

EXCAVATION. BACKFILL AND COMPACTION:

- 1. ALL EXCAVATION WILL BE CONSIDERED UNCLASSIFIED, NO COMPENSATION WILL BE ALLOWED THE CONTRACTOR FOR ROCK OR SHALE EXCAVATION.
- 2. ALL BACKFILL WILL BE AS DESCRIBED IN SPECIFICATION SECTION 310000 USING MACHINE MOUNTED COMPACTION EQUIPMENT TO MEET THE COMPACTION REQUIREMENT OF 100% OF MAXIMUM LABORATORY DRY DENSITY PER ASTM D 698.
- 3. THE OWNER AND THE ENGINEER DO NOT GUARANTEE NOR SUGGEST THE IN—SITU MATERIAL TO BE EXCAVATED WILL BE SUITABLE OR IN ITS PRESENT STATE WILL CONSIST OF THE PROPER MOISTURE CONTENT TO ACHIEVE THE COMPACTION REQUIREMENTS. THE CONTRACTOR SHALL MAKE HIS OWN DETERMINATION AS TO THE BACKFILL MATERIAL HE WILL USE. UPON REQUEST, THE OWNER WILL PROVIDE ACCESS TO THE SITE FOR THE CONTRACTOR TO CONDUCT SUCH INVESTIGATION AND TESTS DEEMED NECESSARY TO MAKE HIS DETERMINATION. NO EXTRA PAYMENT WILL BE MADE TO DISPOSE OF UNSUITABLE MATERIAL OR FURNISH AND PLACE SUITABLE MATERIAL MEETING THE REQUIREMENTS OF SECTION 310000.
- 4. BACKFILLING OF ANY TRENCHES OR EXCAVATIONS WILL NOT BE PERMITTED WITHOUT MACHINE MOUNTED COMPACTION EQUIPMENT BEING USED.
- 5. SLAG PRODUCTS WILL NOT BE PERMITTED FOR BEDDING, BACKFILL, OR TRAFFIC COMPACTED SURFACE.
- 6. ALL UTILITY LINES CROSSING THE NEW WATERLINE TRENCH, (i.e. STORM SEWERS, STORM LATERALS, SANITARY SEWERS, SANITARY LATERALS, WATER MAINS, WATER SERVICE CONNECTIONS, GAS MAINS, GAS SERVICE CONNECTIONS, UNDERGROUND OCT CONDUITS, CABLE T.V. LINES) SHALL BE PROTECTED AND SUPPORTED WITH HARDWOOD PLANKS OR REMOVED AND REPLACED, RECONNECTED AND SUPPORTED ACROSS THE ENTIRE WIDTH OF THE TRENCH. NO ADDITIONAL COMPENSATION WILL BE PAID FOR THE ABOVE WORK UNLESS ANY OF THE ABOVE UTILITIES ARE ENCOUNTERED AND NOT SHOWN ON THE DRAWINGS.

OHIO EPA SANITARY NOTES:

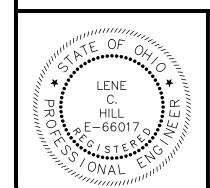
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LAKE COUNTY

- 1. ALL SANITARY SEWERS SHALL PASS THE AIR ACCEPTANCE TEST PER ASTM F-1417. THE INFILTRATION LIMIT SHALL NOT EXCEED 110 GAL. PER IN. PIPE DIA. PER MILE PER DAY.
- 2. PRIOR TO ACCEPTANCE, ALL SANITARY SEWER MANHOLES SHALL PASS THE AIR TEST AS SPECIFIED BY ASTM C-1244.
- 3. A DEFLECTION TEST SHALL BE REQUIRED FOR ALL FLEXIBLE PIPE OF 8" DIAMETER AND LARGER. THE ALLOWABLE DEFLECTION RATE SHALL NOT EXCEED FIVE (5%) PERCENT. THE TEST SHALL BE CONDUCTED AT LEAST 30 DAYS AFTER COMPLETION OF BACKFILL AND SHALL BE IN ACCORDANCE WITH THE OHIO EPA SPECIFICATION 01 33 19 AND THE CITY OF WILLOUGHBY SPECIFICATIONS.
- 4. FLEXIBLE GASKETS ON SEWER LINE CONNECTIONS MUST MEET ASTM C-923 STANDARDS.

LCDU WATER WORKS NOTES

- 1. ONLY WATER/SEWER CONTRACTORS LICENSED BY THE LAKE COUNTY BOARD OF COMMISSIONERS MAY INSTALL WATER MAINS.
- 2. THE CONTRACTOR SHALL NOTIFY THE LCDU AT LEAST 48 HOURS IN ADVANCE OF ANY WORK IN THEIR SYSTEMS.
- 3. THE LCDU SHALL PERFORM INSPECTION SERVICES. THE COST OF INSPECTION SHALL BE INCLUDED AS PART OF THIS CONSTRUCTION PROJECT AT THE CURRENT BASE RATE AS ESTABLISHED BY THE LAKE COUNTY BOARD OF COMMISSIONERS. (SEE SECTION 7 FEE SCHEDULE) COST FOR LAKE COUNTY INSPECTION FEE AND OTHER FEES SHALL BE INCLUDED IN THE UNIT PRICES BID FOR OTHER WATERLINE ITEMS.
- 4. ALL HYDRANTS SHALL BE POSITIONED SO THAT THE STEAMER NOZZLES POINT IN THE DIRECTION SHOWN ON THE PLANS.
- 5. ALL BOLTS SHALL BE STAINLESS STEEL TYPE 304 OR 316 WITH ANTI-GALLING AGENT.
- 6. ALL SHOP DRAWINGS SHALL BE SUBMITTED TO THE ENGINEER FOR PRELIMINARY CHECKING. THE ENGINEER SHALL FORWARD CHECKED SHOP DRAWINGS TO THE LCDU FOR FINAL CHECKING AND APPROVAL.
- 7. THE LCDU SHALL PROVIDE WATER FOR THE NEW WATER MAIN WITHOUT COST FOR THE INITIAL OPERATION. ALL WATER FOR FLUSHING OPERATIONS SHALL BE PAID FOR BY THE CONTRACTOR AT CURRENT RATES AS ESTABLISHED BY THE LAKE COUNTY BOARD OF COMMISSIONERS PER 100 CUBIC FEET OF WATER USED. (SEE SECTION 7 FEE SCHEDULE)
- 8. ALL WATER MAIN PIPE SHALL BE AN APPROVED MATERIAL AS SHOWN ON THE APPROVED PLANS.
- 9. LOCATION OF STERILIZATION AND TESTING CONNECTIONS SHALL BE AS DIRECTED BY THE LCDU AND ALL COSTS ASSOCIATED WITH PLACING AND UTILIZING SAID STERILIZATION AND TESTING CONNECTIONS SHALL BE INCLUDED IN THE PRICE BID PER LINEAL FOOT OF THE WATER MAINS. NO BACTERIA SAMPLES ARE TO BE TAKEN FROM FIRE HYDRANTS.
- 10. ALL CURB STOP BOXES, VALVE BOXES, ETC. TO BE SET AS SHOWN ON THE PLANS. RIMS WILL BE RAISED OR LOWERED AND BOXES PLUMBED BY THE CONTRACTOR AT TIME OF HOUSE CONSTRUCTION WHEN FINAL YARD GRADING IS COMPLETED.
- 11. ALL PROJECT HYDRANTS SHALL HAVE A FIELD COAT OF APPROVED PAINT APPLIED BY THE CONTRACTOR WITH THE EXCEPTION OF HYDRANTS THAT ARE FACTORY PAINTED WITH A ONE COAT UV RESISTANT HIGH GLOSS 2—PART POLYURETHANE ENAMEL, COLOR AS SPECIFIED. IF THE COATING ON THE HYDRANT IS DAMAGED BEFORE INSTALLATION THE HYDRANT MUST BE PAINTED.
- 12. THE CONTRACTOR SHALL NOTIFY THE FIRE DEPARTMENT PRIOR TO ANY PRESSURE TESTING.



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CITY OF WILLOUGHBY

NASON BASIN TO GROVE AVENUE STORM SEWER IMPROVEMENTS PHASE 1

ISSUED FOR: BID

ISSUE DATE: 02/07/25

SCALE: AS SHOWN

DESIGNED BY: MPC

DRAWN BY: TJM

CHECKED BY: LCH

GENERAL NOTES 3

PROJECT NO.

150772

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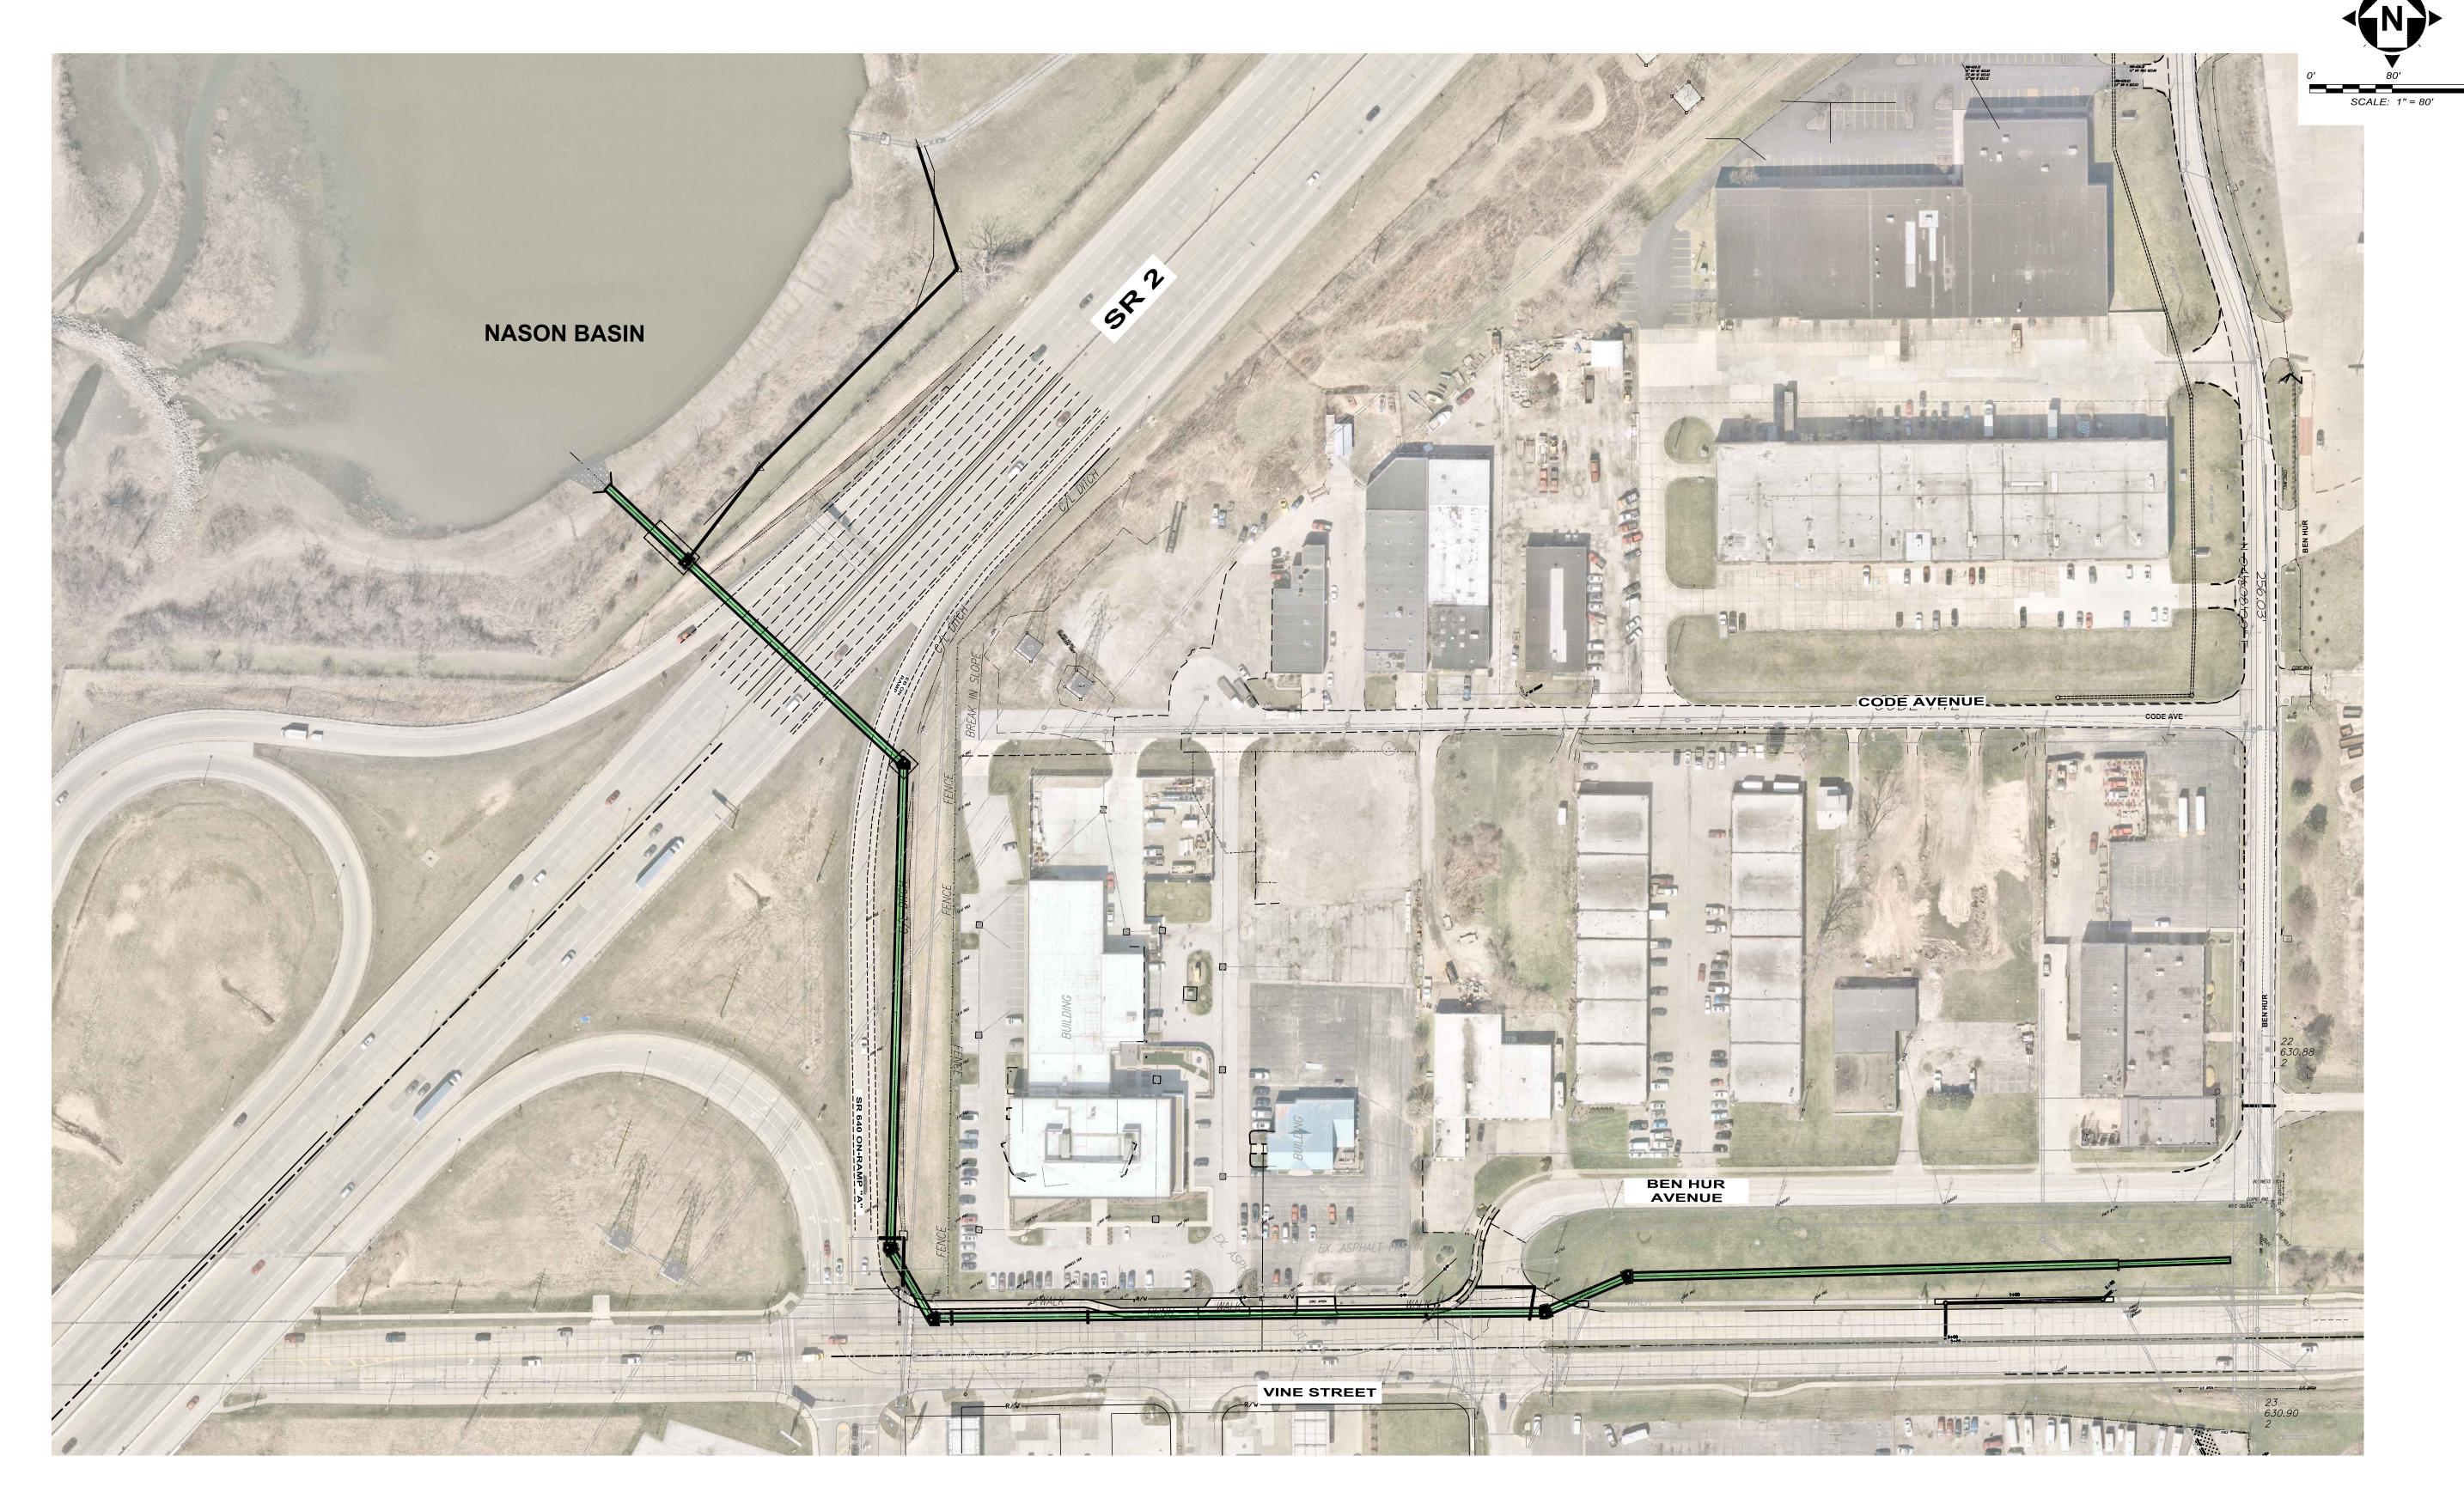
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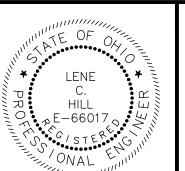
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LAKE COUNTY

CITY OF WILLOUGHBY

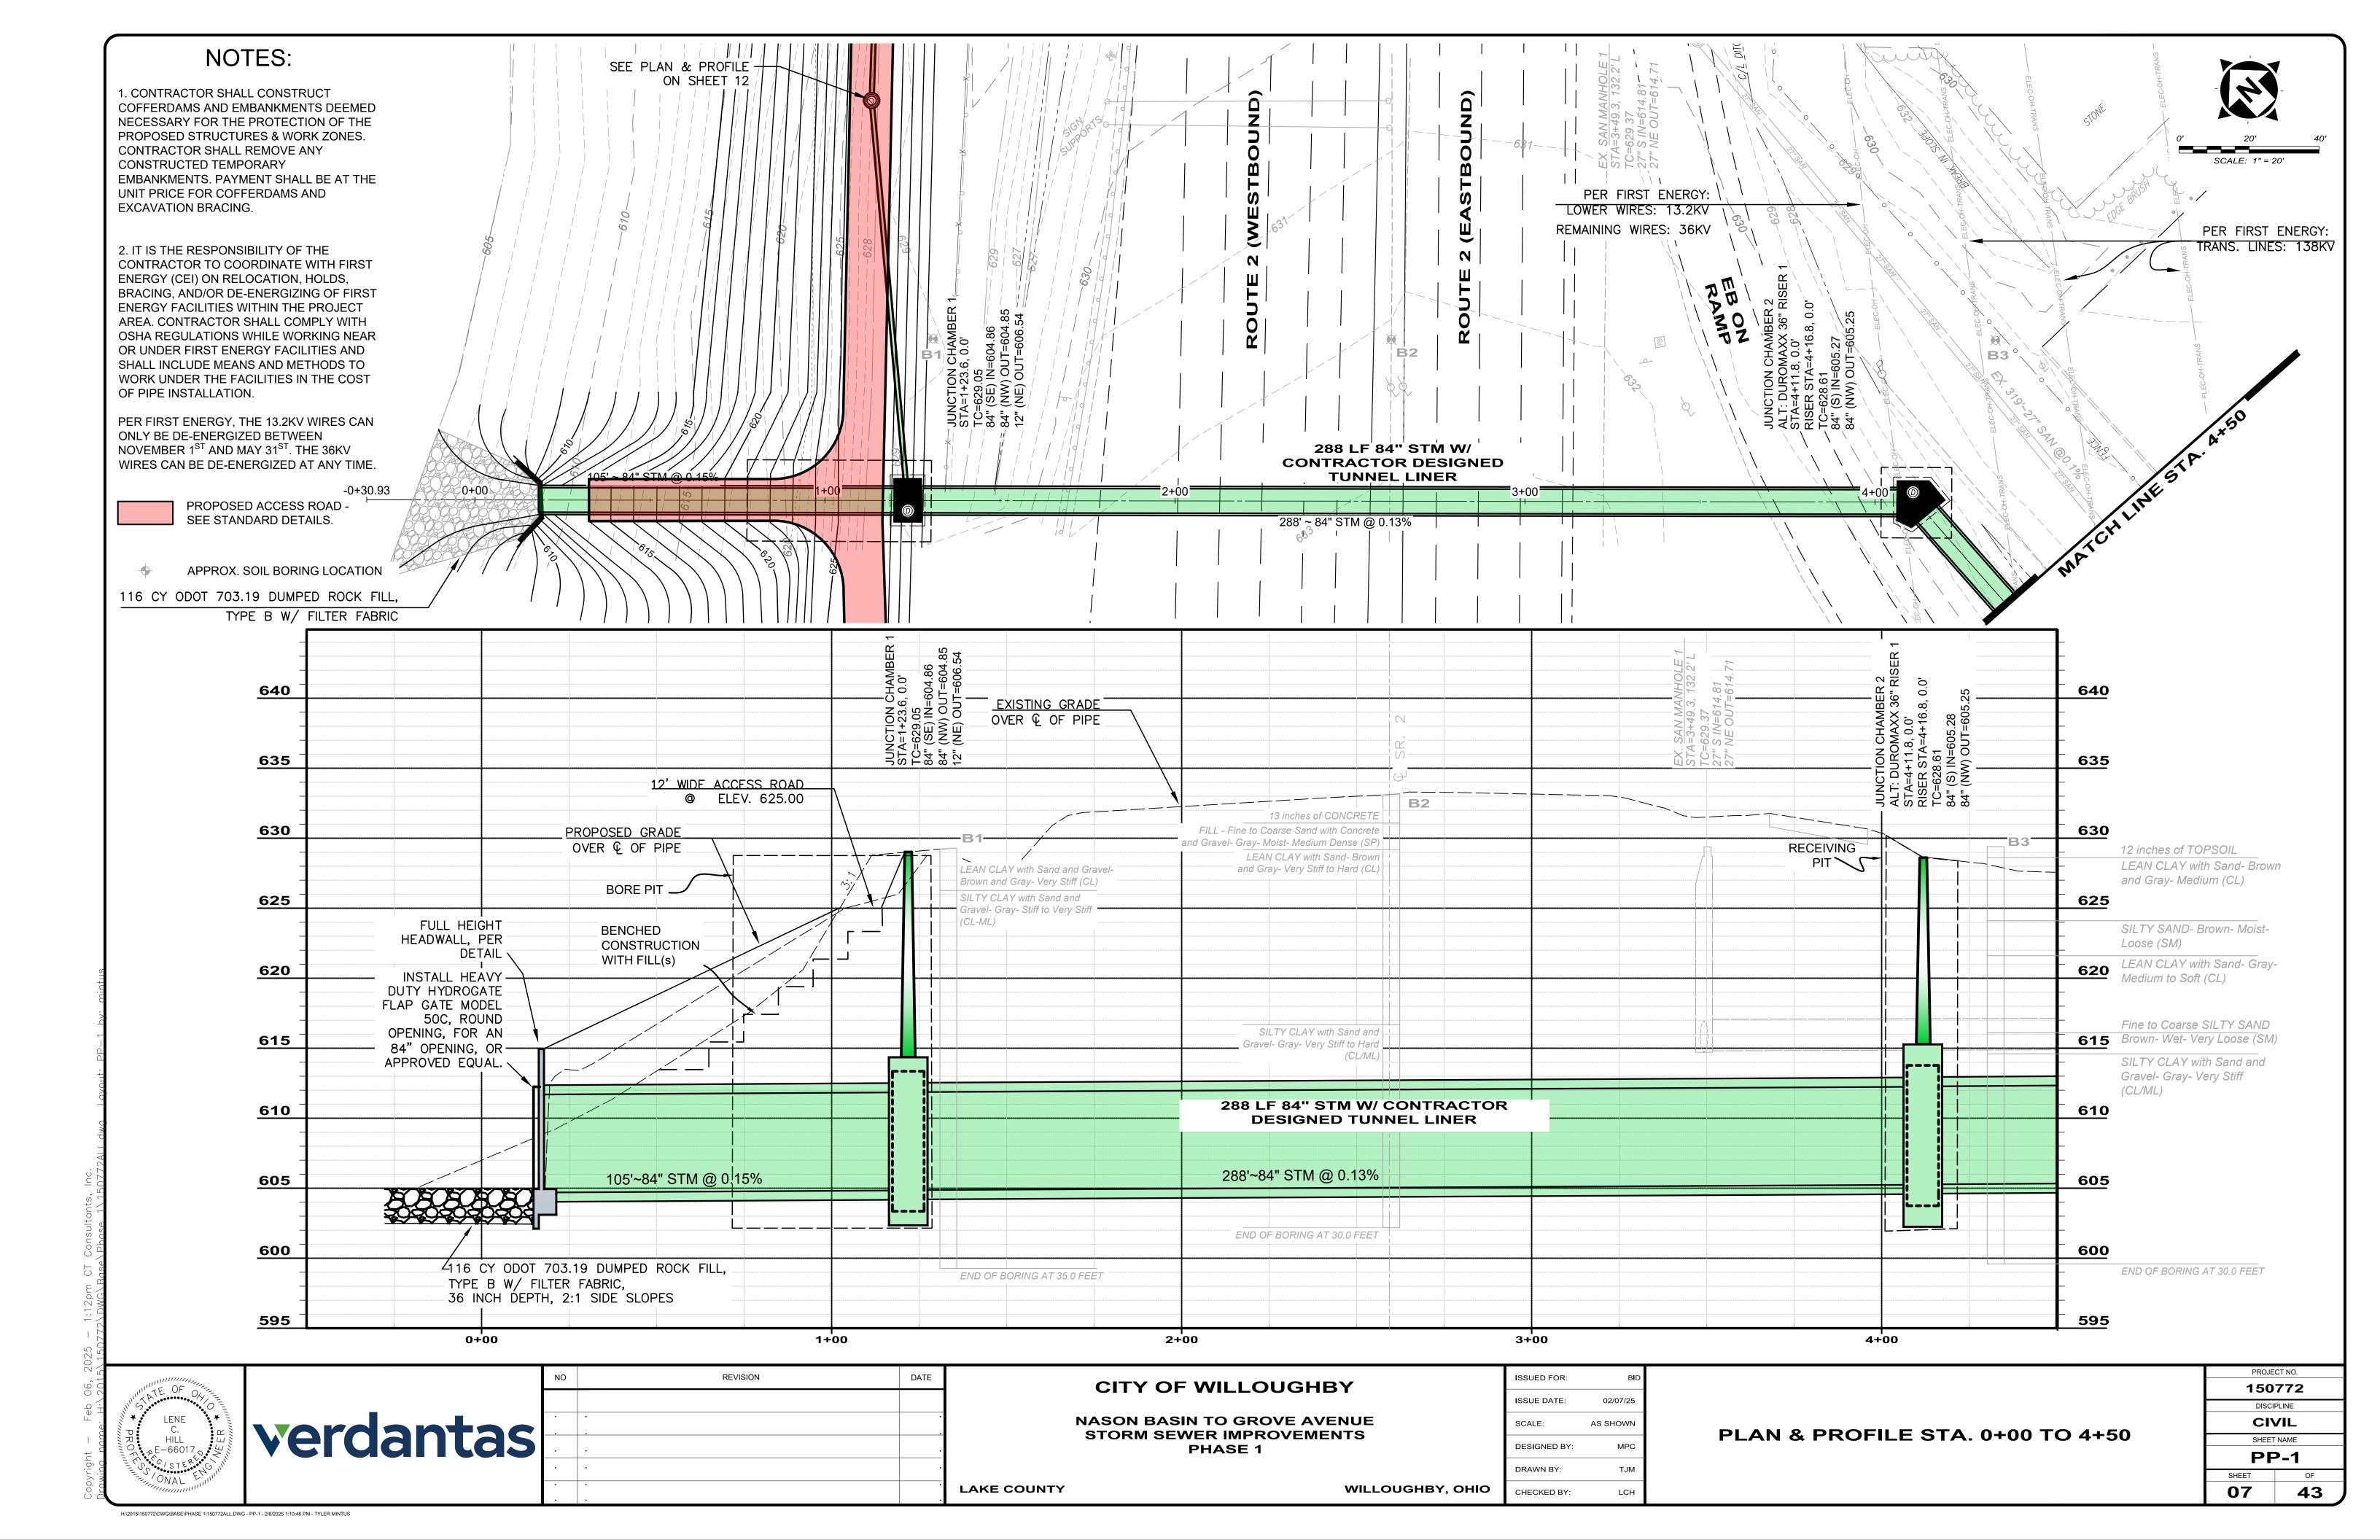
NASON BASIN TO GROVE AVENUE STORM SEWER IMPROVEMENTS PHASE 1

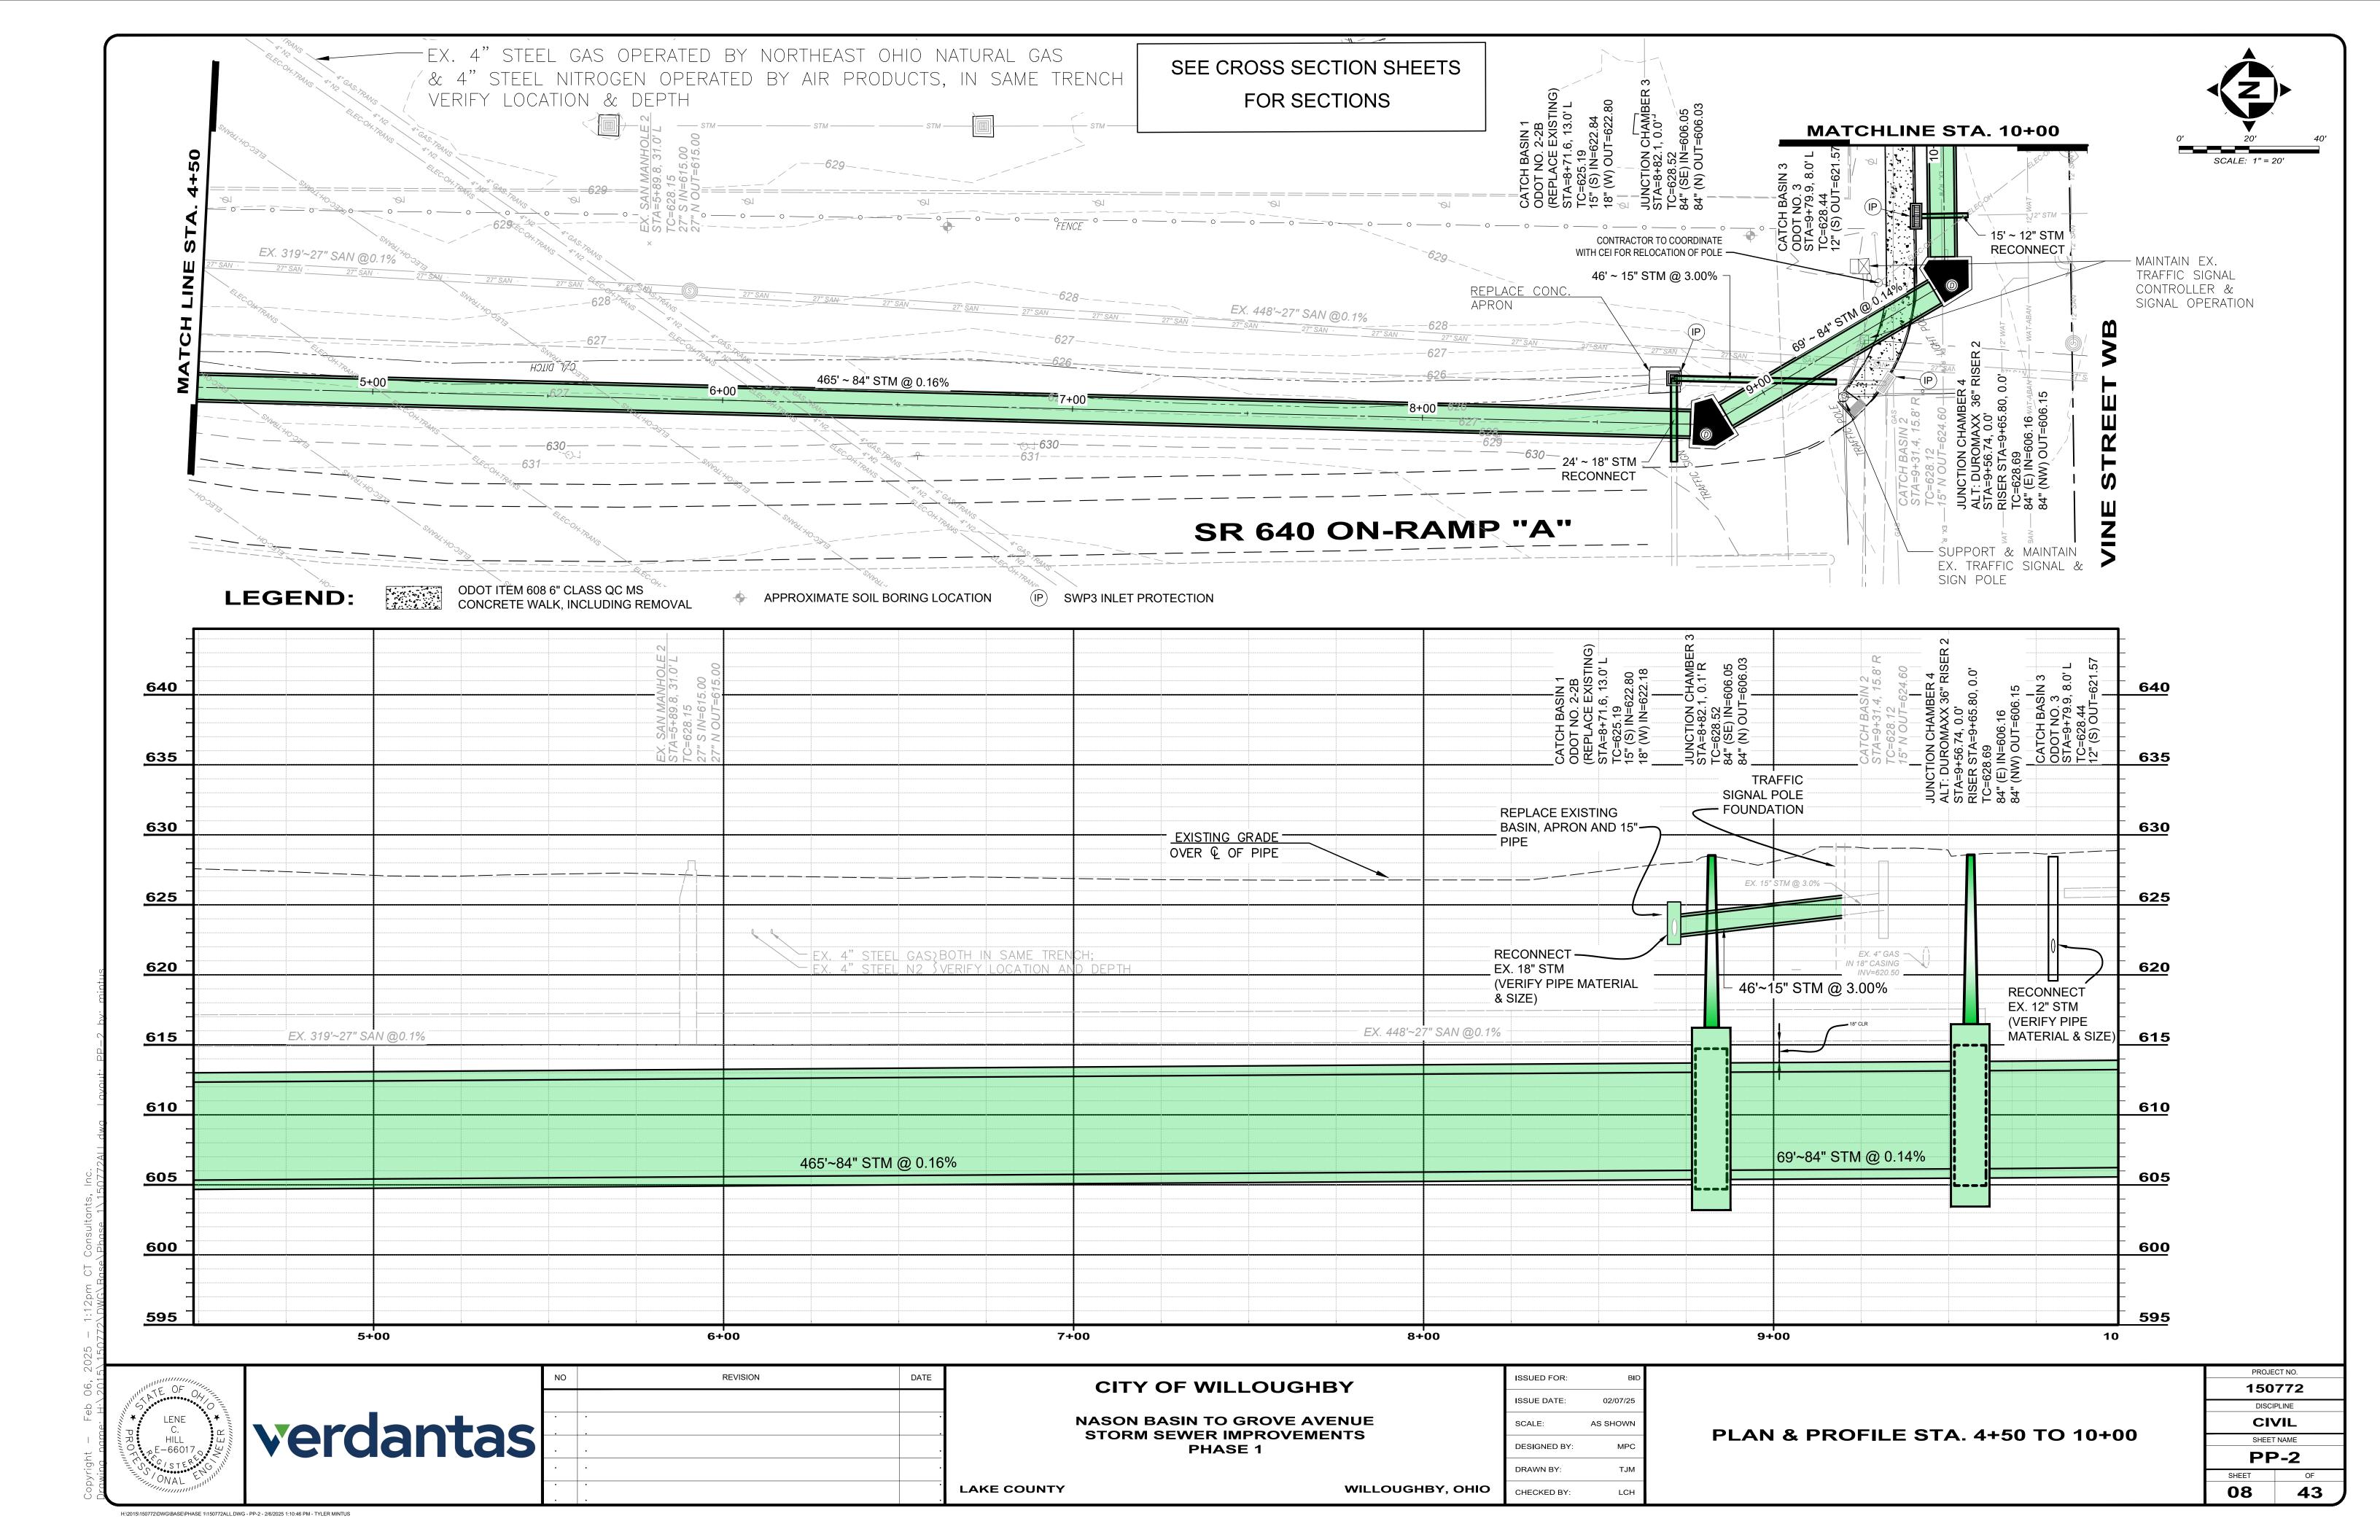
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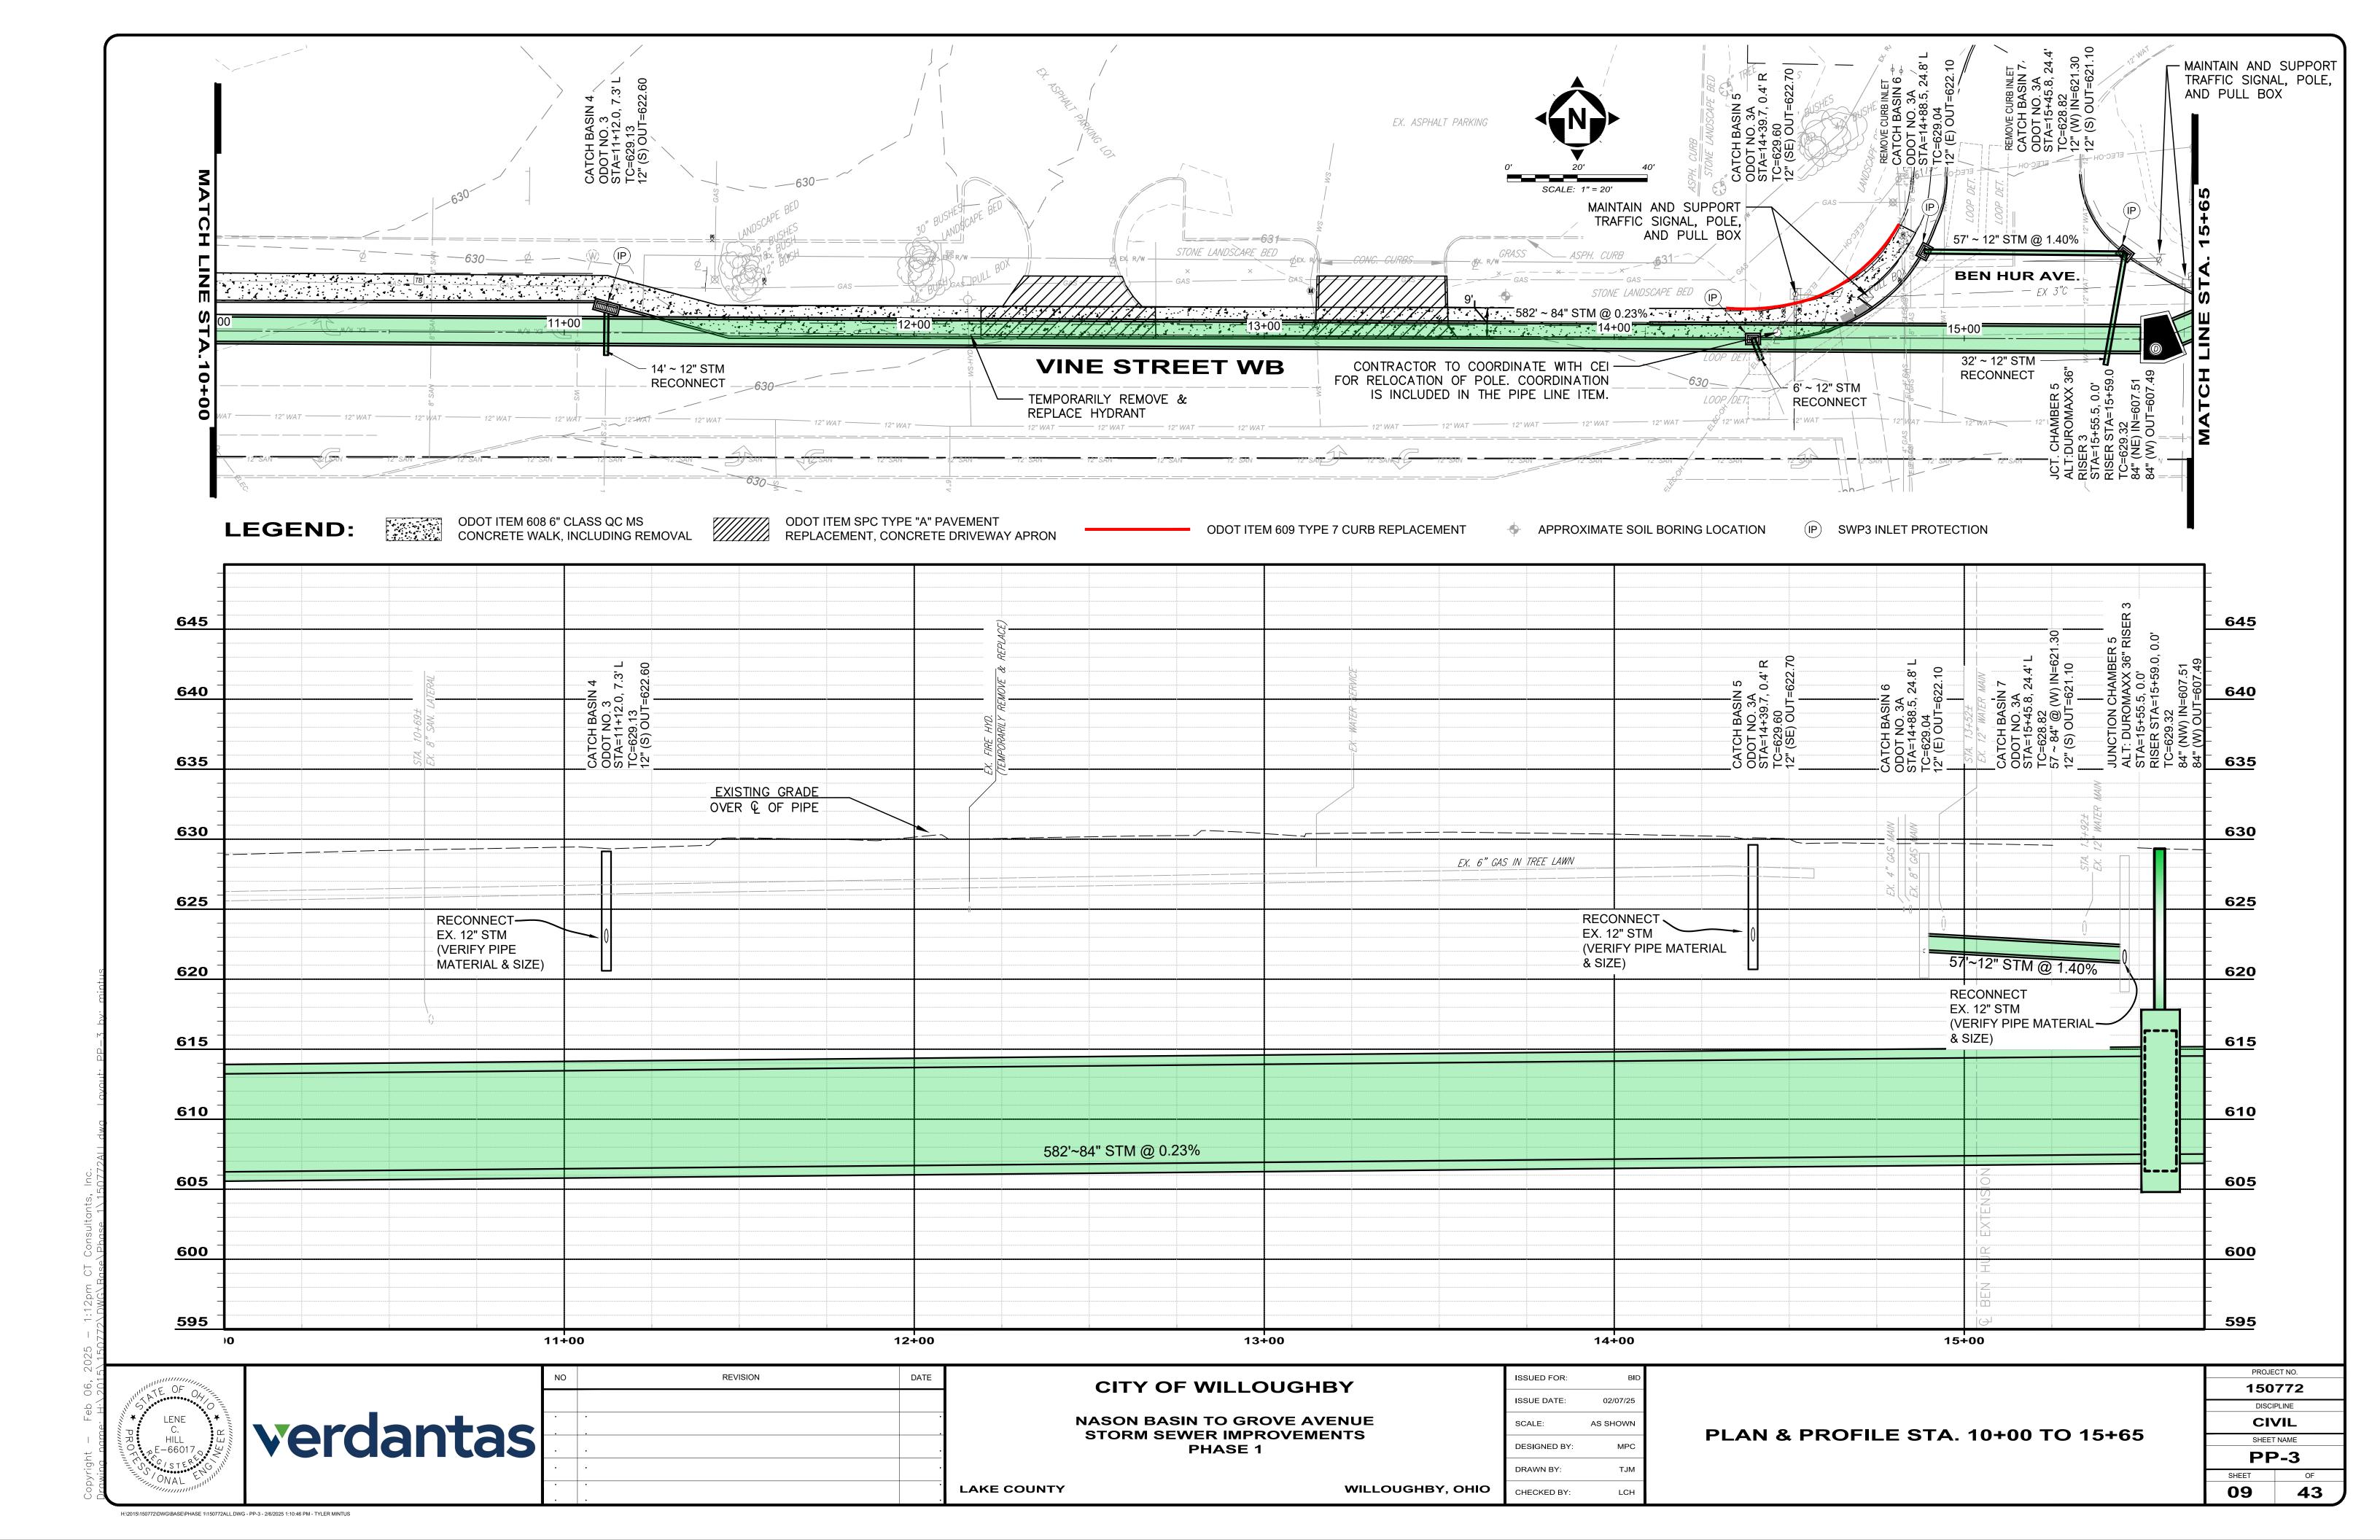
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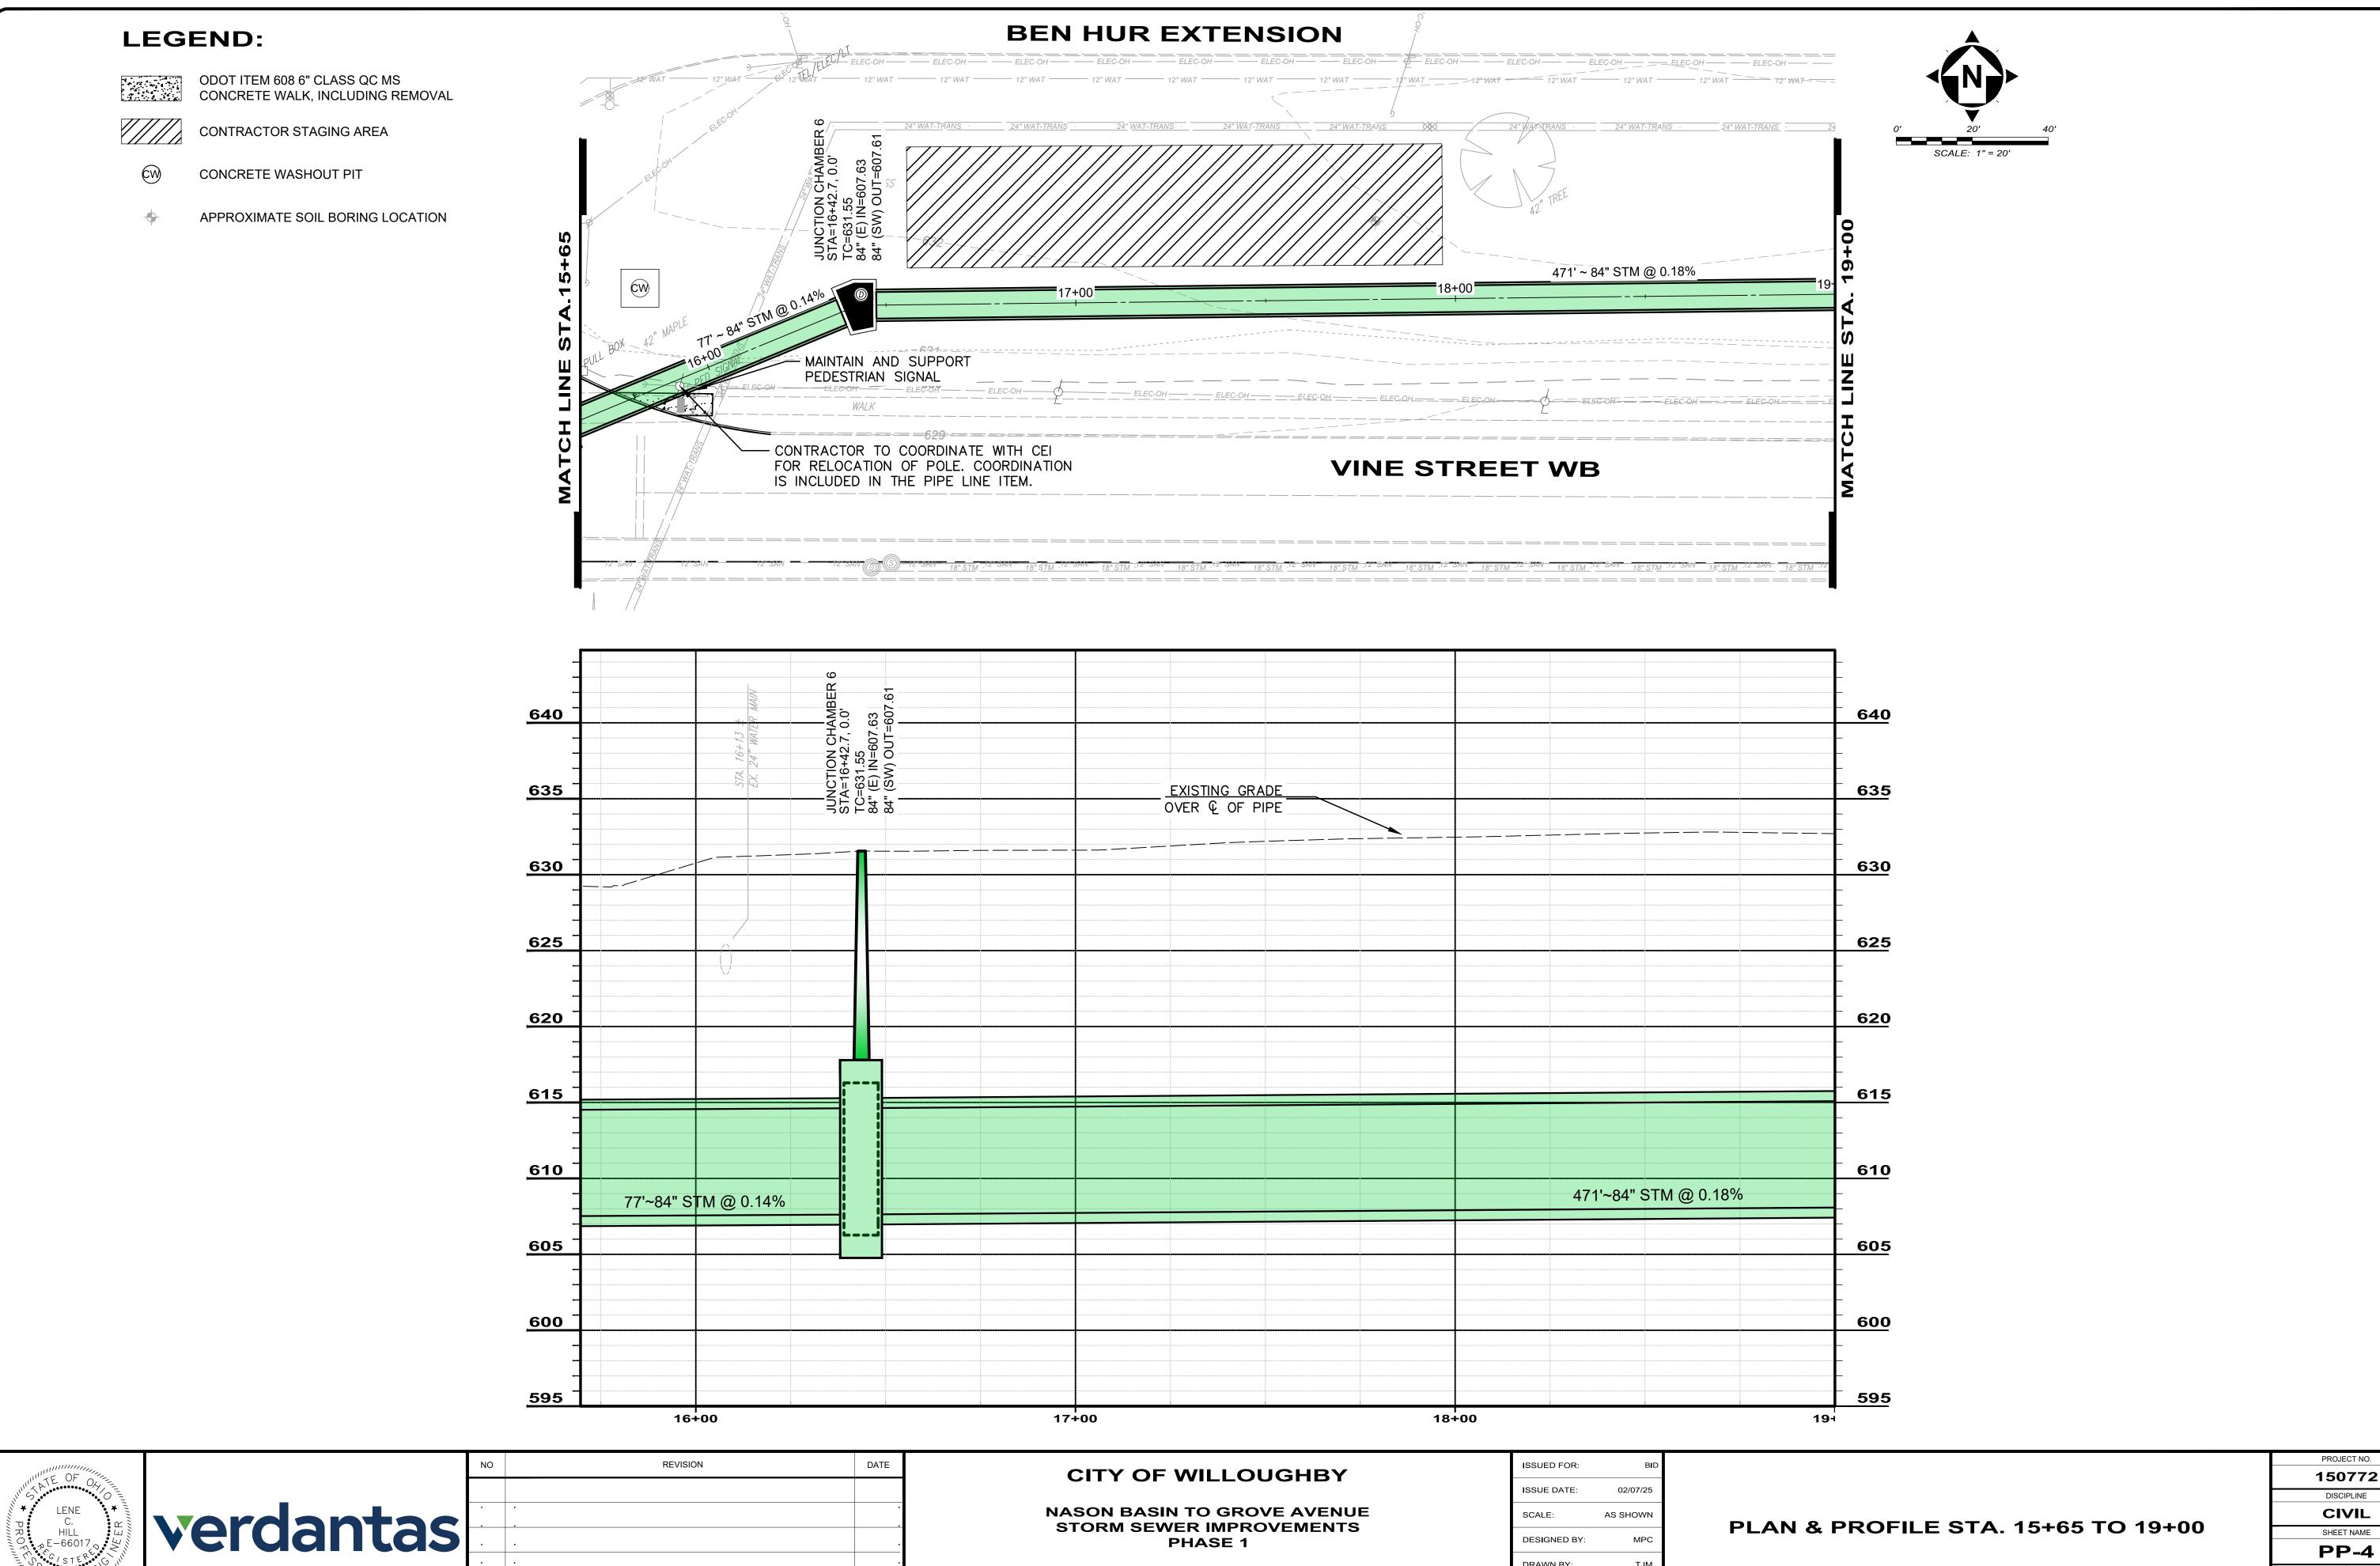
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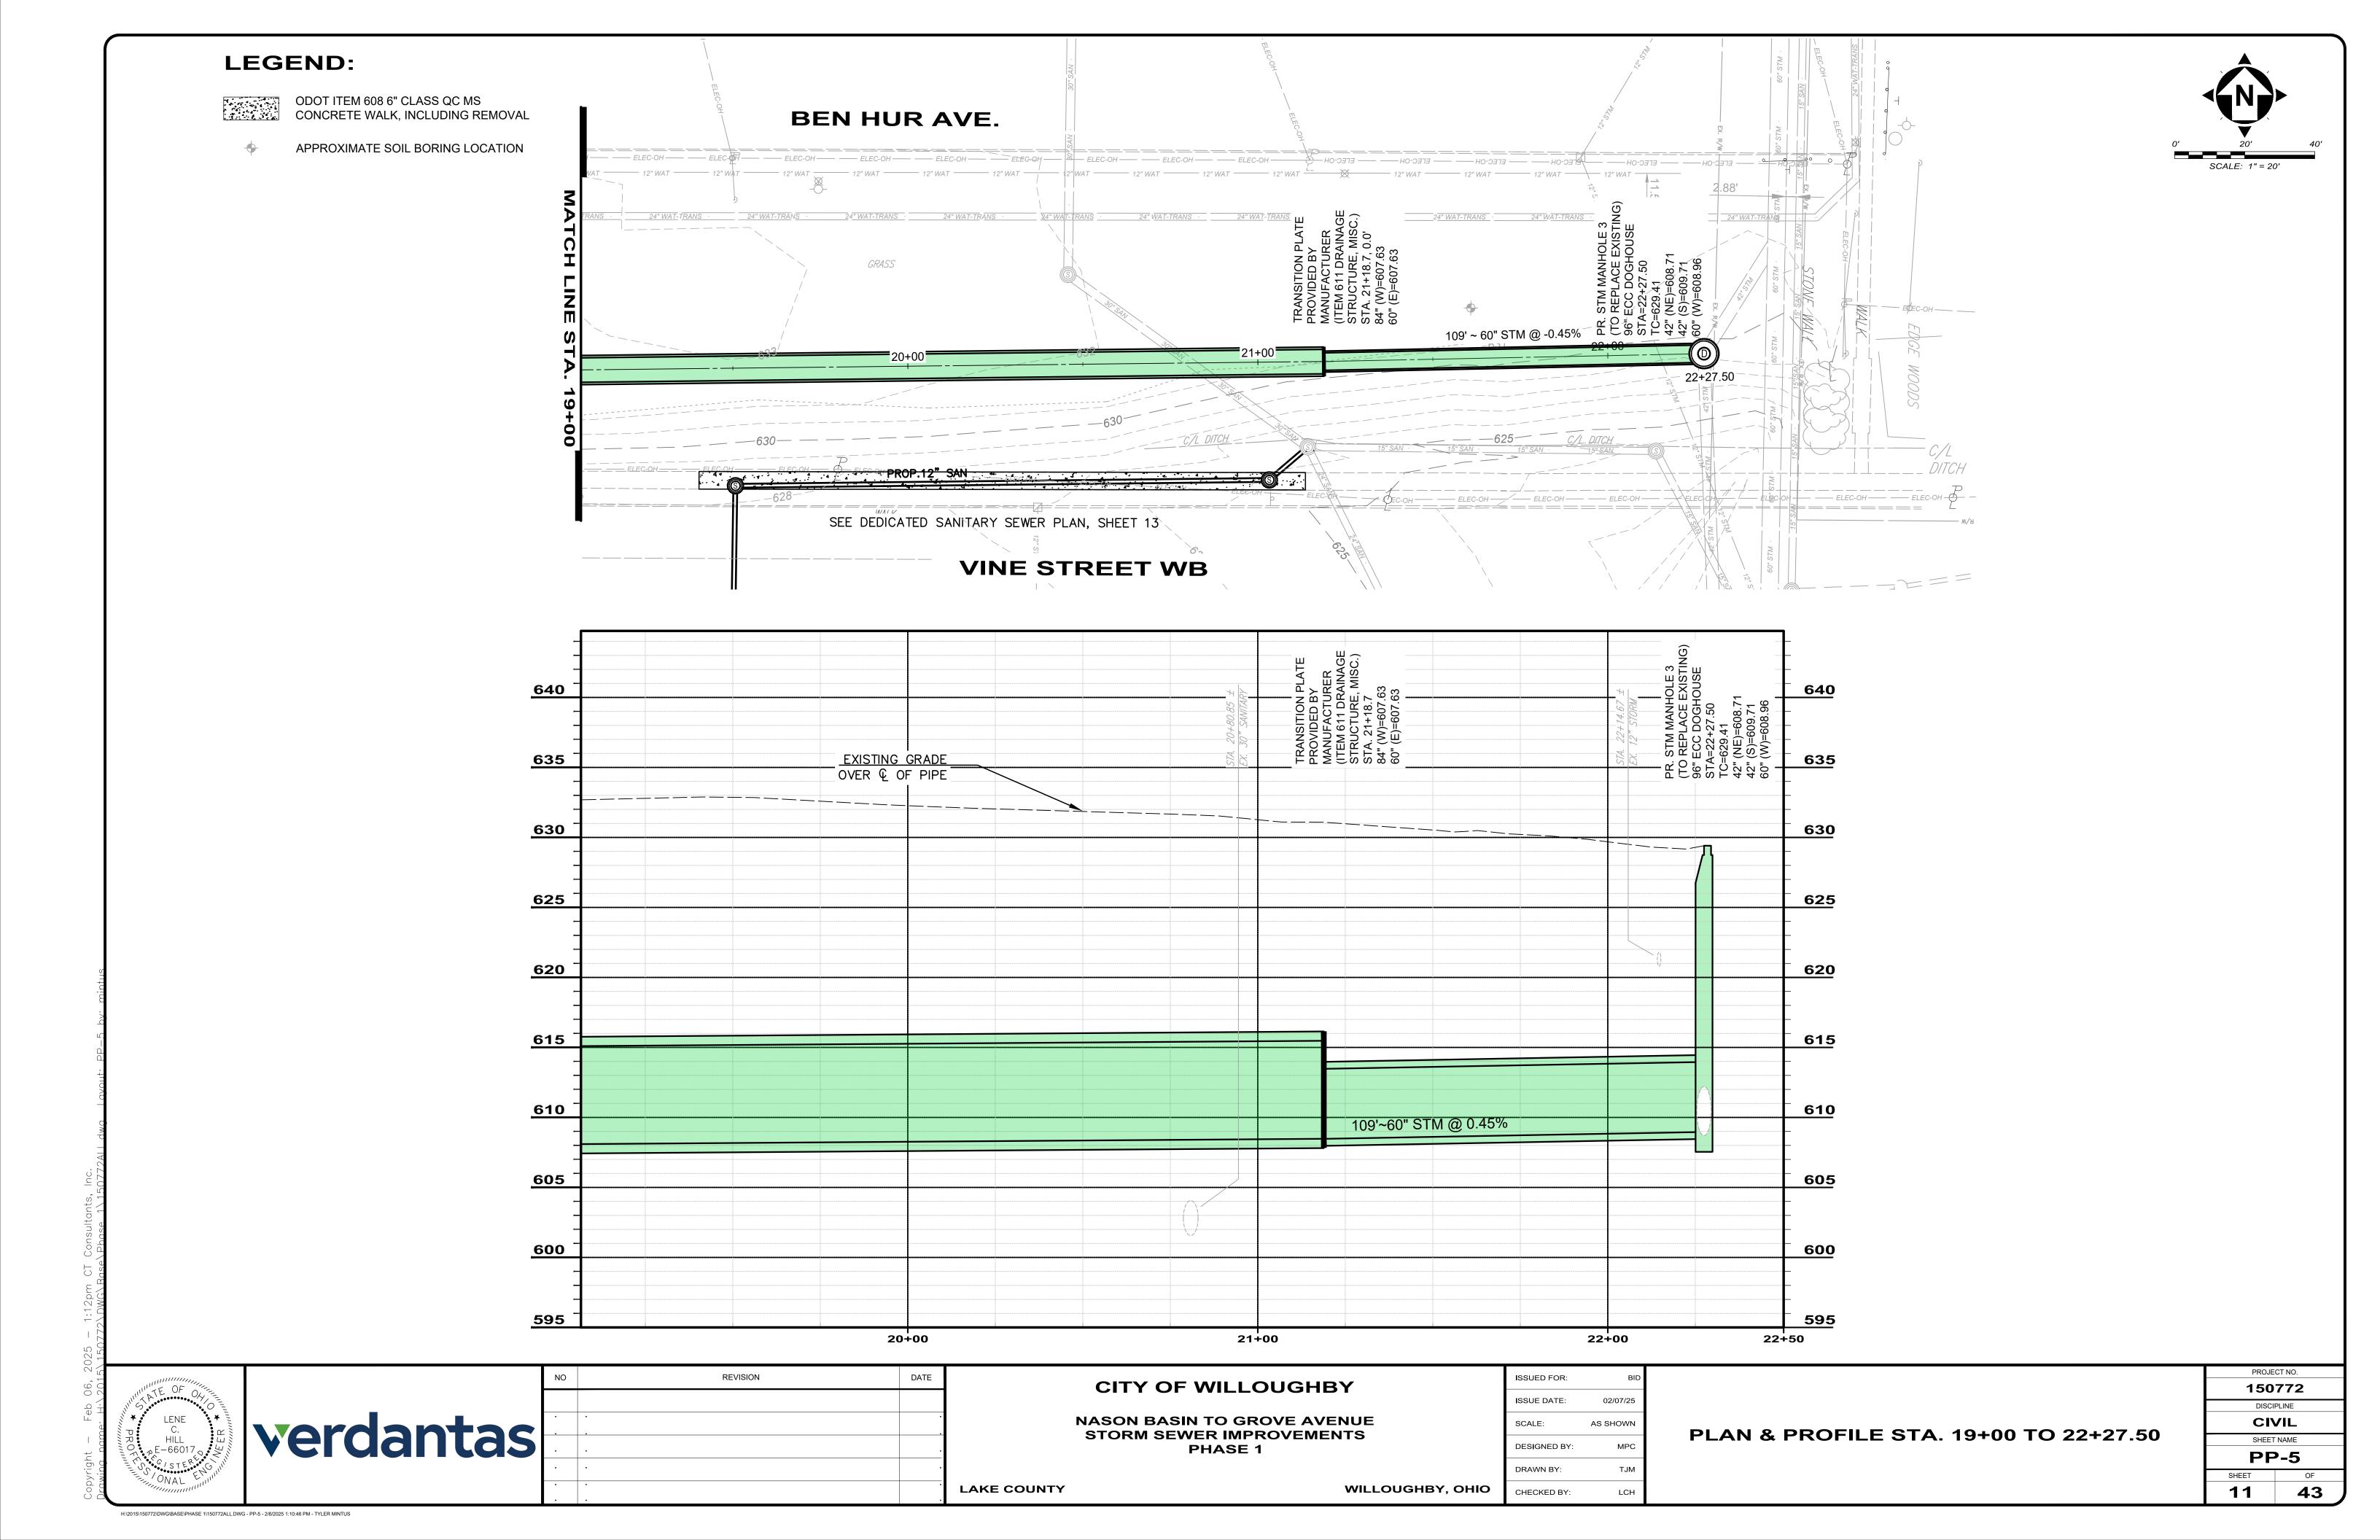
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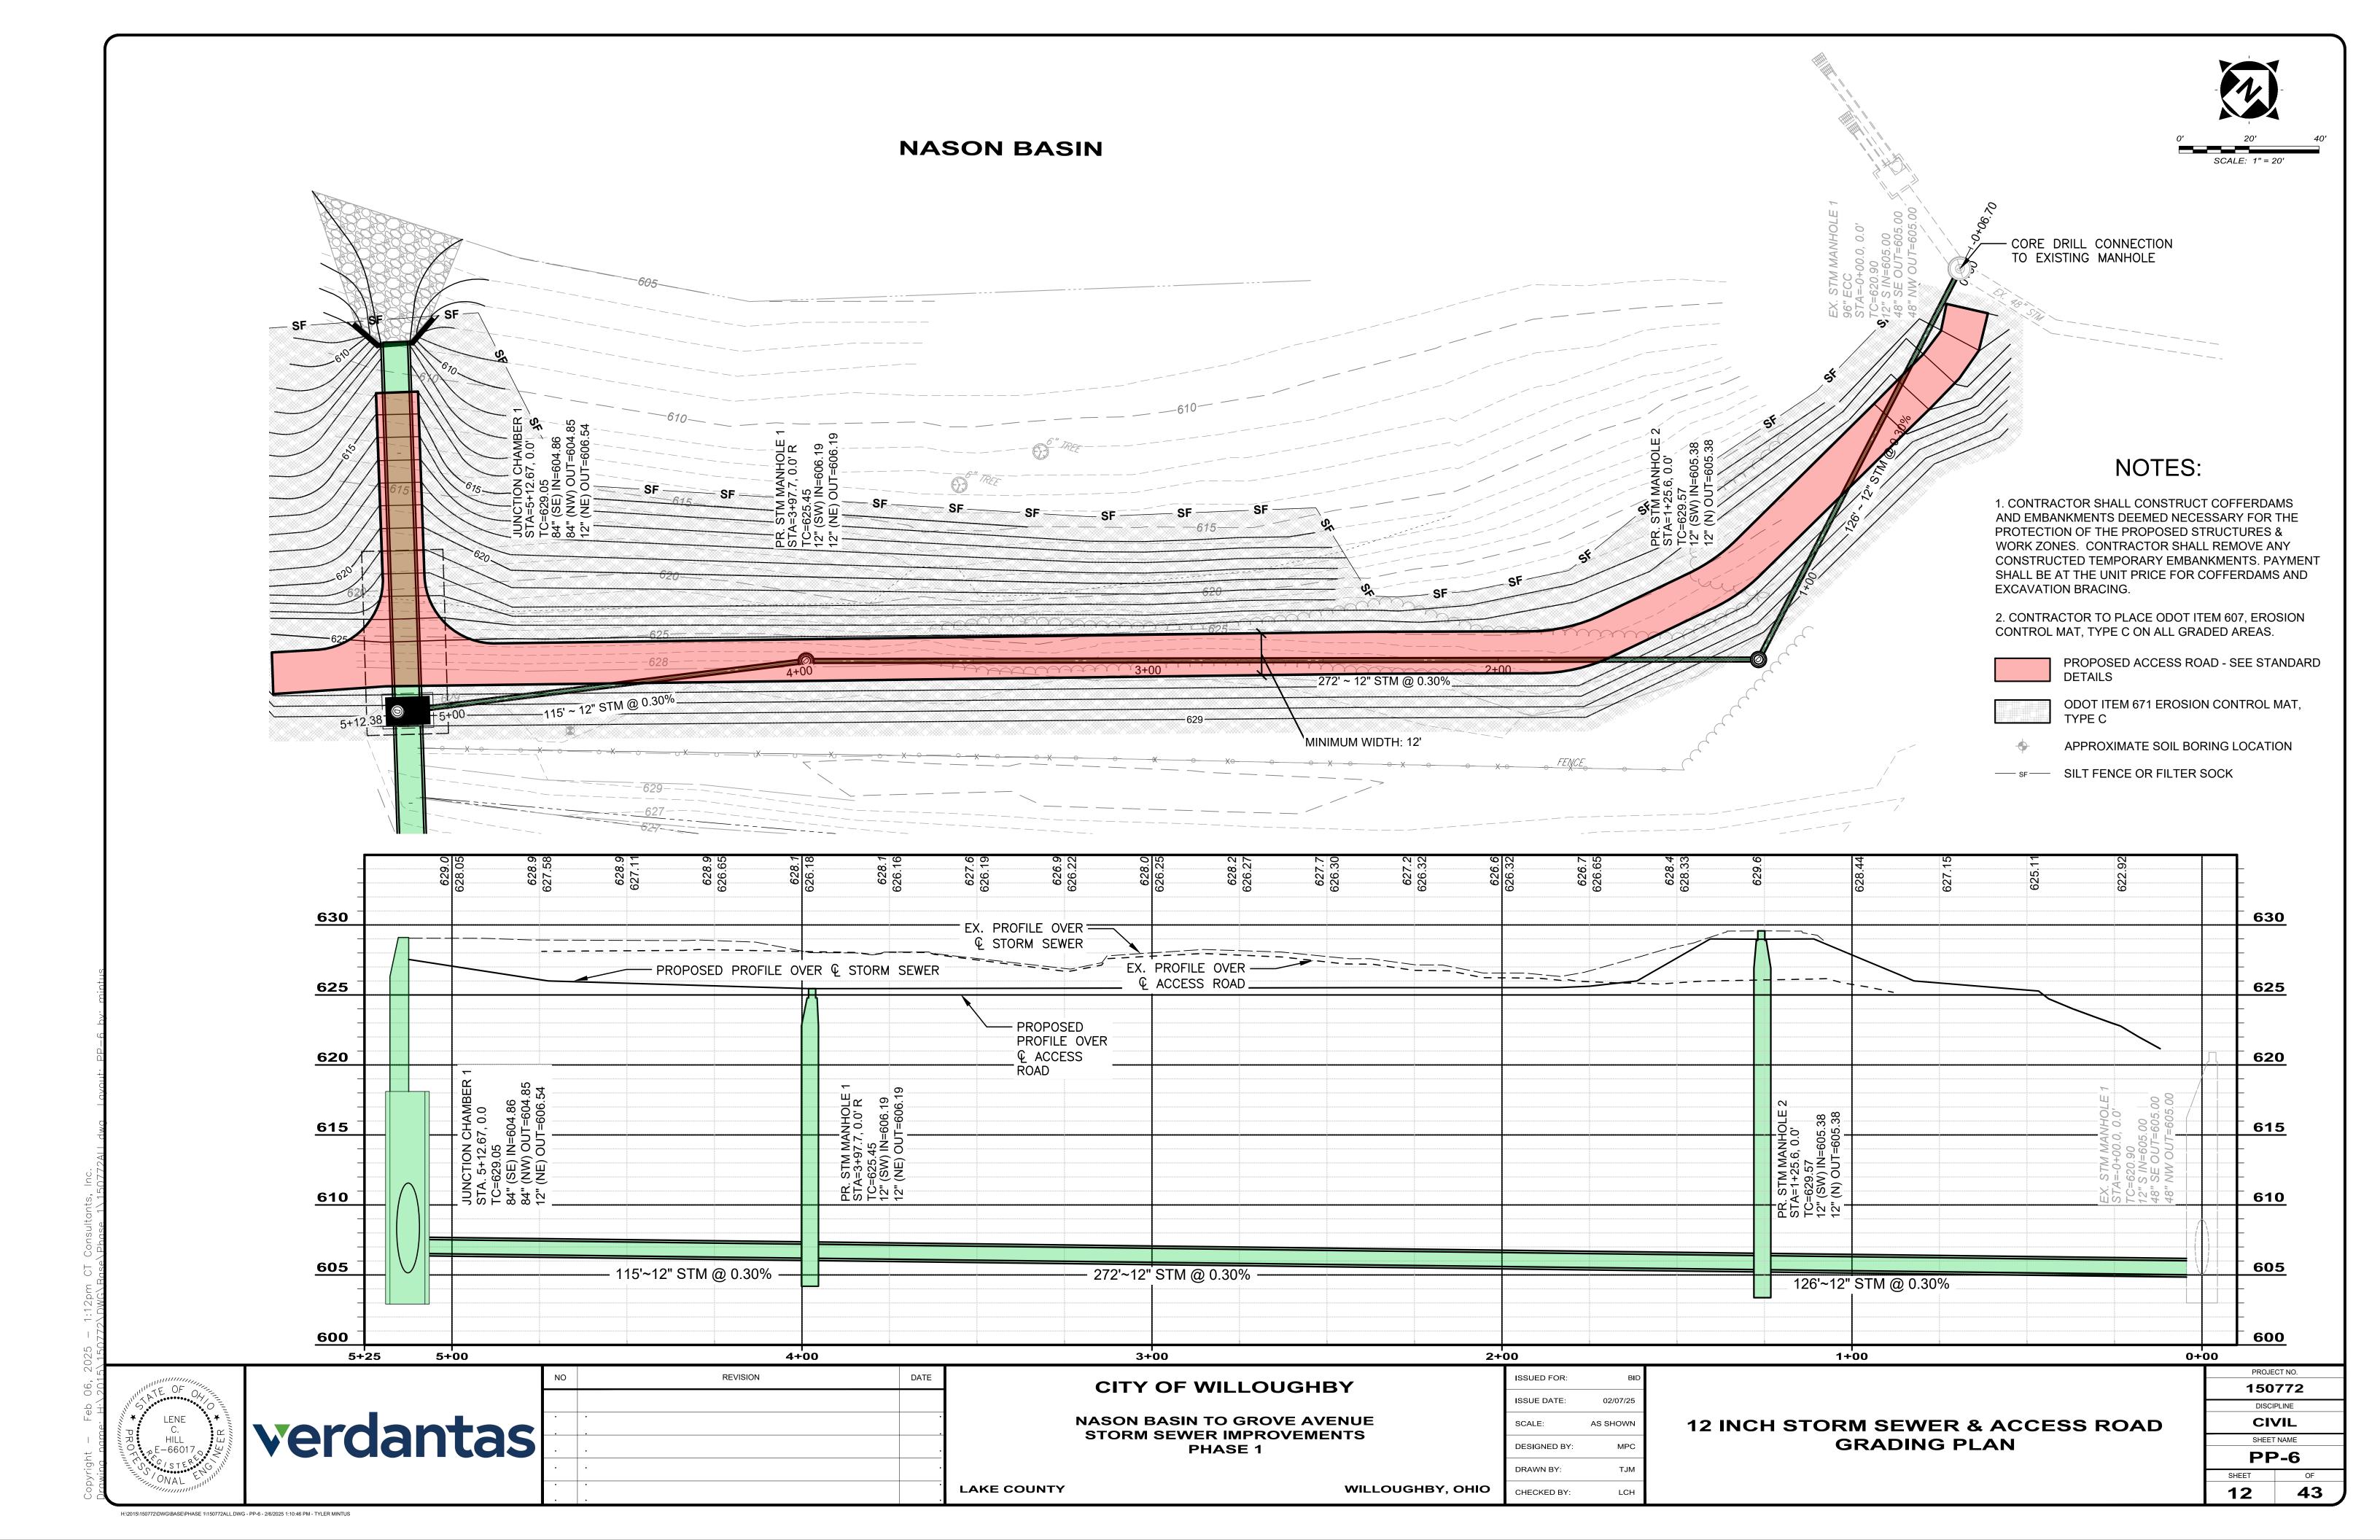
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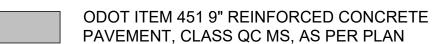
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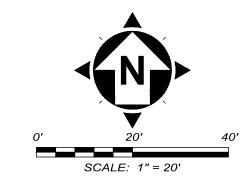


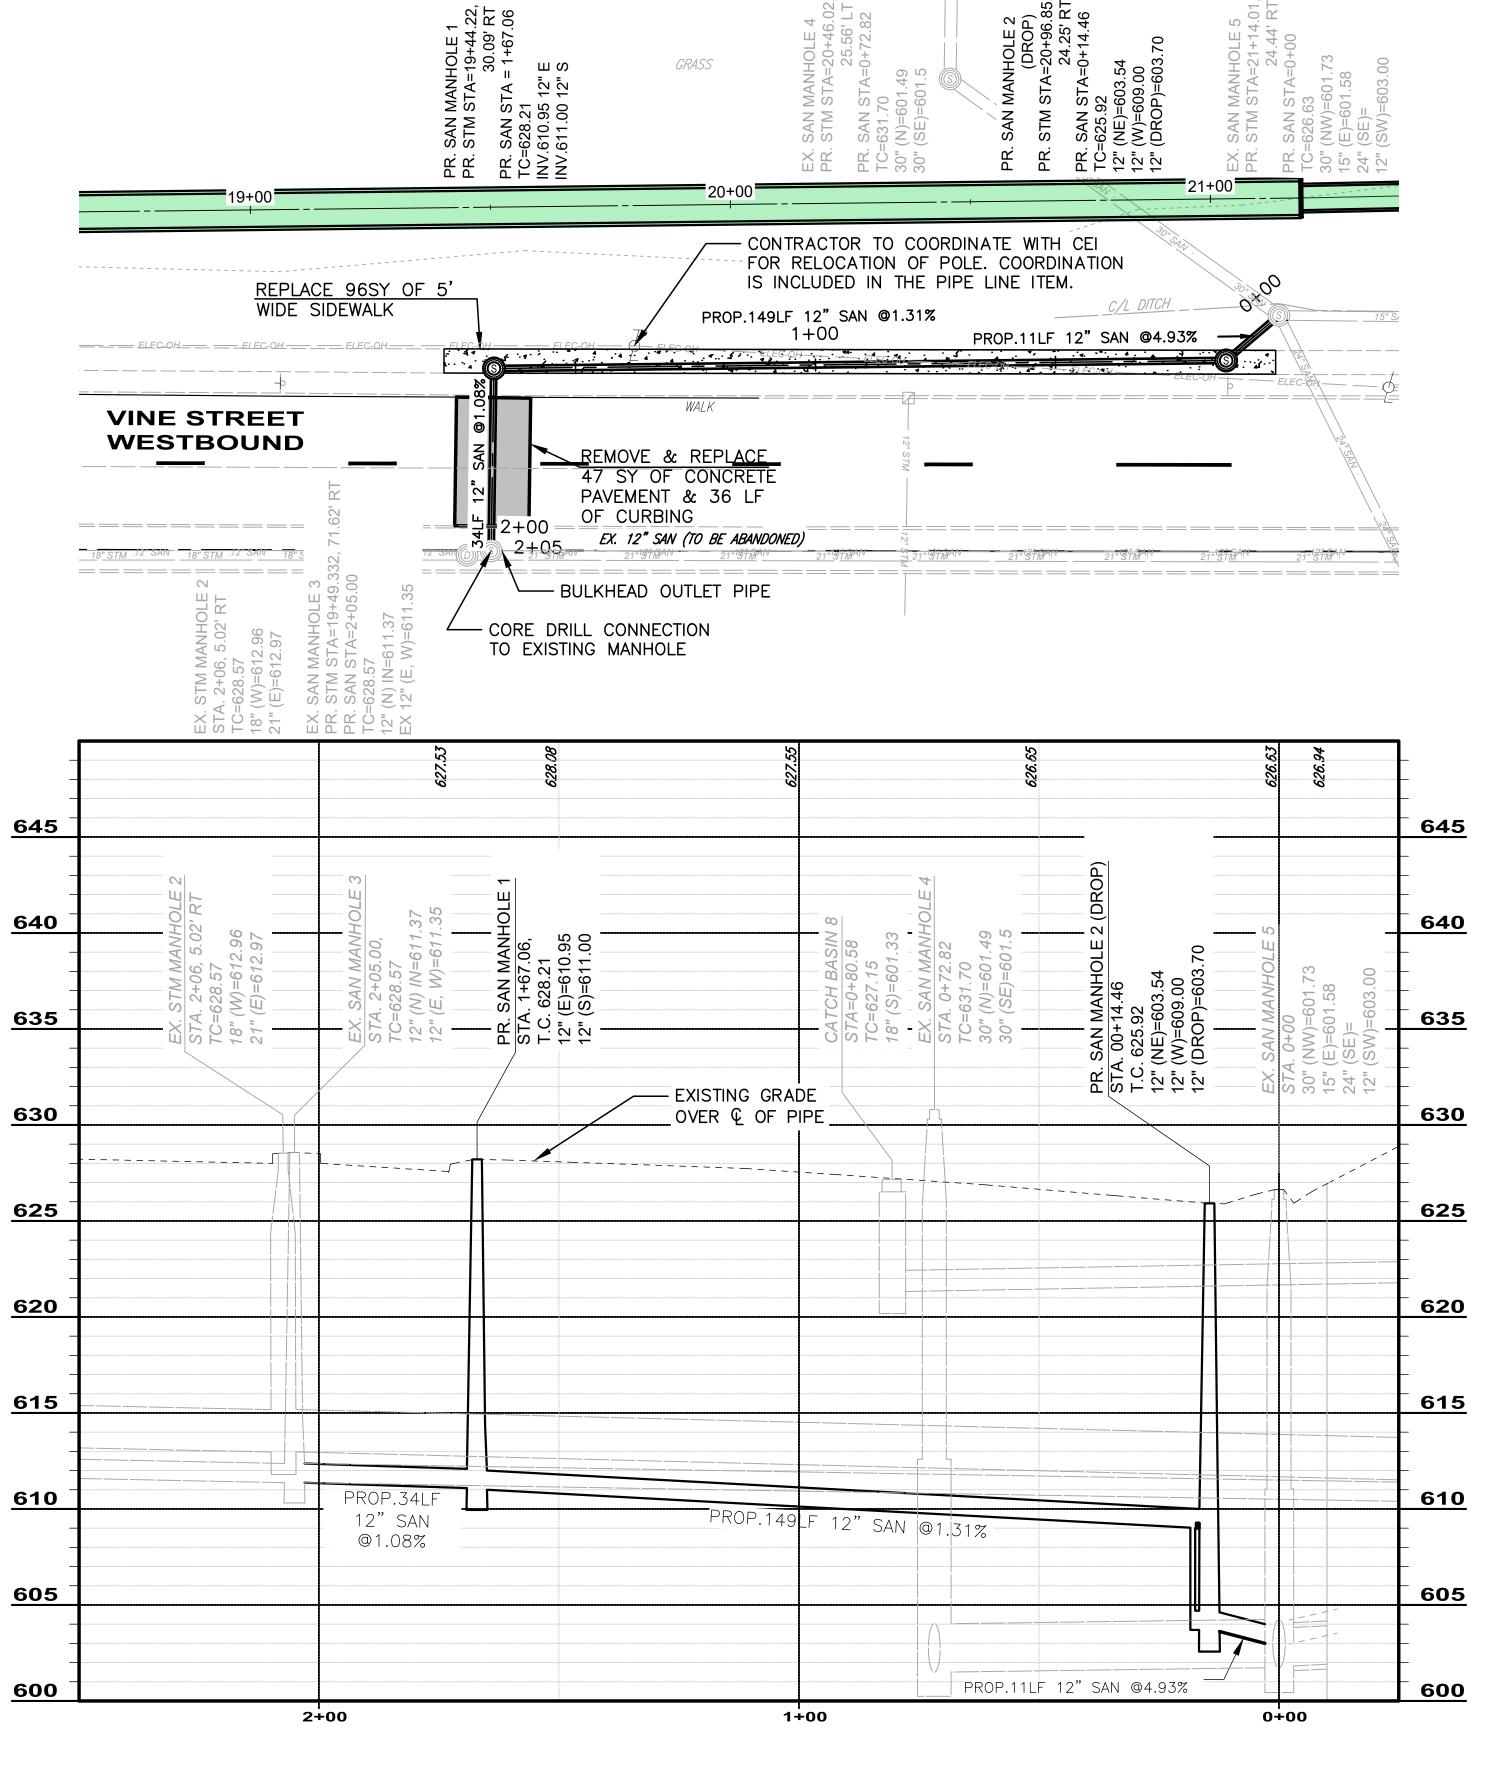


LEGEND:

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CITY OF WILLOUGHBY

NASON BASIN TO GROVE AVENUE
STORM SEWER IMPROVEMENTS
PHASE 1

LAKE COUNTY

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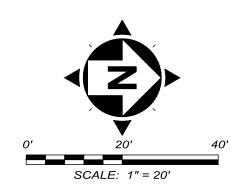
WILLOUGHBY, OHIO

SANITARY SEWER PLAN & PROFILE

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LAKE COUNTY



NOTES:

1. EXCAVATION LINE ITEM INCLUDES
MOBILIZATION, CLEARING AND GRUBBING,
EROSION CONTROL, HAUL ROAD
INSTALLATION AND REMOVAL, EXCAVATION,
DREDGING, DREDGING ACCESS,
DEWATERING, RESTORATION, AND
SPREADING OF THE DREDGED MATERIALS
OVER FINAL GRADING AT THE PELTON ROAD
LANDFILL.

REPAIR REVETMENT
WITH ODOT ITEM 601
DUMPED ROCK FILL,
TYPE A

LENE

C.

HILL

PROFISSO STERES ON THE STATE OF ONAL

verdantas No Revision DATE

CITY OF WILLOUGHBY

NASON BASIN TO GROVE AVENUE STORM SEWER IMPROVEMENTS PHASE 1

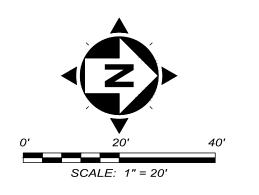
WILLOUGHBY, OHIO C

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ISSUE DATE:	02/07/25	
SCALE:	AS SHOWN	
DESIGNED BY:	MPC	
DRAWN BY:	TJM	
CHECKED BY:	LCH	

PROPOSED DREDGING PLAN

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150772									
DISCIPLINE									
CIVIL									
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14	43								

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ONAL ENGINE	

Verdantas NO REVISION DATE

LAKE COUNTY

CITY OF WILLOUGHBY

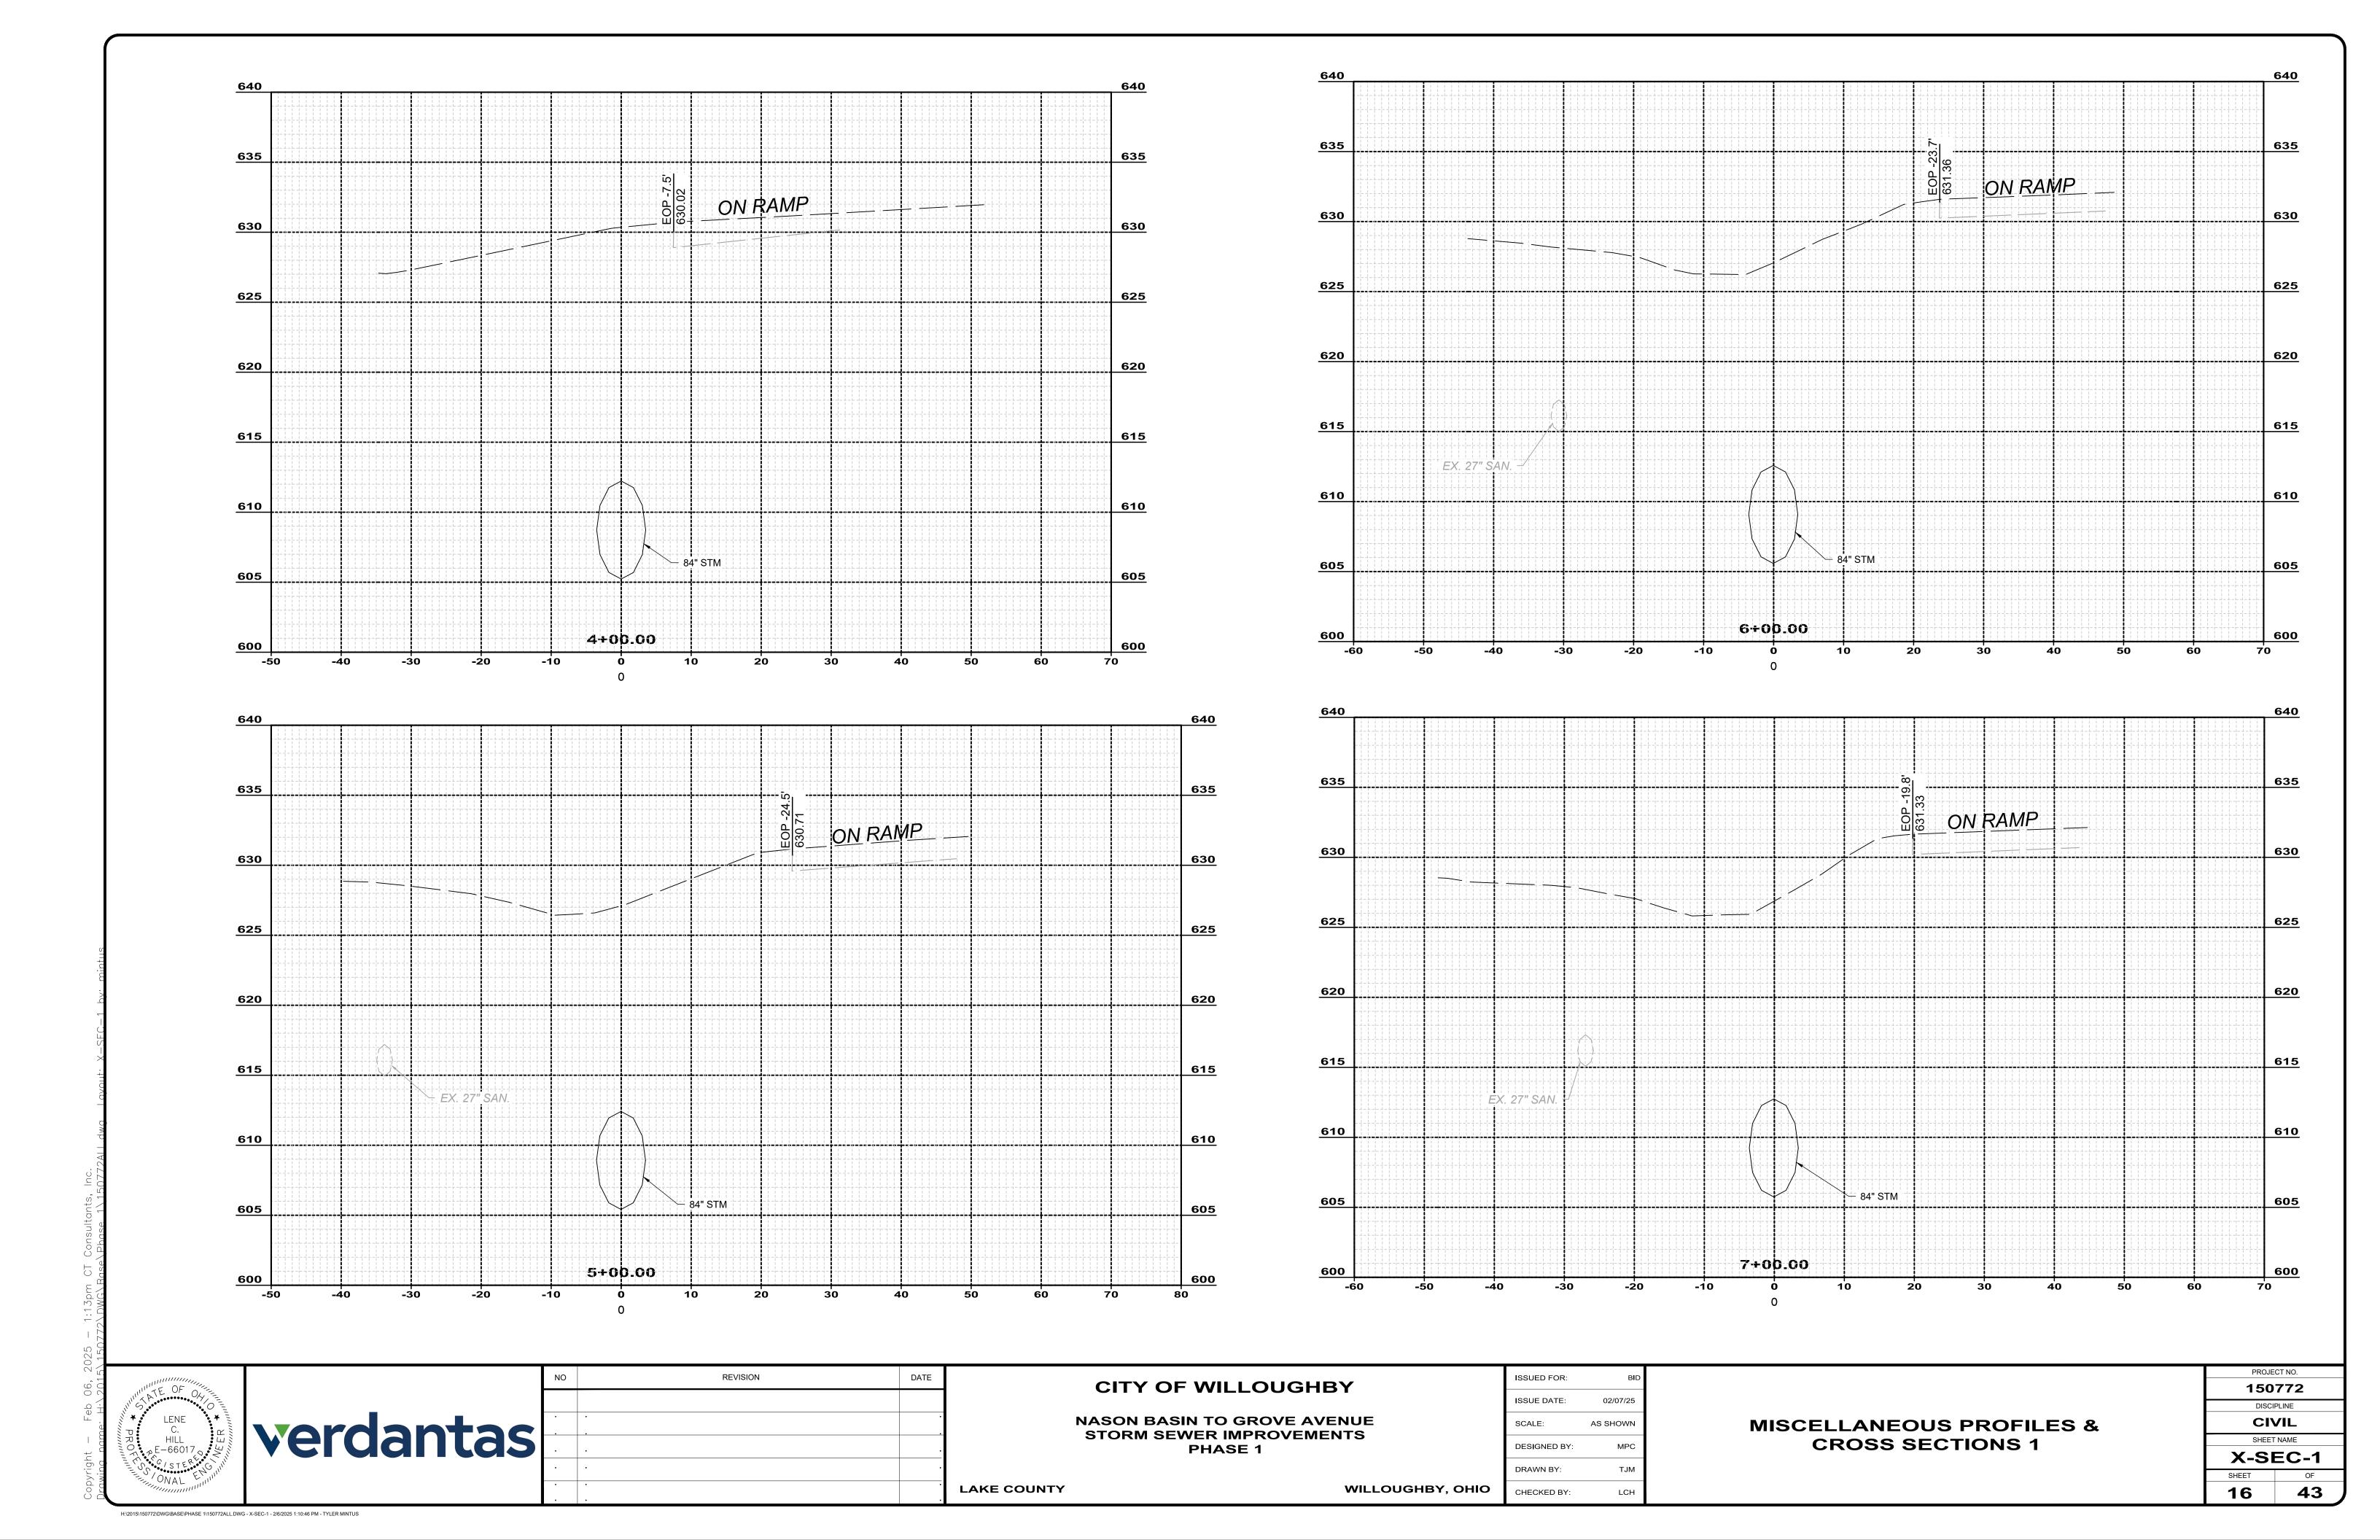
NASON BASIN TO GROVE AVENUE STORM SEWER IMPROVEMENTS PHASE 1

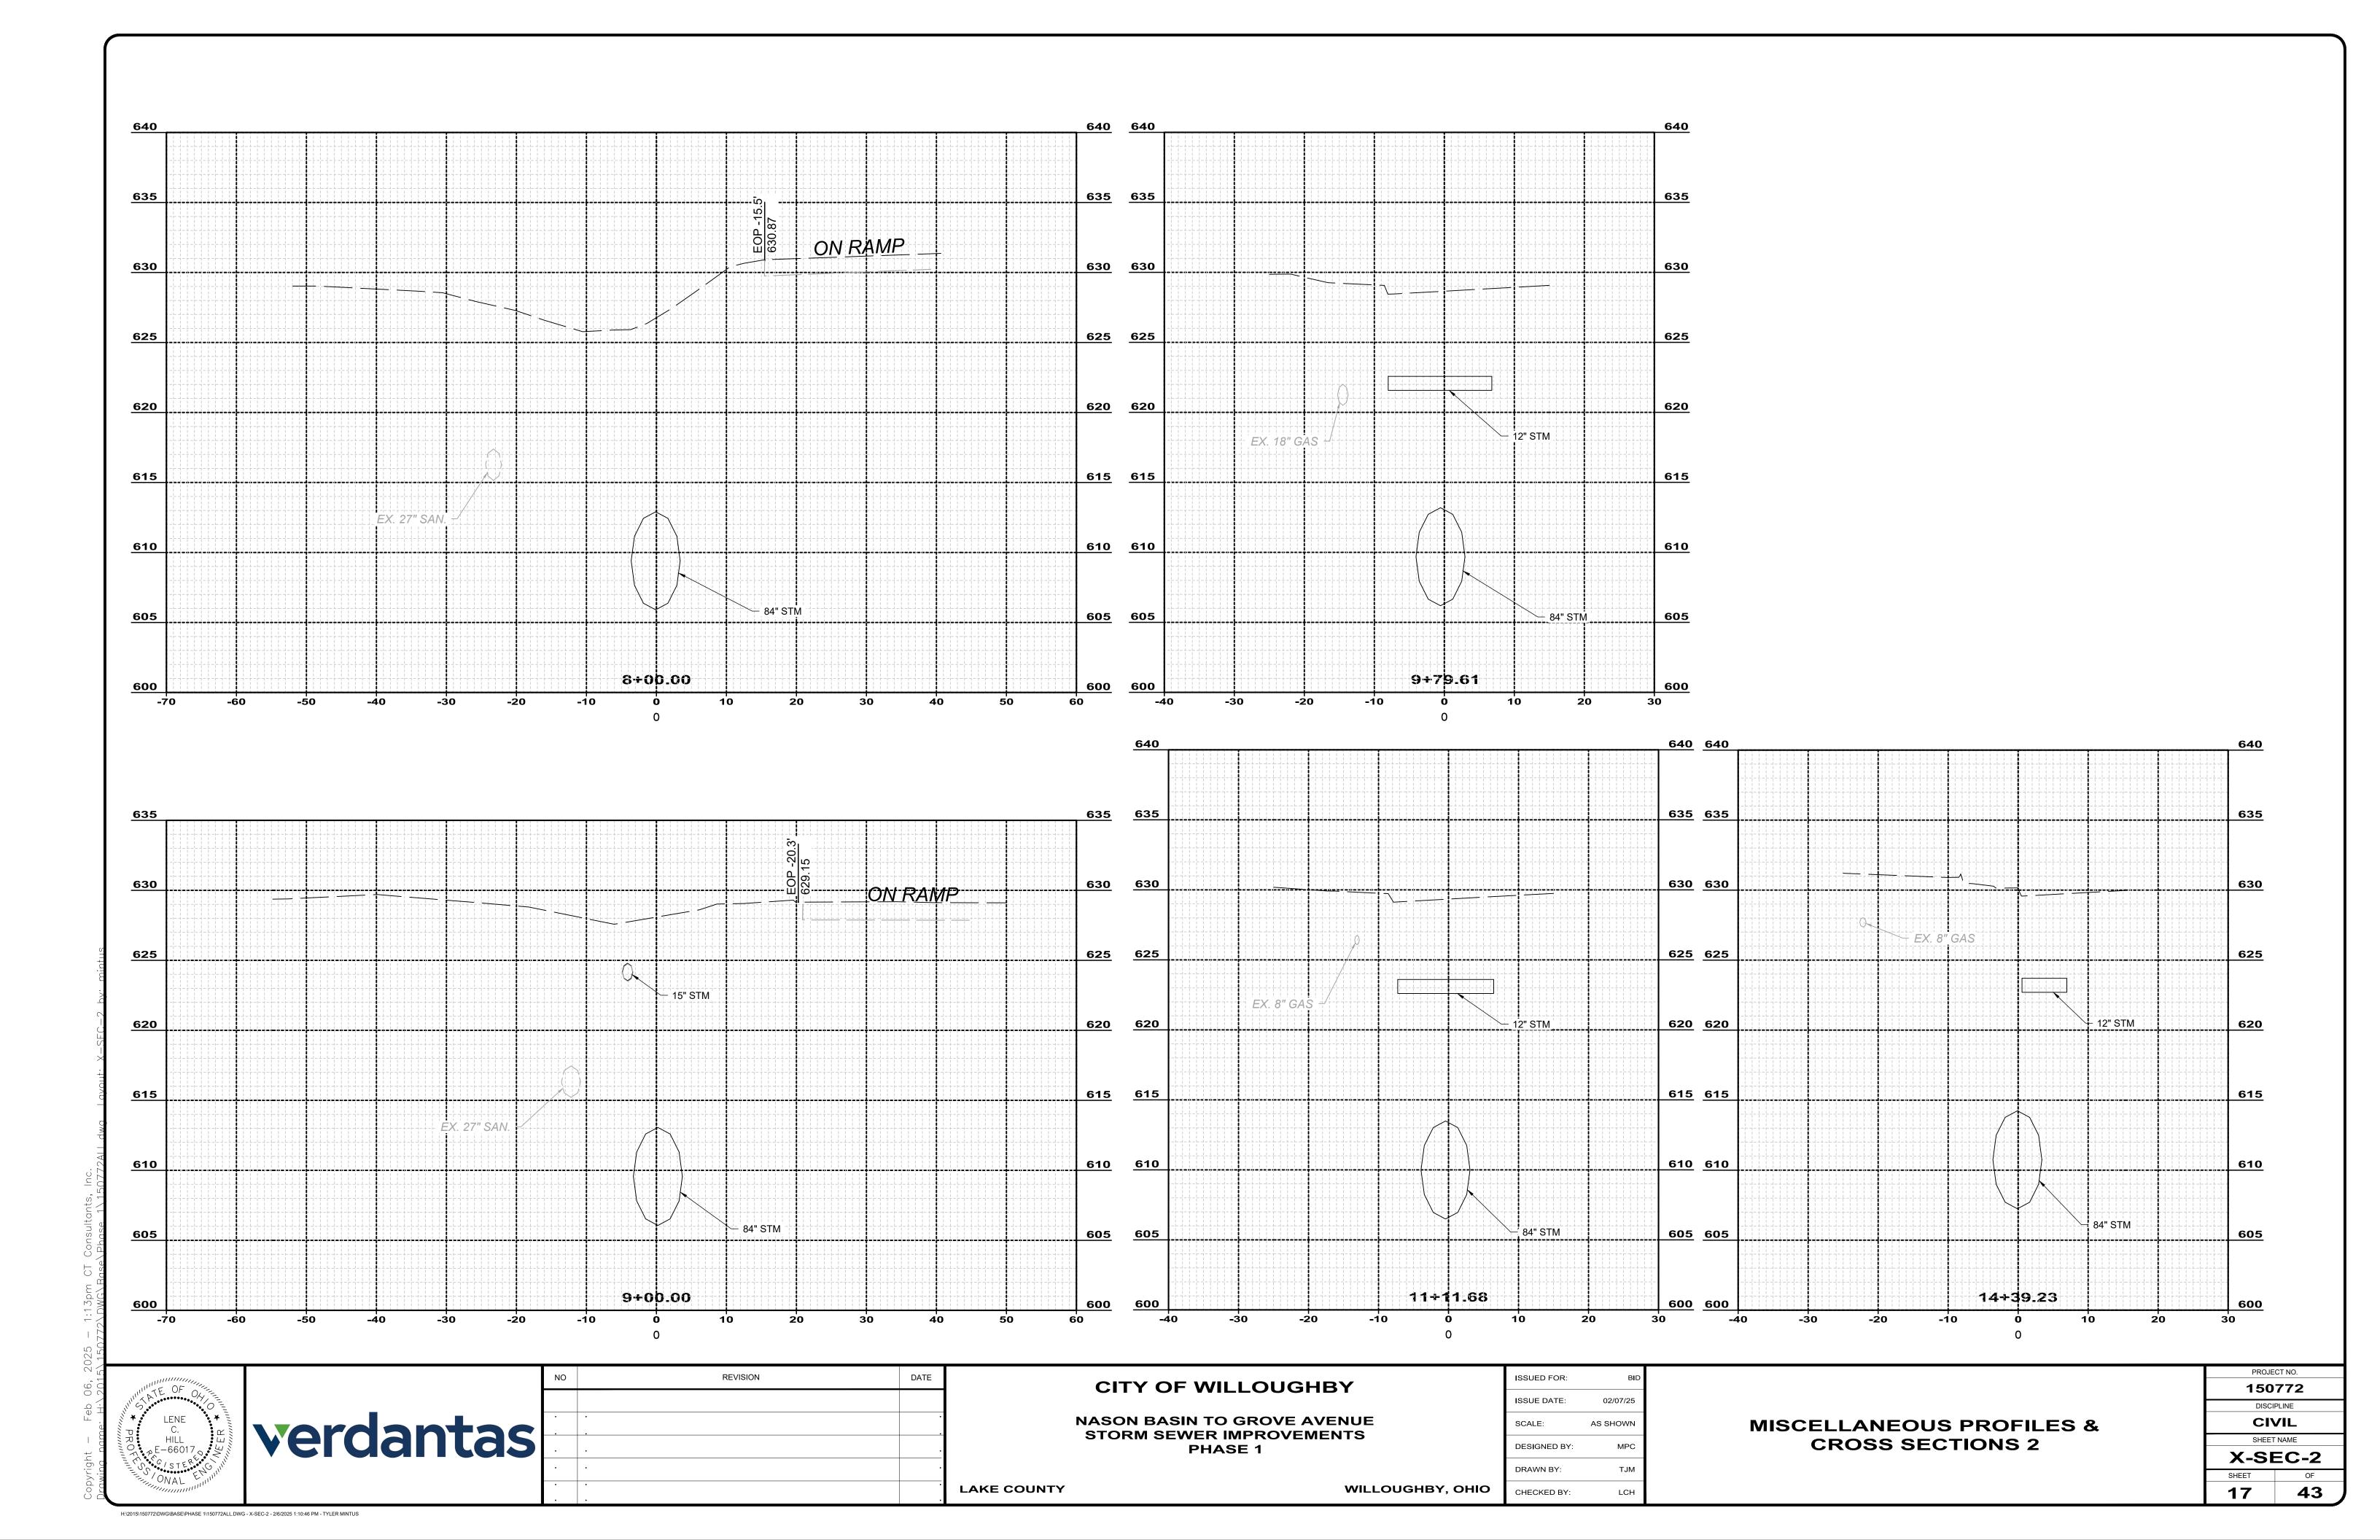
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WILLOUGHBY, OHIO	CHECK

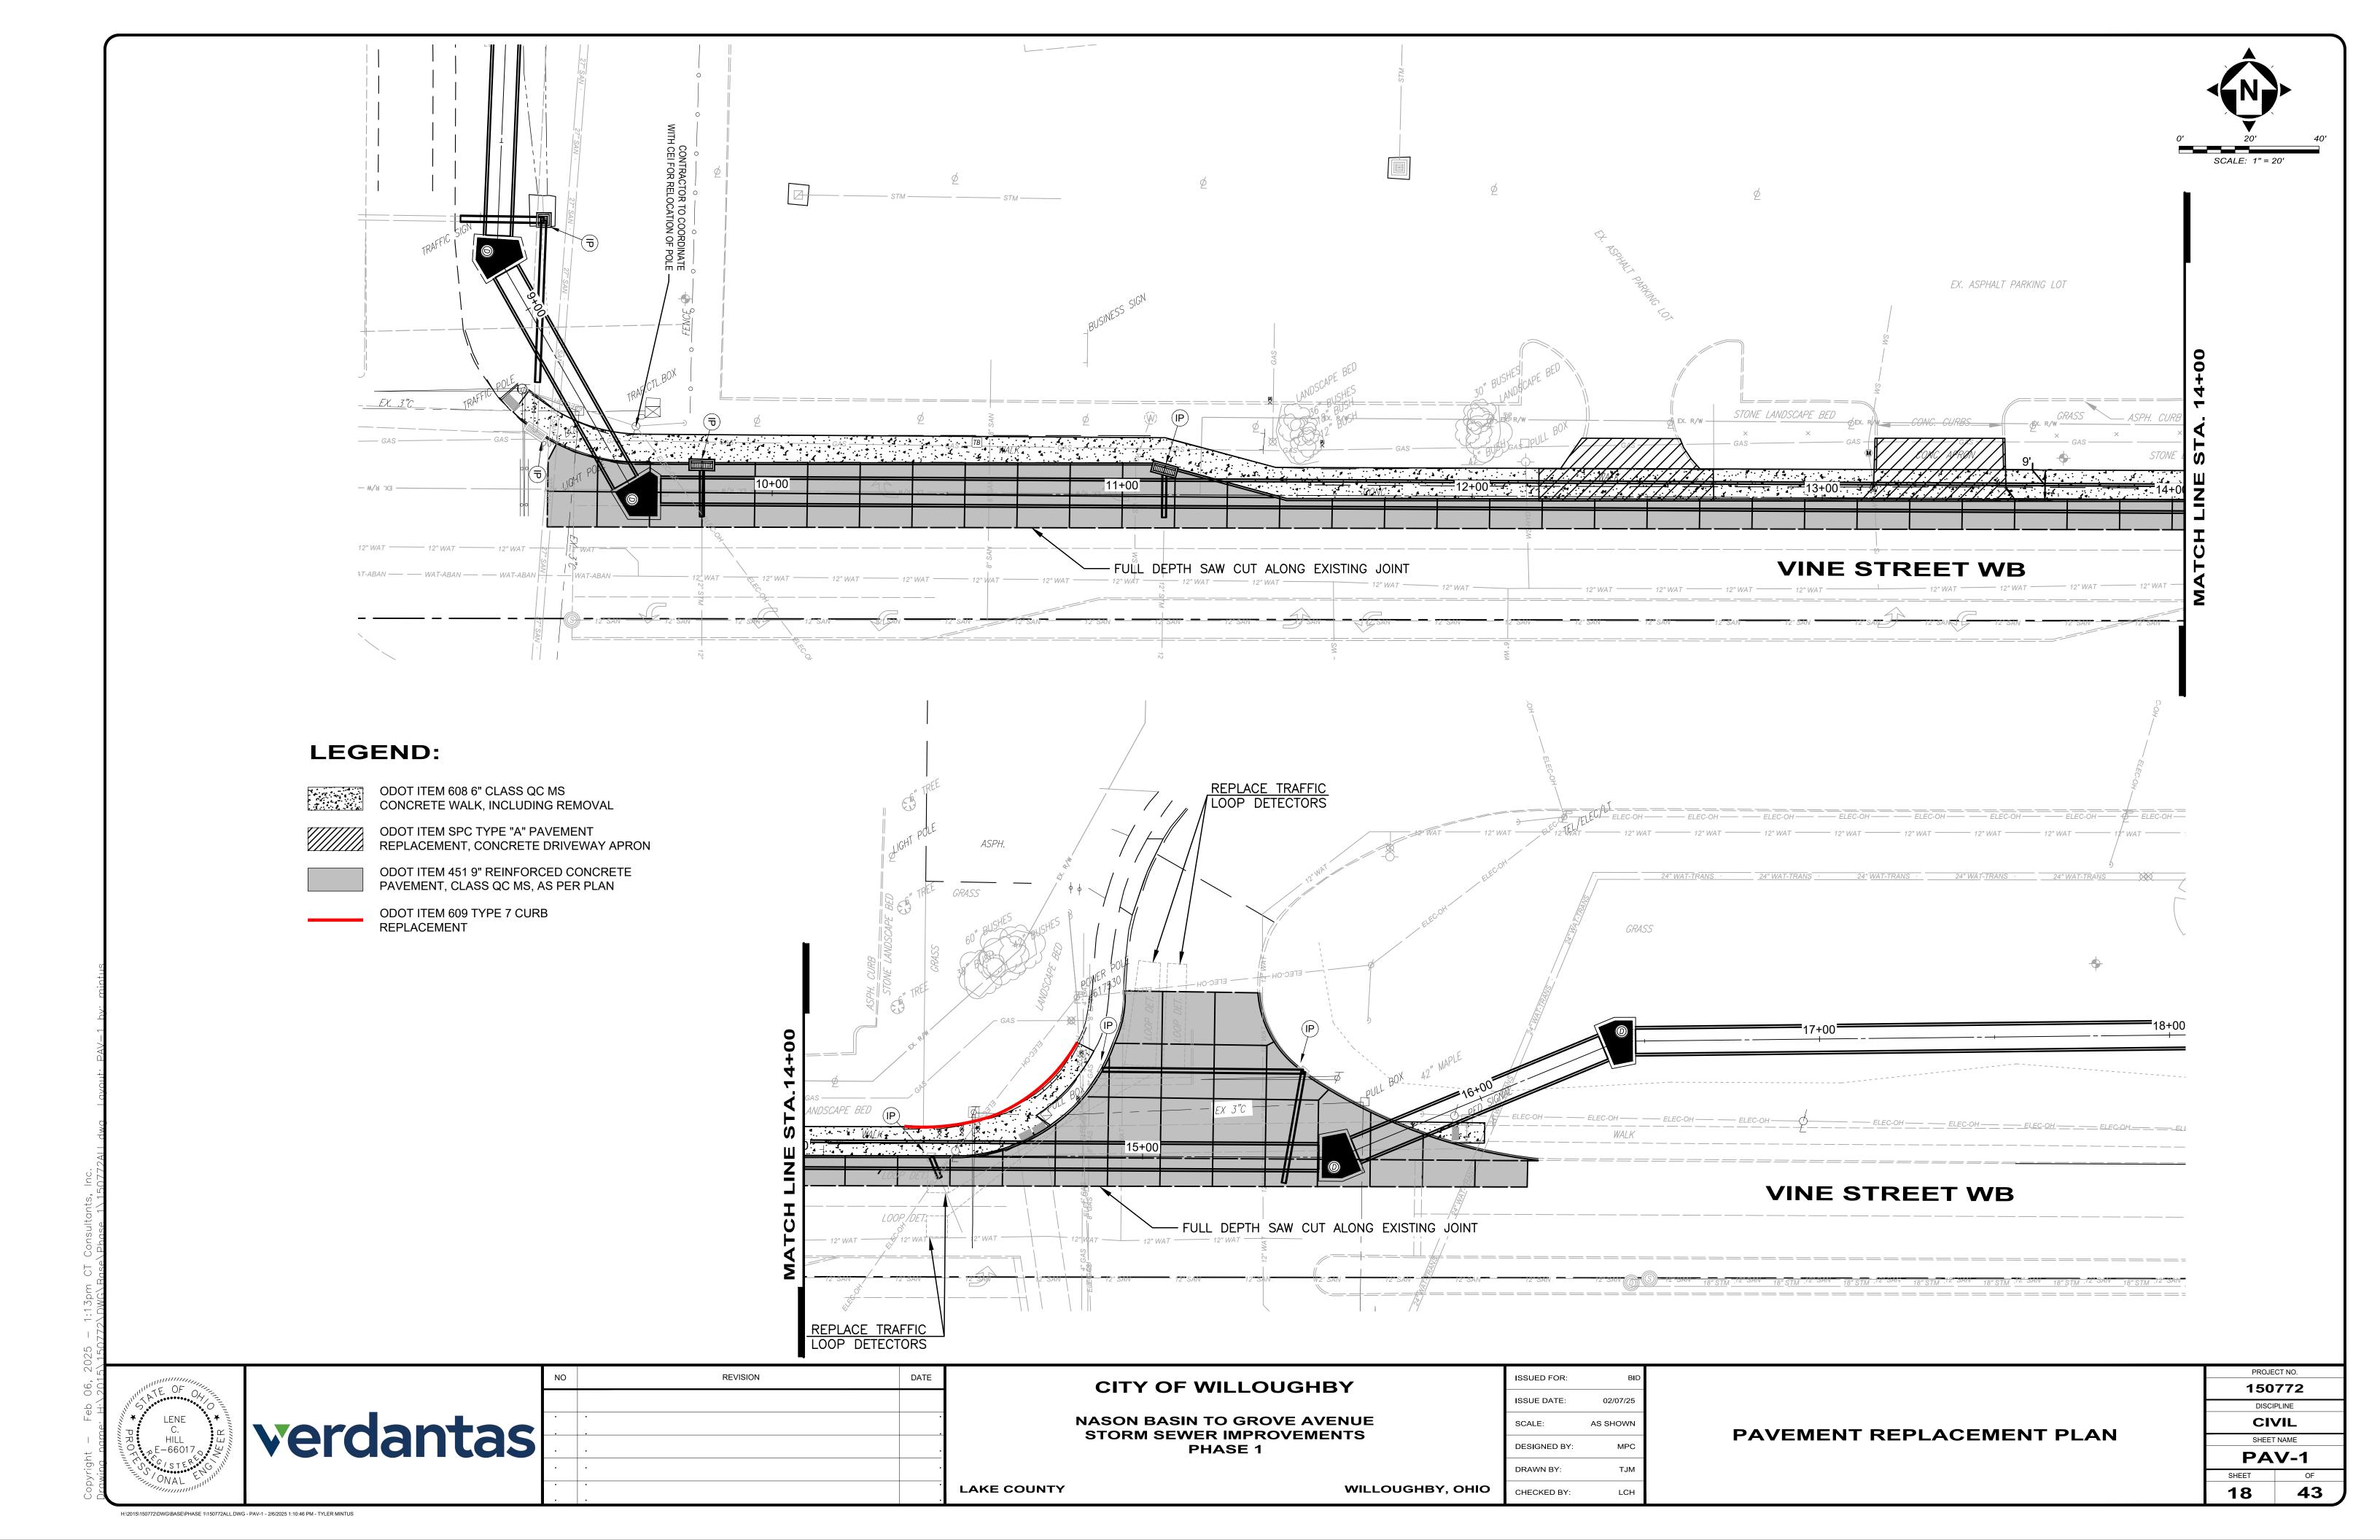
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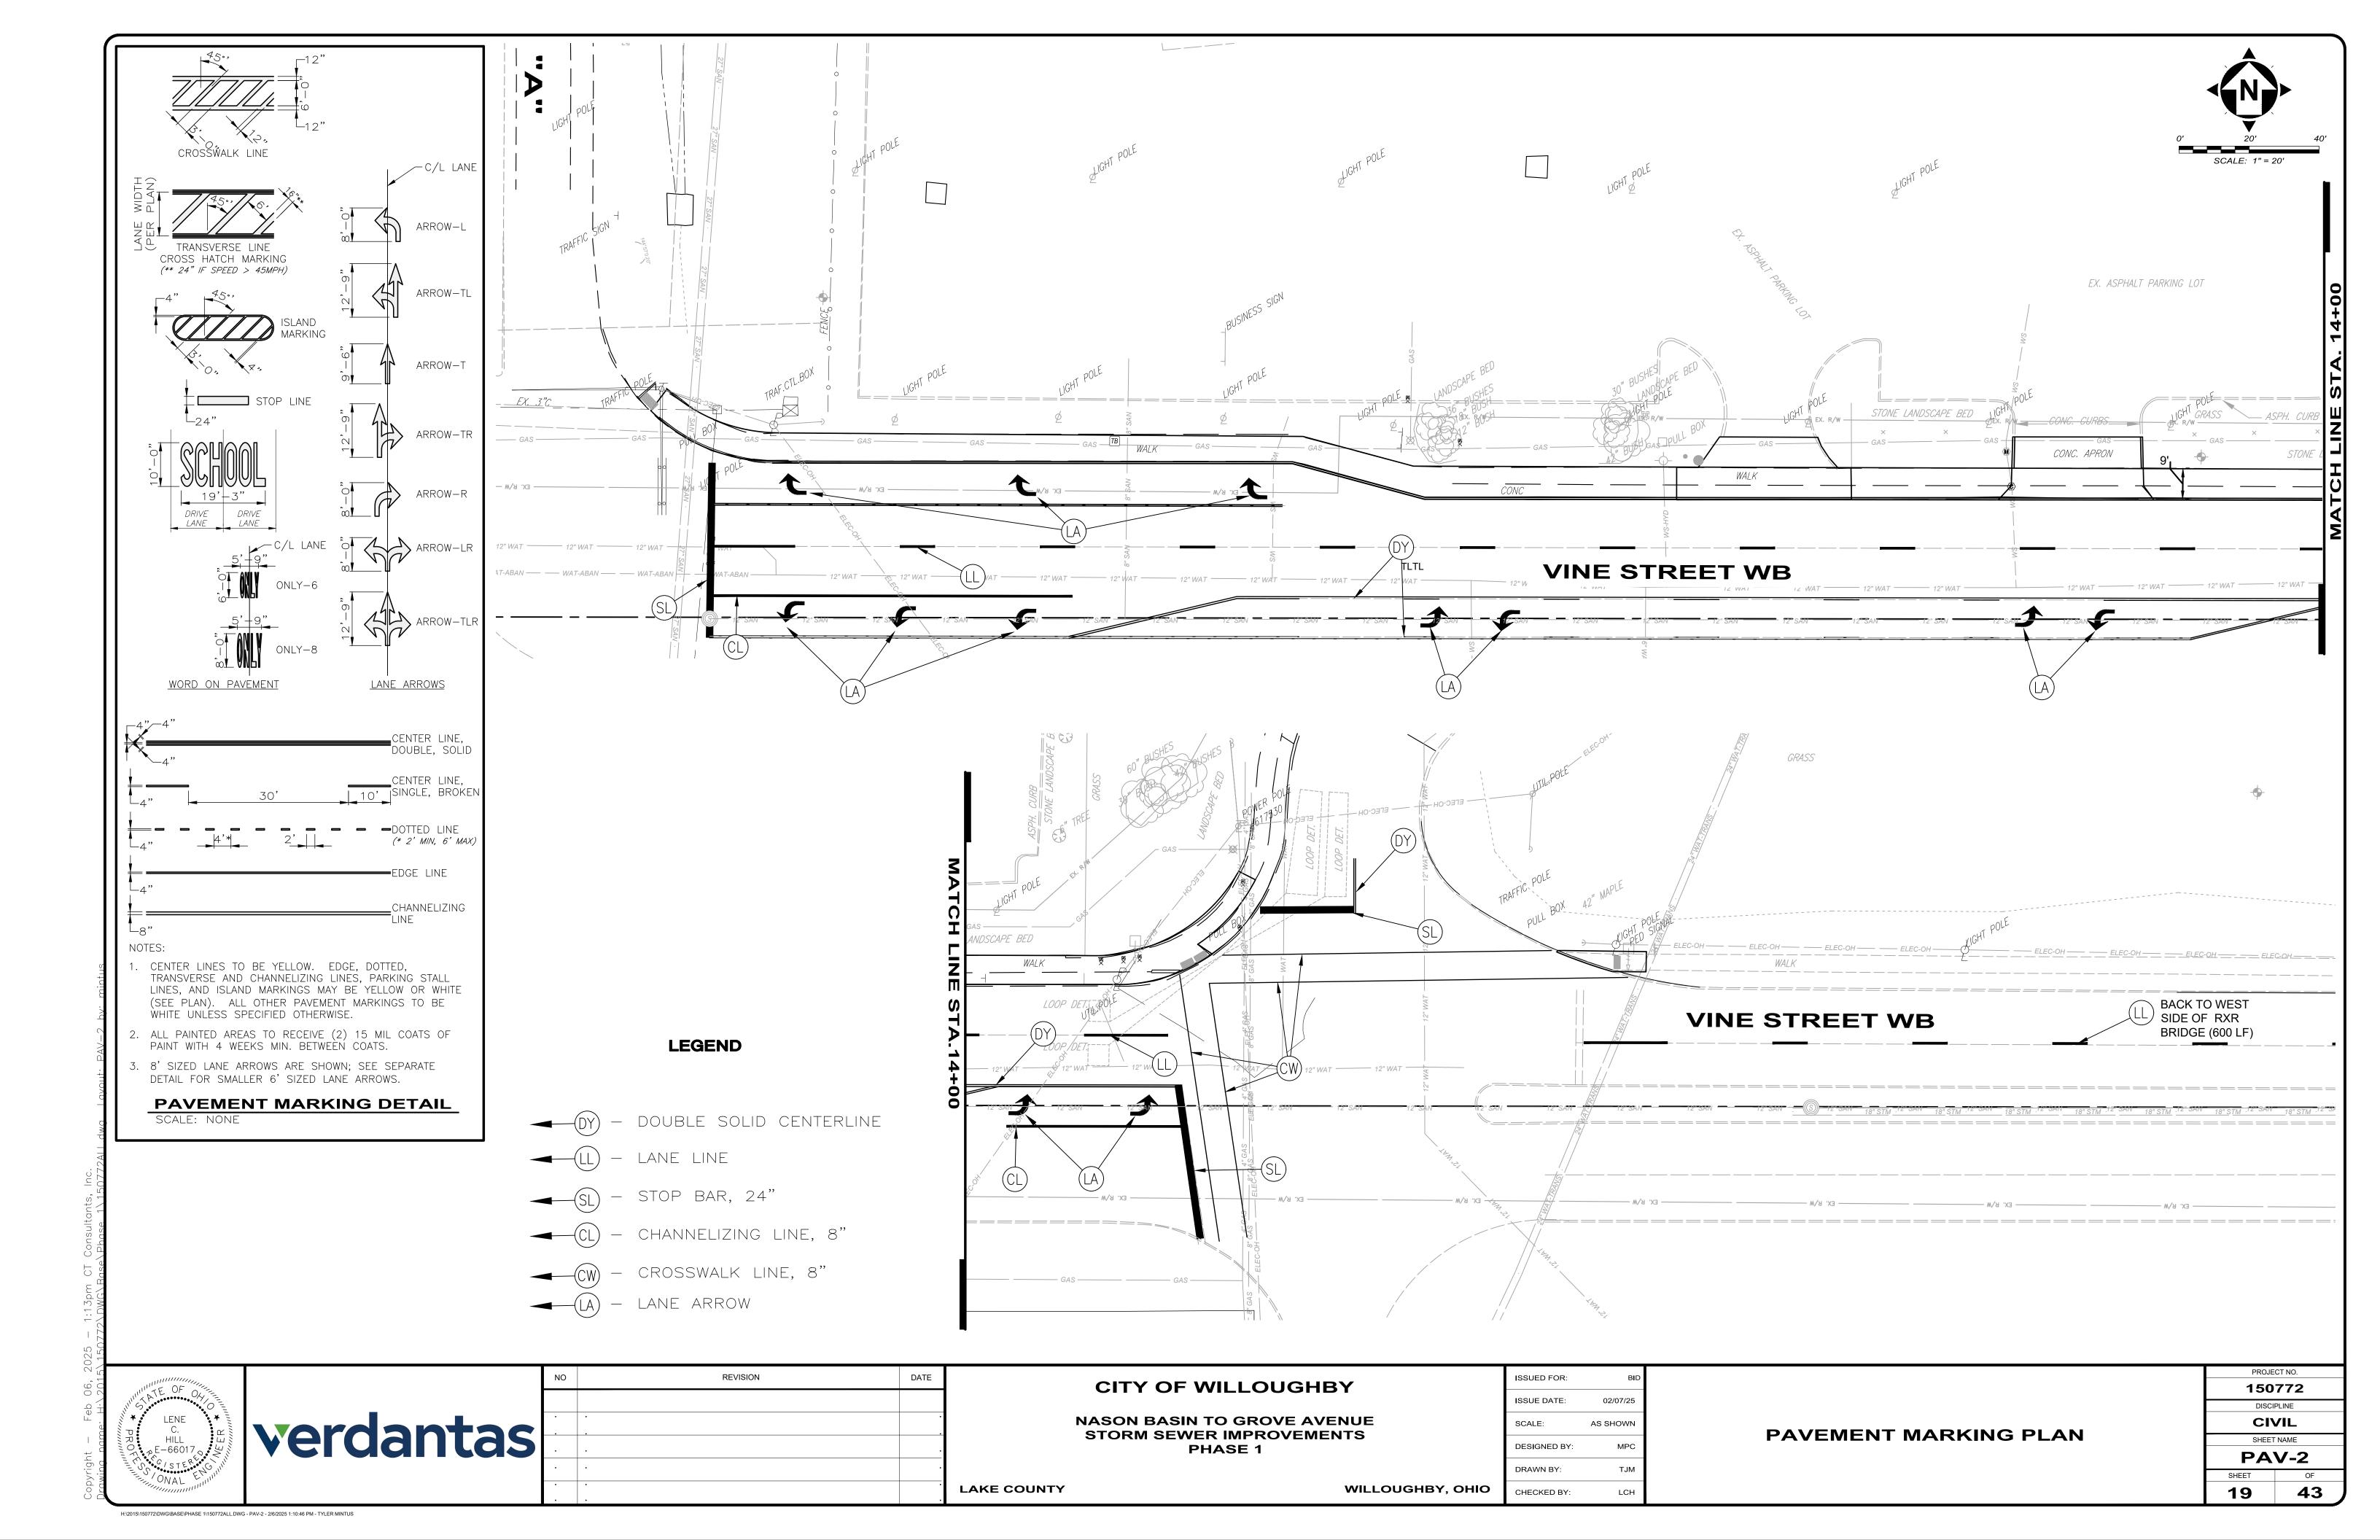
BASIN DREDGE DEPTH

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DISCIPLINE									
CIVIL									
SHEET	NAME								
Dre	dge								
SHEET	OF								
15	43								









ITEM 614 - MAINTAINING TRAFFIC

ALL CONSTRUCTION TRAFFIC CONTROL DEVICES USED FOR THIS PROJECT SHALL CONFORM TO THE OHIO MANUAL OF UNIFORM TRAFFIC CONTROL DEVICES FOR STREETS AND HIGHWAYS, HEREINAFTER REFERRED TO AS THE MANUAL, AND SHALL BE FURNISHED, ERECTED, MAINTAINED, RELOCATED AND REMOVED BY THE CONTRACTOR.

THE CONTRACTOR SHALL FURNISH AND MAINTAIN ALL NECESSARY SAFEGUARDS, SUCH AS BARRICADES, LIGHTING, FLAGGERS, PLASTIC DRUMS, FLASHING ARROW PANELS AND SUCH OTHER TRAFFIC CONTROL DEVICES AS PROVIDED IN ITEM 614, MAINTAINING TRAFFIC, SO AS TO AVOID DAMAGE AND/OR INJURY TO VEHICLES AND PERSONS USING THE ROADWAY DURING CONSTRUCTION. WHENEVER THE ENGINEER DEEMS IT NECESSARY, HE MAY DIRECT THAT ADDITIONAL OR ALTERNATIVE DEVICES BE USED. ALSO, THE CONTRACTOR SHALL PROVIDE SUFFICIENT ADDITIONAL BARRICADES, ETC. TO PROTECT THE FRESH PAVEMENT DURING THE CURING PERIOD FROM VEHICLES WHICH MAY DRIVE AROUND OR THROUGH THE TRAFFIC CONTROL.

TRAFFIC CONTROL DEVICES SHALL BE SET UP PRIOR TO THE START OF CONSTRUCTION AND SHALL BE PROPERLY MAINTAINED DURING THE TIME SUCH SPECIAL CONDITIONS EXIST. THEY SHALL REMAIN IN PLACE ONLY AS LONG AS THEY ARE NEEDED AND SHALL BE IMMEDIATELY REMOVED THEREAFTER. WHERE OPERATIONS ARE PERFORMED IN PHASES, THERE SHALL BE IN PLACE ONLY THOSE DEVICES THAT APPLY TO THE CONDITION PRESENT DURING THE PHASE—IN PROGRESS. ALL SIGNS WITH MESSAGES WHICH DO NOT APPLY DURING A CERTAIN PERIOD SHALL BE COVERED OR SET ASIDE OUT OF THE VIEW OF TRAFFIC. CONFLICTING PAVEMENT MARKINGS SHALL BE REMOVED IN ACCORDANCE WITH SECTION 641.10 OF THE OHIO SPECIFICATIONS BEFORE ANY SECTION OF ROADWAY IS MADE AVAILABLE TO USE BY TRAFFIC.

ALL PERMANENT AND TEMPORARY PAVEMENT MARKINGS ARE TO BE MAINTAINED THROUGHOUT THE PROJECT. ANY DAMAGED OR FADED PAVEMENT MARKINGS SHALL BE CORRECTED WITHIN EIGHT HOURS AFTER THE CONTRACTOR'S NOTIFICATION OF THE PROBLEM. IF WEATHER IS NOT CONDUSIVE TO PAVEMENT MARKING INSTALLATION THEN REPAIRS SHALL BE MADE ON THE FIRST WEATHER PERMISSIVE DAY AFTER NOTIFICATION.

ALL WORK AND TRAFFIC CONTROL DEVICES SHALL BE IN ACCORDANCE WITH ODOT ITEM 614 APPLICABLE SECTIONS OF THE SPECIFICATIONS AS WELL AS THE MANUAL. PAYMENT FOR ALL LABOR. EQUIPMENT AND MATERIALS SHALL BE INCLUDED IN THE LUMP SUM CONTRACT PRICE FOR ITEM 614, MAINTAINING TRAFFIC, UNLESS OTHERWISE SEPARATELY ITEMIZED IN THE PLANS.

THE CONTRACTOR WILL FURNISH AND INSTALL TRAFFIC COMPACTED SURFACE WITH ODOT 304 INCLUDING NECESSARY WATER AND CALCIUM CHLORIDE FOR DUST CONTROL.

WORK HOURS

NO WEEKEND WORK OR WORK BETWEEN THE HOURS OF 9:00 PM TO 7:00 AM SHALL BE PERMITTED UNLESS OTHERWISE SPECIFICALLY APPROVED BY THE ENGINEER.

PROVIDING CONTINUOUS ACCESS TO RESIDENCES AND BUSINESSES

TWO WEEKS PRIOR TO THE START OF WORK, THE CONTRACTOR SHALL SUBMIT TO THE ENGINEER A COMPLETE SCHEDULE OF CONSTRUCTION OPERATIONS ALONG WITH PLANS SHOWING TRAFFIC CONTROL FOR EACH PHASE OF CONSTRUCTION. INCLUDED SHALL BE DETAILS OF THE PROPOSED METHODS TO MAINTAIN SAFE AND CONTINUOUS ACCESS FOR PASSENGER VEHICLES, TRUCKS AND SAFETY EQUIPMENT TO ALL ADJOINING PROPERTIES AND INTERSECTING STREETS. THESE PLANS SHALL INCLUDE ALL TEMPORARY MATERIALS NECESSARY TO PROVIDE SAFE, ADEQUATE DRIVE SURFACES TO ALL ADJOINING PROPERTIES. THE COST FOR ALL MATERIALS, EQUIPMENT AND LABOR NECESSARY TO PROVIDE CONTINUOUS ACCESS SHALL BE INCLUDED IN THE LUMP SUM PRICE BID FOR ODOT ITEM 614, MAINTAINING TRAFFIC. PLANS MUST BE SUBMITTED TO THE ENGINEER AND APPROVED PRIOR TO COMMENCING ANY WORK

SHOULD THE ENGINEER, AT ANY TIME PRIOR TO OR DURING CONSTRUCTION, DEEM ANY PART OF THE CONTRACTOR'S PLANS FOR SAFE AND CONTINUOUS ACCESS TO RESIDENCES AND BUSINESSES INADEQUATE, ADDITIONAL MATERIALS, CLOSURES AND/OR DIVERSIONS SHALL BE REQUIRED AT NO ADDITIONAL COST TO THE CITY.

WHERE CONSTRUCTION ACTIVITIES MAY REQUIRE AN ALTERNATE CIRCULATION PATH, THE CONTRACTOR SHALL TAKE APPROPRIATE MEASURES TO SECURE A TEMPORARY PEDESTRIAN ACCESS ROUTE. THE TEMPORARY PEDESTRIAN ACCESS ROUTE SHALL ACCOMMODATE PERSONS WITH DISABILITIES IN ACCORDANCE WITH THE MUTCD, FEDERAL AND LOCAL GUIDELINES OR REGULATIONS. THE CONTRACTOR SHALL MAINTAIN FACILITIES ON A 24 HOUR BASIS UNTIL THE PROJECT IS COMPLETE AND ACCEPTED BY THE CITY.

NOTIFICATION OF PROPERTY OWNERS

THE CONTRACTOR SHALL NOTIFY ALL RESIDENCES AND BUSINESSES ALONG THE PROJECT ROUTE IN WRITING AT LEAST FORTY-EIGHT (48) HOURS PRIOR TO COMMENCING WORK. SUCH NOTICE SHALL INCLUDE, AT A MINIMUM, A BRIEF PROJECT DESCRIPTION, TENTATIVE CONSTRUCTION SCHEDULE, LIMITS OF CONSTRUCTION, THE CONTRACTOR'S NAME, ADDRESS AND PHONE NUMBER, AS WELL AS A CONTACT PERSON'S NAME AND EMERGENCY PHONE NUMBER WHERE HE COULD BE REACHED DURING NON-WORK HOURS. THE NOTICE SHALL ALSO REQUEST THAT THE PROPERTY OWNERS PROVIDE INFORMATION TO THE CONTRACTOR AND/OR CITY OF WILLOUGHBY REGARDING THE LOCATIONS OF ANY UNDERGROUND PET FENCING, LAWN SPRINKLER SYSTEMS, YARD LIGHTING, WIRING AND ANY OTHER FACILITIES THAT ARE UNDERGROUND IN THE VICINITY OF THE PROJECT. THE NOTICE SHALL BE REVIEWED AND APPROVED BY THE CITY OF WILLOUGHBY PRIOR TO BEING DISTRIBUTED. ALL COSTS ASSOCIATED WITH THE ABOVE SHALL BE INCLUDED IN THE LUMP SUM PRICE BID FOR ODOT ITEM 614, MAINTAINING TRAFFIC.

FAILURE TO COMPLY

FOR ANY FAILURE TO COMPLY WITH PROVISIONS FOR TRAFFIC CONTROL SET OUT IN THESE PLANS AND NOTES OR WITH THE PROVISIONS OF THE MANUAL, THE HIGHWAY IN THE VICINITY OF THE WORK AREA SHALL BE CONSIDERED IN A CONDITION UNACCEPTABLE FOR THE SAFETY AND CONVENIENT USE BY THE TRAVELING PUBLIC. ANY FAILURE TO KEEP THE HIGHWAY IN THE VICINITY OF THE WORKING AREA IN A CONDITION ACCEPTABLE FOR THE SAFE AND CONVENIENT USE BY THE TRAVELING PUBLIC SHALL BE CONSIDERED A BREACH OF THIS CONTRACT. WORK SHALL BE SUSPENDED UNTIL THE CONTRACTOR COMPLIES WITH THE PROVISIONS OF THE AFOREMENTIONED ITEMS.

MATERIALS FOR MAINTAINING TRAFFIC:

SIGNS

SIGN DIMENSION AND SPECIFICATIONS, INCLUDING LETTER SIZES, SHALL BE AS PROVIDED IN THE MANUAL OR SIGN DESIGN DRAWINGS PROVIDED IN THESE PLANS. THE SIGNS SHALL BE SUBJECT TO APPROVAL BY THE ENGINEER PRIOR TO THE START OF THE PROJECT. ALL COST FOR INSTALLING, MAINTAINING AND SUBSEQUENT REMOVAL OF SAID SIGNS SHALL BE INCLUDED IN THE LUMP SUM BID PRICE FOR ODOT ITEM 614 — MAINTAINING TRAFFIC.

NOTIFICATION

THE CITY OF WILLOUGHBY POLICE, FIRE, SERVICE DEPARTMENT, CITY ENGINEER AND THE WILLOUGHBY—EASTLAKE BOARD OF EDUCATION SHALL BE NOTIFIED AT LEAST ONE (1) WEEK PRIOR TO THE ACTUAL START OF CONSTRUCTION.

CITY OF WILLOUGHBY POLICE DEPARTMENT:

JAMES SHULTZ, CHIEF 440-953-4229

CITY OF WILLOUGHBY FIRE DEPARTMENT
TODD UNGER, CHIEF

440-953-4343

CITY OF WILLOUGHBY ENGINEER

TIM LANNON, P.E. 440-951-9000

CITY OF WILLOUGHBY SERVICE DEPARTMENT

440-953-4110

WILLOUGHBY-EASTLAKE BOARD OF EDUCATION

DIRECTOR OF TRANSPORTATION 440-946-5000

RICH PALMISANO, DIRECTOR

UNITED STATES POST OFFICE

440-951-0543

WASTE MANAGEMENT

440-286-7116

LAKETRAN

440-354-6100

SIGN SUPPORTS

SIGN SUPPORTS SHALL BE OF SUFFICIENT SIZES AND HEIGHT TO SUPPORT THE SIGNS AT THE HEIGHT INDICATED IN THE MANUAL. SUPPORTS SHALL ALSO BE ADEQUATE IN MASS AND STABILITY TO PREVENT SIGNS FROM BEING BLOWN OVER BY WIND OR VECULAR—GENERATED AIR TURBULENCE. ALL COSTS FOR INSTALLING, MAINTAINING AND SUBSEQUENT REMOVAL OF SAID SIGNS SHALL BE INCLUDED IN THE LUMP SUM BID PRICE FOR ITEM 614 — MAINTAINING TRAFFIC.

<u>DETOUR PLAN</u>

THE CONTRACTOR SHALL SUBMIT A PHASED CONSTRUCTION SCHEDULE AND PLANS FOR INTERSECTION CLOSURES, MAINTENANCE OF TRAFFIC PLAN AND TRAFFIC SIGNAL MODIFICATIONS REQUIRED FOR THEIR MEANS, METHODS AND CONSTRUCTION SEQUENCING.

IF THE CONTRACTOR PLANS TO CLOSE ANY INTERSECTION THE CONTRACTOR MUST PREPARE AND SUBMIT A DETOUR PLAN TO BE APPROVED BY THE ENGINEER BEFORE BEGINNING CONSTRUCTION.

PLAN SET MOT PLAN

THE MOT PLAN SUPPLIED IN THE PLAN SET FOR VINE STREET IS CONSIDERED TO BE THE MAXIMUM ALLOWABLE LANE CLOSURE FOR WORK IN THIS STRETCH OF VINE STREET. THE CONTRACTOR SHALL INVENTORY ALL EXITING MARKINGS AND SIGNS. CONFLICTING SIGNS AND MARKINGS SHALL BE REMOVED OR BAGGED. SIGNS REQUIRED TO SUPPLEMENT THIS LAYOUT SHALL BE PROVIDED IN A PLAN SUBMITTED BY THE CONTRACTOR AND IN ACCORDANCE WITH WORK ZONE SAFETY REQUIREMENTS.

EB ON RAMP MAINTENANCE OF TRAFFIC SHALL BE CONTROLLED BY RESTRICTING ON RAMP LANE WIDTH TO 10 FT MINIMUM WITH A 2 FT SHOULDER WIDTH FOR DURATION OF WORK REQUIRED TO PERFORM TUNNELING AND PIPE INSTALLATION.

ODOT PERMIT AND LAKE COUNTY ENGINEER'S APPROVAL

LAKE COUNTY

THE MOT PLAN FOR WORKING IN THE LIMITED ACCESS AREA OF LAK-2 SHALL BE DEVELOPED BY THE CONTRACTOR AND SUBMITTED TO ODOT FOR APPROVAL OF A RIGHT-OF-WAY AND UTILITIES PERMIT. THE APPLICATION SHALL BE MADE BY THE CONTRACTOR.

LENE C. HILL WE-66017 O/STERRO O/STERRO O/ONAL

CITY OF WILLOUGHBY

NASON BASIN TO GROVE AVENUE STORM SEWER IMPROVEMENTS PHASE 1

WILLOUGHBY, OHIO CHECKED B

	ISSUED FOR:	ВП
	ISSUE DATE:	02/07/25
	SCALE:	AS SHOWN
	DESIGNED BY:	MPC
	DRAWN BY:	TJM
)	CHECKED BY:	LCH

MAINTENANCE OF TRAFFIC 1

PROJECT NO.

150772

DISCIPLINE

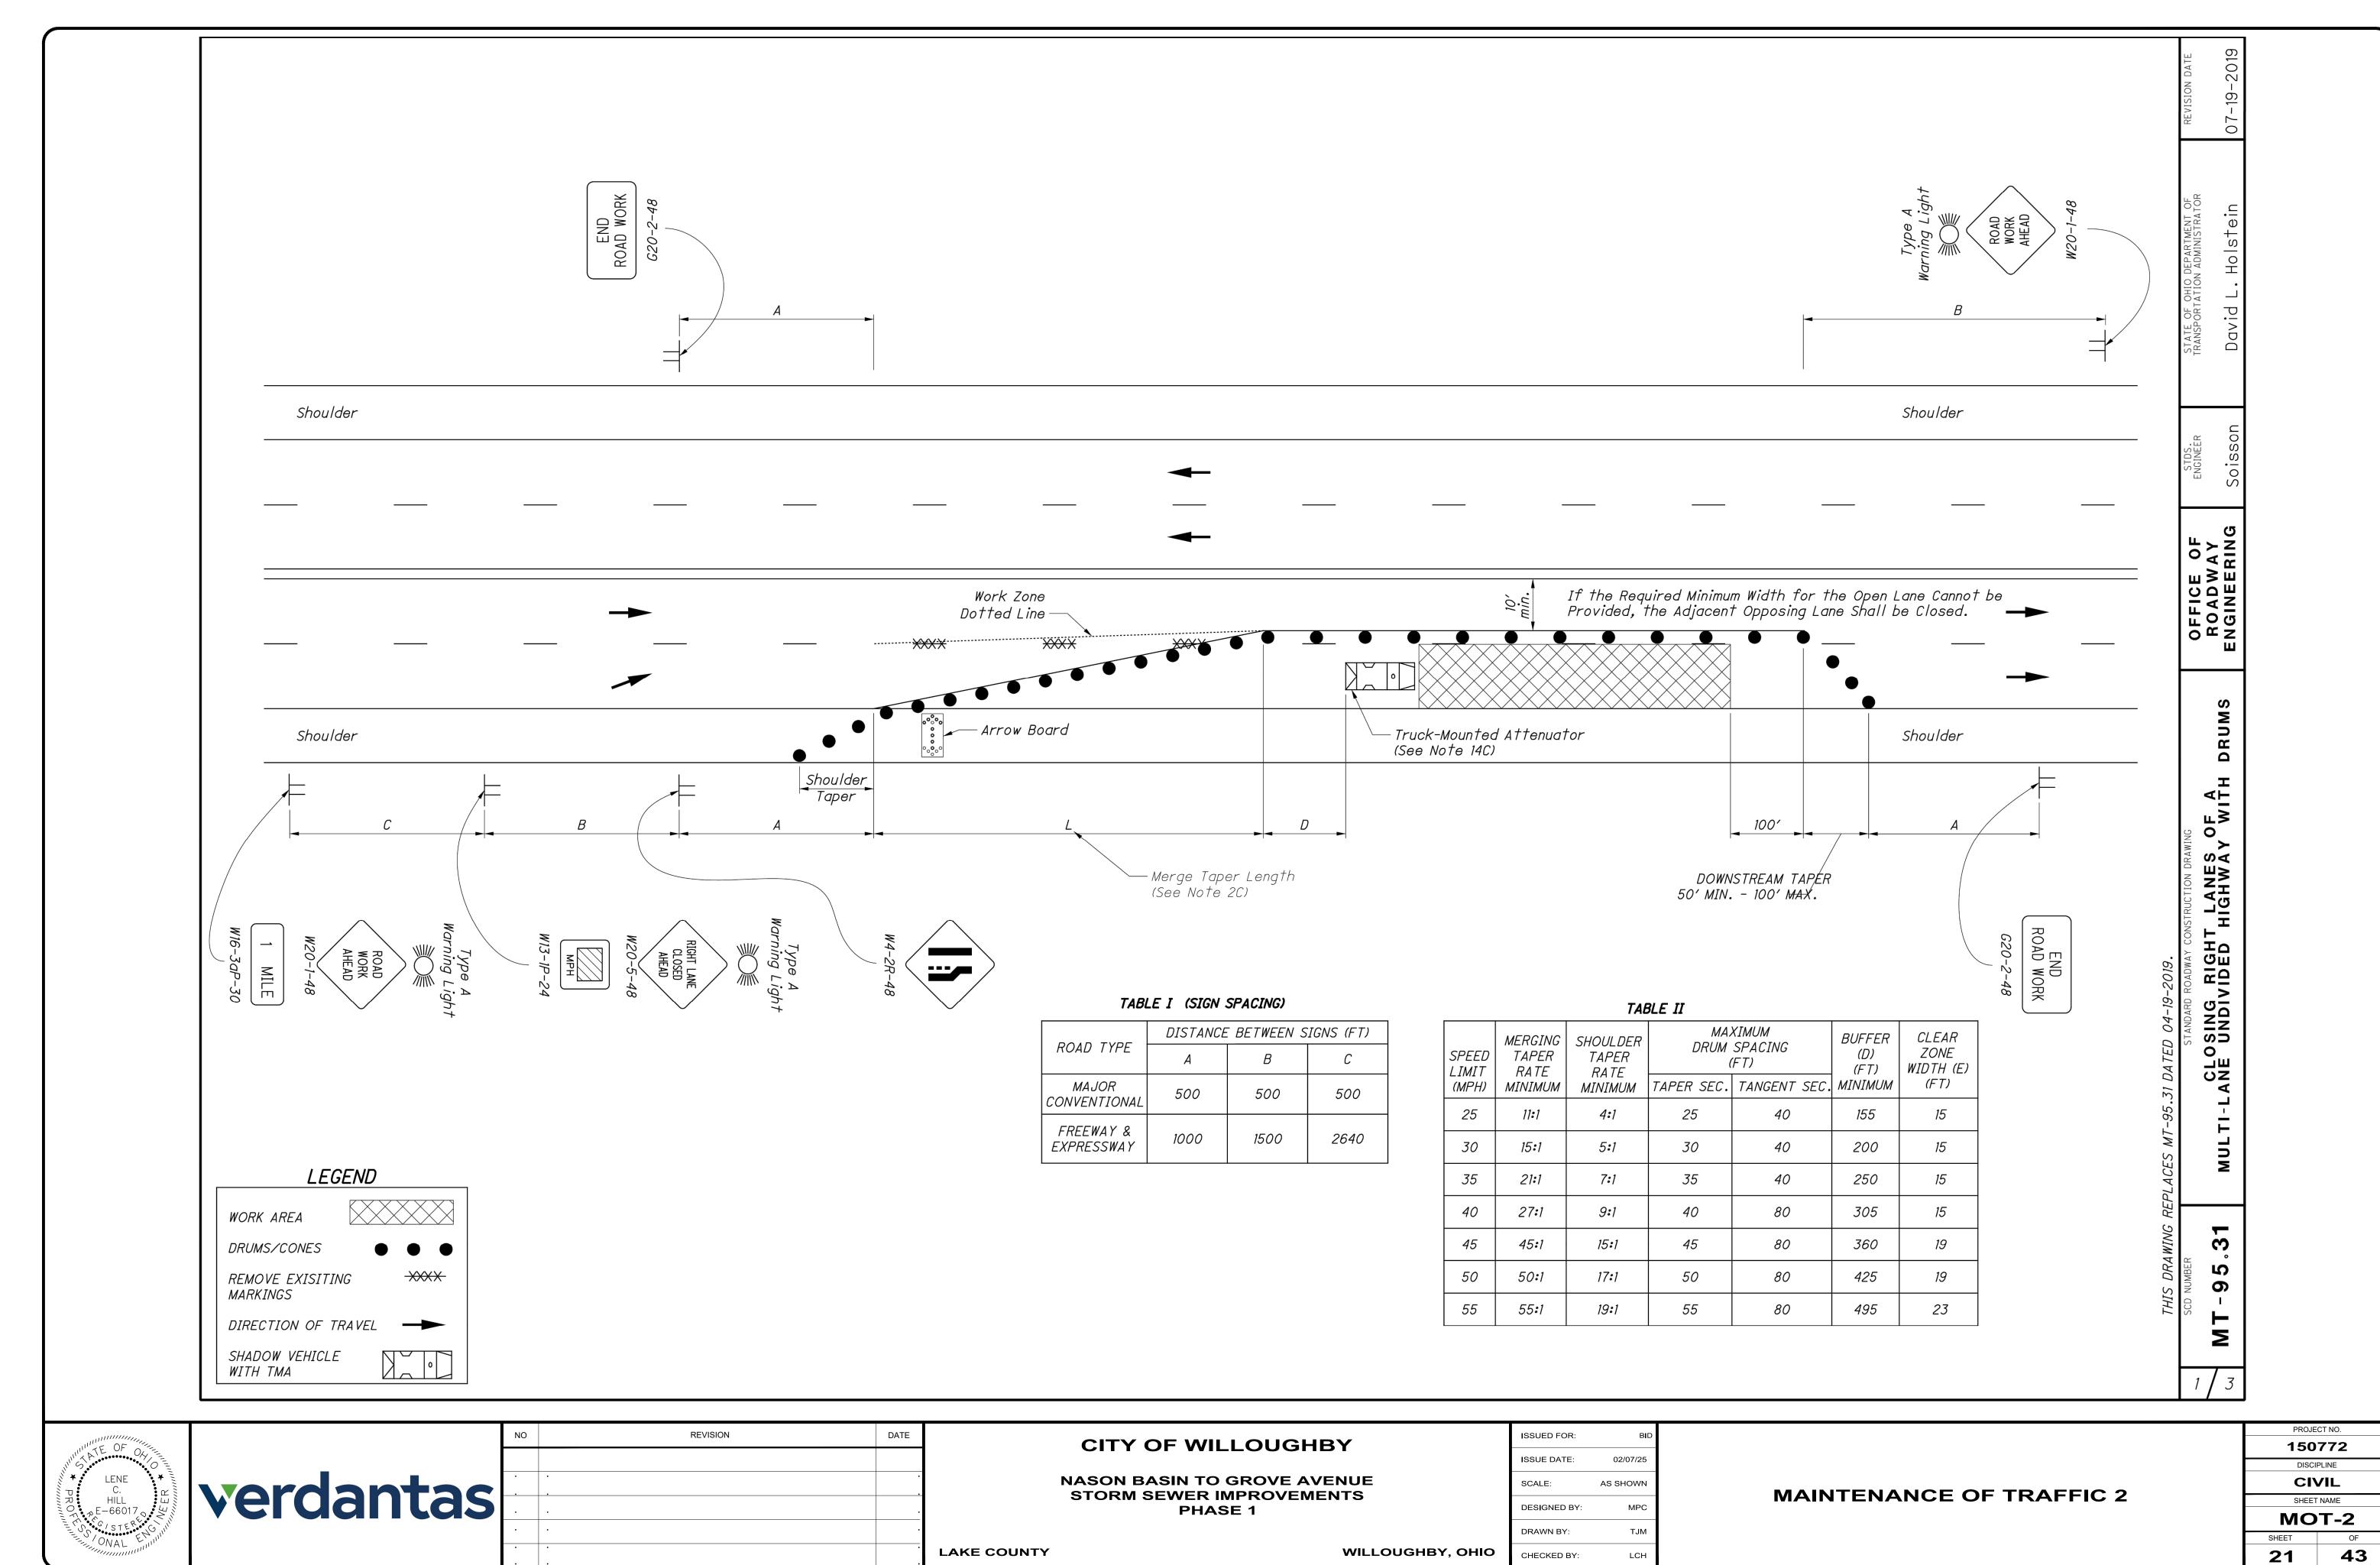
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SHEET NAME

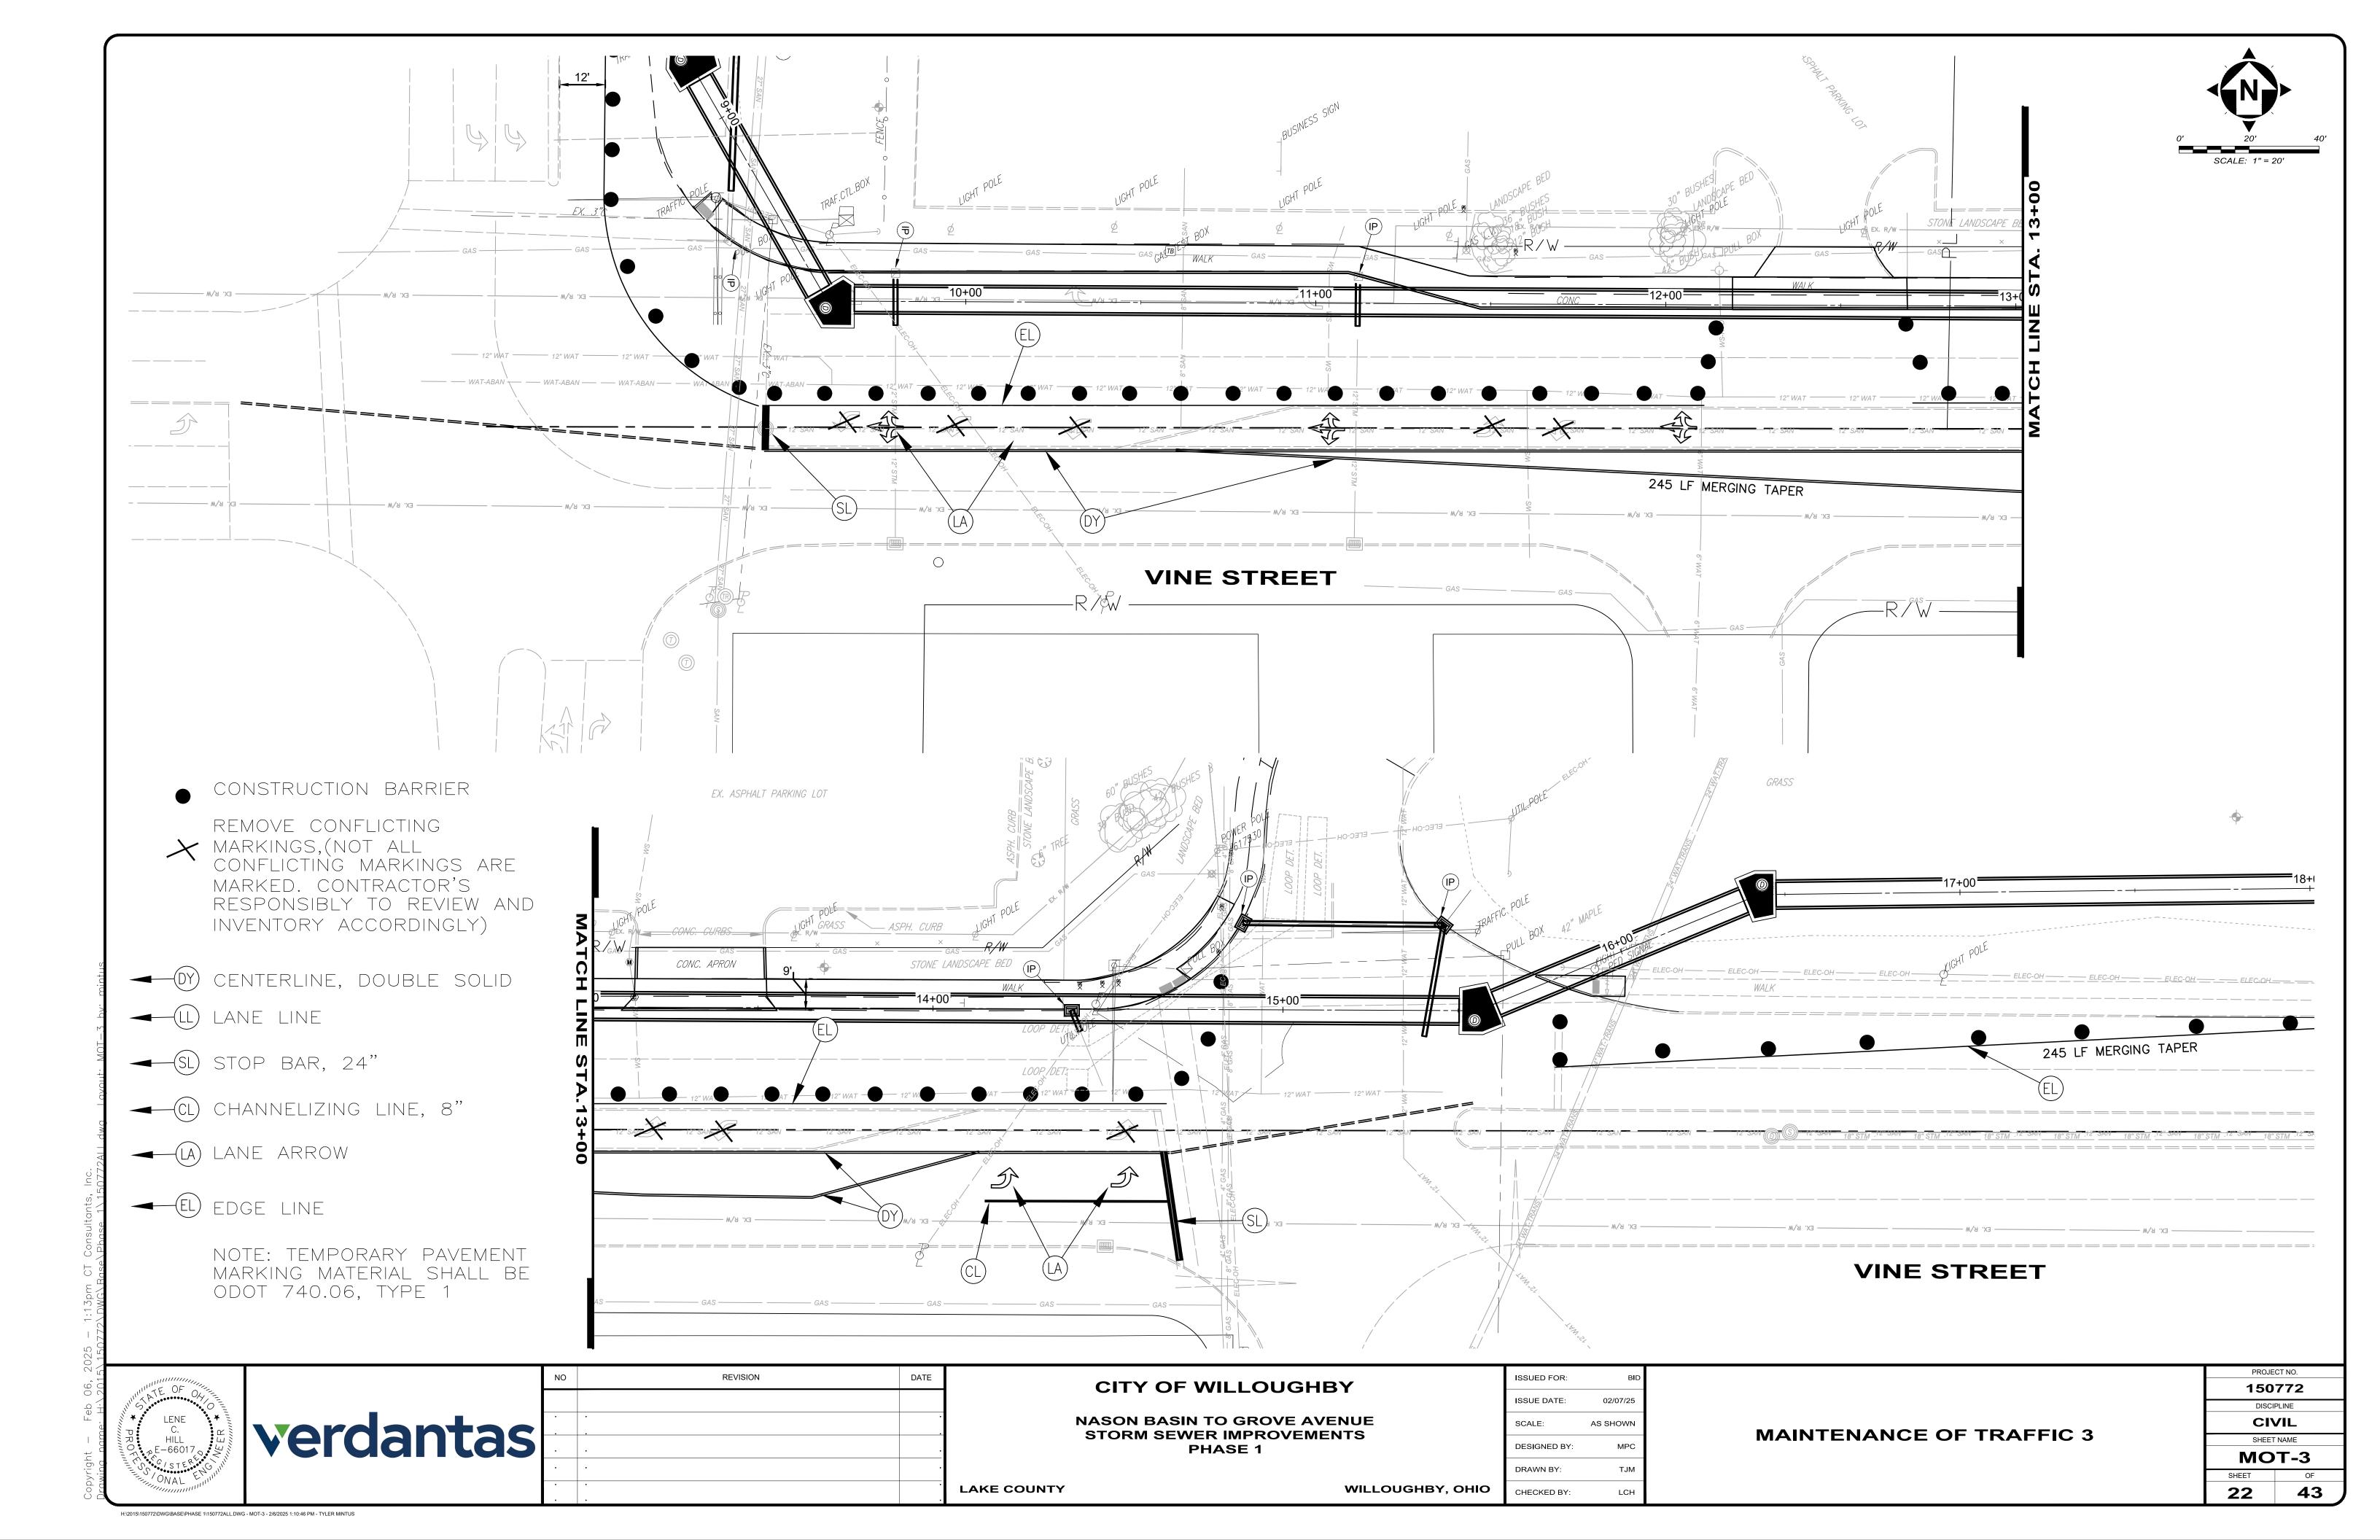
MOT-1

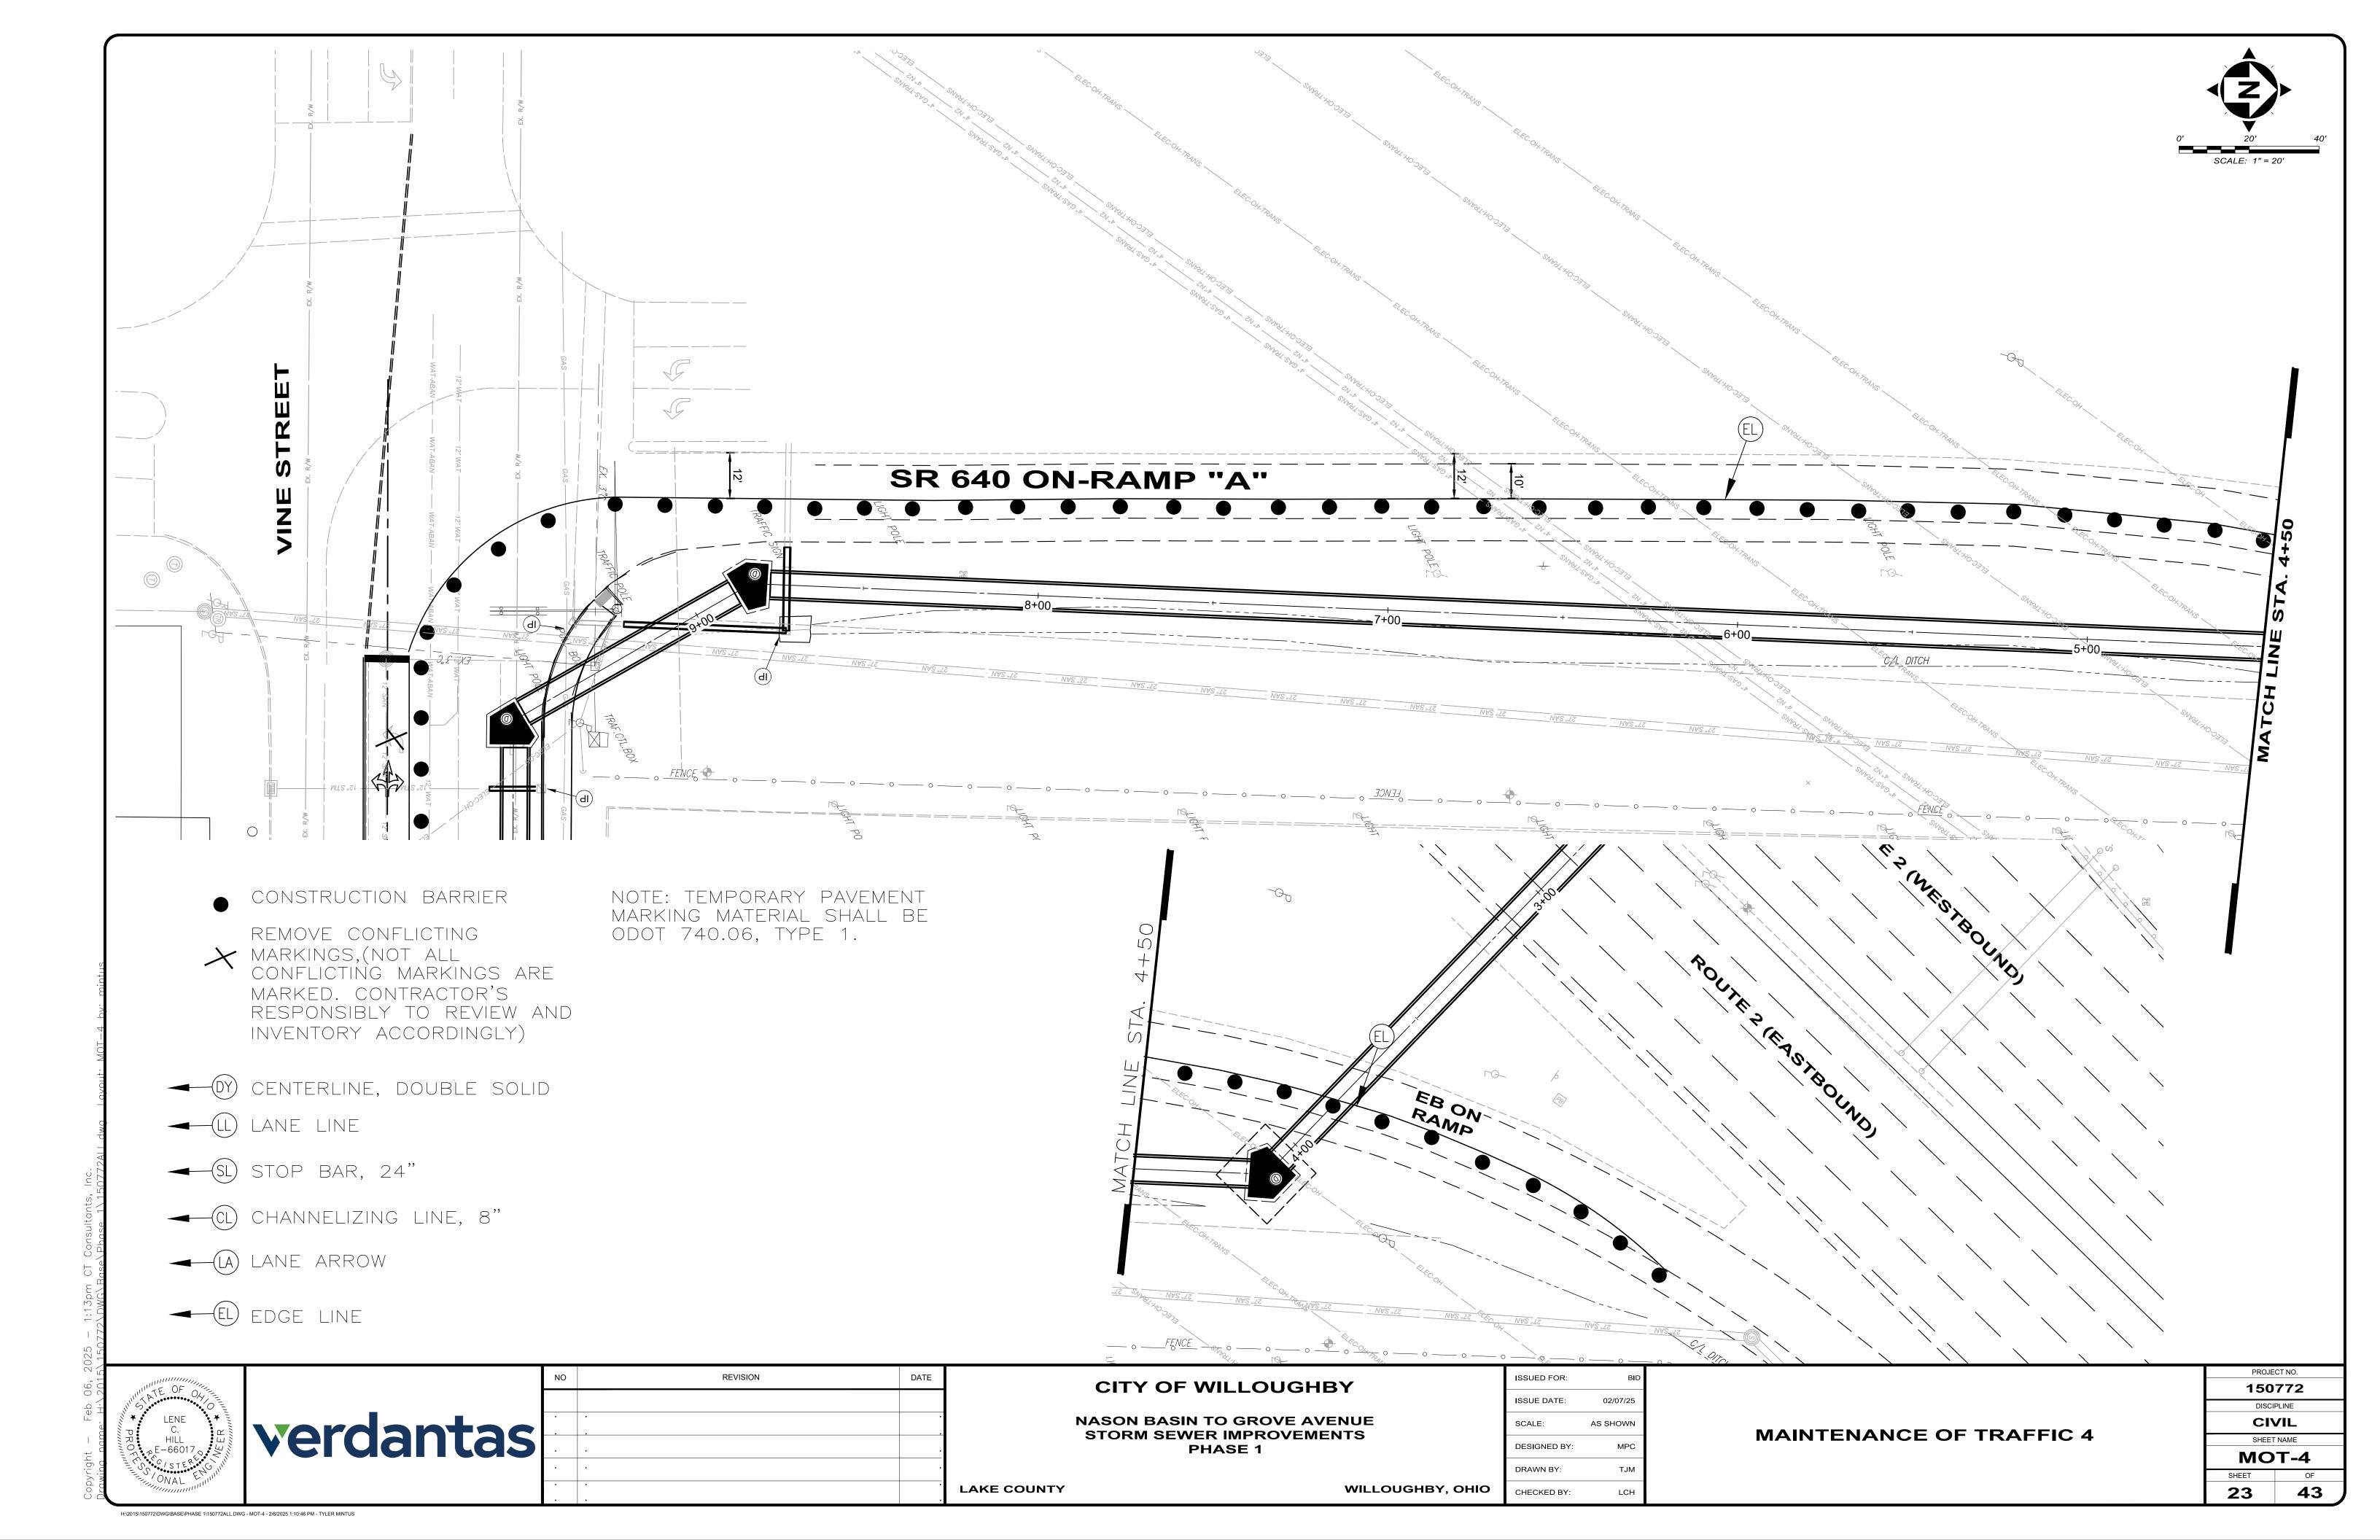
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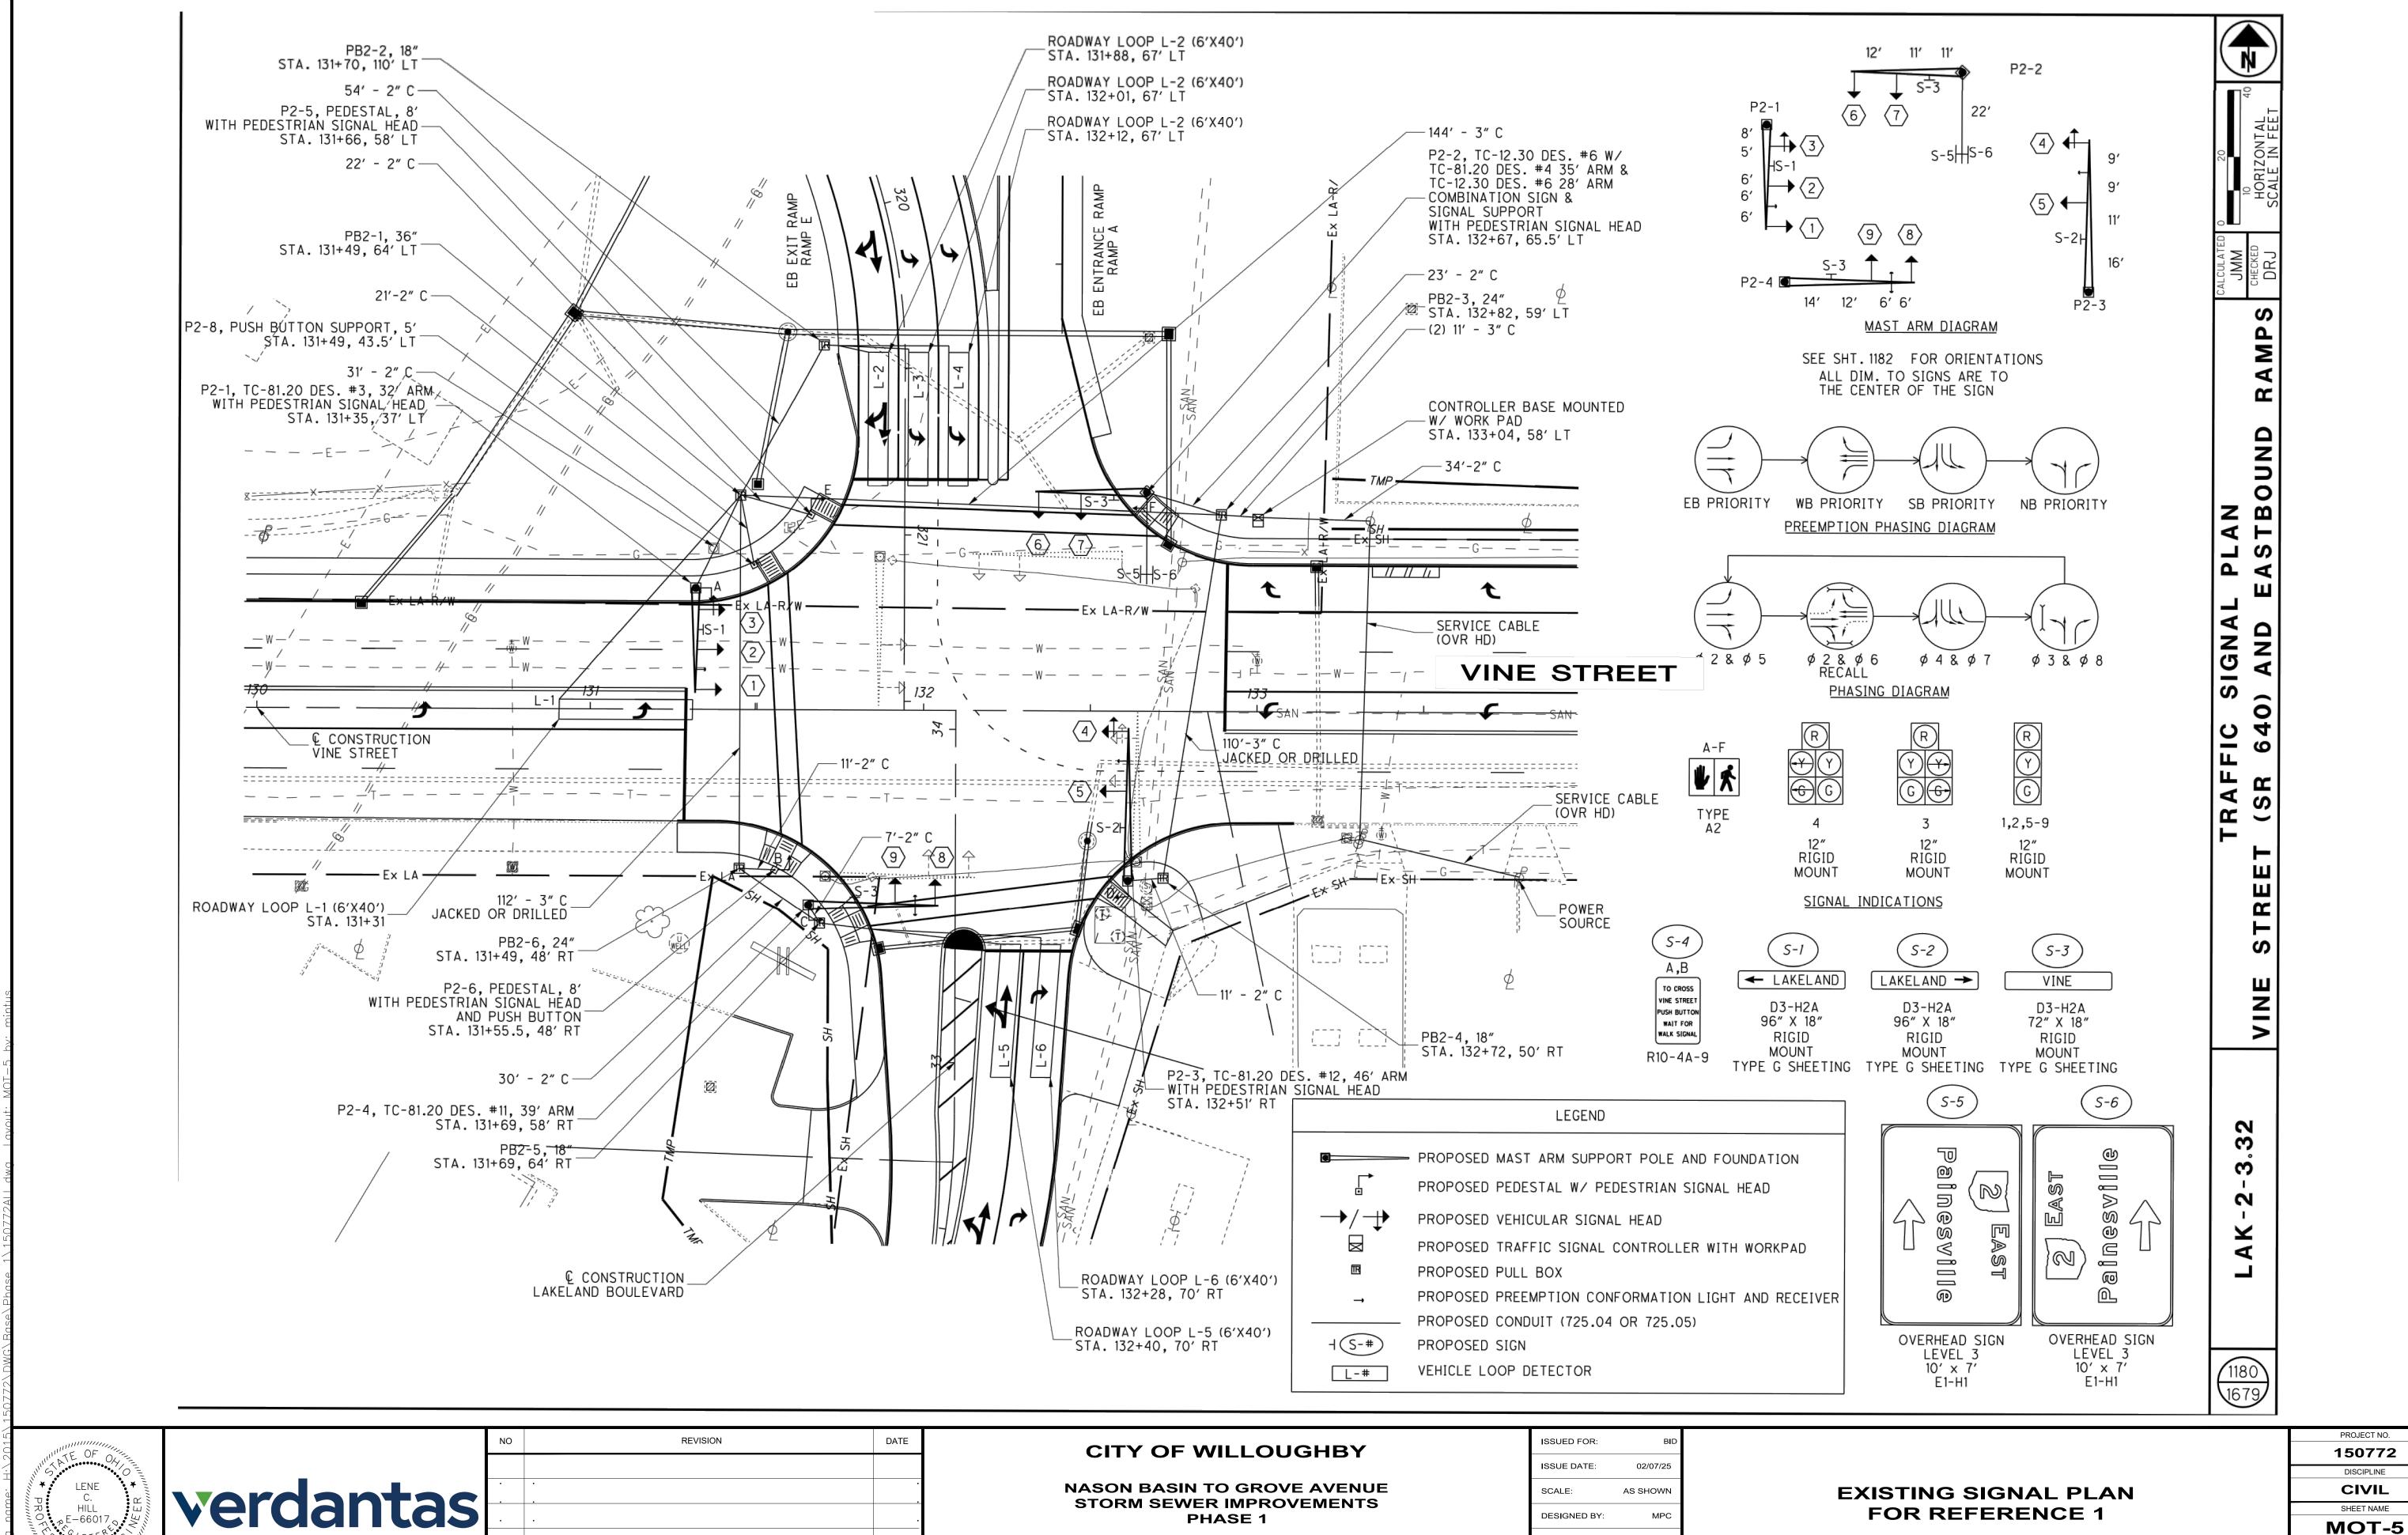
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LAKE COUNTY

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CHECKED BY:

WILLOUGHBY, OHIO

PROJECT NO.

DISCIPLINE

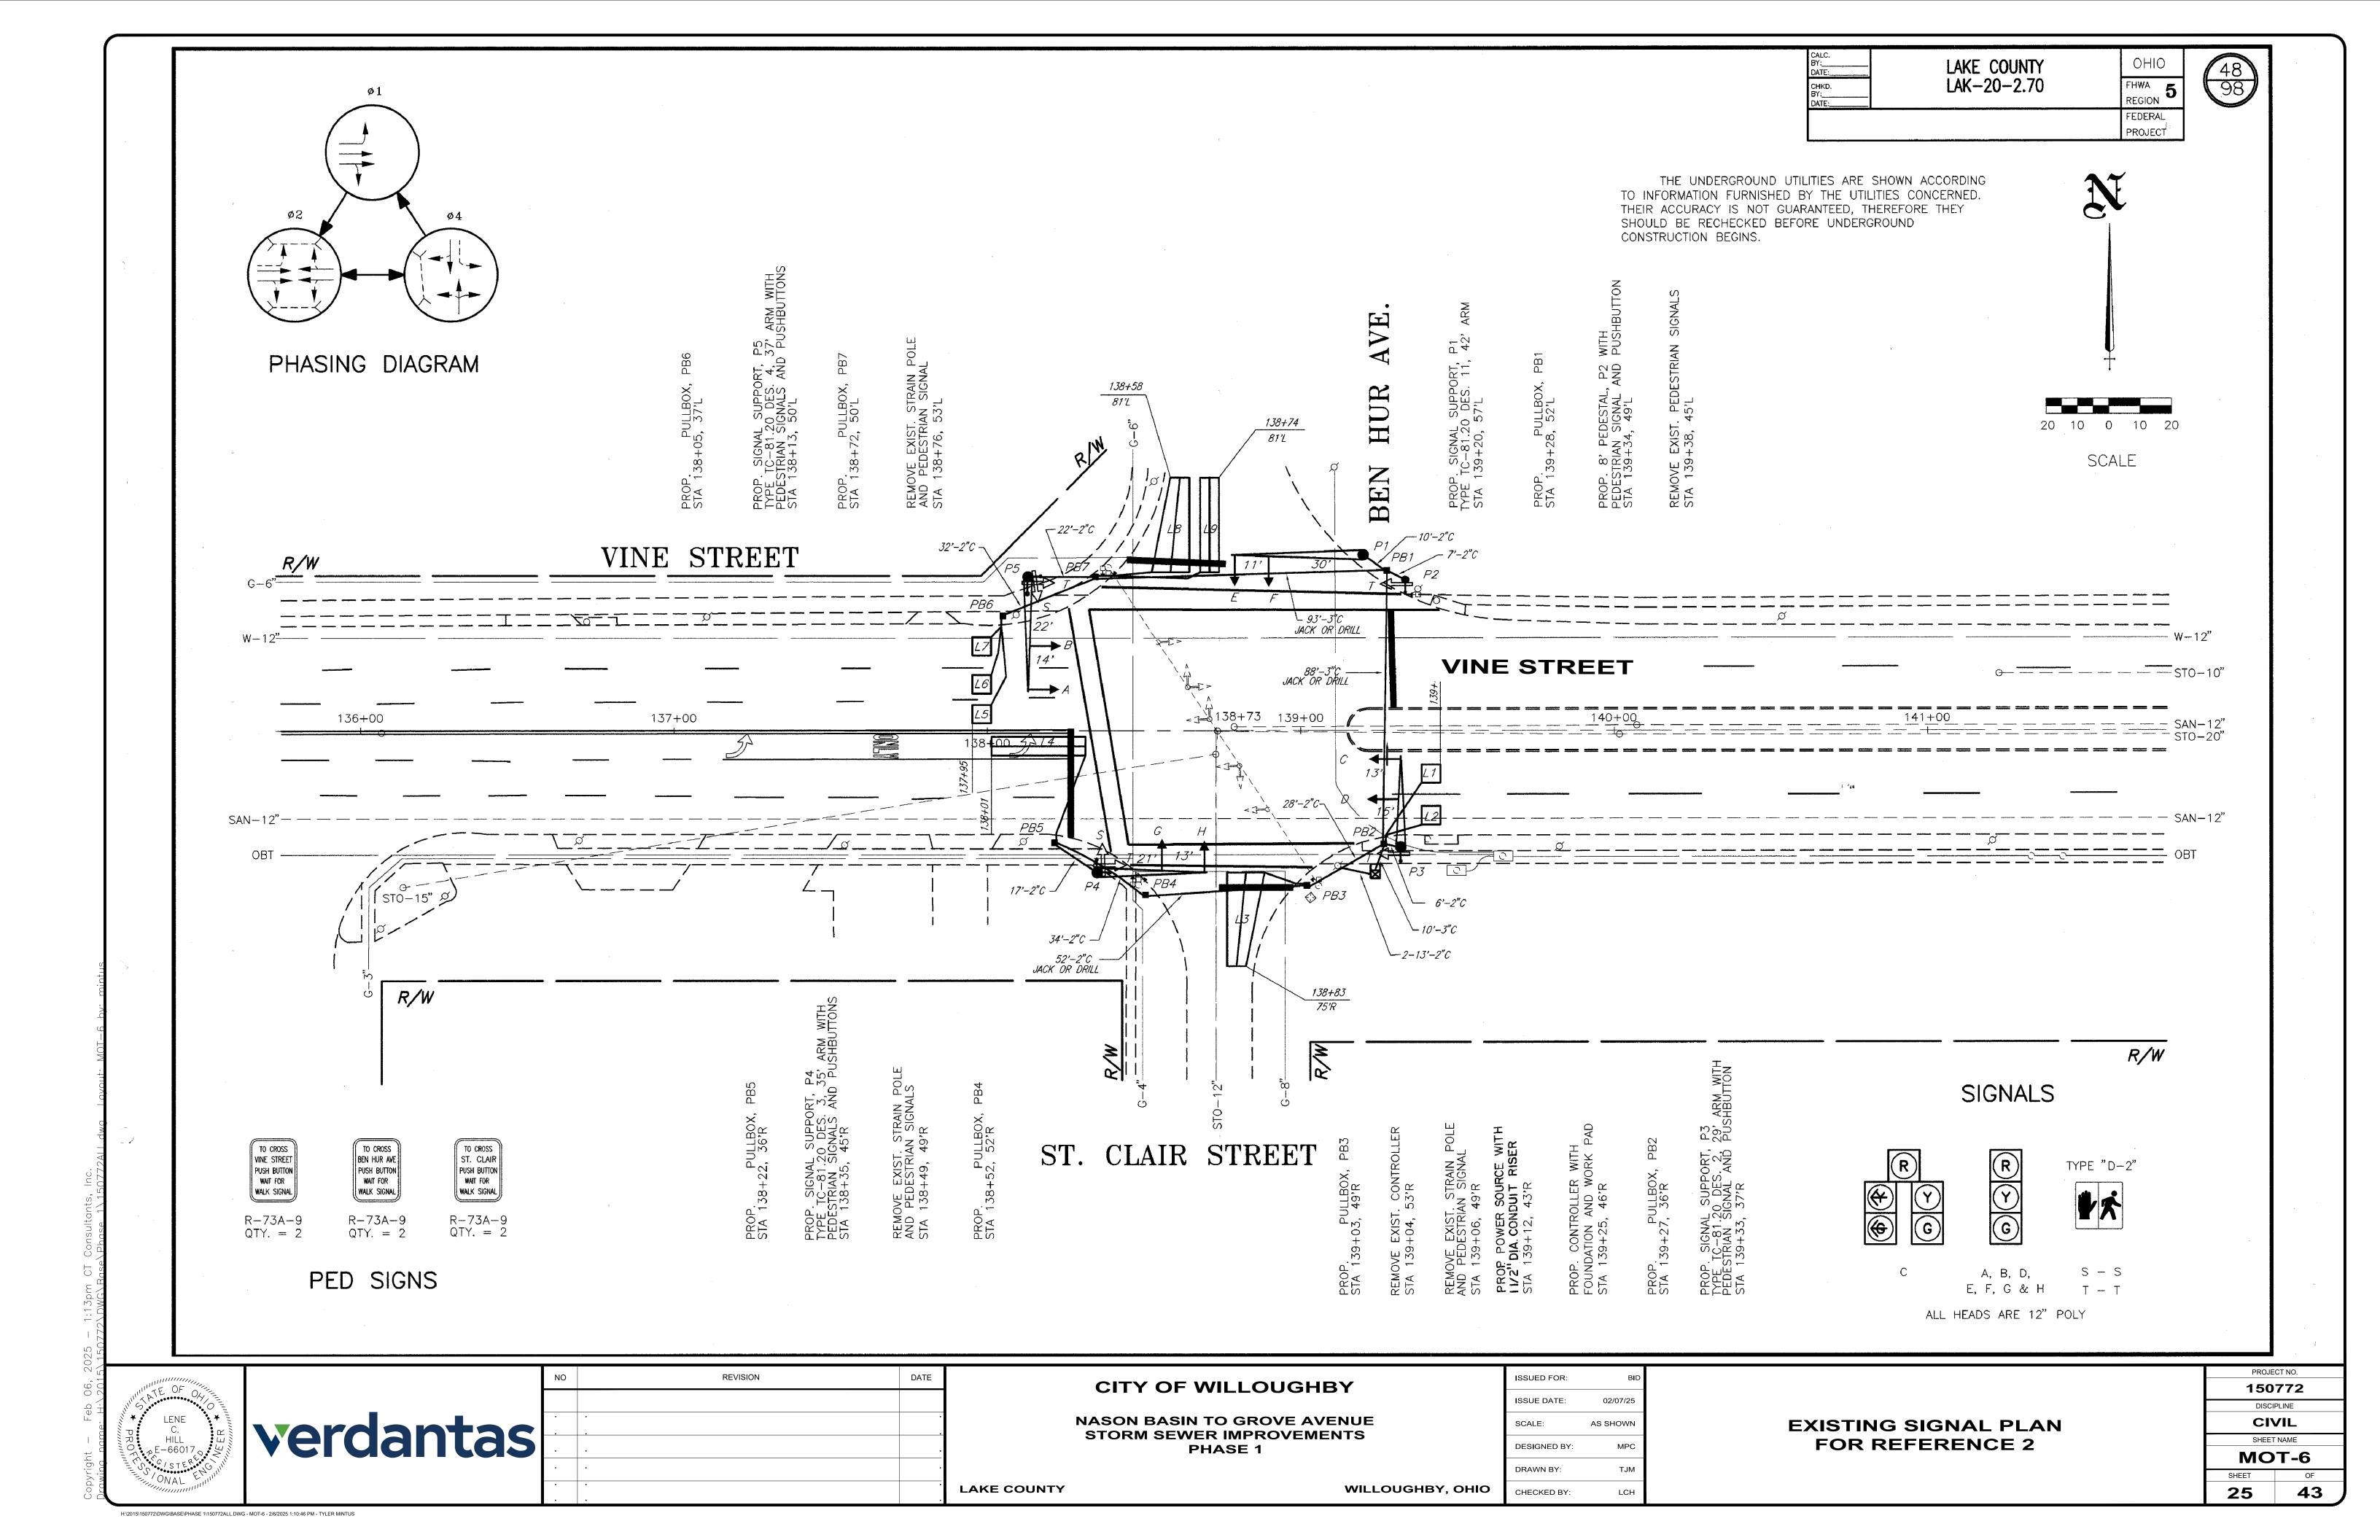
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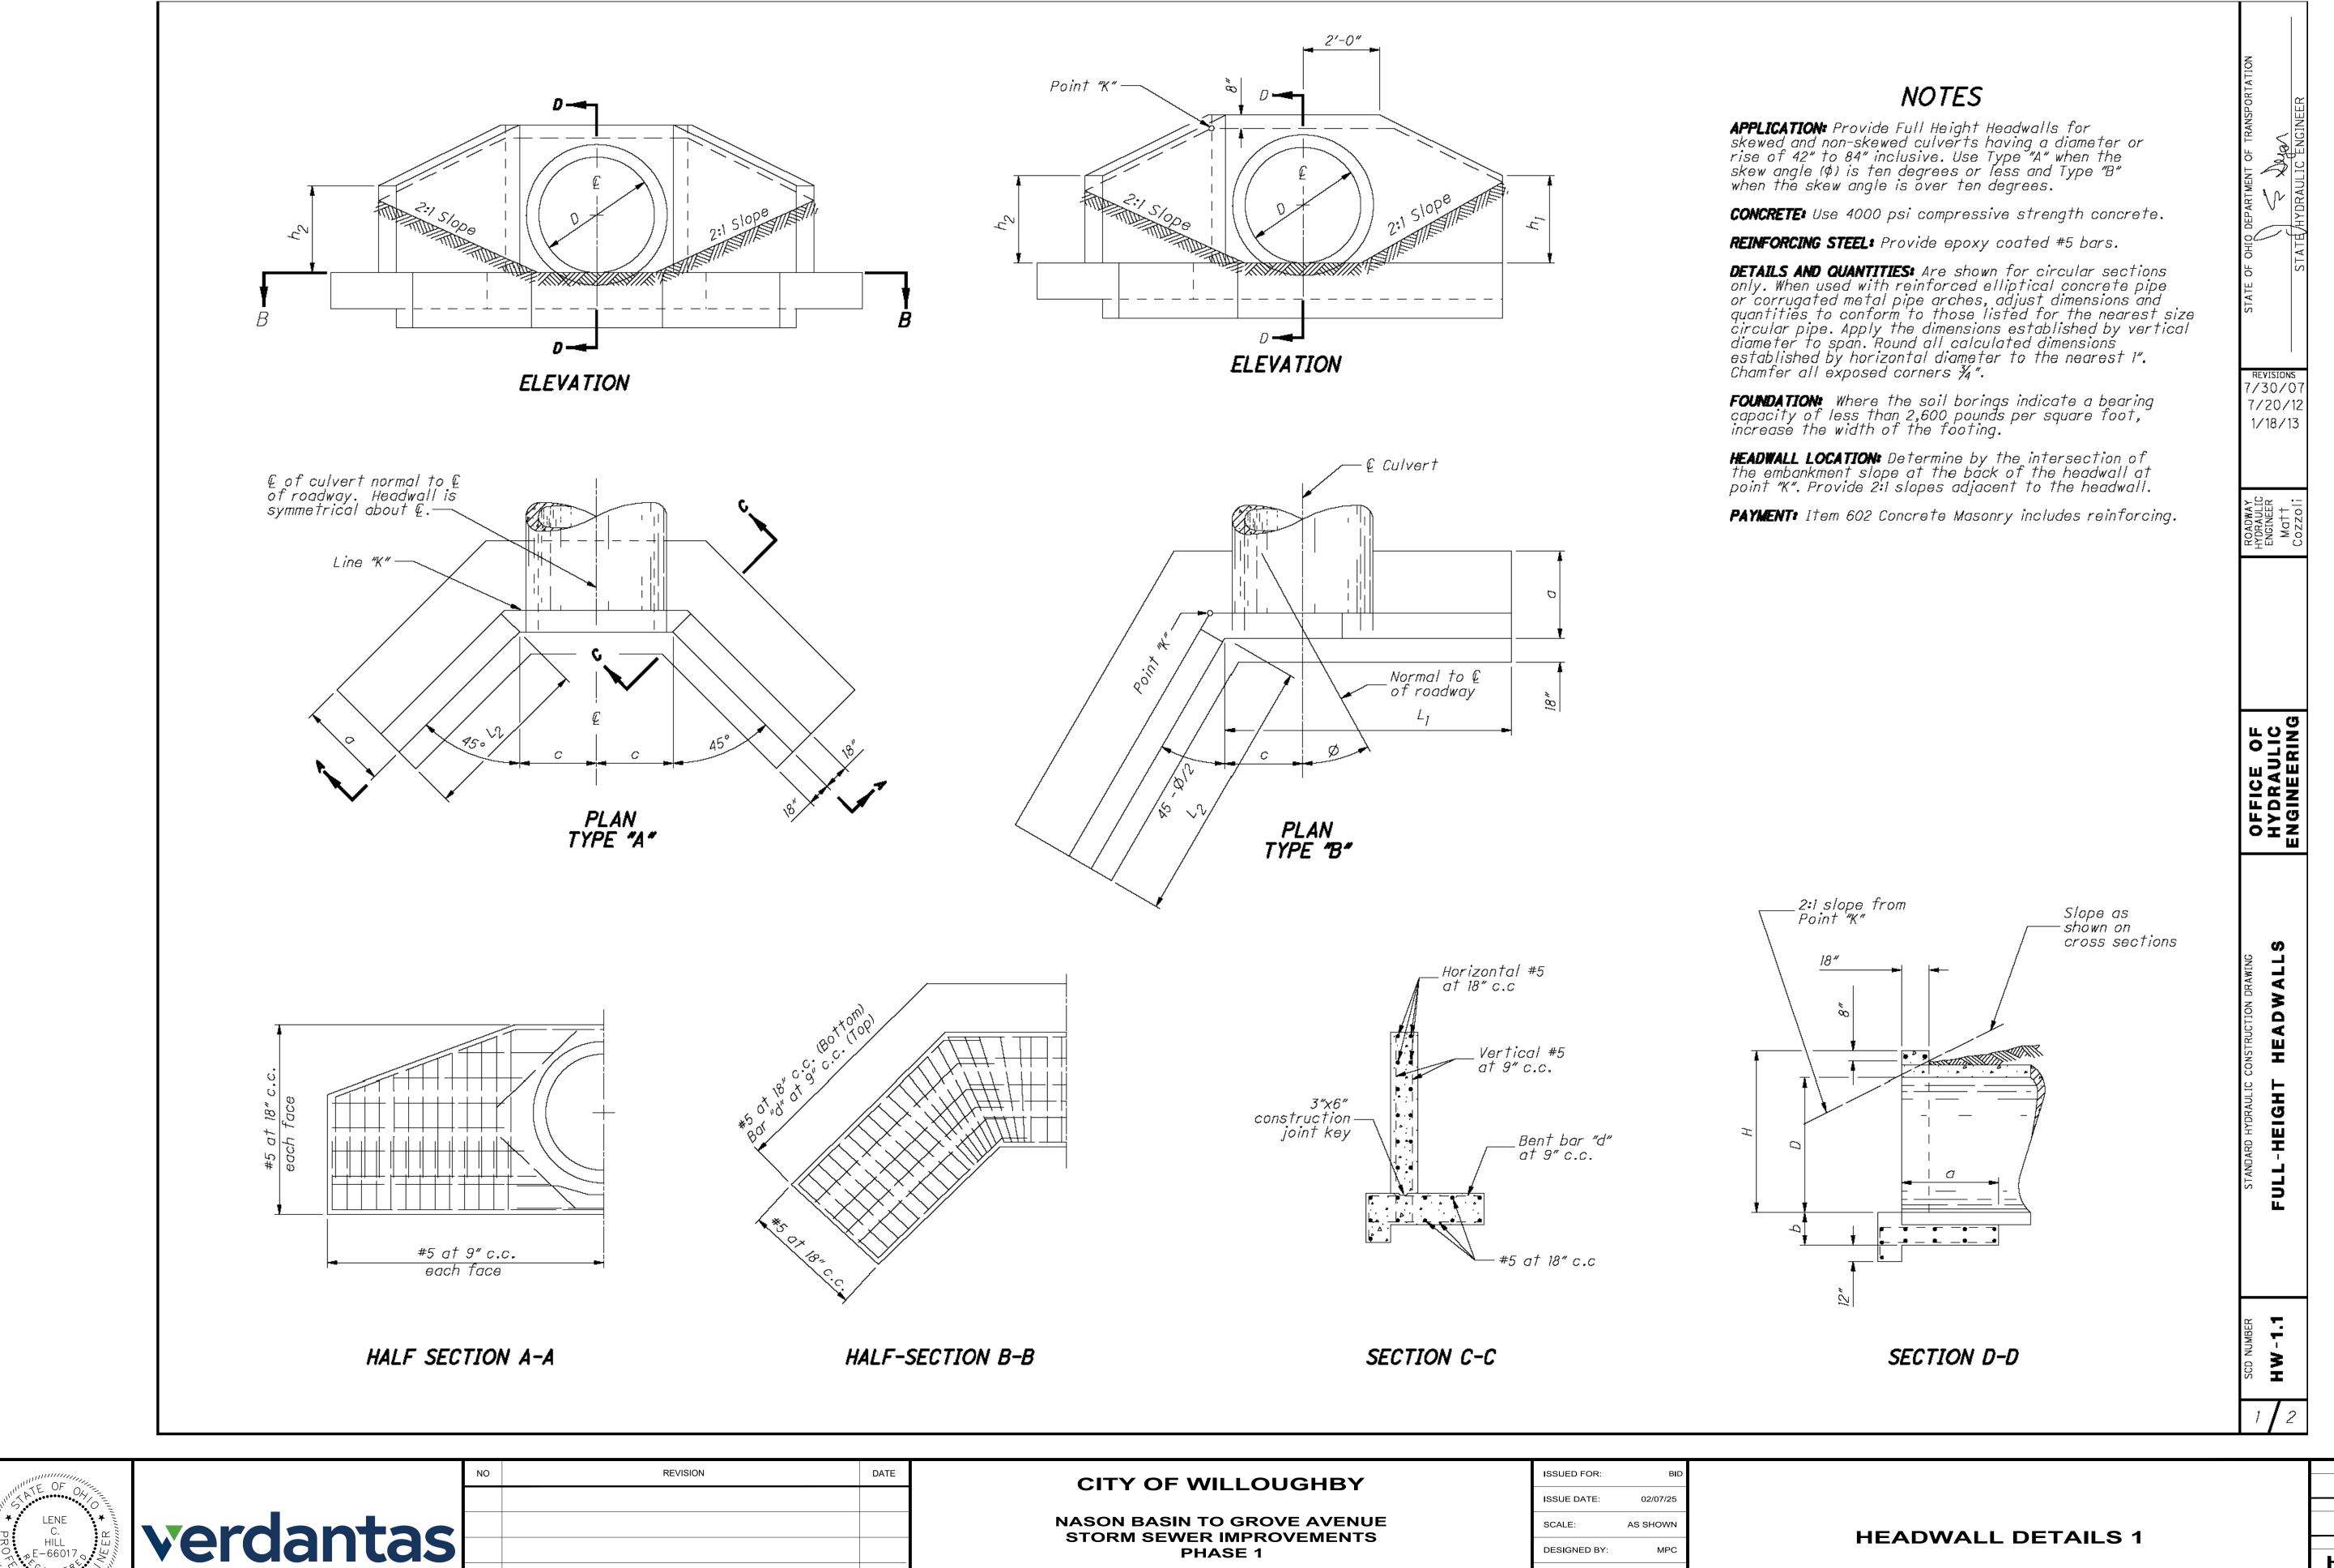
SHEET NAME

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DISCIPLINE CIVIL SHEET NAME **HW DET-1** 43 **26**

PROJECT NO.

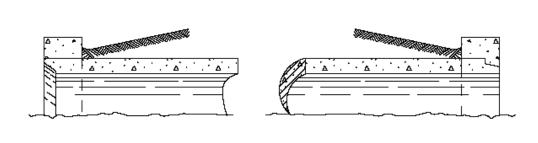
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LAKE COUNTY

WILLOUGHBY, OHIO CHECKED BY:

DRAWN BY:



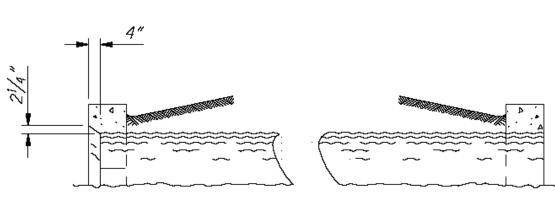
INLET END GROOVE OR BELL UPSTREAM OUTLET END

RIGID PIPE

4'-6"

10'-0"

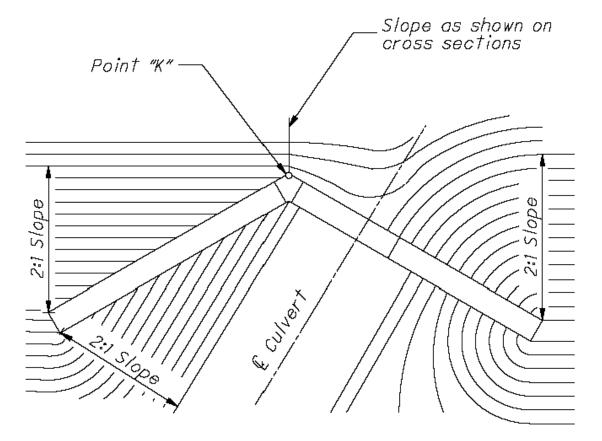
6'-2"



INLET END

OUTLET END

CORRUGATED PIPE END TREATMENT OF HEADWALL



LOCATION AND GRADING PLAN FOR SKEWED PIPE CULVERT - TYPE B

	FULL-HEIGHT HEADWALLS (English)																																						
							Ø ≈ 0°			Ø ~				Ø ≈ 15°			≈ <i>1</i> 5°		Ø ≈ 5°			Ø ~ 15 °					Ø		Ø ≈ 30°					Ø ≈ 45°					
PIPE DIA. D	н	а	Ь	c	Bar# d	L ₂	h ₂	Conc.	Conc. RCP	Steel	L,	L2	h,	h ₂	Conc.	Cone. ACP	Steel	L 1	LZ	, h ₁	h ₂	Conc.	Conc. MCP	Steel	۲,	12	hı	h ₂	Conc.	Cope. ACP	Steel	PIPE DIA. D							
42"	4'-11"	3'-3"	1′-6″	2'-6"	#5	3'-7"	3'-1"	7.	6.7	598	8'-9"	4'-6"	3'-8"	3'-2"	7.3	7.1	619	7′-10″	5'-9"	3'-2"	3'-3"	7.5	7.3	633	7′-10″	7′-9″	3'-2"	3'-3"	8.7	8.5	718	42"							
48"	5′-5″	3'-6"	1′-6″	2'-9"	#5	4'-4"	3'-4"	85	8.2	793	10'-0"	5'-4"	4'-1"	7-5	9.0	8.7	776	8'-9"	6'-10"	3′-5″	3'-6	9.1	8.8	801	8'-9"	9'-2"	3'-5"	8-7	10.6	10.3	925	48*							
54"	5′-11″	3'-9"	1′-6″	3'-0"	#5	5′-2″	3'-8"	1/2/3	10.0	1,069	11'-4"	6'-3"	4'-6"	3'-8"	10 9	10.5	1,026	9'-8"	7′-11″	31-8"	3'-9"	10.8	10.5	1,024	9'-8"	10'-7"	3'-8"	3'-10"	12.6	12.2	1,188	54"							
60"	6′-6″	4'-0"	1′-6″	3′-3″	#5	5′-11″	3'-11"	12.3	11.8	1,149	12'-7"	7'-2"	4'-10"	4'-0"	12.9	12.4	1,174	10'-7"	9'-0"	3'-10"	4'-1"	12.7	12.3	1,157	10'-7"	12'-0"	3'-10"	4'-1"	14.8	14.3	1,354	60"							
72"	7′-7″	4'-6"	1'-7"	3′-9″	#7	7′-5″	4'-5"	17.0	16.2	1,783	15′-1″	8'-11"	5′-7″	4'-6"	17.8	17.1	1,811	12'-5"	11'-2"	4'-3"	4'-7"	17.3	16.6	1,788	12'-5"	14'-10"	4'-3"	4'-8"	20.2	19.6	2,076	72"							
84"	8	5'-0"	1′-10″	4	#8	9'-0"	5			2545	171-7"	10'-9"	6'-4"	5'-1"	24.8	23.9	2,586	141-7"	13'-4"	4'-10"	5′-2″	24.1	23.3	2,511	141-3"	17′-8″	4'-8"	5′-2″	27.9	27.0	2,980	84*							

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	NO	REVISION	DATE	
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				LAKE COUNTY

CITY OF WILLOUGHBY

NASON BASIN TO GROVE AVENUE STORM SEWER IMPROVEMENTS PHASE 1

	DR
WILLOUGHBY, OHIO	СН

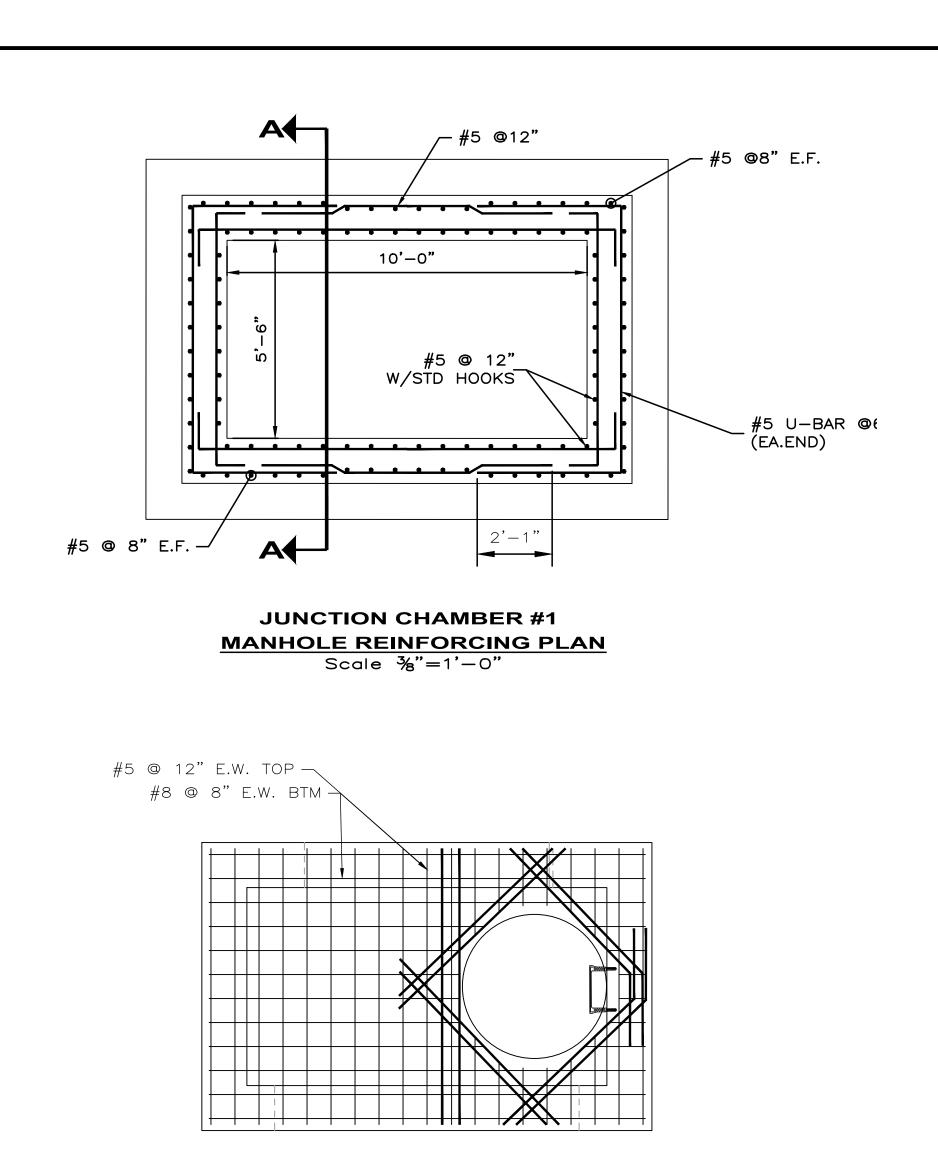
ISSUED FOR:	BID
ISSUE DATE:	02/07/25
SCALE:	AS SHOWN
DESIGNED BY:	MPC
DRAWN BY:	ТЈМ
CHECKED BY:	LCH

HEADWALL DETAILS 2

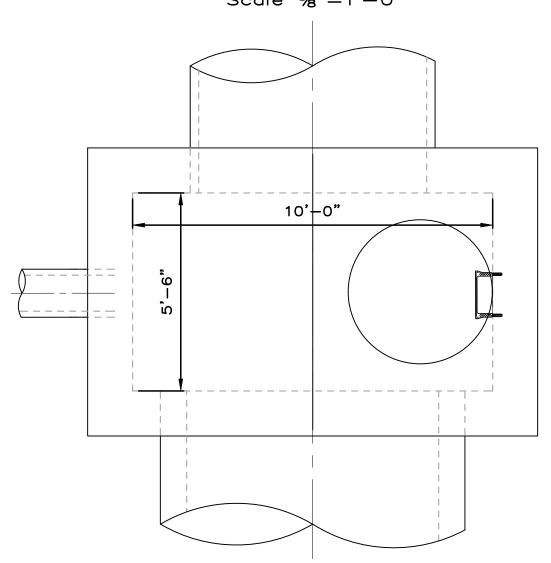
PROJECT NO.		
150772		
DISCIPLINE		
CIVIL		
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HW DET-2		
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REVISIONS 7/30/07 7/20/12 1/18/13

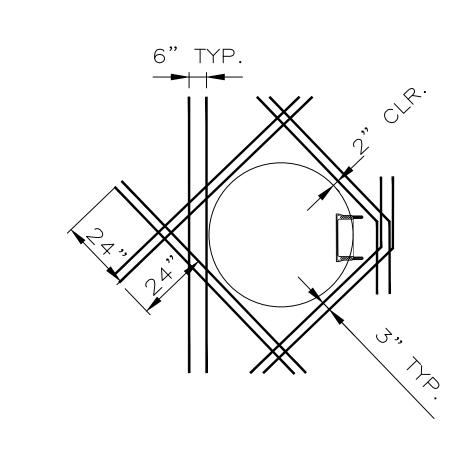
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JUNCTION CHAMBER #1 MANHOLE CLEARANCE DETAILS

Scale %"=1'-0"

LAKE COUNTY

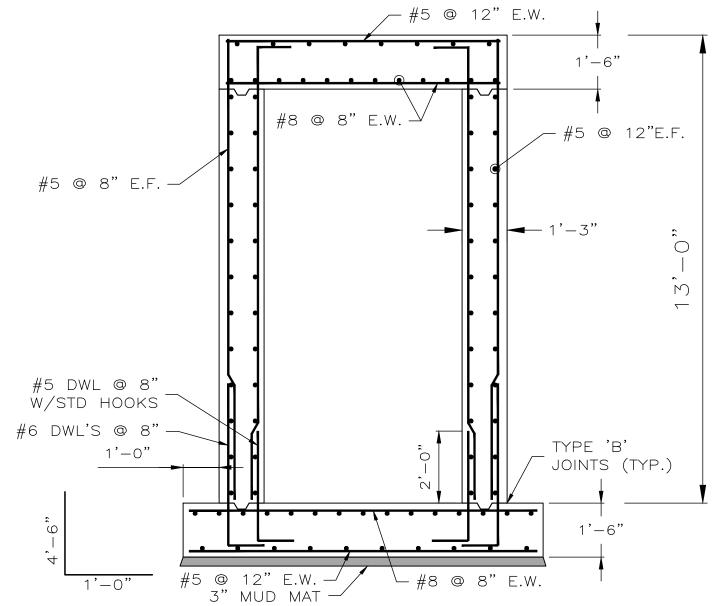
1. SEE STANDARD DETAILS FOR REINFORCING AROUND OPENINGS

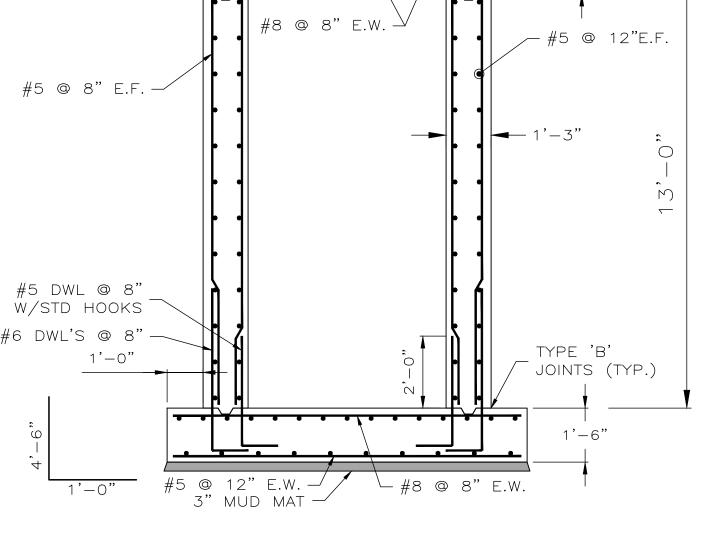
- 2. CONCRETE CLASS QC1 COMPRESSIVE STRENGTH = 4000 PSI

3. REINFORCING STEEL - GRADE 60 MINIMUM YIELD STRENGTH 60,000 PSI EPOXY COATED

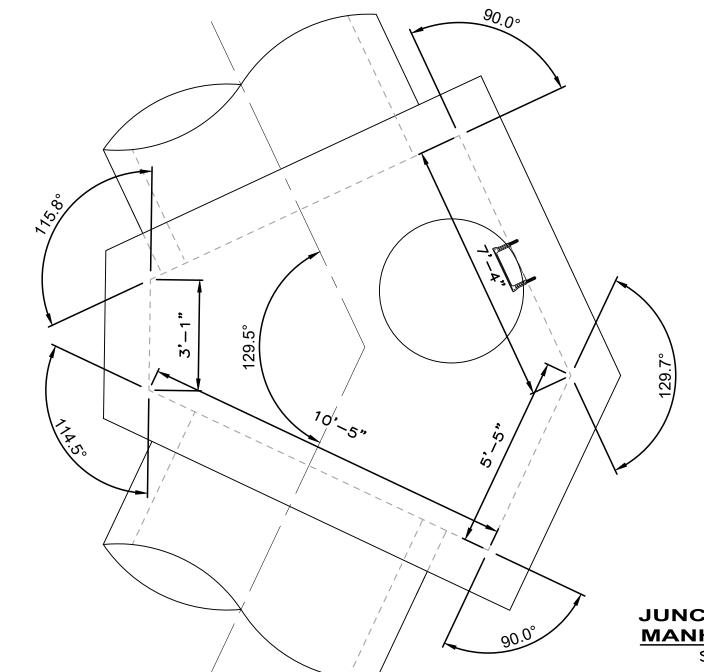
- 4. CONTRACTOR HAS OPTION TO UTILIZE PRECAST CONCRETE MANHOLE STRUCTURES. THE STRUCTURE. NO ADDITIONAL PAYMENT TO CONTRACTOR SHALL BE MADE FOR PRECAST STRUCTURES.
- 5. PRECAST MANHOLE STRICTURES SHALL UTILIZE WATERPROOFING MEMBRANE AROUND FABRICATED STRUCTURE JOINTS.
- 6. PIPE TO MANHOLE CONNECTORS A-LOK OR APPROVED EQUIVALENT SHALL BE UTILIZED IN PRECAST SECTIONS.
- 7. PROVIDE MANHOLE STEPS 16" O/C.

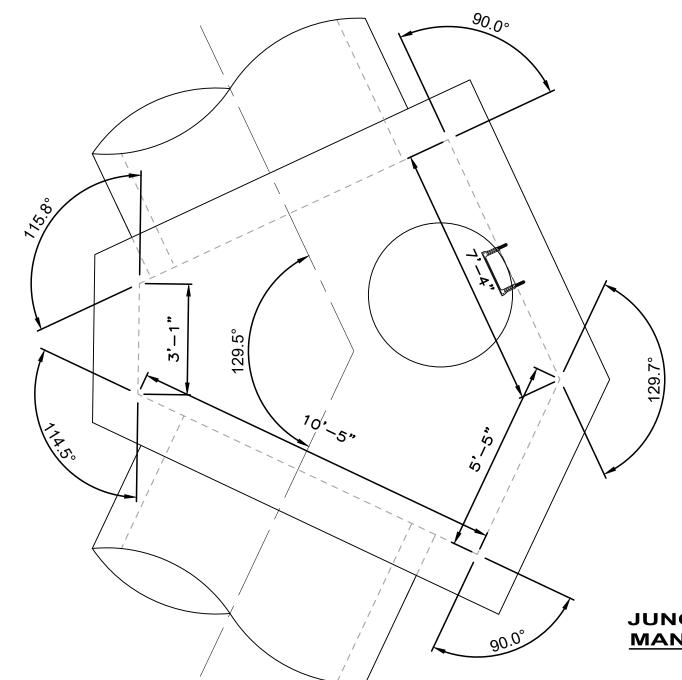
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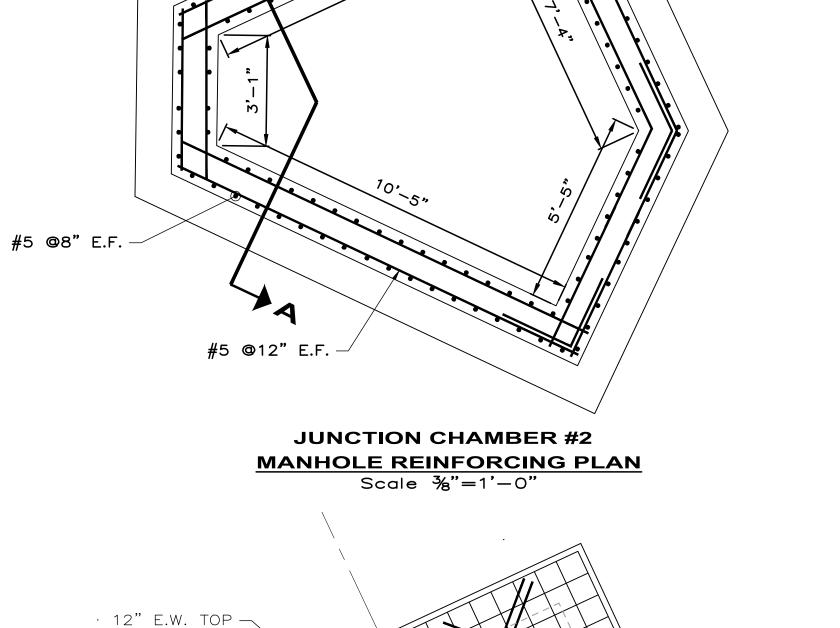




<u>SECTION A-A</u> Scale %"=1'-0"







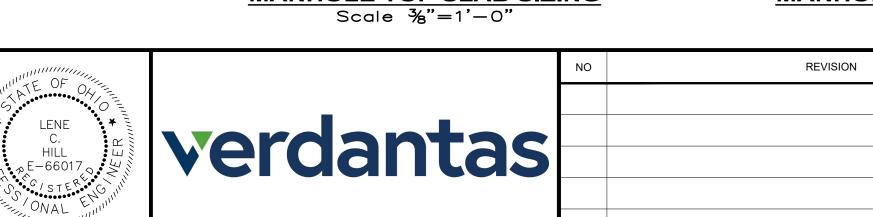
#5 CORNER BARS © 12" O.F. (TYP.)

#5 @ 8" E.F. —

JUNCTION CHAMBER #2 MANHOLE TOP SLAB PLAN
Scale %"=1'-0"

JUNCTION CHAMBER #2
MANHOLE DIMENSIONS
Scale %"=1'-0"

8 @ 8" E.W. BTM -



CITY OF WILLOUGHBY

NASON BASIN TO GROVE AVENUE STORM SEWER IMPROVEMENTS PHASE 1

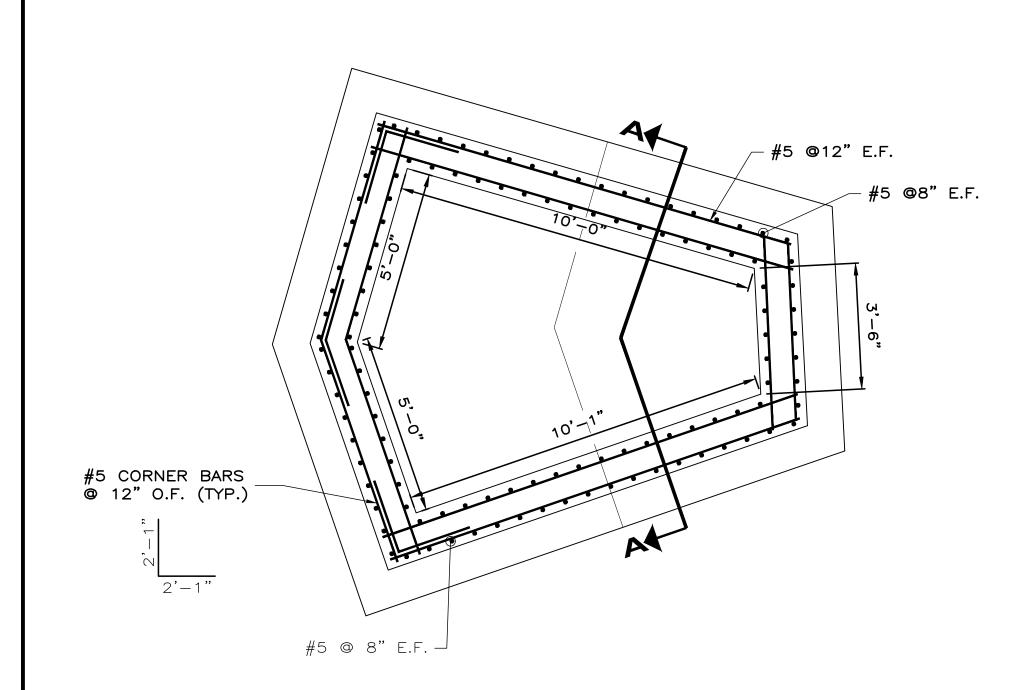
•	ISSUE DATE:	02/07/25
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	DESIGNED BY:	MPC
	DRAWN BY:	ТЈМ
WILLOUGHBY, OHIO	CHECKED BY:	LCH

ISSUED FOR:

JUNCTION CHAMBER DETAILS 1

PROJECT NO.
150772
DISCIPLINE
CIVIL
SHEET NAME
MH DET-1

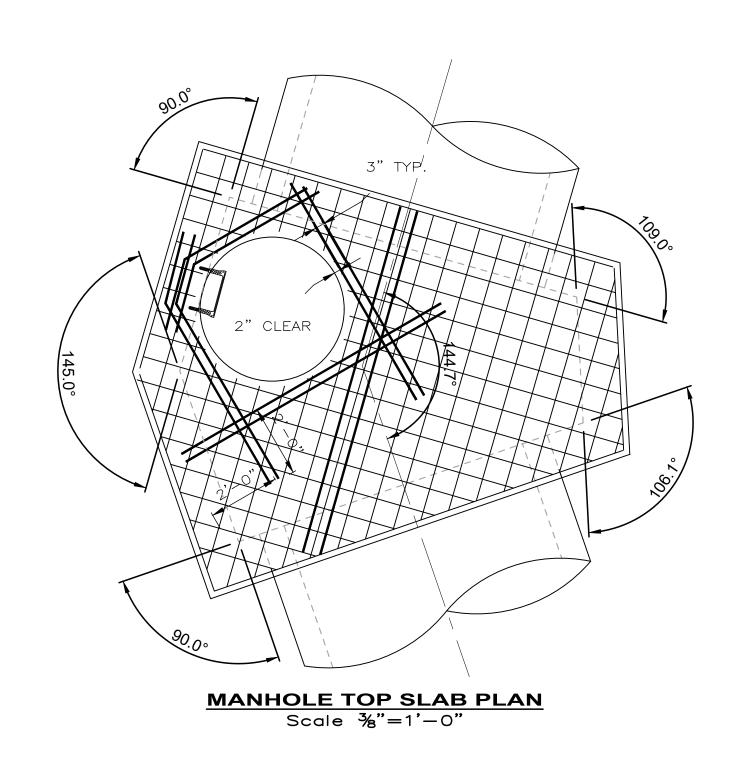
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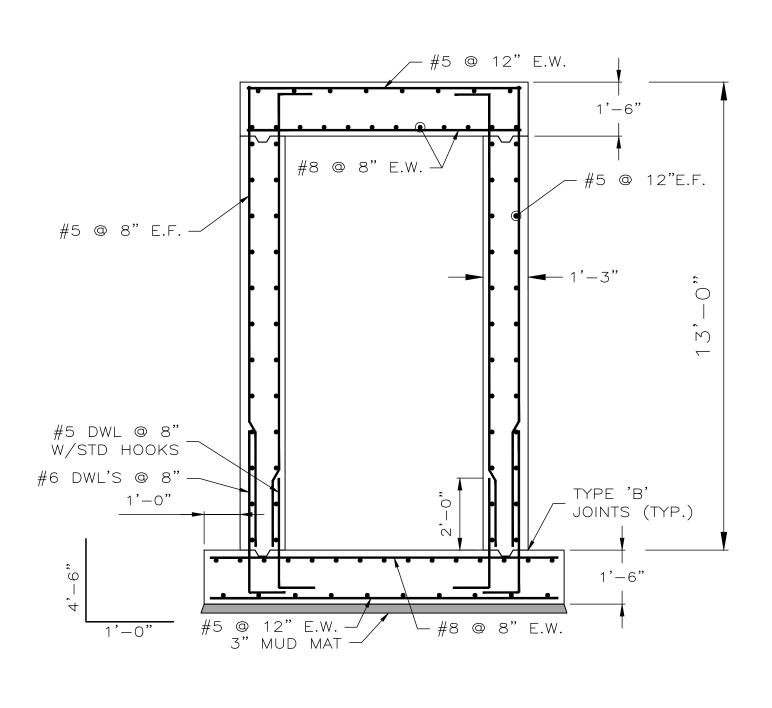


JUNCTION CHAMBER #3

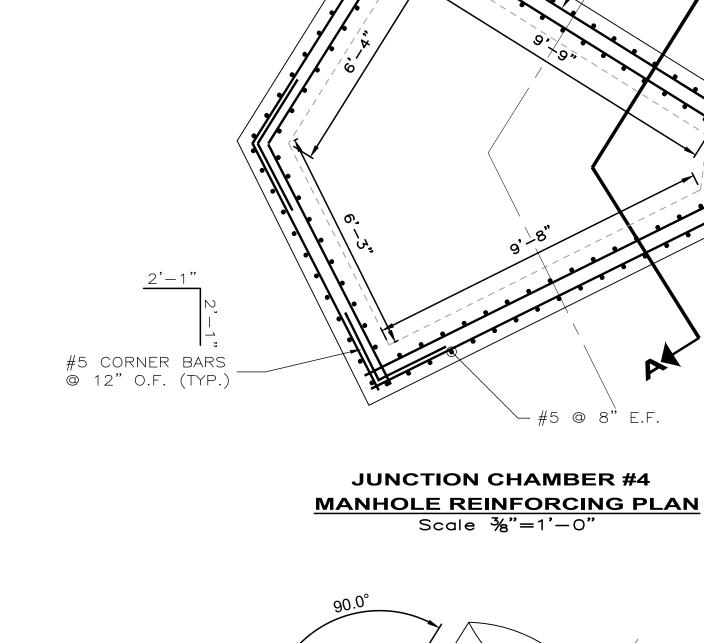
MANHOLE REINFORCING PLAN

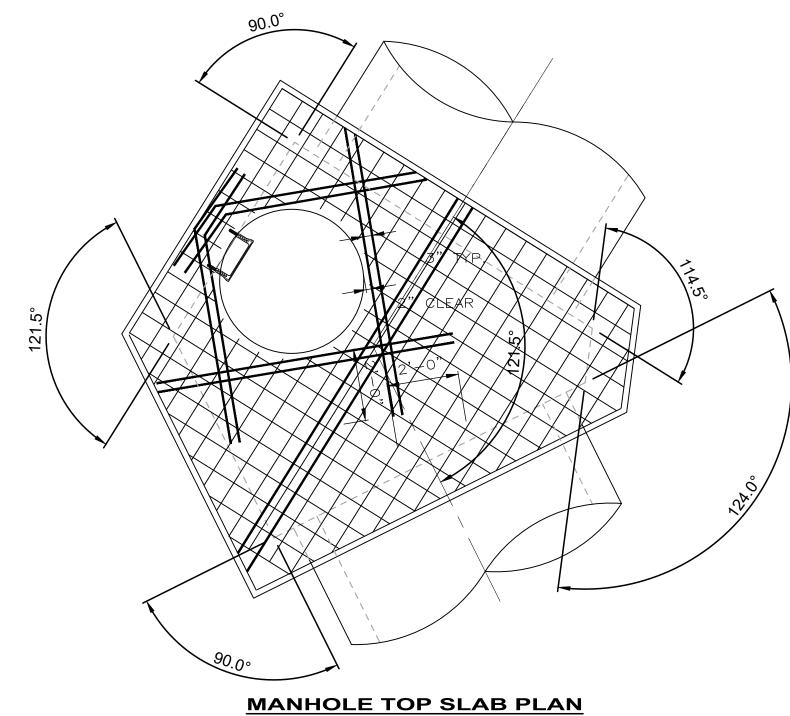
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SECTION A-A





Scale %"=1'-0"

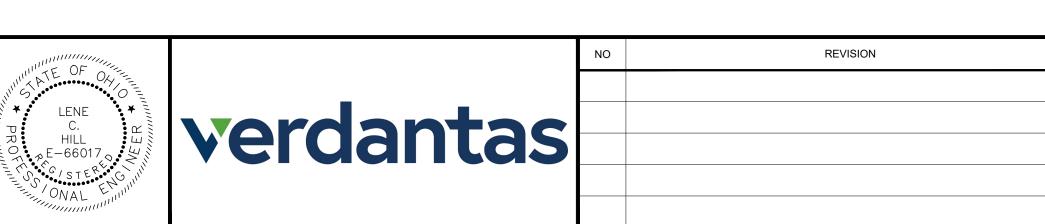
NOTES:

- 1. SEE STANDARD DETAILS FOR REINFORCING AROUND OPENINGS
- 2. CONCRETE CLASS QC1 COMPRESSIVE STRENGTH = 4000 PSI

LAKE COUNTY

- 3. REINFORCING STEEL GRADE 60 MINIMUM YIELD STRENGTH 60,000 PSI EPOXY COATED
- 4. CONTRACTOR HAS OPTION TO UTILIZE PRECAST CONCRETE MANHOLE STRUCTURES. THE STRUCTURE. NO ADDITIONAL PAYMENT TO CONTRACTOR SHALL BE MADE FOR PRECAST STRUCTURES.
- 5. PRECAST MANHOLE STRICTURES SHALL UTILIZE WATERPROOFING MEMBRANE AROUND FABRICATED STRUCTURE JOINTS.
- 6. PIPE TO MANHOLE CONNECTORS A-LOK OR APPROVED EQUIVALENT SHALL BE UTILIZED IN PRECAST SECTIONS.
- 7. PROVIDE MANHOLE STEPS 16" O/C.

DATE



CITY OF WILLOUGHBY

NASON BASIN TO GROVE AVENUE STORM SEWER IMPROVEMENTS PHASE 1

, .	ISSUE DATE:	02/07/25
NUE NTS	SCALE:	AS SHOWN
	DESIGNED BY:	MPC
	DRAWN BY:	TJM
WILLOUGHBY, OHIO	CHECKED BY:	LCH

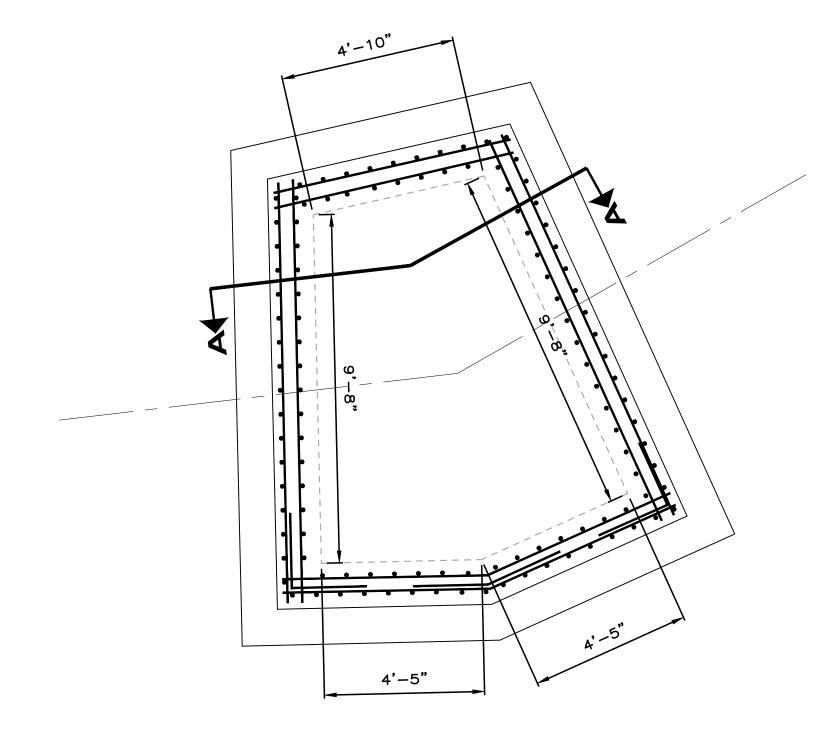
ISSUED FOR:

JUNCTION CHAMBER DETAILS 2

√#5 @12" E.F.

#5 @8" E.F.

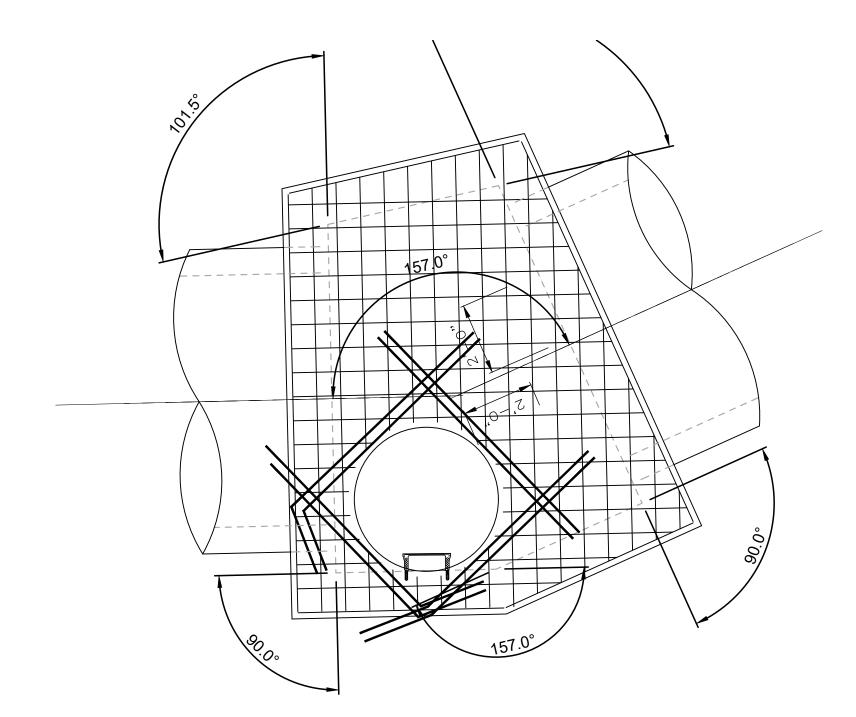
PROJECT NO.
150772
DISCIPLINE
CIVIL
SHEET NAME
MH DET- 2
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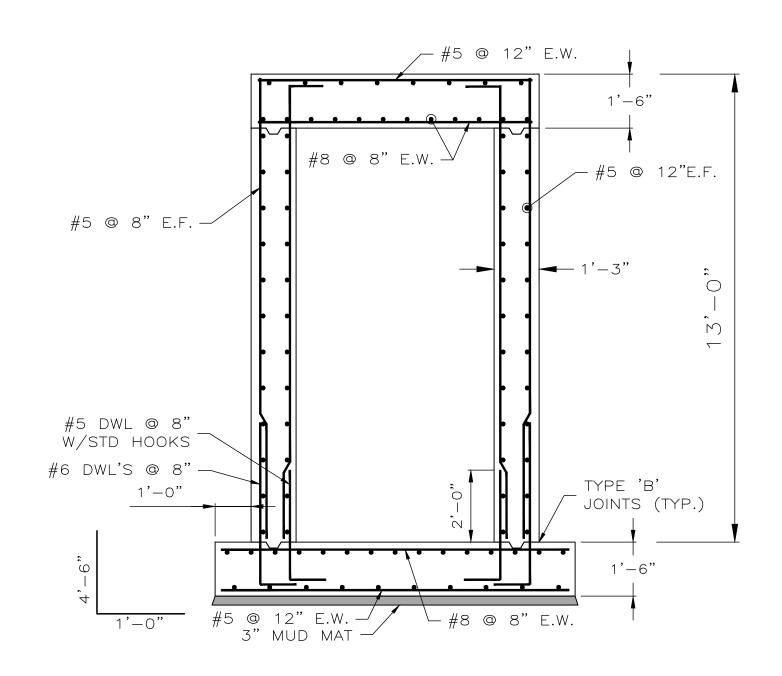
JUNCTION CHAMBER #5

MANHOLE REINFORCING PLAN

Scale %"=1'-0"



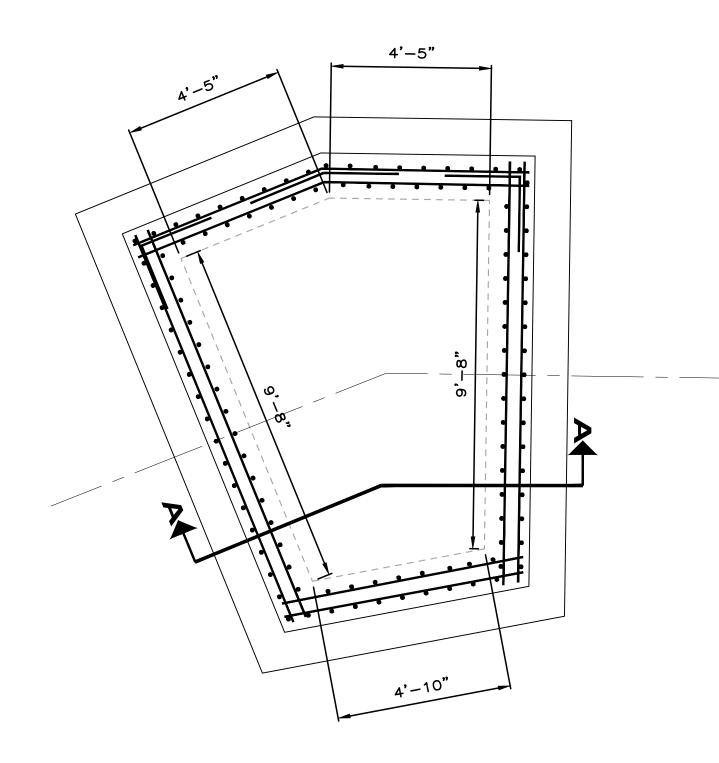
MANHOLE TOP SLAB PLAN
Scale %"=1'-0"



SECTION A-A
Scale $\frac{3}{6}$ "=1'-0"

NOTES:

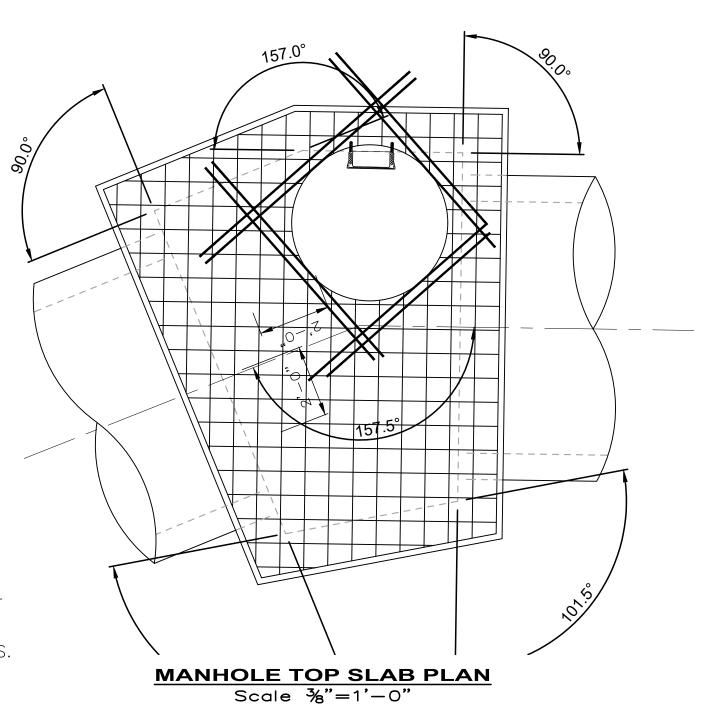
- 1. SEE STANDARD DETAILS FOR REINFORCING AROUND OPENINGS
- 2. CONCRETE CLASS QC1 COMPRESSIVE STRENGTH = 4000 PSI
- 3. REINFORCING STEEL GRADE 60 MINIMUM YIELD STRENGTH 60,000 PSI EPOXY COATED
- 4. CONTRACTOR HAS OPTION TO UTILIZE PRECAST CONCRETE MANHOLE STRUCTURES. THE STRUCTURE. NO ADDITIONAL PAYMENT TO CONTRACTOR SHALL BE MADE FOR PRECAST STRUCTURES.
- 5. PRECAST MANHOLE STRICTURES SHALL UTILIZE WATERPROOFING MEMBRANE AROUND FABRICATED STRUCTURE JOINTS.
- 6. PIPE TO MANHOLE CONNECTORS A-LOK OR APPROVED EQUIVALENT SHALL BE UTILIZED IN PRECAST SECTIONS.
- 7. PROVIDE MANHOLE STEPS 16" O/C.



JUNCTION CHAMBER #6

MANHOLE REINFORCING PLAN

Scale %"=1'-0"



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CITY OF WILLOUGHBY

NASON BASIN TO GROVE AVENUE STORM SEWER IMPROVEMENTS

PHASE 1

LAKE COUNTY WILLOUGHBY, OHIO

ISSUED FOR: BID

ISSUE DATE: 02/07/25

SCALE: AS SHOWN

DESIGNED BY: MPC

DRAWN BY: TJM

CHECKED BY: LCH

JUNCTION CHAMBER DETAILS 3

PROJECT NO.

150772

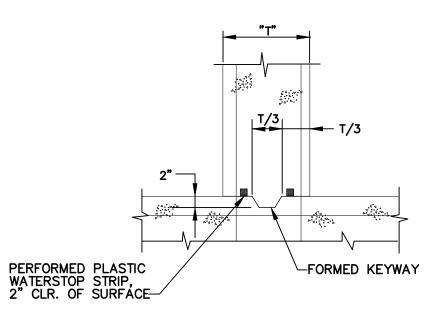
DISCIPLINE

CIVIL

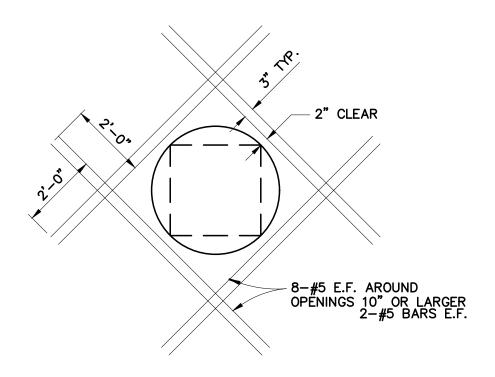
SHEET NAME

MH DET-3

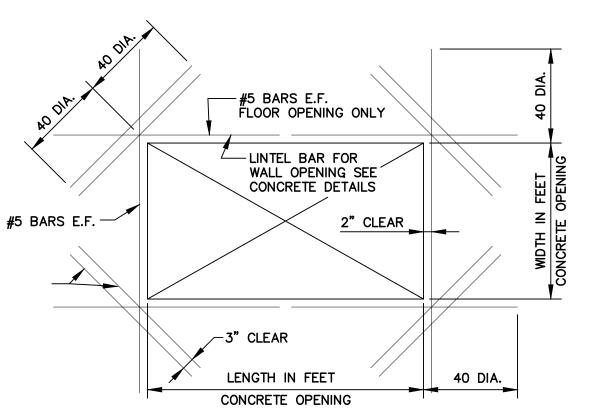
H:\2015\150772\DWG\SHEETS\C_150772-31_MH-D01 -D06.DWG - MH DET-3 - 1/8/2025 8:38:57 AM - TYLER MINTUS



TYPE "B"
WATERSTOP CONSTRUCTION JOINT
(N.T.S.)



TYPICAL REINFORCING AROUND OPENINGS IN REINFORCED CONCRETE SLABS AND WALLS



TYPICAL REINFORCING AROUND BARS SHALL BE TOP & OPENINGS IN REINFORCED CONCRETE SLABS AND WALLS

(N.T.S.)

WATERSTOP NOTES:

- 1. WATERSTOP SHOWN SHALL BE "WATERSTOP-RX" BY AMERICAN COLLOID COMPANY OR "SYNKO-FLEX" BY SYNKO-FLEX PRODUCTS, INC. OR AN APPROVED EQUAL.
- 2. MAINTAIN A MINIMUM OF 2 INCHES OF CONCRETE COVER TO THE EXTERIOR OF THE JOINT SURFACE.
- 3. EXISTING CONCRETE SURFACES SHALL BE CLEAN AND DRY. APPLY MANUFACTURER'S RECOMMENDED PRIMER TO EXISTING SURFACE PRIOR TO INSTALLING WATERSTOP.
- 4. THE ENDS OF WATERSTOP STRIPS SHALL BE BUTTED TOGETHER OR LAPPED END TO END AS REQUIRED BY THE APPROVED MANUFACTURER.

STRUCTURAL BACKFILL AND FILL

- NO BACKFILL SHALL BE PLACED AGAINST ANY STRUCTURAL ELEMENT UNTIL THE STRENGTH LEVEL OF THE IN-PLACE CONCRETE HAS ATTAINED THE SPECIFIED DESIGN STRENGTH.
- 2. THE CONTRACTOR MAY TEST IN-PLACE STRENGTH USING NONDESTRUCTIVE PROCEDURES OF ASTM C803.
- 3. WHERE STRUCTURES ARE LOCATED OUTSIDE OF PAVEMENT OR THE ZONE OF INFLUENCE, EXISTING ON—SITE SOILS WHICH ARE FREE OF ORGANIC CONTAMINATION AND OTHER OBJECTIONABLE MATERIALS MAY BE UTILIZED AS FILL MATERIAL BEYOND THE LIMITS OF POROUS STRUCTURAL BACKFILL. COMPACT MAXIMUM EIGHT (8") INCH LOOSE LAYERS UNIFORMLY TO NOT LESS THAN 98% STANDARD PROCTOR UNLESS OTHERWISE SPECIFIED. SHALE AND/OR SLAG MAY NOT BE USED AS A BACKFILL OR FILL MATERIAL.
- 4. POROUS STRUCTURAL BACKFILL SHALL BE PLACED FULL LENGTH AND HEIGHT AROUND ALL NEW STRUCTURES. THE THICKNESS NORMAL TO WALL FACE SHALL BE NOT LESS THAN 18" INCHES.
- 5. POROUS BACKFILL SHALL BE GRAVEL OR LIMESTONE; NO. 467, NO. 57, NO. 67, NO. 6 OR NO. 78 SIZE.

CONCRETE SPECIFICATIONS

- 1. ALL STRUCTURAL CONCRETE SHALL BE ODOT ITEM 499 CLASS QC1.
- 2. CONCRETE DESIGN MIX SHALL BE SUBMITTED TO ENGINEER FOR REVIEW AND APPROVAL PRIOR TO STARTING WORK.
- 3. ALL REINFORCING SHALL BE ASTM 615 GRADE 60.
- 4. MUD MAT CONCRETE SHALL BE 2000 PSI (28 DAYS).

EXCAVATION SUPPORT

- 1. IF THE CONTRACTOR PROVIDES TEMPORARY EXCAVATION SUPPORTS TO ENCLOSE AND PROTECT THE CHAMBER EXCAVATIONS, HE SHALL SUBMIT HIS DESIGN TO THE ENGINEER FOR REVIEW. THE SUPPORT SYSTEM DESIGN AND CALCULATIONS SHALL BE PREPARED AND SEALED BY A REGISTERED OHIO PROFESSIONAL FUGINEER.
- 2. CONTINUOUS DEWATERING MAY BE REQUIRED AT THE TIME OF EXCAVATION TO MAINTAIN THE WATER TABLE BELOW THE BOTTOM OF EXCAVATION.

LOW STRENGTH MORTAR BACKFILL

- SELF-COMPACTING FLOWABLE, CONTROLLED LOW STRENGTH MORTAR BACKFILL SHALL BE USED FOR BACKFILL WHERE INDICATED.
- 2. THE MATERIAL SHALL BE PROPORTIONED IN ACCORDANCE WITH ODOT ITEM 613, LOW STRENGTH MORTAR BACKFILL, TYPE 1 WITH A MINIMUM 28 DAY UNCONFINED COMPRESSIVE STRENGTH OF 100 PSI, SAMPLES SHALL BE FABRICATED AND TESTED IN ACCORDANCE WITH ASTM D 4832, AT 7 AND 28 DAYS.

CONCRETE CURING

- 1. BEGINNING IMMEDIATELY AFTER PLACEMENT, CONCRETE SHALL BE PROTECTED FROM PREMATURE
- 2. CURING COMPOUNDS SHALL NOT BE USED ON ANY STRUCTURAL ELEMENTS, INCLUDING SLABS.
- 3. PROVIDE MOIST CURING BY KEEPING CONCRETE SURFACES CONTINUOUSLY WET FOR A MINIMUM OF
- 4. ACCEPTABLE METHODS ARE BY PONDING, CONTINUOUS SPRINKLING, ABSORPTIVE MATS OR FABRICS KEPT CONTINUOUSLY WET, OR APPLICATION OF WATERPROOF SHEET MATERIALS CONFORMING TO ASTM C171

STRUCTURAL EXCAVATIONS

- 1. THE SUBSURFACE EXPLORATION PERFORMED FOR THIS PROJECT IS ON FILE AT THE OFFICES OF CT CONSULTANTS, INC. AND MAY BE REVIEWED BY CONTRACTORS BIDDING ON THE PROJECT.
- 2. THE CONTRACTOR SHALL MAINTAIN SAFE SIDE SLOPES FOR ALL STRUCTURAL EXCAVATIONS. EXCAVATION SLOPES FOR SOIL ABOVE ROCK SHOULD FOLLOW OSHA GUIDELINES FOR TYPE 'C' SOILS.

FOUNDATION PREPARATION

- 1. FOUNDATION EXCAVATIONS SHALL BE DUG WITH FLAT BOTTOMS OR AS SHOWN BY A METHOD THAT WILL NOT DISTURB THE BEARING MATERIAL.
- 2. SOIL LOOSENED DURING EXCAVATION SHALL BE REMOVED FROM THE FOOTING BOTTOM.
- 3. ALL FOOTING EXCAVATIONS SHALL BE CHECKED BY A GEOTECHNICAL ENGINEER OR ENGINEERING GEOLOGIST BEFORE POURING CONCRETE TO CONFIRM THAT DESIGN BEARING CONDITIONS ARE ACHIEVED IN THE FIELD. ALLOWABLE BEARING PRESSURE SHALL BE 2000 PSF MINIMUM.
- 4. THE FOOTING BEARING SURFACE SHALL BE PROTECTED AGAINST WATER ACCUMULATION FROM RAINFALL, SURFACE DRAINAGE OR SIDEWALL SEEPAGE.
- 5. A CONCRETE MUD MAT SHALL BE POURED IMMEDIATELY AFTER CLEANING THE EXCAVATION BOTTOM AND CHECKING THE BEARING CONDITION, UNLESS NOTED OTHERWISE.

MINIMUM CONCRETE COVER FOR REINFORCEMENT

UNLESS NOTED OTHERWISE:

- a. CONCRETE CAST AGAINST AND PERMANENTLY EXPOSED TO EARTH
- b. CONCRETE EXPOSED TO EARTH, LIQUID, WEATHER OR BEARING ON WORK MAT OR SLABS SUPPORTING EARTH COVER:

SLAB AND JOINTS

BEAMS AND COLUMNS:
 STIRRUPS, SPIRALS, AND TIES
 PRIMARY REINFORCING

WALLS

FOOTING AND BASE SLABS:
 FORMED SURFACES
 TOP OF FOOTINGS AND BASE SLABS

2"



verdantas

NO REVISION DATE

LAKE COUNTY

CITY OF WILLOUGHBY

NASON BASIN TO GROVE AVENUE STORM SEWER IMPROVEMENTS PHASE 1

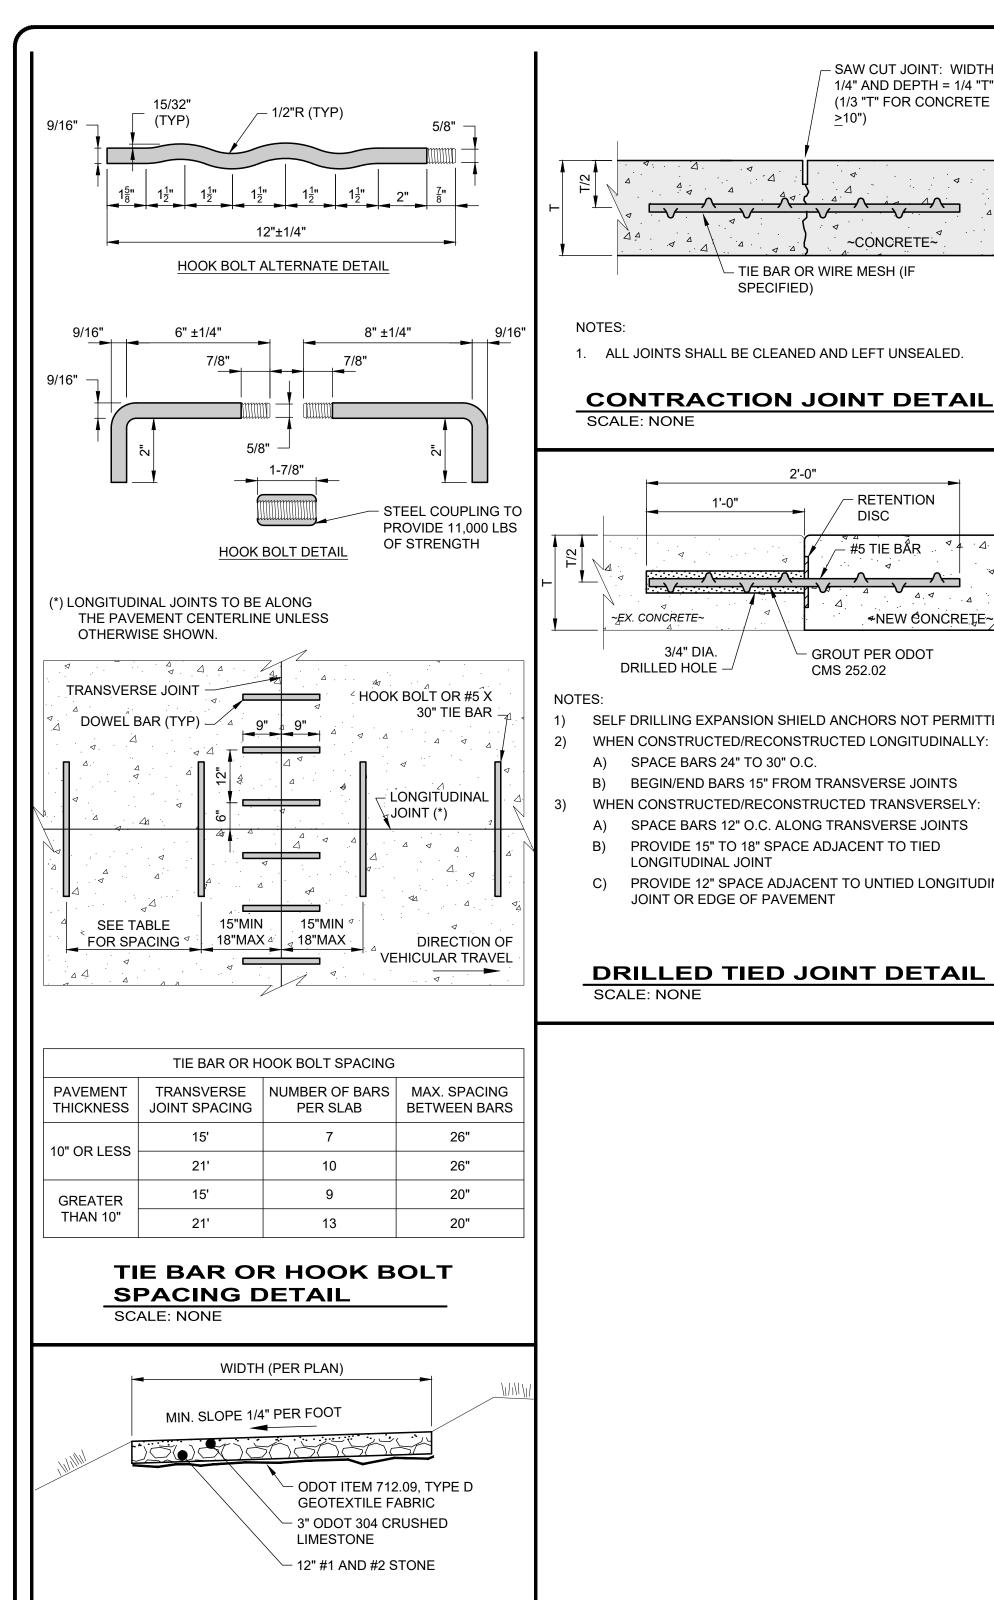
WILLOUGHBY, OHIO

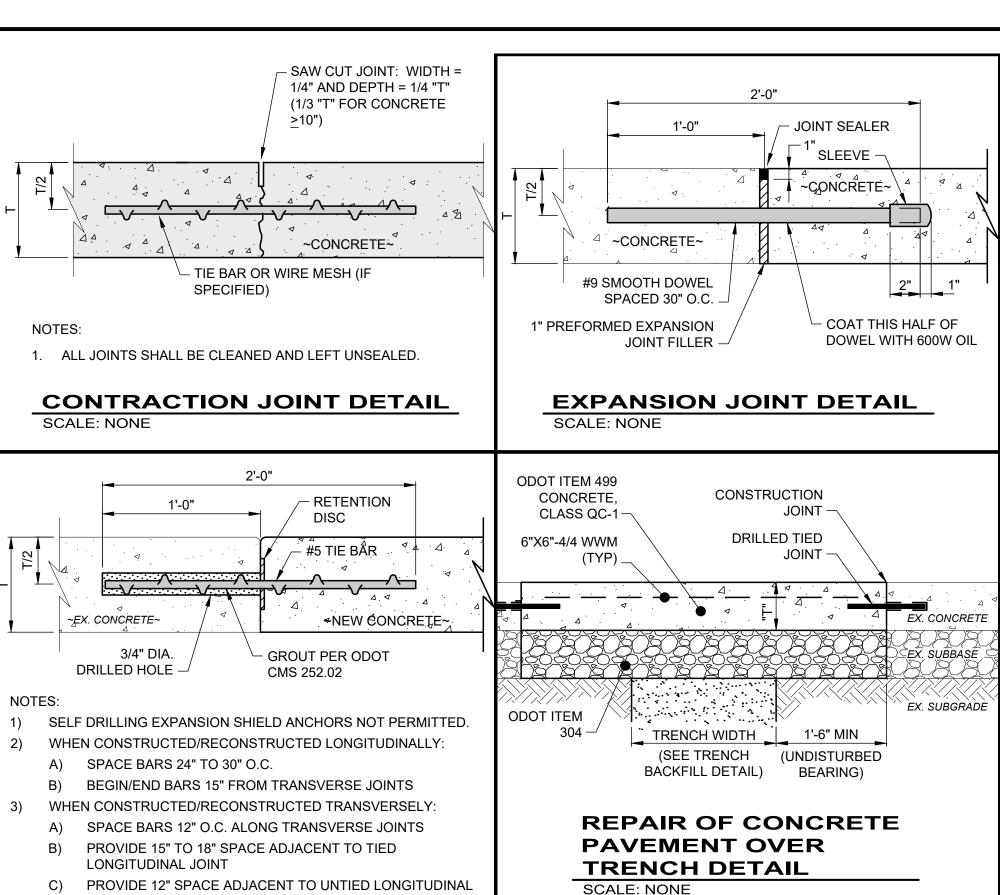
	ISSUED FOR:	BID
	ISSUE DATE:	02/07/25
	SCALE:	AS SHOWN
	DESIGNED BY:	MPC
	DRAWN BY:	TJM
)	CHECKED BY:	LCH

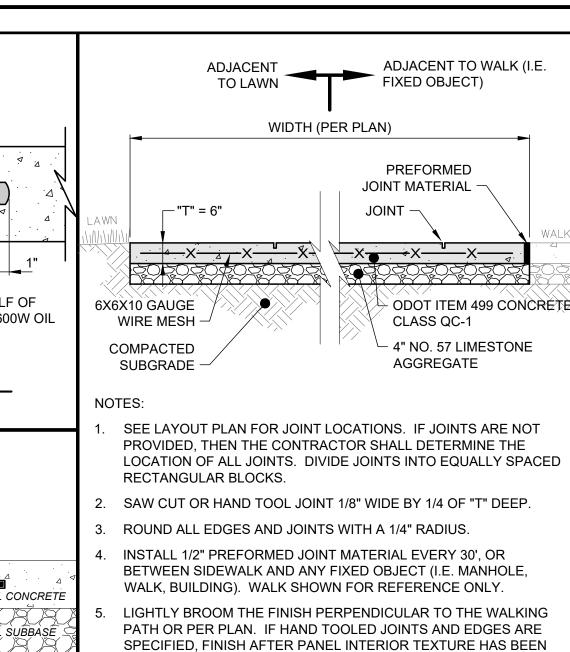
CAST IN PLACE MANHOLE REINFORCING DETAILS & NOTES

FROJECT NO.	
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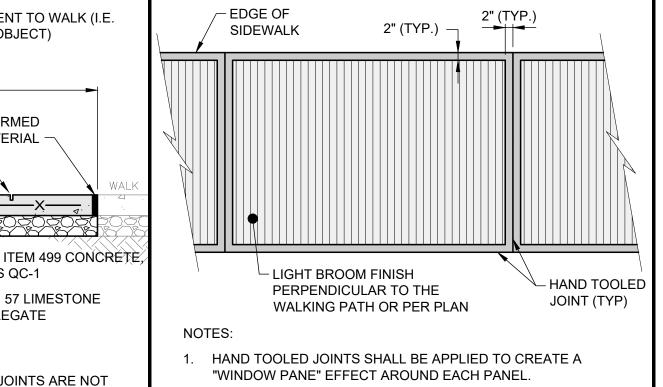


APPLIED (I.E WINDOW PANE EFFECT).

SCALE: NONE

6. APPLY LIQUID-MEMBRANE CURING COMPOUND (200 S.F./GAL.)

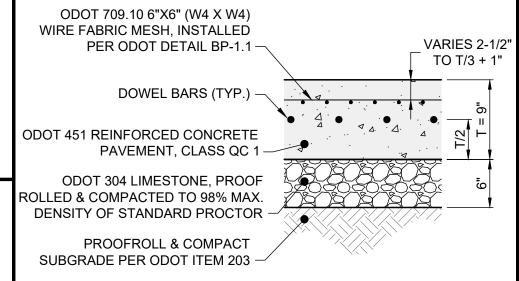
CONCRETE WALK DETAIL



- 2. ALL HAND TOOLED JOINTS AND EDGES SHALL BE FINISHED AFTER PANEL INTERIOR TEXTURE HAS BEEN APPLIED.
- 3. TOOLED EDGE SHALL BE 2" WIDTH EACH SIDE OF JOINT.

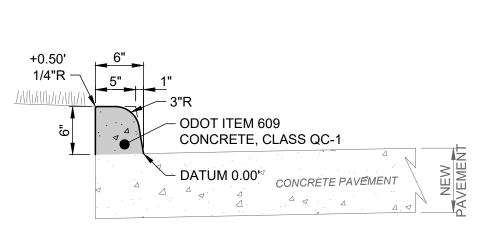
CONCRETE SIDEWALK JOINT AND FINISH DETAIL

SCALE: NONE



- THIS DETAIL SHOWS DIMENSIONS FOR REFERENCE ONLY. SEE SITE PLAN FOR ACTUAL THICKNESS.
- SEE LAYOUT PLAN FOR JOINT LOCATIONS. IF JOINTS ARE NOT SHOWN, THE CONTRACTOR SHALL DETERMINE THE LOCATION OF ALL JOINTS. DIVIDE JOINTS INTO EQUALLY SPACED RECTANGULAR BLOCKS. MAXIMUM JOINT SPACING SHALL BE 13' X 13'.
- IF UNSUITABLE SOILS EXISTS, SEE SUBGRADE REPAIR DETAIL

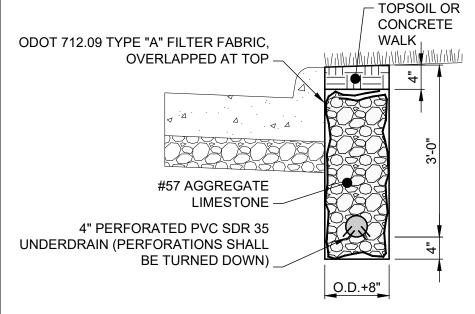
SCALE: NONE



NOTES:

1. SEE THE SEPARATE PAVEMENT DETAIL.

(ODOT TYPE 2A) **6" INTEGRAL VERTICAL CURB DETAIL** SCALE: NONE

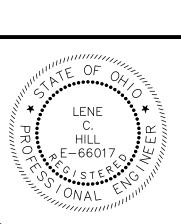


- 1. REMOVE OR COMPACT ALL LOOSE EXCAVATION AT BOTTOM OF TRENCH BEFORE INSTALLING AGGREGATE.
- 2. MAINTAIN POSITIVE DRAINAGE OF PIPE INVERTS WITH NO DIPS OR HUMPS IN FLOWLINE.

UNDERDRAIN DETAIL SCALE: NONE

- APPLY LIQUID-MEMBRANE CURING COMPOUND (200 S.F./GAL.).

REINFORCED CONCRETE PAVEMENT DETAIL



REVISION DATE verdantas

JOINT OR EDGE OF PAVEMENT

CITY OF WILLOUGHBY

NASON BASIN TO GROVE AVENUE STORM SEWER IMPROVEMENTS PHASE 1

LAKE COUNTY

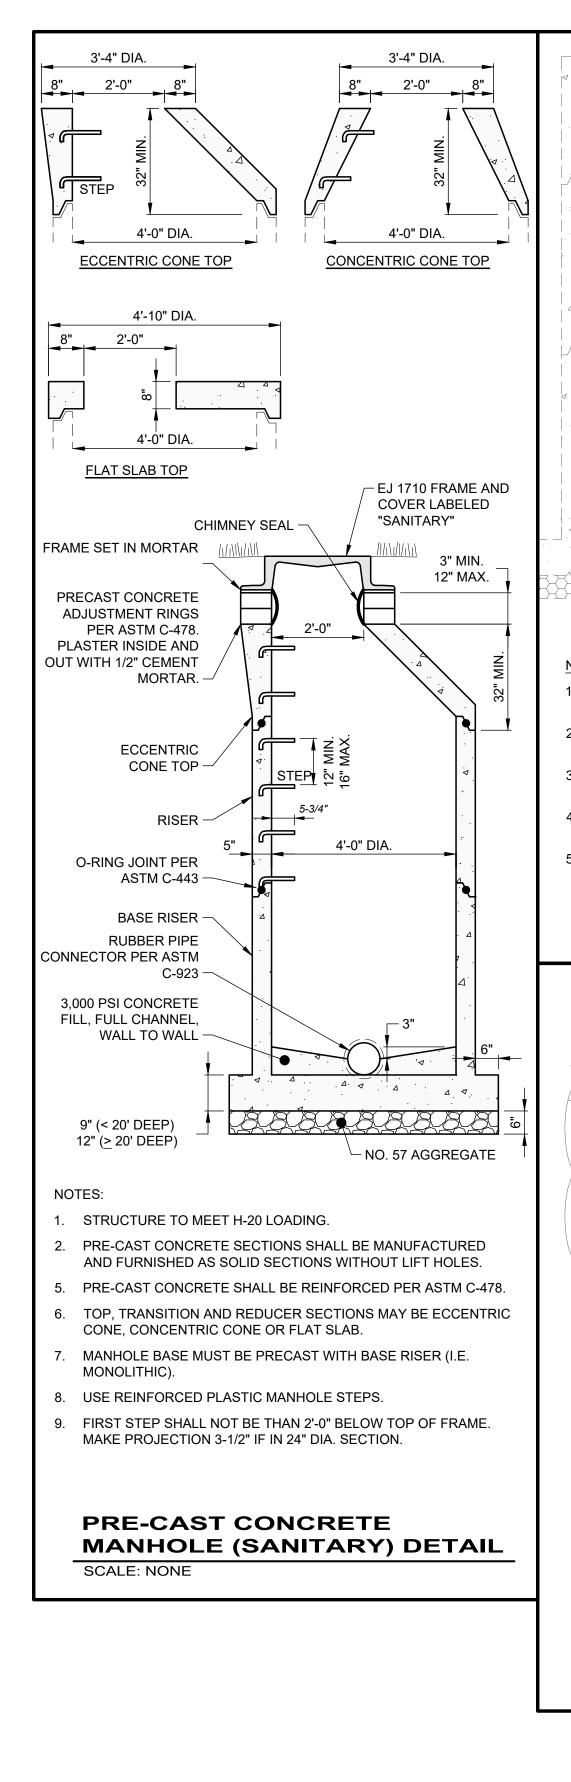
ISSUED FOR: ISSUE DATE: 02/07/25 SCALE: AS SHOWN **DESIGNED BY** DRAWN BY: TJM WILLOUGHBY, OHIO CHECKED BY:

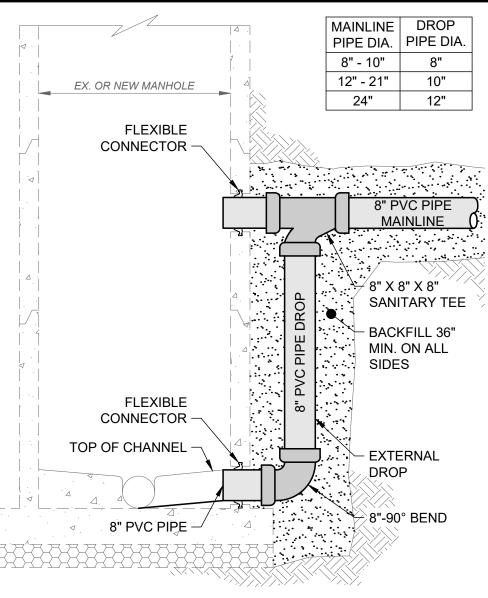
STANDARD DETAILS 1

PROJECT NO. 150772 DISCIPLINE CIVIL SHEET NAME DET-1 **32** 43

ACCESS ROAD DETAIL

SCALE: NONE

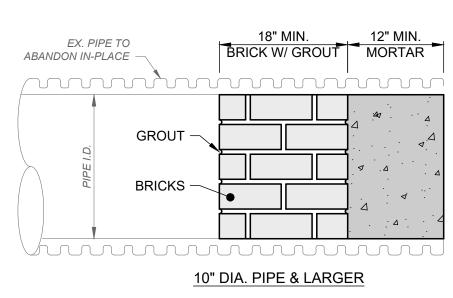


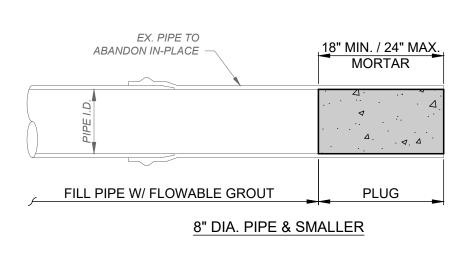


- SEE PRECAST CONCRETE MANHOLE (SANITARY) AND TRENCH BEDDING DETAILS FOR SPECIFICATIONS.
- THIS DETAIL SHOWS AN 8" PIPE FOR REFERENCE ONLY. SEE UTILITY PLAN FOR ACTUAL PIPE SIZE.
- PIPE AND FITTINGS MATERIALS SHALL BE PVC SDR 35 OR AS
- ALL PIPE OPENINGS MUST BE PREFABRICATED WITH FLEXIBLE CONNECTIONS PER ASTM C-923,A-LOK.
- TOP OF CONCRETE CHANNEL SHALL EXTEND TO FULL HEIGHT

PRECAST CONCRETE MANHOLE W/ OUTSIDE DROP DETAIL

SCALE: NONE





PIPE BULKHEAD DETAIL

EXCAVATED TRENCH WIDTH TRENCH WIDTH **GEOTEXTILE** GEOTEXTILE FABRIC FABRIC 12" MIN. 12" MIN. PIPE COVER COVER PIPE PIPE **SPRINGLINE** SPRINGLINE I.D. I.D. HAUNCHING HAUNCHING BEDDING BEDDING 6" MIN. OR 1/8 (MAY NOT BE SUBBEDDING PIPE I.D., WHICH-REQUIRED) SHAPE TRENCH BOTTOM **EVER IS GREATER** FOR PIPE BELLS

EXCAVATED TRENCH WIDTH: MEASURED FROM BOTTOM OF TRENCH TO 12" OVER TOP OF PIPE (WITHIN THE PIPE

EMBEDMENT), THE MIN. TRENCH WIDTH SHALL BE 9" AND THE

CLASS "C" PIPE EMBEDMENT

O.D.+24" FOR 24" AND SMALLER I.D. PIPE

O.D.+48" FOR 84" AND LARGER I.D. PIPE

O.D.+30" FOR 27" THRU 72" I.D. PIPE

FINAL BACKFILL: ALL AREAS UNDER PAVEMENT, STRUCTURES SPRINGLINE OR WITHIN THE ZONE OF INFLUENCE SHALL BE PREMIUM BACKFILL (ODOT ITEM 304 LIMESTONE). PAVEMENT INCLUDES ROADWAY, SHOULDER AND DRIVEWAY, BUT NOT SIDEWALK.

NO SLAG OR SLACKER AGGREGATES ALLOWED. IN ALL OTHER AREAS, THE FINAL BACKFILL SHALL BE SUITABLE ON-SITE MATERIAL.

PIPE EMBEDMENT:

MAX. SHALL BE:

CLASS "A": SHALL BE USED FOR ALL PIPES UNDER PAVEMENT OR STRUCTURES WITH LESS THAN 12" OF PIPE COVER TO THE SUBGRADE. THE CONCRETE CRADLE SHALL BE IN ACCORDANCE WITH ODOT ITEM 499, CLASS QC-1. THE INITIAL BACKFILL SHALL BE NO. 57 COURSE INTERLOCKING LIMESTONE AGGREGATE.

CLASS "B": SHALL BE USED FOR ALL PIPES UNLESS OTHERWISE NOTED ON THE PLANS. BEDDING AND HAUNCHING SHALL BE NO. 8 OR 57 COURSE INTERLOCKING LIMESTONE AGGREGATE IN AREAS UNDER PAVEMENT, STRUCTURES OR WITHIN THE ZONE OF INFLUENCE, THE INITIAL BACKFILL SHALL BE NO. 8 OR 57 COURSE INTERLOCKING LIMESTONE AGGREGATE. IN ALL OTHER AREAS, THE INITIAL BACKFILL MAY BE SUITABLE ON-SITE MATERIAL FOR RIGID PIPE, AND SHALL BE NO. 8 OR 57 COURSE INTERLOCKING LIMESTONE AGGREGATE FOR FLEXIBLE PIPE.

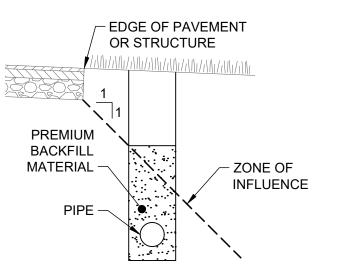
CLASS "C": SHALL BE USED ONLY FOR DUCTILE IRON WATER MAIN OR FORCE MAIN. THE PIPE EMBEDMENT SHALL BE NO. 8 OR 57 COURSE INTERLOCKING LIMESTONE AGGREGATE IN ALL AREAS UNDER PAVEMENT, STRUCTURES OR WITHIN THE ZONE OF INFLUENCE. IN ALL OTHER AREAS, THE PIPE EMBEDMENT SHALL BE SUITABLE ON-SITE MATERIAL. BEDDING IS NOT REQUIRED. WHERE ROCK OR SHALE IS ENCOUNTERED, BEDDING SHALL BE 6" MIN. OF NO. 8 OR 57 COURSE INTERLOCKING LIMESTONE AGGREGATE OR SAND.

- SUBBEDDING: WHERE AN UNSTABLE TRENCH BOTTOM CONDITION IS ENCOUNTERED, EXCAVATE TO A DEPTH REQUIRED BY THE ENGINEER AND REPLACE WITH MATERIAL AS DIRECTED BY THE ENGINEER.
- GEOTEXTILE FABRIC SHALL BE PER ODOT 712.09, TYPE A, AND INSTALLED AFTER ALL INITIAL BACKFILL.
- CLAY TRENCH DAMS SHALL BE REQUIRED AS SHOWN ON PLANS OR AS DIRECTED BY THE ENGINEER.

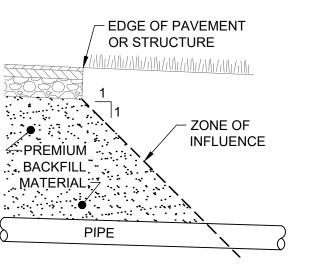
EXCAVATED TRENCH WIDTH PAVEMENT SUBGRADE LESS THAN PIPE O.D. 12" COVER CONCRETE CRADLE (IF REQUIRED) **SUBBEDDING**

CLASS "B" PIPE EMBEDMENT

CLASS "A" PIPE EMBEDMENT



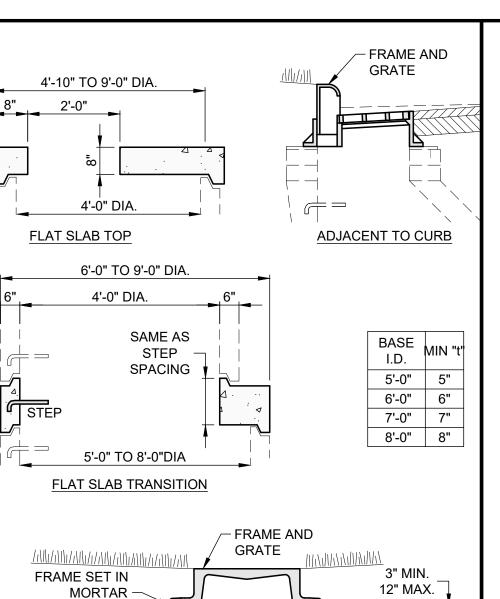
PARALLEL ZONE OF INFLUENCE



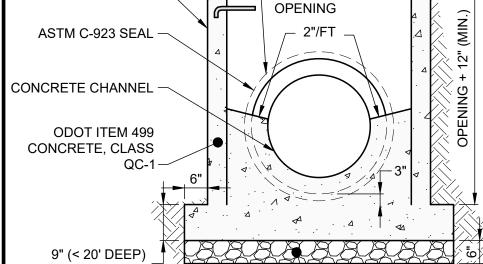
TRANSVERSE ZONE OF INFLUENCE

TRENCHING, EMBEDMENT AND BACKFILL DETAIL

SCALE: NONE



PER ASTM C-478 STEP **ECCENTRIC** CONE TOP RISER 4'-0" DIA ─ O.D.+2" MIN



12" (> 20' DEEP)

PRECAST CONCRETE

ADJUSTMENT RINGS

- 1. STRUCTURE TO MEET H-20 LOADING.
- PRE-CAST CONCRETE SECTIONS SHALL BE MANUFACTURED AND FURNISHED WITH LIFT HOLES.
- 3. TOP, TRANSITION AND REDUCER SECTIONS MAY BE ECCENTRIC CONE, CONCENTRIC CONE OR FLAT SLAB.
- OPENINGS IN RISER SECTIONS FOR 18" AND SMALLER PIPES TO BE PREFABRICATED. PROVIDE FLEXIBLE CONNECTIONS ("Z" LOCK, INSERT A-TEE, OR APPROVED EQUAL) FOR ALL PIPES.
- JOINT SEAL BETWEEN PRE-CAST MANHOLE SECTIONS TO BE RESILIENT AND FLEXIBLE GASKET JOINTS PER ODOT ITEM
- PRE-CAST CONCRETE SHALL BE REINFORCED PER ASTM C-478.
- USE REINFORCED PLASTIC MANHOLE STEPS.

SCALE: NONE

- 8. FIRST STEP SHALL NOT BE THAN 2'-0" BELOW TOP OF FRAME. MAKE PROJECTION 3-1/2" IF IN 24" DIA. SECTION.
- 9. USE FRAME AND GRATE EJ 1040 W/TYPE B VENTED COVER IN PAVEMENT, EJ 1040 W/TYPE N OVAL GRATE IN GRASS, EJ 7000 W/TYPE M2 SINUSOIDAL GRATE AND T1 BACK IN PAVEMENT ADJACENT TO CURB, OR PER PLAN.

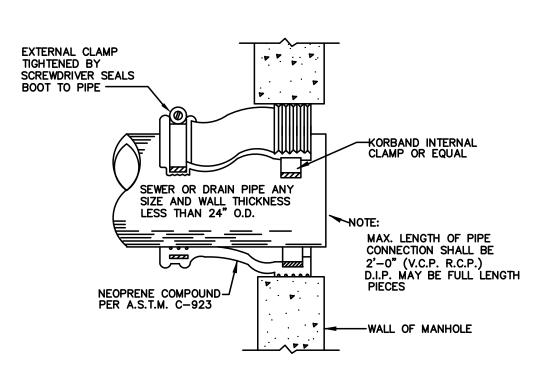
PRE-CAST CONCRETE MANHOLE (STORM) DETAIL

PRECAST MANHOLE RISER SECTION -NEW PIPE DIA. (PER PLAN) PIPE OPENINGS SHALL BE PRE-CAST INTO RISER SECTION -**GROUT OPENING** SAWCUT AND REMOVE **BETWEEN PIPE** TOP HALF OF EX. PIPE AND OPENING WITHIN MANHOLE AFTER POURED BASE HAS SET 1"/FT. (TO FORM CHANNEL) POURED CONCRETE CHANNEL 1/2 I.D. + REBAR (TYP.) -NO. 57 AGGREGATE -**BRICK OR SOLID BLOCK SUPPORTS -** CAST-IN PLACE CONCRETE BASE, ODOT ITEM 499 CONCRETE, CLASS QC-1

- USE #4 REBAR AT 18" O.C. EACH WAY FOR MANHOLE DEPTH LESS THAN 14', AND USE #5 REBAR FOR MANHOLE DEPTHS GREATER THAN 14'.
- IF NOT PREFORMED, THE PIPE OPENING IN THE PRECAST RISER SECTION MUST BE FULL DEPTH SAW CUT. THE CONTRACTOR SHALL NOT USE A JACKHAMMER OR SLEDGEHAMMER TO CREATE THE OPENING.

DOGHOUSE MANHOLE DETAIL

SCALE: NONE



CORE DRILLED PIPE CONNECTION AT MANHOLE FLEXIBLE GASKET DETAIL SCALE: NONE

NO

SCALE: NONE

REVISION

ISSUED FOR: ISSUE DATE: 02/07/25 AS SHOWN SCALE: **DESIGNED BY** TJM DRAWN BY:

– NO. 57 AGGREGATE

PROJECT NO. 150772 DISCIPLINE CIVIL SHEET NAME DET-2 43 33

CITY OF WILLOUGHBY

NASON BASIN TO GROVE AVENUE STORM SEWER IMPROVEMENTS PHASE 1

WILLOUGHBY, OHIO CHECKED BY:

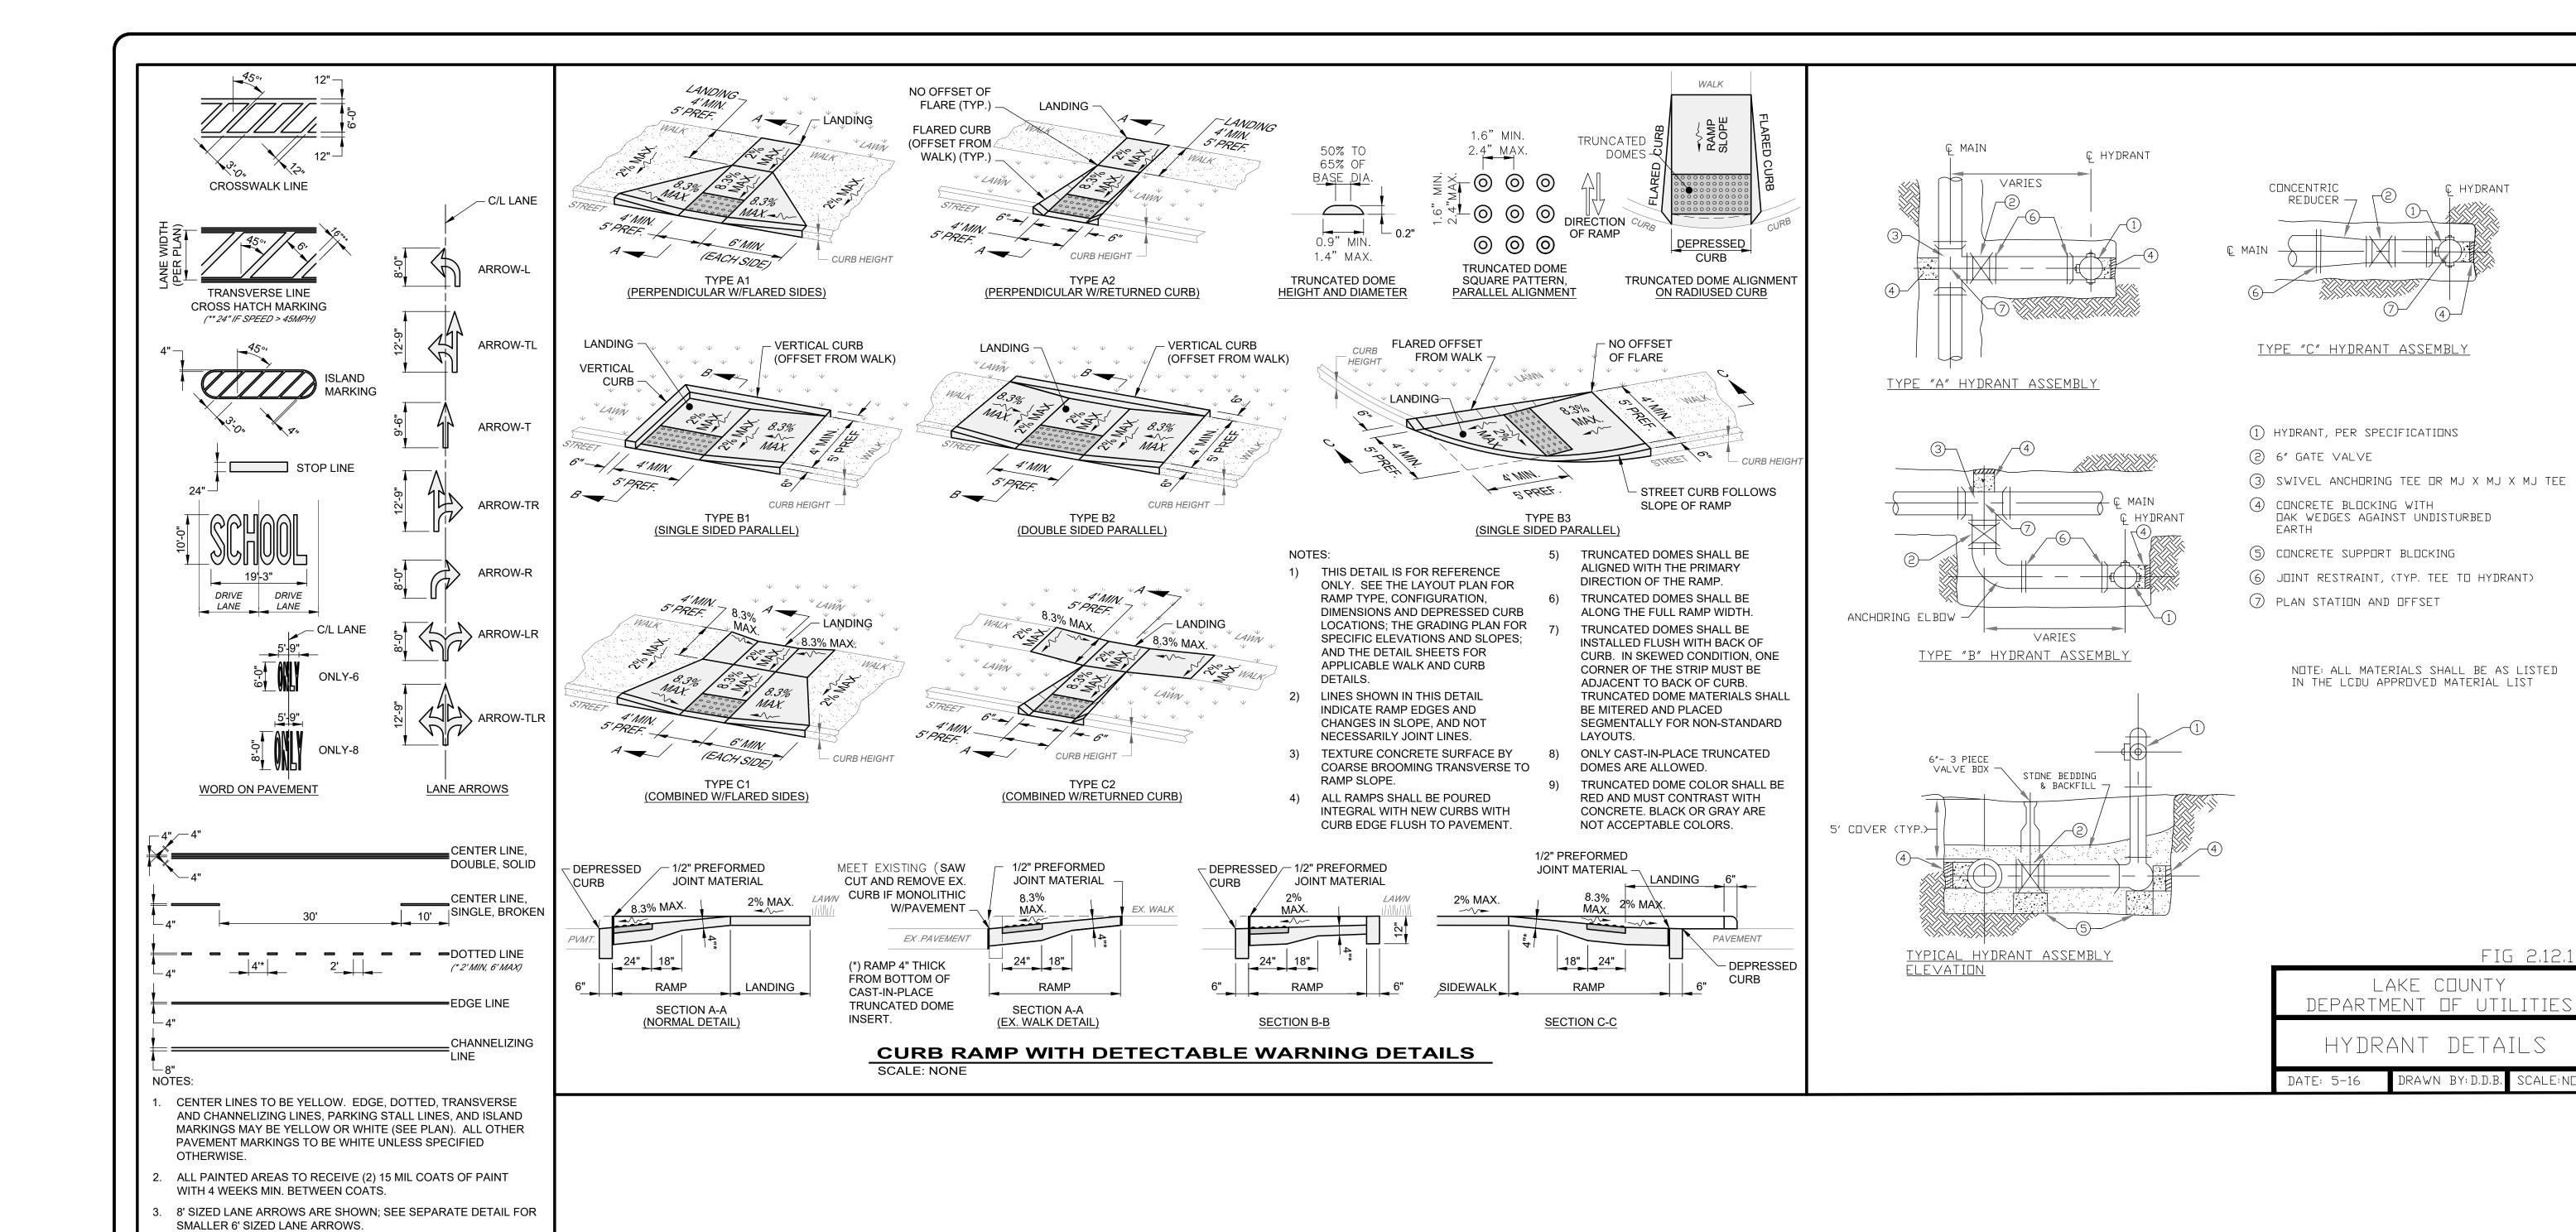
DATE

LAKE COUNTY

H:\2015\150772\DWG\SHEETS\C_150772 - STD DETAILS.DWG - DET-2 - 2/5/2025 4:29:44 PM - TYLER MINTUS

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STANDARD DETAILS 2



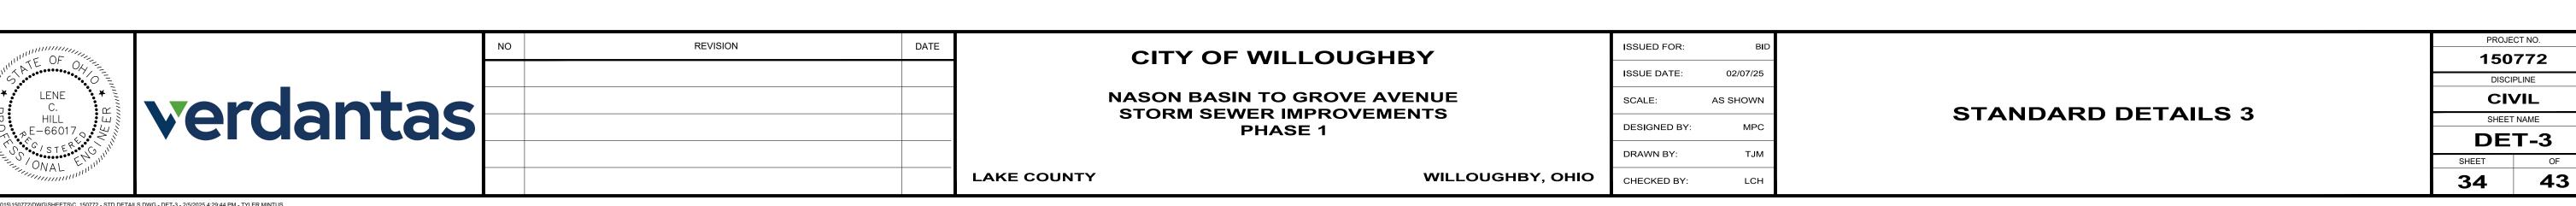
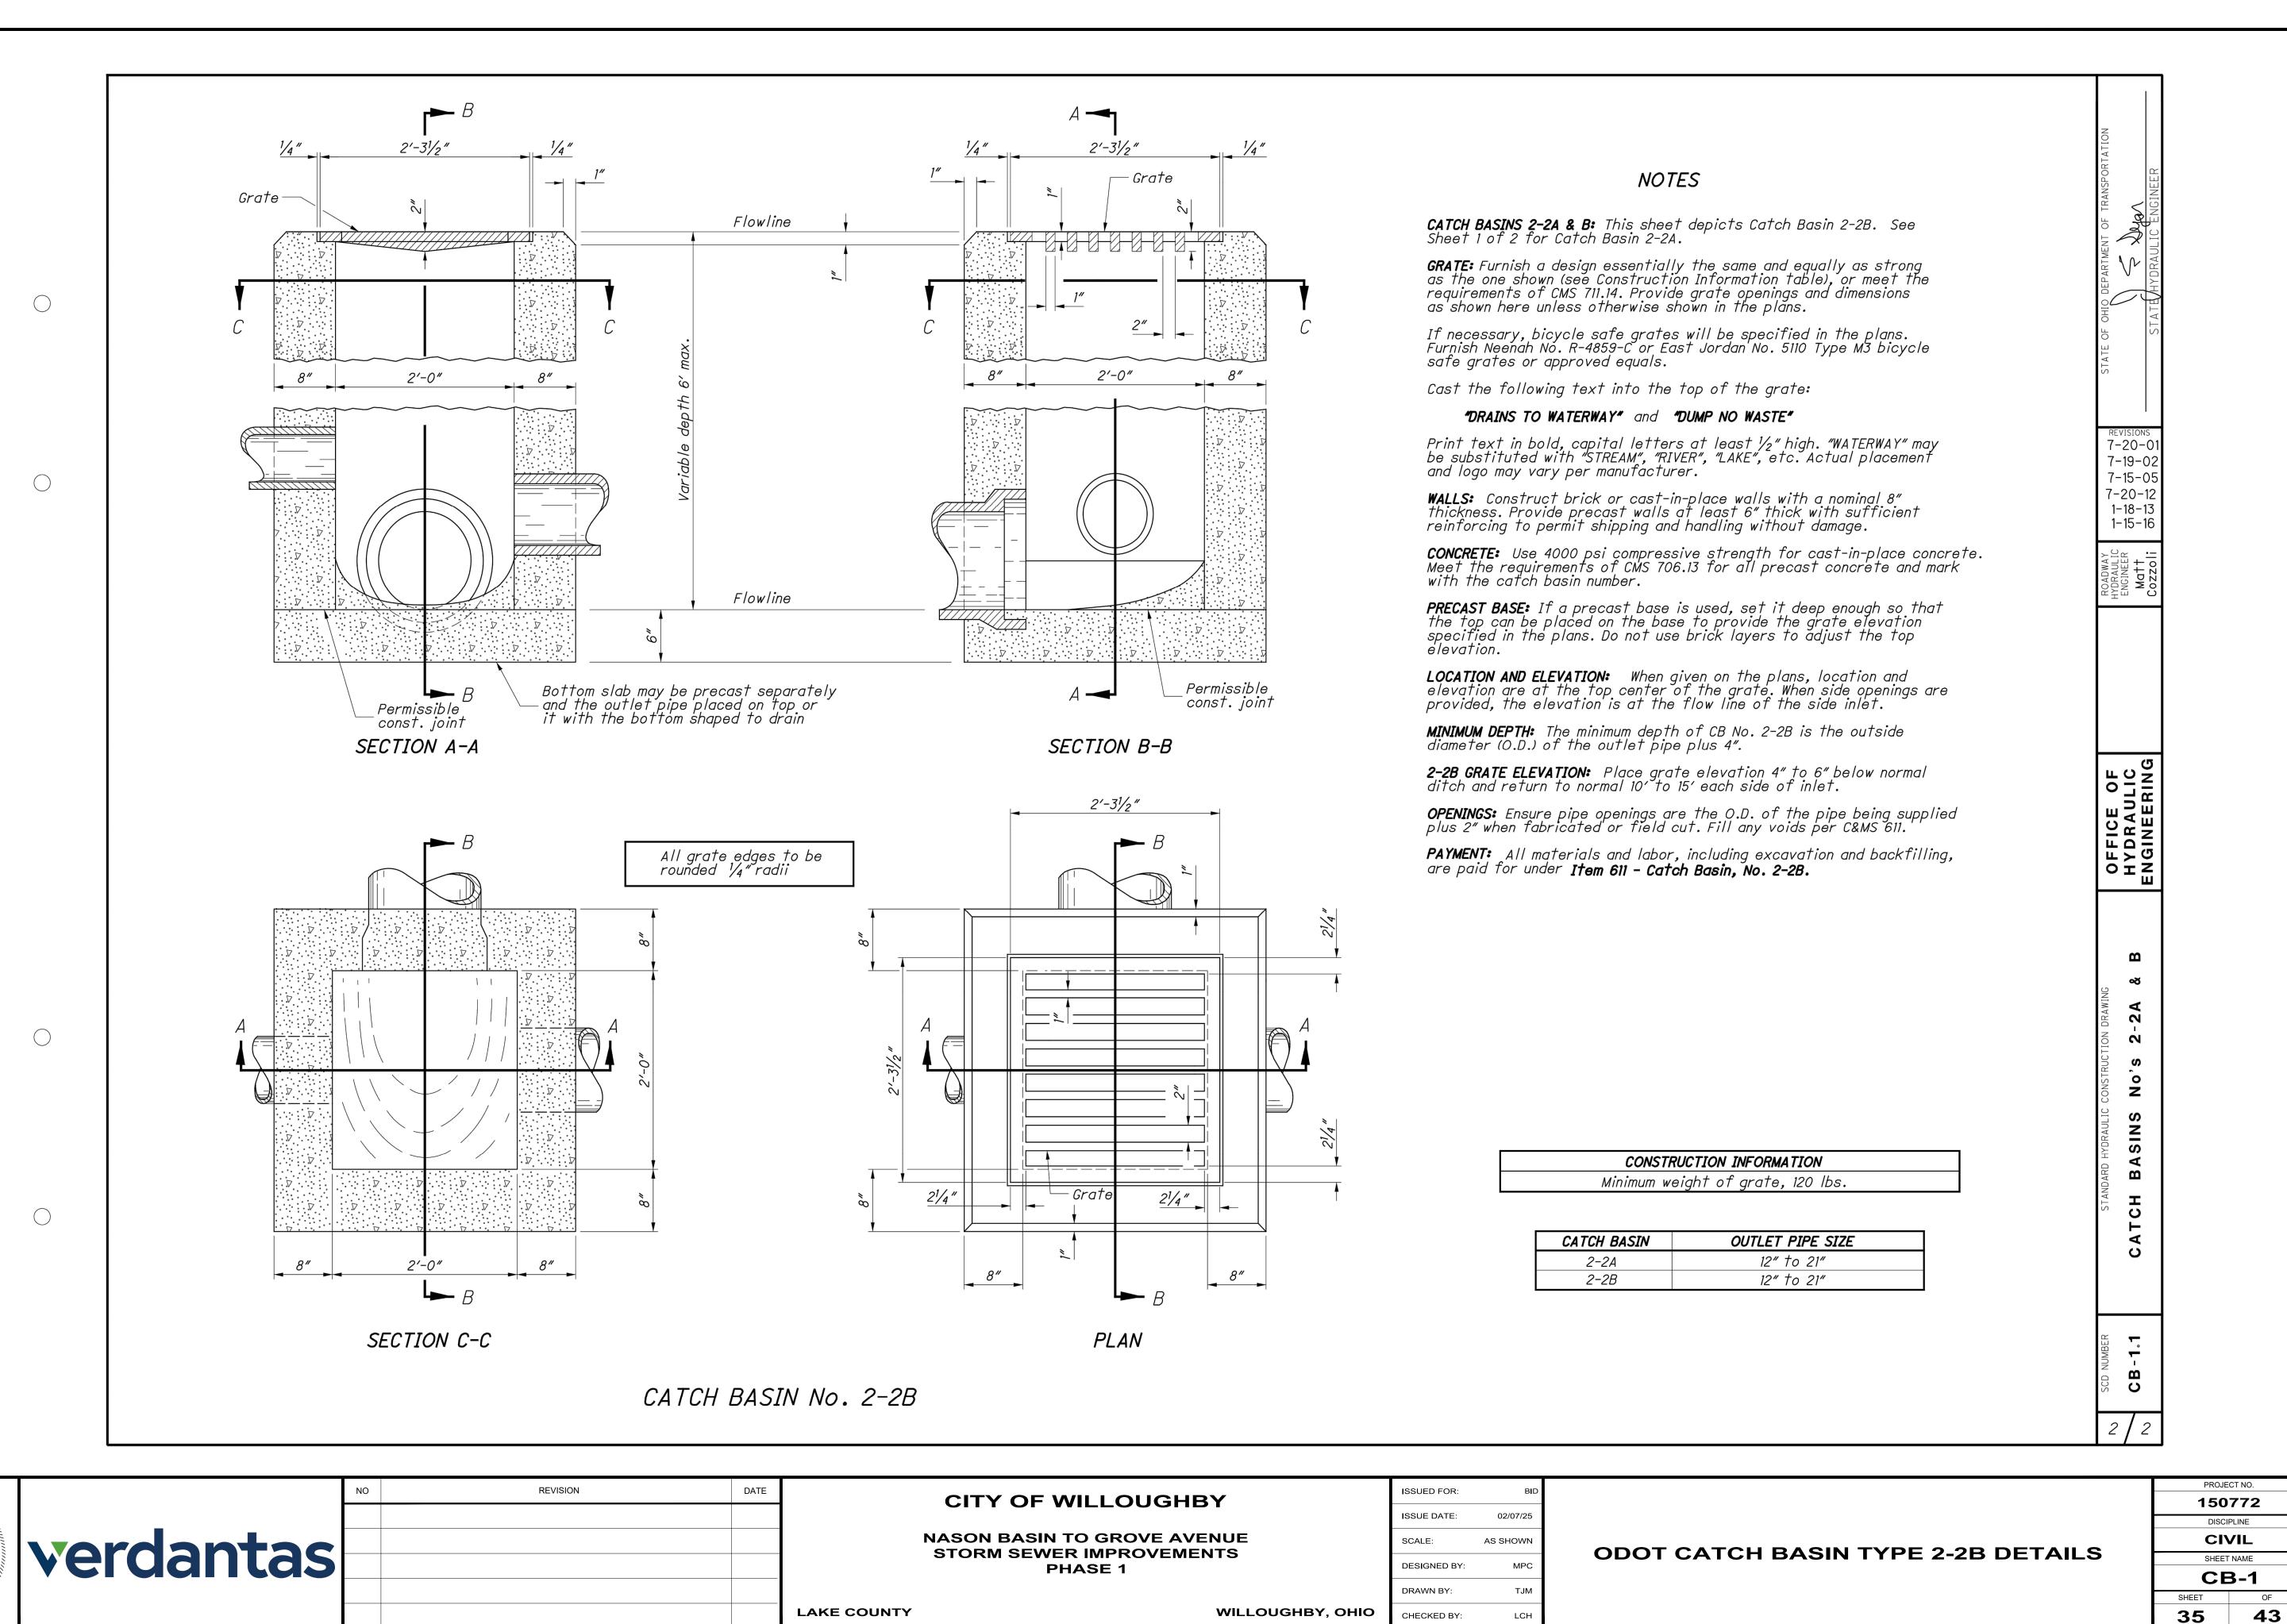


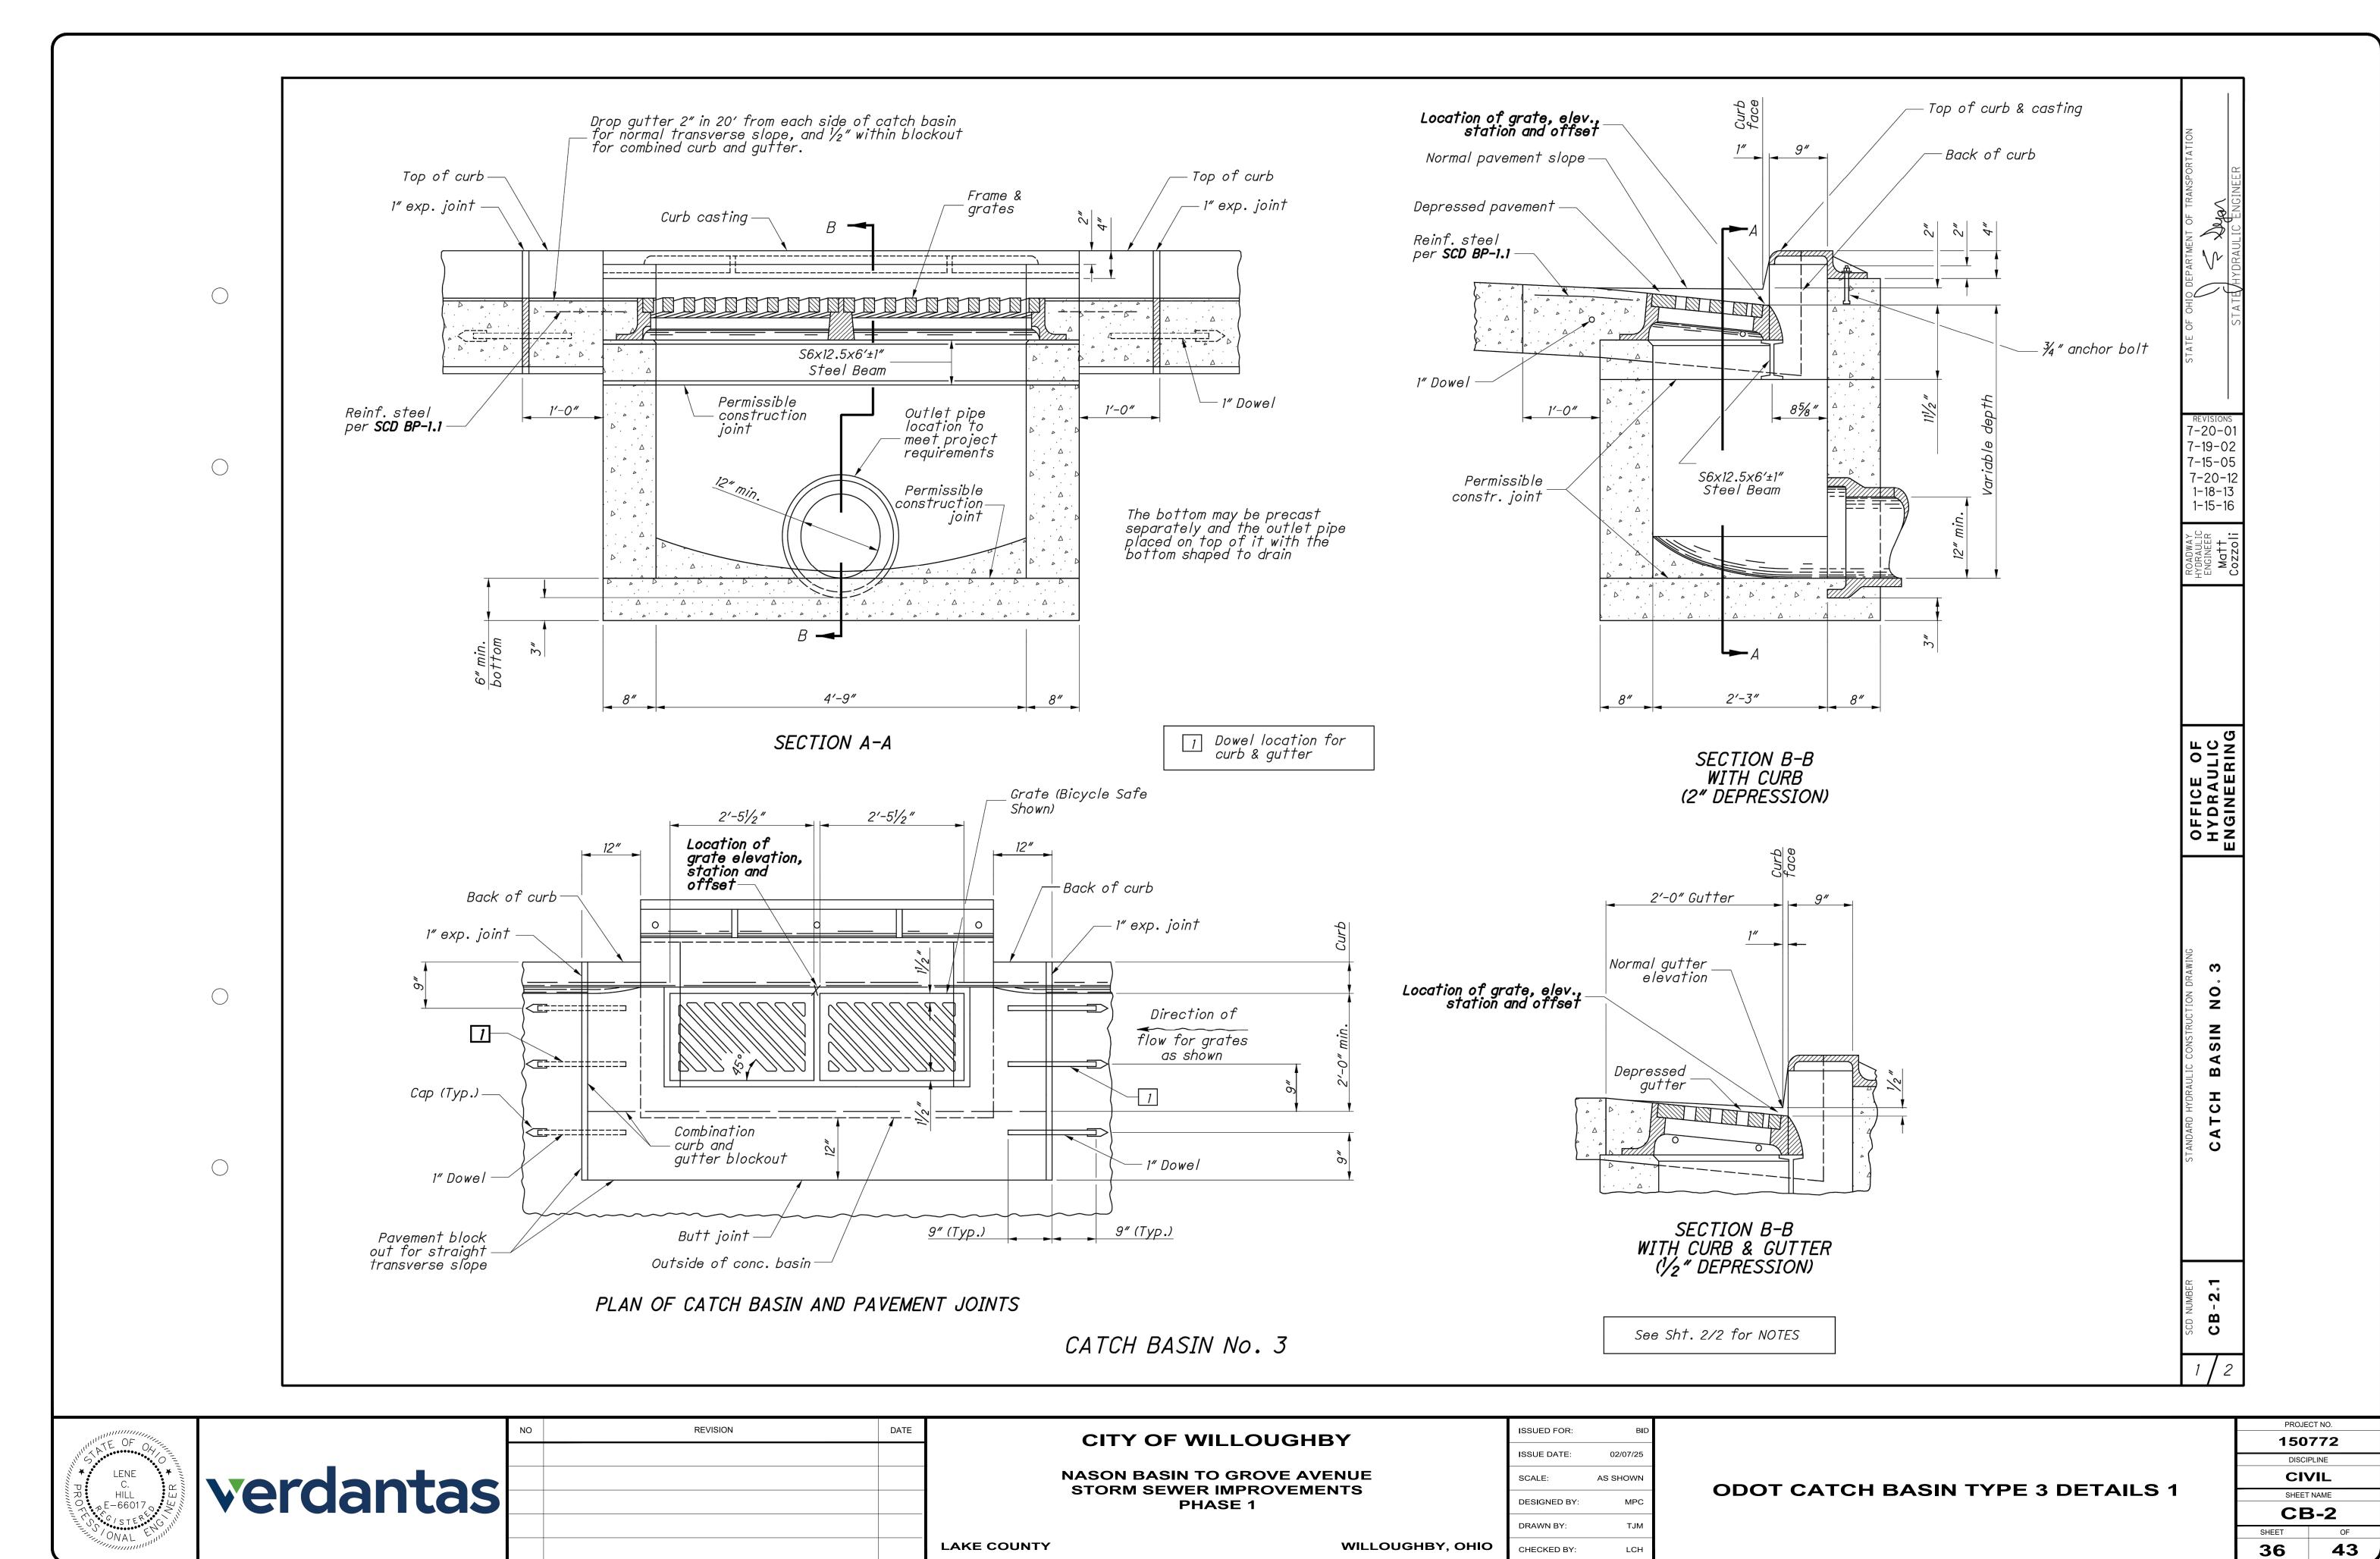
FIG 2.12.1

PAVEMENT MARKING DETAIL

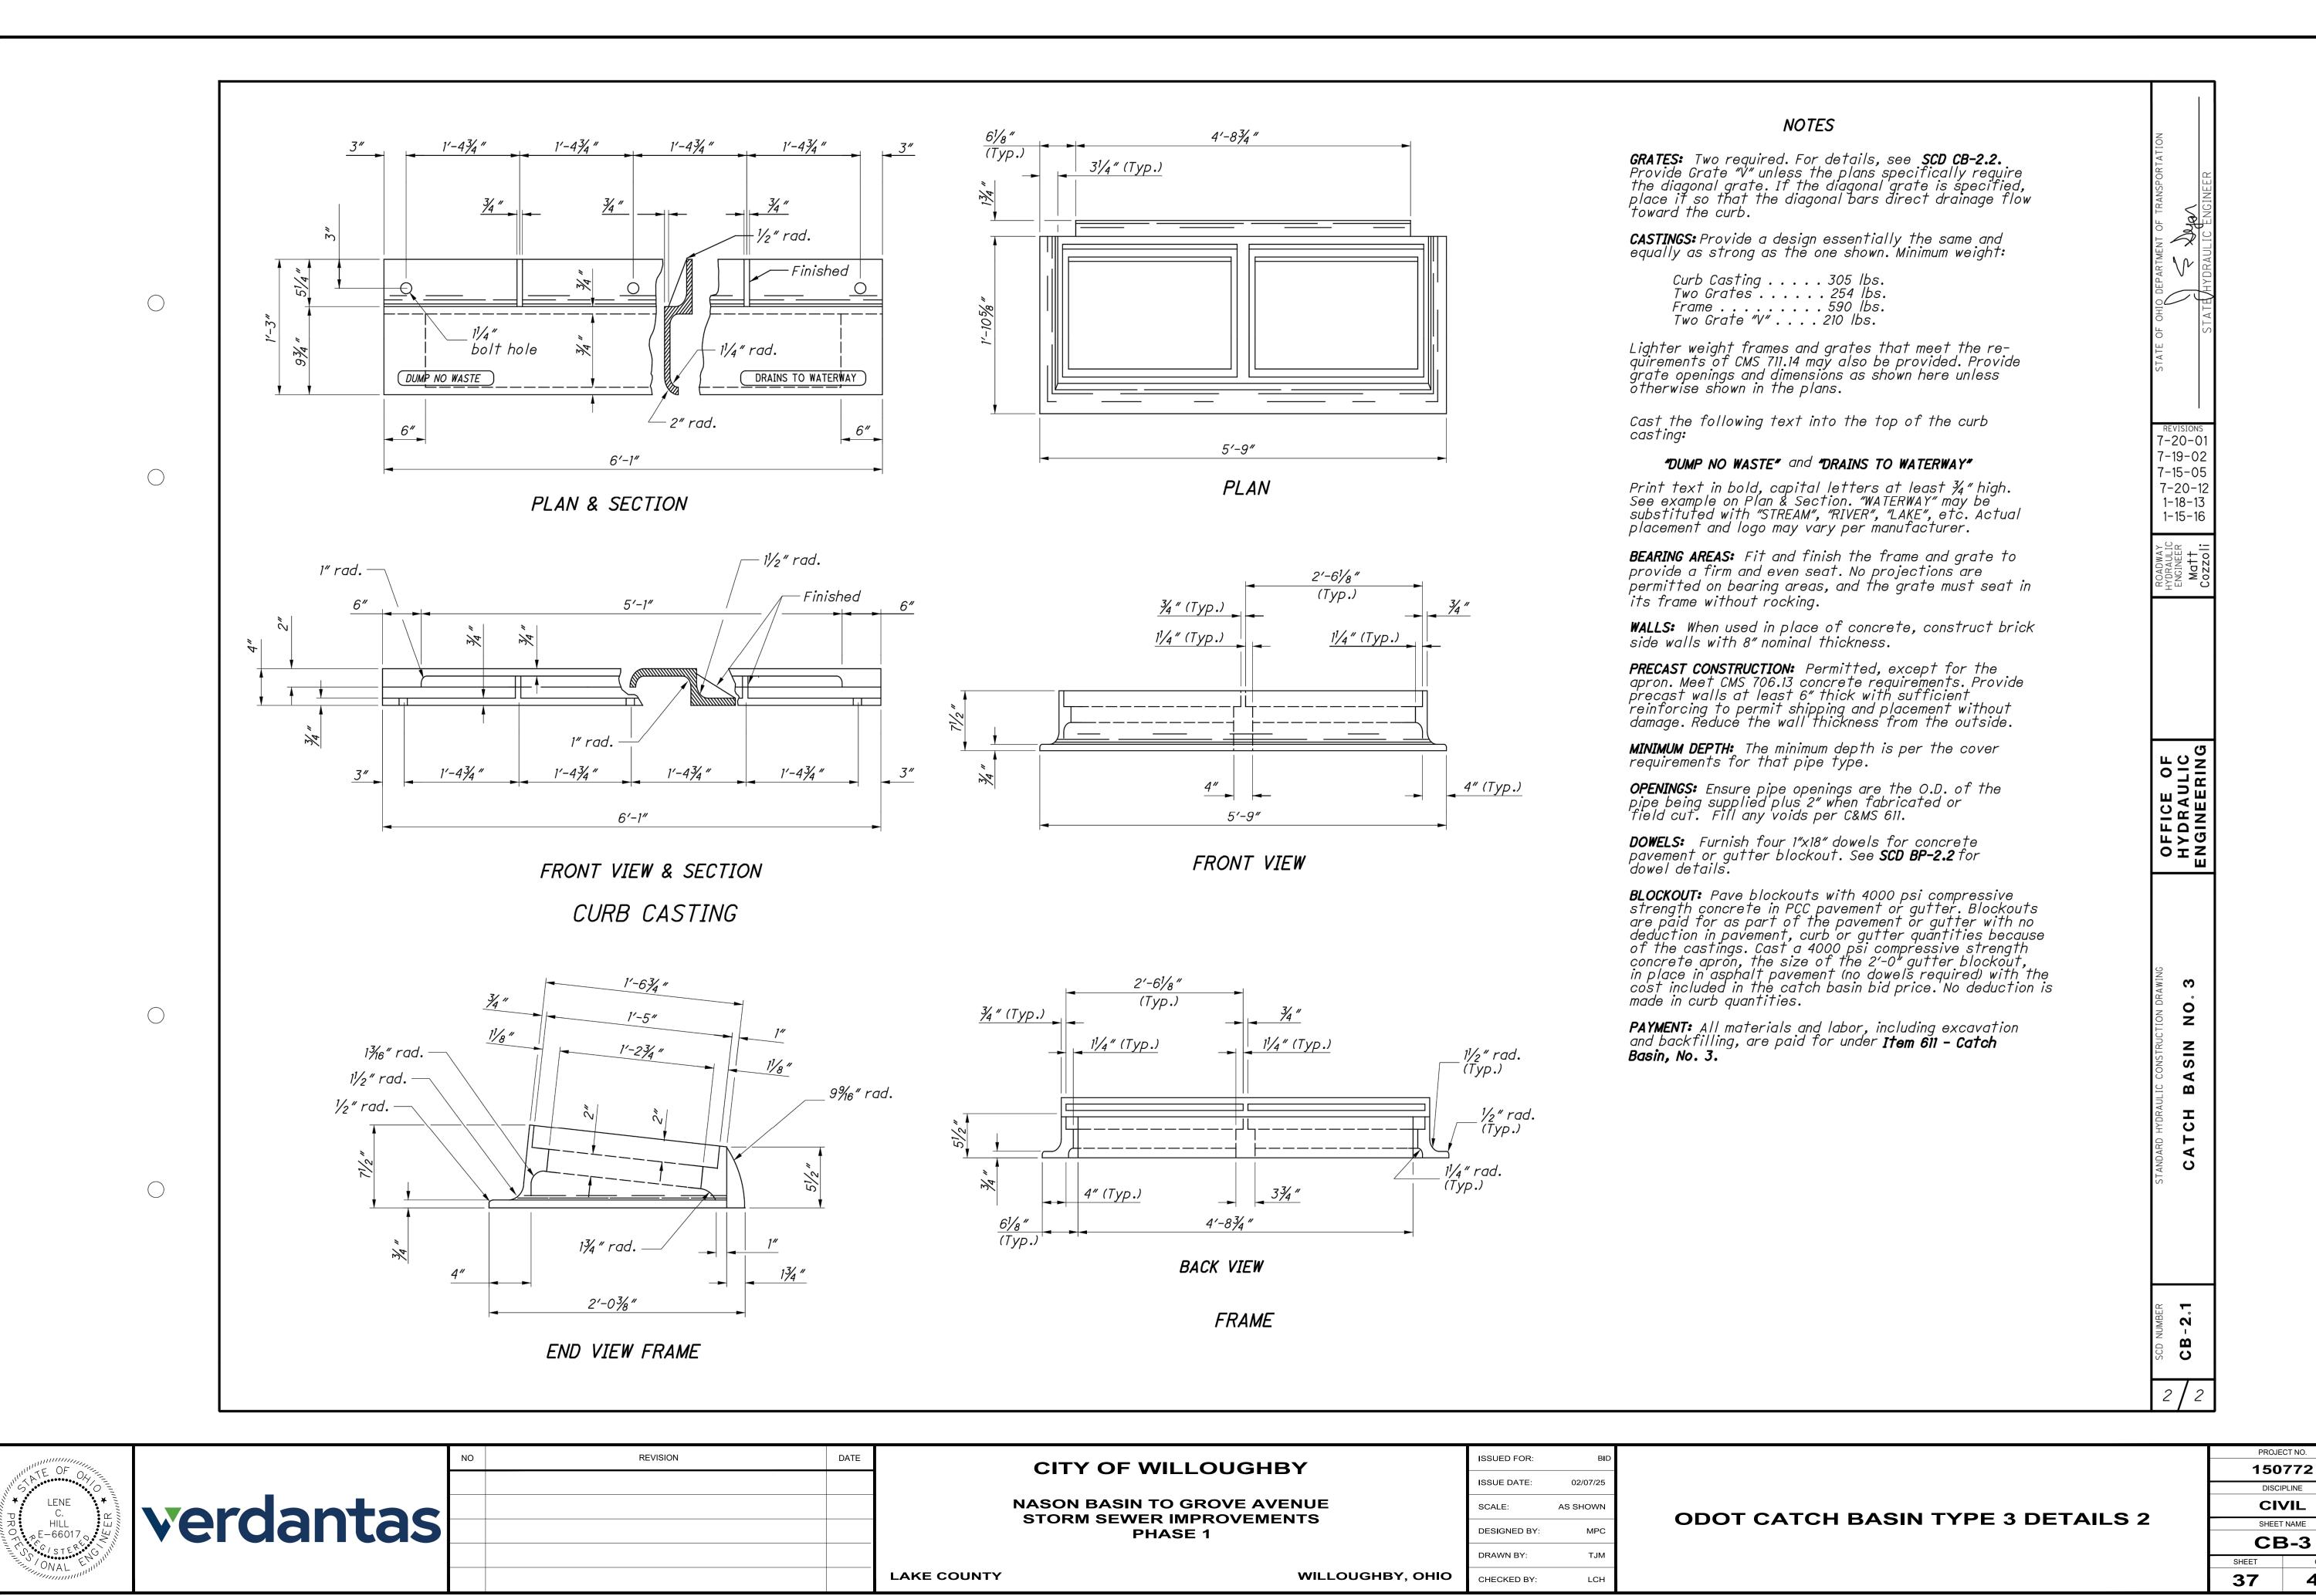
SCALE: NONE



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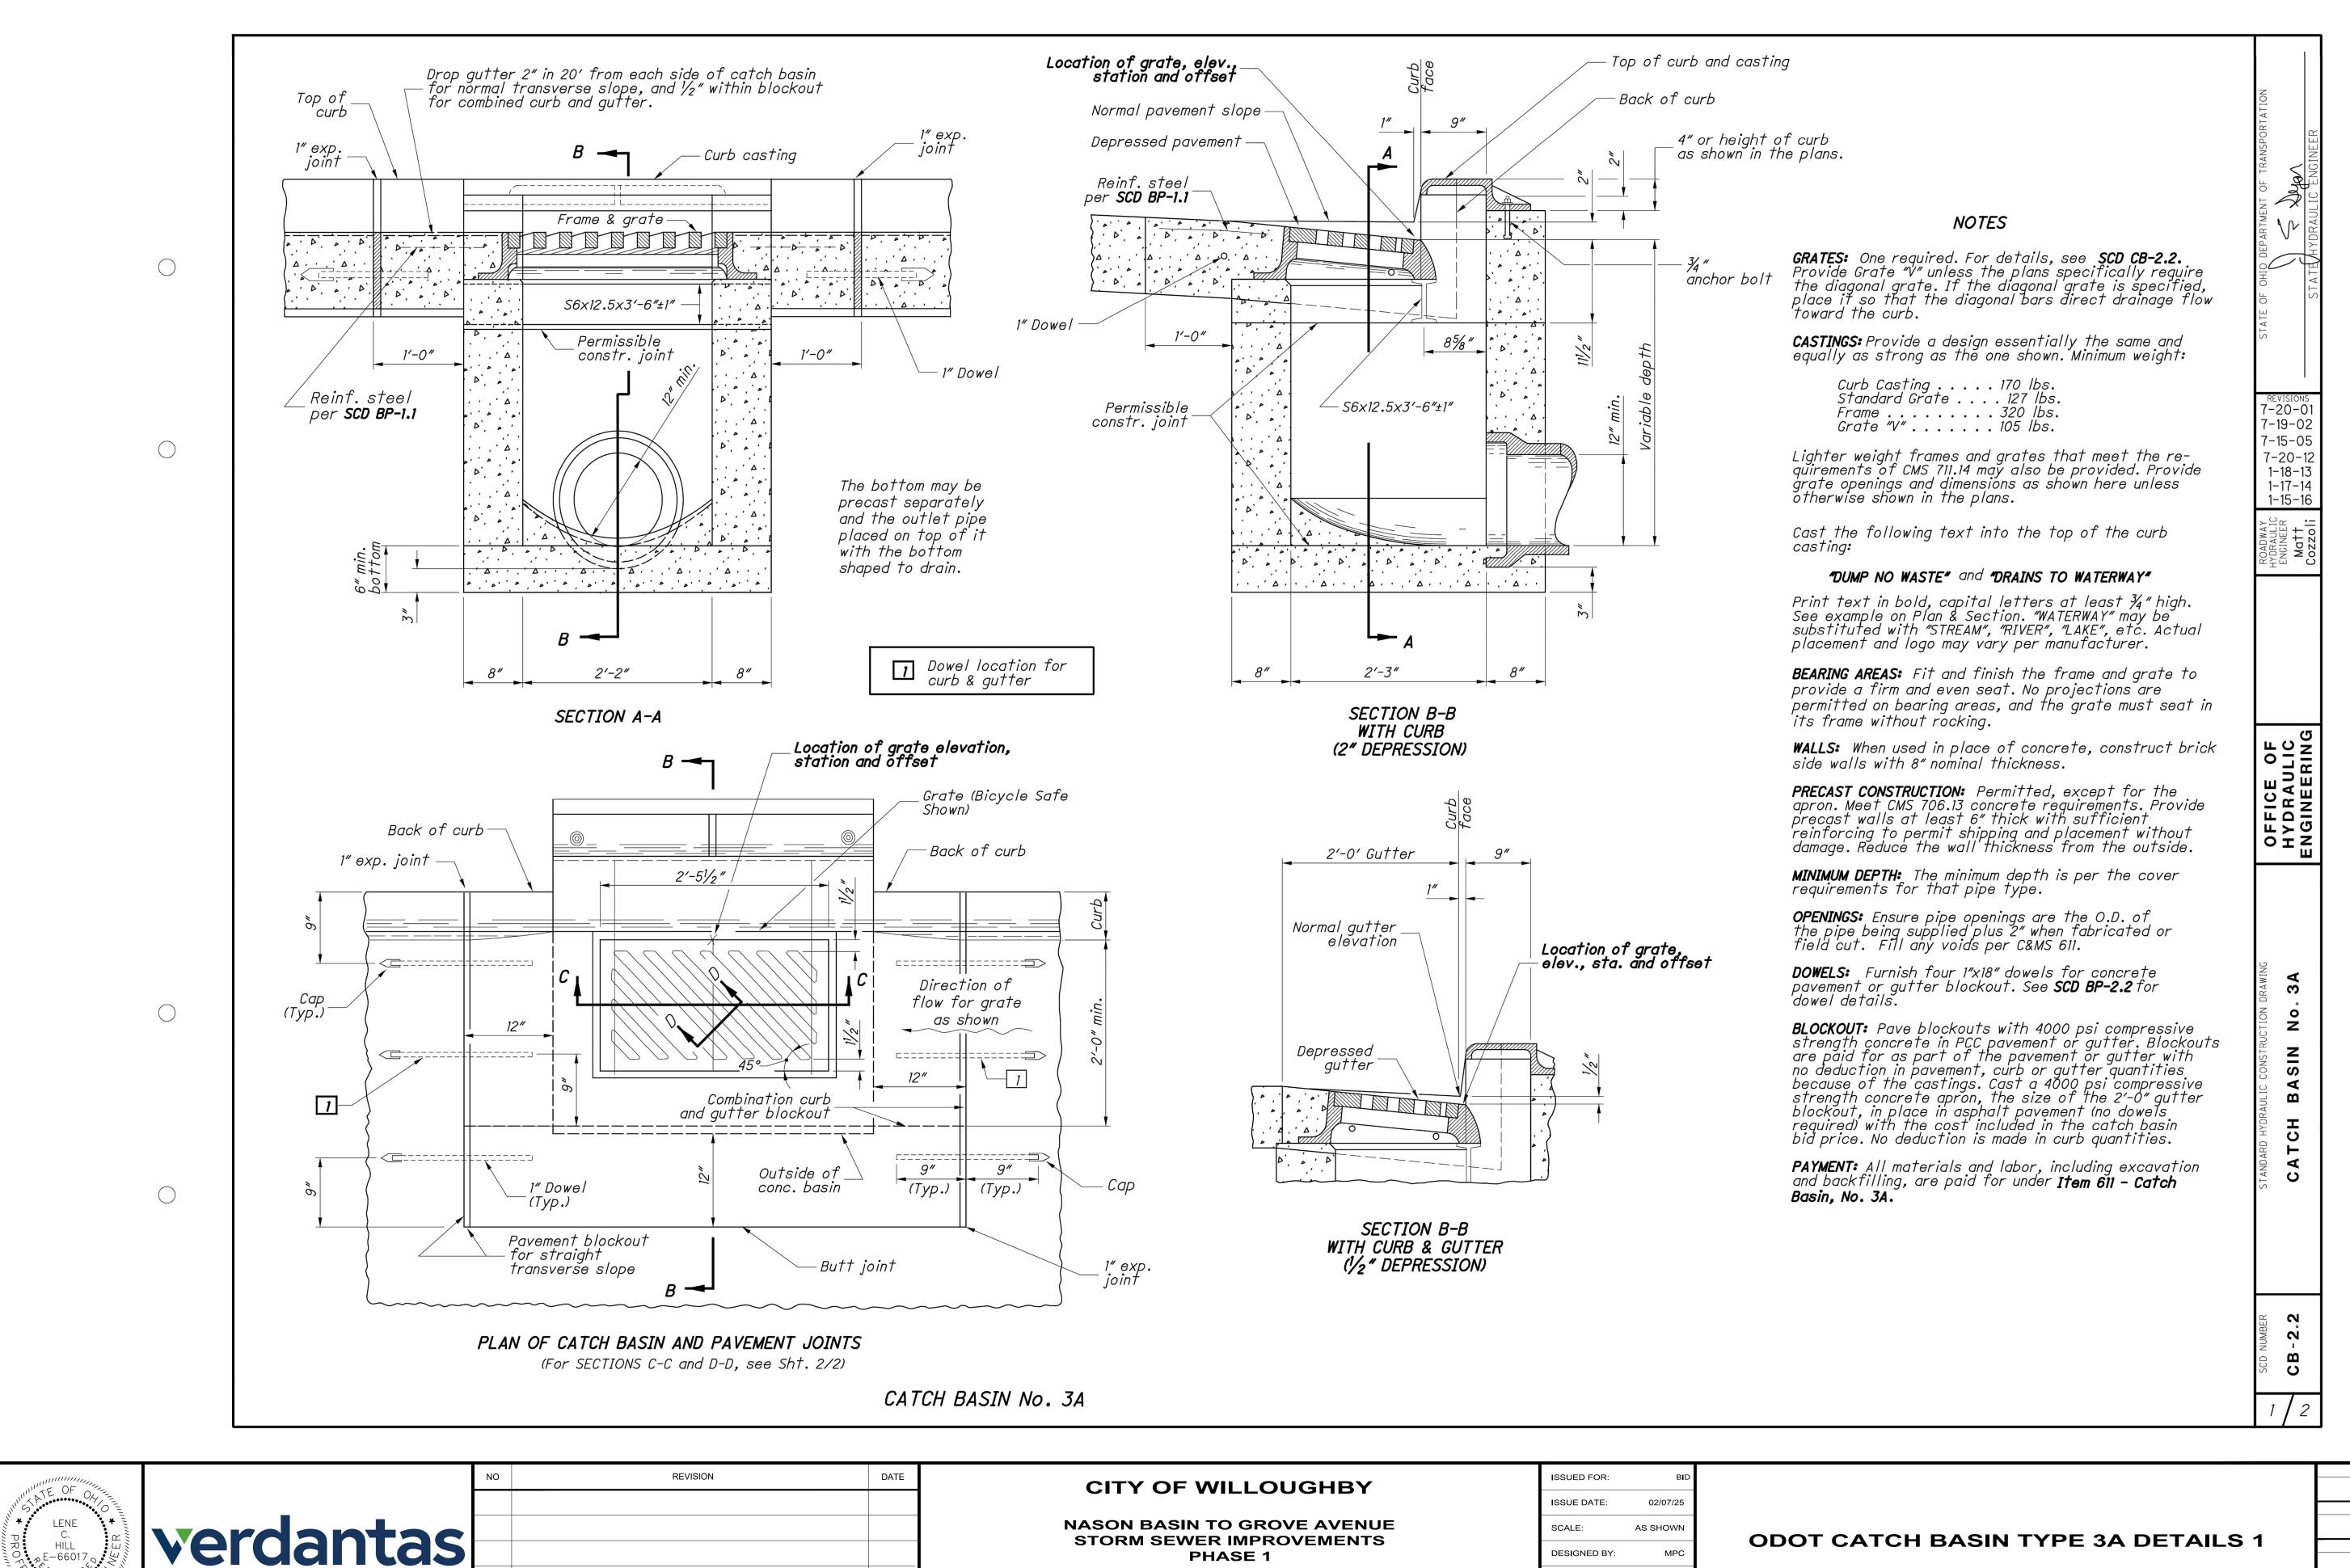


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STORM SEWER IMPROVEMENTS PHASE 1

LAKE COUNTY

NUE NTS	SCALE:
V13	DESIGNED BY:
	DRAWN BY:
WILLOUGHBY, OHIO	CHECKED BY:

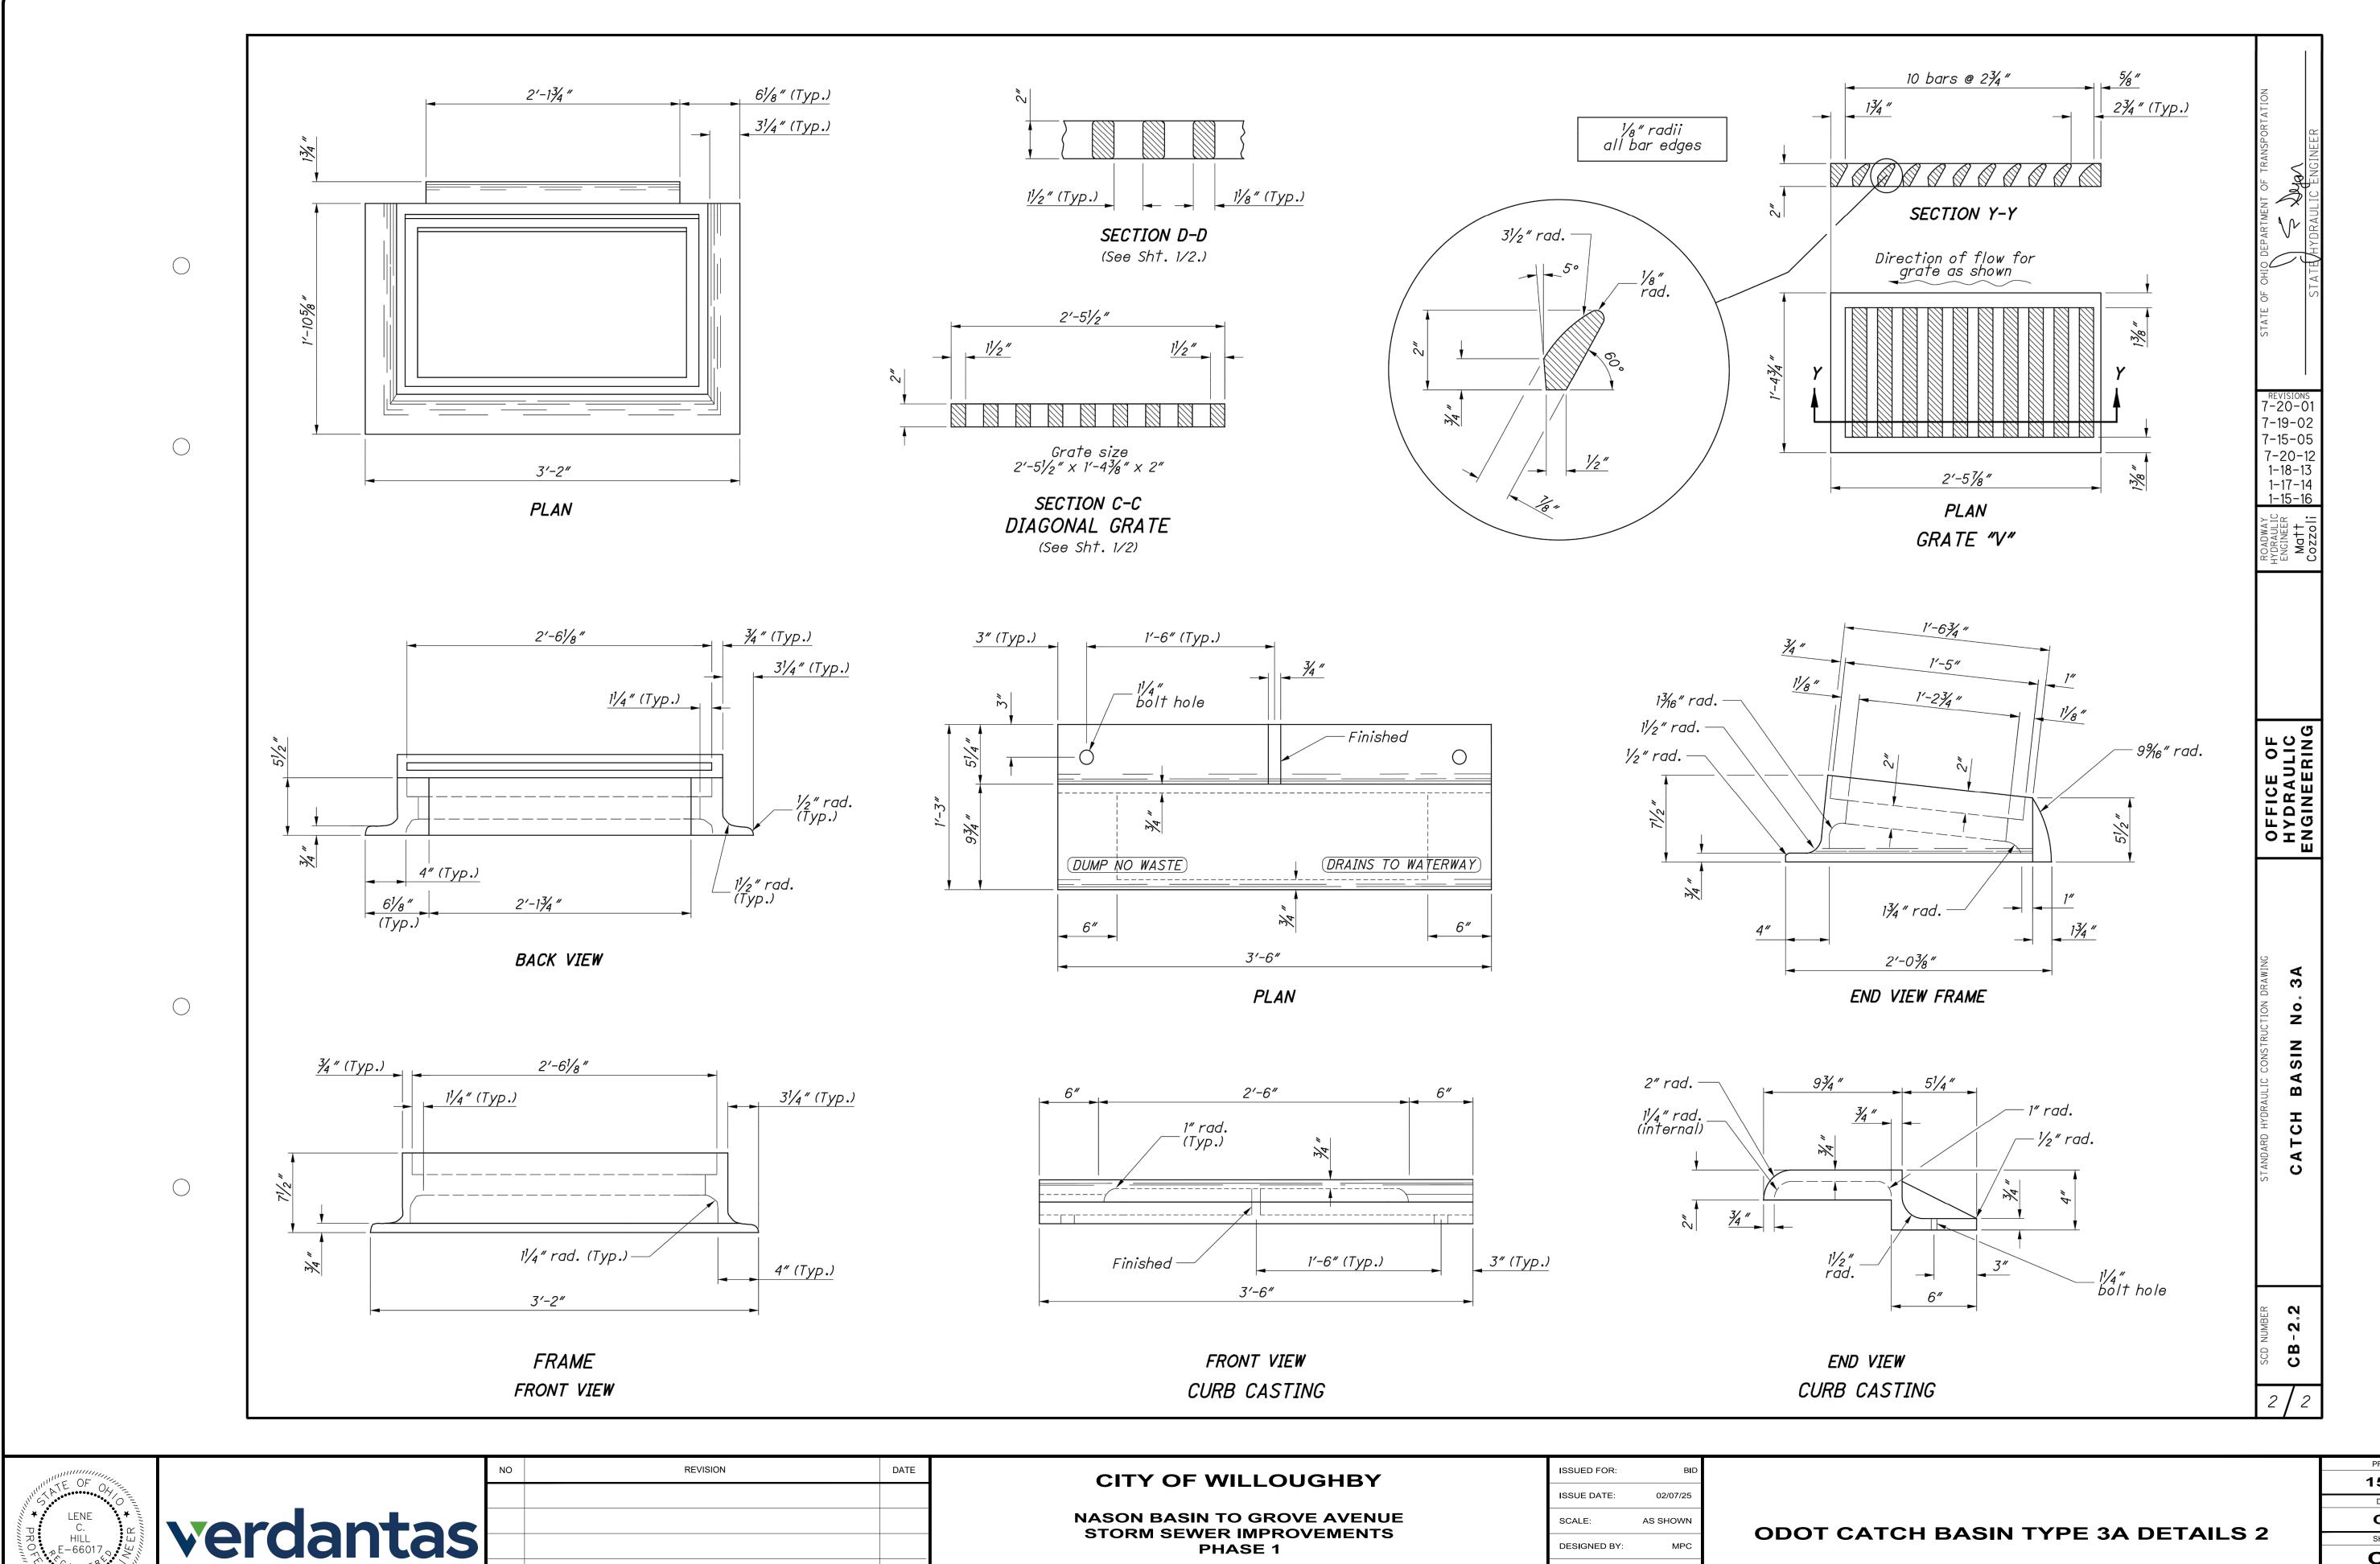
MPC

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PROJECT NO. 150772 DISCIPLINE CIVIL SHEET NAME CB-4 43 38

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LAKE COUNTY

	DESIGNED BY:
	DRAWN BY:
WILLOUGHBY, OHIO	CHECKED BY:

39	43	
SHEET	OF	
CE	3-5	
SHEET NAME		
CIVIL		
DISCIPLINE		
150	772	
PROJECT NO.		

GENERAL NOTES

- 1. THIS SWP3 HAS BEEN PREPARED SHOWING THE ITEMS LISTED BELOW, BUT THE CONTRACTOR MAY NEED TO MOVE OR ADD ITEMS AS CONSTRUCTION PROGRESSES OR DURING THE VARIOUS STAGES OF
 - LIMITS OF EARTH DISTURBING ACTIVITY
 - CONSTRUCTION ENTRANCE
 - EROSION AND SEDIMENT CONTROL MEASURES
- INLET PROTECTIONS
- CONCRETE WASHOUT PITS
- EQUIPMENT STAGING
- FUEL STORAGE AND VEHICLE FUELING AREA
- CONSTRUCTION TRAILER
- SANITATION FACILITY
- MATERIAL STOCKPILE LOCATION
- CHEMICAL COMPOUND MIXING AND STORAGE AREA
- ANY OTHER EROSION CONTROL REQUIRED
- 2. ALL WORK REQUIRED TO IMPLEMENT THE SWP3 INCLUDING INSPECTION FEES, MAINTENANCE AND REPAIRS SHALL BE DONE BY AND AT THE EXPENSE OF THE CONTRACTOR.
- 3. THE CONTRACTOR SHALL AMEND THE SWP3 WHEN THERE IS A CHANGE IN DESIGN, CONSTRUCTION, OPERATION OR MAINTENANCE THAT HAS A SIGNIFICANT POTENTIAL FOR DISCHARGE OF POLLUTANTS TO SURFACE WATERS OF THE STATE.
- 4. ADDITIONAL OR DIFFERENT BMPS MAY BE NEEDED AS CONSTRUCTION PROGRESSES OR REQUIRED BY THE OWNER, SWCD, MS4 OR OHIO EPA.
- 5. NO CONDITION OF THE SWP3 OR NPDES PERMIT SHALL RELEASE THE CONTRACTOR OF THEIR RESPONSIBILITY OR REQUIREMENTS UNDER ANY OTHER ENVIRONMENTAL STATUE OR REGULATION.

ADMINISTRATIVE NOTES

- 1. AN OHIO EPA NPDES PERMIT IS REQUIRED WHERE CONSTRUCTION ACTIVITIES (I.E. CLEARING, GRUBBING, GRADING, EXCAVATING, FILLING AND/OR TRENCH DEWATERING) AND/OR SUPPORT ACTIVITIES (I.E. CONCRETE OR ASPHALT BATCH PLANT, EQUIPMENT STAGING YARD, MATERIAL STORAGE AREA, AND ON-SITE OR OFF-SITE BORROW AREA OR SOIL DISPOSAL AREA) DISTURB 1 OR MORE ACRES OF LAND, OR SMALLER SITES LESS THAN 1 ACRE THAT ARE PART OF A LARGER COMMON DEVELOPMENT. DISTURBED LAND IS LAND IN WHICH SOILS ARE EXPOSED TO STORM WATER.
- 2. A NOI IS REQUIRED FOR THIS PROJECT AND MUST BE FILED WITH THE OHIO EPA AT LEAST 21 DAYS PRIOR TO THE START OF CONSTRUCTION BECAUSE THE TOTAL LAND DISTURBANCE IS GREATER THAN 1 ACRE. THE CONTRACTOR SHALL FOLLOW THE PRACTICES AND REQUIREMENTS PROVIDED IN THE OHIO EPA NPDES CONSTRUCTION SITE STORMWATER GENERAL PERMIT OHC000006 AND THE ODNR RAINWATER AND LAND DEVELOPMENT MANUAL, AND BE RESPONSIBLE FOR ALL NPDES TERMS AND CONDITIONS UNTIL A NOT IS FILED.
- 3. NO CONSTRUCTION ACTIVITIES MAY BEGIN UNTIL ALL OF THE FOLLOWING OCCUR:
 - OHIO EPA NPDES AUTHORIZATION LETTER RECEIVED.
 - THE CONTRACTOR FILES A CO-PERMITTEE APPLICATION TO THE
 ONLY FRA
 - THE CONTRACTOR ATTENDS A PRE-CONSTRUCTION MEETING WITH THE SWCD TO DISCUSS OHIO EPA NPDES PERMIT REQUIREMENTS.
- OHIO EPA APPLICATION FORMS (I.E. NOI, NOT, CO-PERMITTEE NOI/NOT, INDIVIDUAL LOT NOI/NOT AND PERMIT TRANSFER) ARE ONLY ACCESSIBLE ELECTRONICALLY VIA THE OHIO EPA STREAMS APPLICATION SUBMITTAL SYSTEM USING AN INDIVIDUAL EBUSINESS CENTER ACCOUNT. VISIT THE OHIO EPA'S ELECTRONIC BUSINESS SERVICES WEBSITE (HTTPS://EBIZ.EPA.OHIO.GOV/) FOR MORE INFORMATION, GUIDANCE AND REPORTING QUESTIONS.
- THE CONTRACTOR SHALL SELECT QUALIFIED INSPECTION PERSONNEL KNOWLEDGEABLE IN THE PRINCIPLES AND PRACTICES OF EROSION AND SEDIMENT CONTROLS FOR INSPECTIONS, MAINTENANCE, REPAIRS, AND COMPLETING INSPECTION AND MAINTENANCE REPORTS. THE CONTRACTOR SHALL COMPLETE A "DELEGATION OF AUTHORITY FOR STORMWATER POLLUTION PREVENTION PLAN".
- ALL PROCEDURES AND REQUIREMENTS CONTAINED IN THE SWP3
 APPLY TO ALL GENERAL AND SUBCONTRACTORS. THE CONTRACTOR
 SHALL IMPLEMENT, INFORM, REQUIRE AND ENFORCE ALL ASPECTS AND
 PROCEDURES OF THE SWP3. THE CONTRACTOR SHALL HAVE ALL
 SUBCONTRACTORS THAT ARE OR MAY BE ENGAGED IN ACTIVITIES
 THAT COULD IMPACT STORMWATER COMPLETE A "SUBCONTRACTOR
 AGREEMENT FOR EROSION AND SEDIMENT CONTROL" TO
 ACKNOWLEDGE THEY REVIEWED AND UNDERSTOOD THE SWP3.
- 8. ALL NPDES PERMITS, NOI, SWP3, INSPECTION LOGS, REPORTS AND CERTIFICATIONS MUST BE SIGNED, KEPT ON-SITE AND IMMEDIATELY AVAILABLE UPON REQUEST BY THE OWNER, SWCD, MS4 OR OHIO EPA.
- 9. EROSION AND SEDIMENT CONTROL WORK SHALL BE SUBJECT TO INSPECTION BY THE OWNER, SWCD, MS4 AND OHIO EPA.

EROSION & SEDIMENT CONTROL NOTES

- SPECIAL MEASURES SHALL BE TAKEN TO STABILIZE DRAINAGE CHANNELS AND STORM WATER OUTFALLS.
- PHASE CONSTRUCTION ACTIVITIES TO MINIMIZE LAND DISTURBED AT ANY ONE TIME AND LEAVE EXISTING VEGETATION IN PLACE AS LONG AS POSSIBLE.
- STORMWATER DIVERSION PRACTICES SHALL BE USED TO KEEP SURFACE RUNOFF AWAY FROM DISTURBED AREAS AND STEEP SLOPES WHERE PRACTICABLE.
- 4. STABILIZATION OF DISTURBED AREAS SHALL, AT A MINIMUM, BE INITIATED WITHIN THE TIME FRAMES IN THE FOLLOWING TABLES:

PERMANENT STABILIZATION

AREA REQUIRING PERMANENT STABILIZATION	TIME FRAME TO APPLY EROSION CONTROLS
ANY AREAS TO LIE DORMANT FOR 1 YEAR OR MORE.	WITHIN 7 DAYS OF MOST RECENT DISTURBANCE.
ANY AREAS WITHIN 50 FEET OF A SURFACE WATER OF THE STATE (*) AND AT FINAL GRADE.	WITHIN 2 DAYS OF REACHING FINAL GRADE.
OTHER AREAS AT FINAL GRADE.	WITHIN 7 DAYS OF REACHING FINAL GRADE.

TEMPORARYS	STABILIZATION
AREA REQUIRING TEMPORARY STABILIZATION	TIME FRAME TO APPLY EROSION CONTROLS
ANY DISTURBED AREAS WITHIN 50 FEET OF A SURFACE WATER OF THE STATE (*) AND NOT AT FINAL GRADE.	WITHIN 2 DAYS OF MOST RECENT DISTURBANCE IF TO REMAIN IDLE MORE THAN 14 DAYS.
ANY DISTURBED AREAS TO BE DORMANT FOR MORE THAN 14 DAYS, BUT LESS THAN 1 YEAR, AND NOT WITHIN 50 FEET OF A SURFACE WATER OF THE STATE (*).	WITHIN 7 DAYS OF MOST RECENT DISTURBANCE. FOR RESIDENTIAL SUBDIVISION, DISTURBED AREAS MUST BE STABILIZED AT LEAST 7 DAYS PRIOR TO TRANSFER OF PERMIT COVERAGE FOR INDIVIDUAL LOT(S).
DISTURBED AREAS THAT WILL BE IDLE OVER WINTER.	PRIOR TO ONSET OF WINTER WEATHER.

(*) SURFACE WATERS OF THE STATE INCLUDE WETLANDS, STREAMS, LAKES, PONDS, MARSHES, WATERCOURSES, WELLS, SPRINGS, IRRIGATION SYSTEMS, DRAINAGE SYSTEMS, AND OTHER ACCUMULATIONS OF WATER, SURFACE AND UNDERGROUND, NATURAL OR ARTIFICIAL.

- 5. INLET PROTECTION AND SEDIMENT CONTROLS MUST BE INSTALLED PRIOR TO CLEARING AND GRUBBING.
- 6. SEDIMENT PONDS, TEMPORARILY MODIFIED PERMANENT PONDS AND PERIMETER SEDIMENT BARRIERS MUST BE INSTALLED AS THE FIRST STEP OF GRADING AND WITHIN 7 DAYS FROM THE START OF CLEARING AND GRUBBING, AND CONTINUE TO FUNCTION UNTIL ALL DISTURBED UPLAND AREAS ARE STABILIZED.
- 7. SEDIMENT CONTROLS MUST POND RUNOFF TO BE CONSIDERED
- SEDIMENT-LADEN TRENCH OR GROUND WATER MUST PASS THROUGH A SEDIMENT-SETTLING POND OR BE DEWATERED IN-PLACE USING A SUMP PIT, FILTER BAG OR OTHER COMPARABLE METHOD PRIOR TO DISCHARGE FROM THE SITE. TRENCH AND GROUND WATER FREE FROM SEDIMENT OR OTHER POLLUTANTS MAY BE DISCHARGED WITHOUT TREATMENT, PROVIDED THIS WATER DOES NOT BECOME POLLUTANT-LADEN BY TRAVERSING OVER DISTURBED SOILS OR OTHER POLLUTANT SOURCES.
- SEDIMENT BARRIERS SHALL NOT EXCEED THEIR DESIGN CAPACITIES.
 INSTALLING SEDIMENT BARRIERS IN PARALLEL SERIES DOES NOT INCREASE THE DESIGN CAPACITY.
- 10. SETTLED MATERIAL SHALL BE DISPOSED IN A LOCATION WHERE IT WILL
- NOT BE CARRIED OFF-SITE OR INTO A STORM SEWER BY RAINFALL.

 11. SOIL STOCKPILES SHALL BE RINGED WITH SILT FENCE ALONG THE BOTTOM FOOTPRINT. IF THE STOCKPILE WILL BE INACTIVE FOR 14 DAYS OR MORE, THE SURFACE SHALL BE SEEDED OR STABILIZED WITHIN 7 DAYS OF LAST DISTURBANCE.

GOOD HOUSEKEEPING AND OTHER WASTE CONTROL NOTES

1. MATERIALS OR SUBSTANCES LISTED BELOW ARE ANTICIPATED TO BE PRESENT ON-SITE DURING CONSTRUCTION:

(X) CONCRETE (X) FERTILIZER () CLEANING SOLVENT

() ASPHALT () TAR () DETERGENT

() CMU BLOCK () PAINT () PETROLEUM BASED PRODUCT
2. STORE ONLY ENOUGH PRODUCT REQUIRED TO DO THE JOB. ALL

- MATERIALS STORED ON-SITE SHALL BE STORED IN AN ORDERLY
 MANNER IN APPROPRIATE CONTAINERS AND, IF POSSIBLE, UNDER A
 ROOF OR OTHER ENCLOSURE.
- PRODUCTS SHALL BE KEPT IN ORIGINAL CONTAINERS WITH THE ORIGINAL MANUFACTURER LABEL UNLESS NOT RESEALABLE. PETROLEUM PRODUCTS SHALL BE STORED IN TIGHTLY SEALED CONTAINERS AND CLEARLY LABELED.
- 4. ALL OF A PRODUCT SHALL BE USED BEFORE DISPOSING OF THE CONTAINER WHENEVER POSSIBLE. DO NOT MIX PRODUCTS WITH ONE ANOTHER UNLESS RECOMMENDED BY THE MANUFACTURER.
- DAILY INSPECTION SHALL OCCUR TO ENSURE PROPER USE AND DISPOSAL OF MATERIALS.
- 6. SAFETY DATA SHEETS (SDS) SHALL BE KEPT ON-SITE.
- 7. SPILL CONTROL PRACTICES:
 - A. MANUFACTURER RECOMMENDED METHODS FOR SPILL CLEANUP MUST BE POSTED AND SITE PERSONNEL MADE AWARE OF THE PROCEDURES, LOCATION OF THE INFORMATION AND LOCATION OF CLEANUP SUPPLIES.
 - B. SPILL CLEANUP SUPPLIES (I.E. DUST PANS, BROOMS, MOPS, RAGS, GLOVES, GOGGLES, TRASH CONTAINERS, ETC.) AND MATERIALS (I.E. SAWDUST, KITTY LITTER, SAND, ABSORBENT MATERIAL, ETC.) SHALL BE KEPT IN AN ON-SITE MATERIAL STORAGE AREA.
 - C. SPILLS SHALL BE CLEANED IMMEDIATELY AFTER DISCOVERY AND PERSONNEL SHALL WEAR APPROPRIATE PROTECTIVE CLOTHING. SMALL PETROLEUM PRODUCT SPILLS (LESS THAN 25 GALLONS) SHALL BE CLEANED PER MANUFACTURER RECOMMENDED METHODS AND DISPOSED WITH THE TRASH. LARGE PETROLEUM PRODUCT SPILLS (25 OR MORE GALLONS) OR ANY TOXIC OR HAZARDOUS MATERIAL SPILL, REGARDLESS OF SIZE, MUST BE REPORTED TO THE APPROPRIATE FEDERAL GOVERNMENT AGENCY, OHIO EPA SPILL HOTLINE (800-282-9378), LOCAL FIRE DEPARTMENT AND LOCAL EMERGENCY PLANNING COMMITTEE (LEPC) WITHIN 30 MINUTES OF THE SPILL. SPILLS THAT RESULT IN CONTACT WITH WATERS OF THE STATE, REGARDLESS OF SIZE OR TYPE, MUST BE REPORTED TO THE OHIO EPA SPILL HOTLINE.
 - D. ON-SITE VEHICLES SHALL BE MONITORED FOR LEAKS AND RECEIVE REGULAR PREVENTIVE MAINTENANCE TO REDUCE THE CHANCE OF LEAKAGE
- 8. IT IS PROHIBITED TO BURN, BURY OR POUR ONTO THE GROUND OR INTO STORM INLETS OR SURFACE WATERS OF THE STATE ANY LIQUID OR SOLID WASTE (I.E. CONSTRUCTION AND DEMOLITION DEBRIS (C&DD), TRASH, BUILDING MATERIALS, SOLVENTS, PAINTS, FUELS, MOTOR OIL, ANTIFREEZE, HYDRAULIC FLUIDS, CURING COMPOUNDS, FORM RELEASE OILS, OTHER TOXIC OR HAZARDOUS WASTE, ETC.).
- 9. TRASH AND C&DD SHALL BE COLLECTED IN A SECURELY LIDDED AND LEAK-PROOF DUMPSTER, HAULED OFF-SITE AND EMPTIED AS NECESSARY, IN AN OHIO EPA APPROVED LANDFILL. ALL OTHER WASTE SHALL BE DISPOSED IN ACCORDANCE WITH FEDERAL, STATE AND LOCAL REGULATIONS OR AS SPECIFIED BY THE MANUFACTURER.
- 10. CONTAMINATED SOILS MUST BE TREATED AND/OR DISPOSED IN AN OHIO EPA APPROVED SOLID WASTE MANAGEMENT FACILITY OR HAZARDOUS WASTE TREATMENT, STORAGE OR DISPOSAL FACILITY. THE FOLLOWING PRACTICES SHALL BE USED AS APPROPRIATE TO PREVENT CONTAMINATION FROM SPREADING:
 - A. BERMS, TRENCHES AND PITS TO COLLECT CONTAMINATED RUNOFF.
 - B. RUNOFF PUMPED INTO A CONTAINER FOR TRANSPORT TO A
 - C. CONTAMINATED AREA COVERED WITH TARPS OR OTHER METHODS THAT PREVENT STORM WATER CONTACT.
- 11. FUEL STORAGE TANKS SHALL BE STORED IN DIKED AREAS WITH A VOLUME OF AT LEAST 110% OF THE LARGEST TANK. A DIKED AREA IS NOT NECESSARY IF A SELF-CONTAINED SPILL PROOF TANK IS USED. AREAS USED FOR FUEL STORAGE TANK STORAGE, FUELING OR VEHICLE MAINTENANCE SHALL NOT BE LOCATED NEAR STORM INLETS, WATERCOURSES OR SURFACE WATERS OF THE STATE.
- 12. APPLY FERTILIZER ONLY IN THE MINIMUM AMOUNTS RECOMMENDED BY THE MANUFACTURER. ONCE APPLIED, FERTILIZER SHALL BE WORKED INTO THE SOIL TO LIMIT EXPOSURE TO STORM WATER. CONTENTS OF PARTIALLY USED BAGS OF FERTILIZER SHALL BE TRANSFERRED TO A SEALABLE PLASTIC BIN TO AVOID SPILLS.
- 3. CONCRETE TRUCKS ARE PROHIBITED TO WASH OUT OR DISCHARGE SURPLUS CONCRETE OR DRUM WASH WATER ONTO THE GROUND OR INTO STORM INLETS OR SURFACE WATERS OF THE STATE. ALL EXCESS CONCRETE AND WASHOUT, INCLUDING FROM HAND MIXERS AND LIGHT EQUIPMENT, MUST BE DISPOSED IN A CONCRETE WASHOUT AREA.
- 14. TEMPORARY SANITARY FACILITIES SHALL BE PROVIDED ON-SITE, SERVICED BY A LICENSED SANITARY WASTE MANAGEMENT CONTRACTOR, AND COLLECTED AT LEAST ONCE PER WEEK.

LAKE COUNTY

15. OFF-SITE VEHICLE TRACKING OF SEDIMENT AND DUST SHALL BE MINIMIZED. ADJACENT OFF-SITE PAVED STREETS SHALL BE SWEPT DAILY, OR MORE OFTEN AS NECESSARY, TO REMOVE MUD, DIRT OR ROCK TRACKED FROM THE SITE. DUST CONTROL SHALL BE PROVIDED WITH WATER OR CALCIUM CHLORIDE DUST PALLIATIVE AS NECESSARY. USED OIL MAY NOT BE USED. DUMP TRUCKS HAULING MATERIAL OFF-SITE MUST BE COVERED WITH A TARPAULIN.

PROJECT INFORMATION

CONSTRUCTION ACTIVITIES LOCATED AT:

WILLOUGHBY, LAKE COUNTY, OHIO 44094

LATITUDE: 41.644957°N LONGITUDE: -81.423295°W

EATHOBE. 41.044007 N

SWP3 PREPARED FOR:

CITY OF WILLOUGHBY

1 PUBLIC SQUARE, WILLOUGHBY, OH 44094 CONTACT: RICH PALMISANO. SERVICE DIRECTOR

PHONE: (440) 953-4110

EMAIL: RPALMISANO@WILLOUGHBYOHIO.COM

SWP3 PREPARED:

VERDANTAS LLC

8150 STERLING COURT, MENTOR, OHIO 44060

CONTACT: LENE C. HILL, PE

PHONE: (440) 530-2212

EMAIL: LHILL@VERDANTAS.COM

GENERAL CONTRACTOR INFORMATION:

BUSINESS NAME

STREET ADDRESS

CITY STATE ZIP CODE

PERSON RESPONSIBLE FOR AMENDING SWP3:

NAME PHO

PHONE

(X) OFF-SITE SOIL DISPOSAL AREA

(X) LINEAR UTILITY

EMAIL

ESTIMATED PROJECT CONSTRUCTION START DATE: 04/01/2025
ESTIMATED PROJECT CONSTRUCTION COMPLETION DATE: 12/31/2025

TYPE OF CONSTRUCTION ACTIVITY:

(X) SOIL DISPOSAL AREA

() CLEARING () GRUBBING (X) GRADING
(X) EXCAVATING (X) FILLING (X) TRENCH DEWATERING

TYPE OF CONSTRUCTION SUPPORT ACTIVITY:

() ASPHALT BATCH PLANT (X) CONCRETE BATCH PLANT
(X) EQUIPMENT STAGING YARD (X) MATERIAL STORAGE AREA
(X) BORROW AREA (X) OFF-SITE BORROW AREA

TYPE OF PROJECT:

() RETAIL
() COMMUNITY
() MIXED USE
() OFFICE
() RECREATION
() SHOPPING MALL
() MEDICAL
() PUBLIC SAFETY
() RESTAURANT
() HIGHWAY
() EDUCATION
() APARTMENT
(X) ROAD
() INDUSTRIAL
() MANUFACTURING

DESCRIPTION OF PROJECT:

() LOW DENSITY RESIDENTIAL

() HIGH DENSITY RESIDENTIAL

INSTALLATION OF 2100 LF OF 84" STORM SEWER AND 200 LF OF 12" SANITARY SEWER, INCLUDING APPURTENANCES. CREATION OF AN ACCESS ROAD, REPLACEMENT OF 1230 CY OF CONCRETE PAVEMENT.

SOIL DISTURBING ACTIVITIES INCLUDE:
EROSION AND SEDIMENT CONTROL INSTALLATION; UTILITIES
INSTALLATION; EARTHWORK GRADING.

DESCRIPTION OF PRIOR AND EXISTING LAND USE: URBAN AREA

SITE AREA INFORMATION:

CONSTRUCTION LIMIT AREA = 2.0 AC.

TOTAL SOIL DISTURBANCE AREA = 1.5 AC.

INCREASE OR DECREASE IMPERVIOUS AREA = 0 %

PROJECT INFORMATION CONTINUED

NAME OF IMMEDIATE RECEIVING STREAM, SURFACE WATER OR MS4:

NASON BASIN TO CORPORATION CREEK TO THE CHAGRIN RIVER TO
LAKE ERIE.

DESCRIPTION OF ON-SITE STREAM(S) CONDITION:

() PRIOR CHANNELIZATION () BED INSTABILITY OR HEADCUTS
() NATURAL CHANNEL () PUBLIC MAINTENANCE CHANNEL

DESCRIPTION OF ON-SITE WETLANDS

THERE ARE NO WETLANDS ON-SITE.

DESCRIPTION OF ON-SITE CONTAMINATED SOILS

THERE IS NO KNOWN OR PROBABLY CONTAMINATED SOIL

LENE
C.
HILL
PROFTS CISTERE COMAL

verdantas

NO REVISION DATE

CITY OF WILLOUGHBY

NASON BASIN TO GROVE AVENUE STORM SEWER IMPROVEMENTS PHASE 1

WILLOUGHBY, OHIO CH

ISSUED FOR: BII

ISSUE DATE: 02/07/25

SCALE: AS SHOWN

DESIGNED BY: MPC

DRAWN BY: TJM

CHECKED BY: LCH

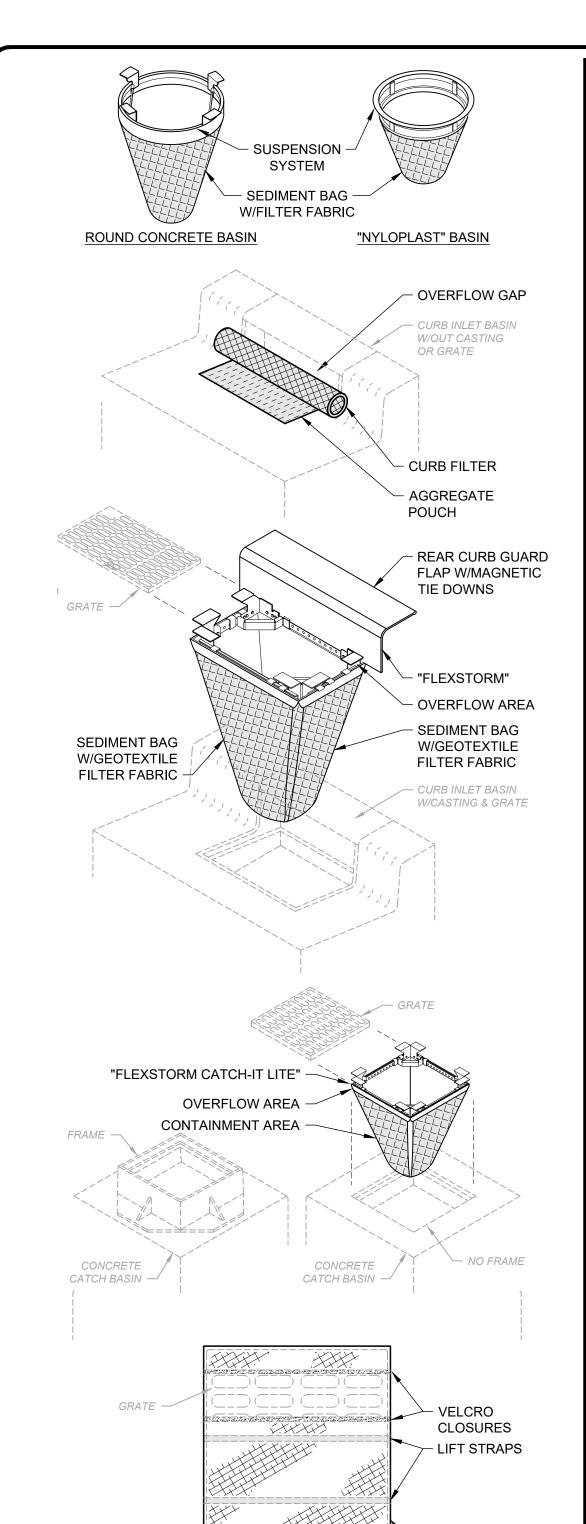
SWPPP NOTES

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PROJECT NO.

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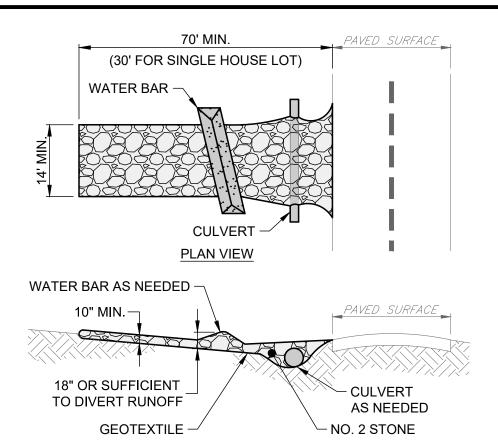


ALL NEW AND EXISTING STORM INLET BASINS WITHIN THE WORK LIMITS SHALL HAVE INLET PROTECTION INSTALLED.

CATCH BASIN -

- INLET PROTECTION SHALL BE INSTALLED AS EACH STORM INLET IS CONSTRUCTED.
- NOT ALL ITEMS SHOWN MAY APPLY OR DIFFERENT TYPES OR CONFIGURATIONS MAY BE REQUIRED. THE CONTRACTOR SHALL MEASURE EACH INLET TO CONFIGURE AND ASSEMBLE CUSTOMIZED

INLET PROTECTION DETAIL



GEOTEXTILE SHALL BE COMPOSED OF STRONG ROT-PROOF POLYMERIC FIBERS MEETING THE FOLLOWING:

PROFILE

TENSILE STRENGTH	200 LB
PUNCTURE STRENGTH	80 PSI
TEAR STRENGTH	50 LB
BURST STRENGTH	320 PSI
ELONGATION	20%
EQUIVALENT OPENING SIZE	< 0.6 MM
PERMITTIVITY	0.001 CM/SEC.

- INSTALL WATER BAR, AS NEEDED, TO PREVENT SURFACE RUNOFF FROM FLOWING OUT ONTO PAVEMENT.
- APPLY ADDITIONAL STONE AS CONDITIONS DEMAND, REPLENISH STONE WHEN THE DEPTH IS LESS THAN 6", AND REPLACE IF STONES BECOMES MUD-LADEN.
- IMMEDIATELY REMOVE MUD DROPPED, WASHED OR TRACKED ONTO ROADS OR ANY SURFACE WHERE RUNOFF IS NOT CHECKED BY SEDIMENT CONTROLS BY SCRAPING OR SWEEPING.
- CONSTRUCTION ENTRANCE SHALL NOT BE RELIED UPON TO REMOVE MUD FROM VEHICLES OR PREVENT OFF-SITE TRACKING. VEHICLES THAT ENTER AND LEAVE THE SITE SHALL BE RESTRICTED FROM MUDDY AREAS.
- CONSTRUCTION ENTRANCE SHALL REMAIN UNTIL THE DISTURBED AREA IS STABILIZED OR REPLACED WITH A PERMANENT ROADWAY.

CONSTRUCTION ENTRANCE DETAIL

SCALE: NONE - 4" TO 8"Ø STONE CHANNEL WIDTH SPLASH <u></u> — 3' МАХ. ┌─ 6" MIN. APRON ENTRENCH BASE 6" MIN.-**PROFILE CROSS SECTION**

"DANDY BAG"

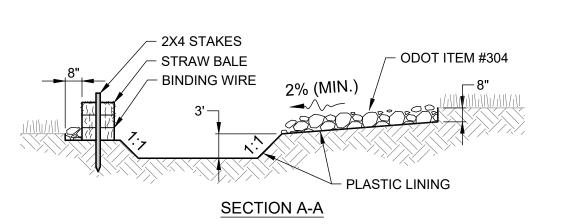
- STONE MUST COVER THE FULL CHANNEL WIDTH.
- ODOT TYPE 'D' STONE IS ACCEPTABLE, BUT MUST BE UNDERLAIN WITH NO. 3 OR 4 STONE OR FILTER FABRIC.
- THE MIDPOINT OF THE CHECK DAM SHALL BE A MINIMUM OF 6" LOWER THAN THE SIDES TO DIRECT WATER ACROSS THE CENTER AND AWAY FROM CHANNEL SIDES.
- SPACE CHECK DAMS SO TOE OF UPSTREAM DAM IS AT SAME ELEVATION AS TOP OF DOWNSTREAM DAM, OR AS FOLLOWS:

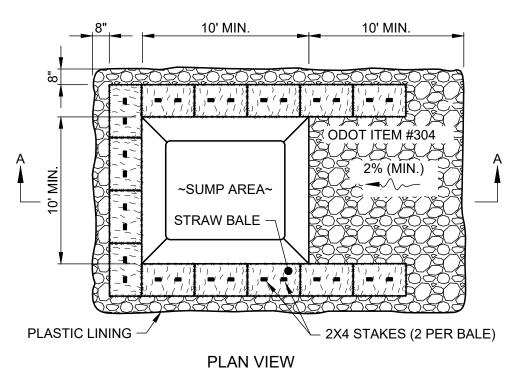
CHECK DAM	CHANNEL SLOPE			
HEIGHT	< 5%	5% - 10%	10% - 15%	15% - 20%
1 FT.	65 FT.	30 FT.	20 FT.	15 FT.
2 FT.	130 FT.	65 FT.	40 FT.	30 FT.
3 FT.	200 FT.	100 FT.	65 FT.	50 FT.

IF CHECK DAMS TO REMAIN IN USE FOR EXTENDED PERIOD OF TIME, INSTALL SPLASH APRON 6" MINIMUM THICK WITH LENGTH 2 TIMES CHECK DAM HEIGHT.

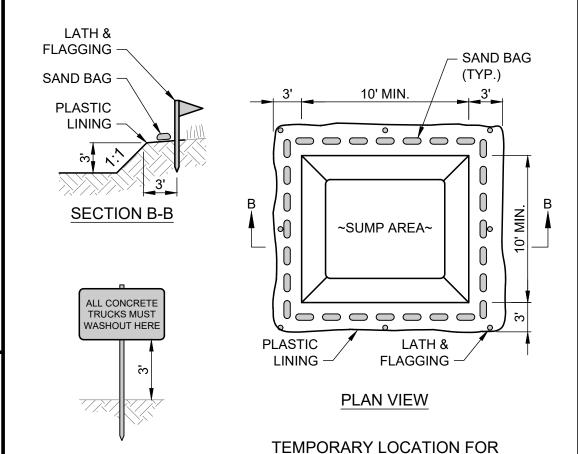
CHECK DAM DETAIL

SCALE: NONE





SINGLE LOCATION FOR SMALL PROJECT



NOTES:

WASHOUT SIGN

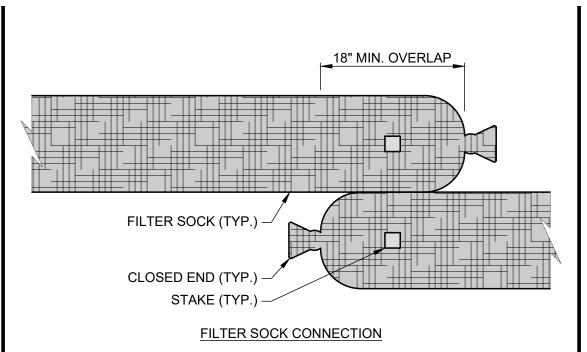
CONCRETE WASHOUT AREA SHALL BE LOCATED A MINIMUM OF 100' FROM STORM SEWER INLETS, STREAMS, WETLANDS OR ANY OTHER SURFACE WATERS OF THE STATE.

MULTIPLE PHASE OR LARGE PROJECT

- IF CONCRETE WASHOUT AREA IS LOCATED AWAY FROM A PAVED SURFACE, CONSTRUCT A GRAVEL ACCESS ROUTE EQUAL IN COMPOSITION TO A CONSTRUCTION ENTRANCE.
- CONCRETE WASHOUT AREA SHALL BE SUFFICIENT SIZE TO CONTAIN CONCRETE WASTE GENERATED. LARGE SITES MAY REQUIRE MULTIPLE CONCRETE WASHOUT AREAS.
- PLASTIC LINING SHALL BE DOUBLE-LINED, CONTINUOUS 10-ML POLYETHYLENE SHEETING FREE OF HOLES, TEARS OR OTHER DEFECTS INSTALLED ON A SMOOTH, LEVEL SURFACE, FREE OF LARGE ROCKS AND DEBRIS.
- CONCRETE WASHOUT SIGNAGE SHALL BE CLEARLY VISIBLE AND LOCATED WITHIN 30 FEET OF EACH WASHOUT AREA.
- CONCRETE WASHOUT AREA SHALL BE COVERED DURING INCLEMENT WEATHER TO PREVENT OVERFLOW.
- PREFABRICATED, PORTABLE AND RE-USABLE CONCRETE WASHOUT CONTAINERS ARE ACCEPTABLE.
- CONCRETE WASHOUT AREA SHALL BE INSPECTED DAILY TO CHECK FOR DAMAGE AND DETERMINE IF IT NEEDS CLEANED OR REPLACED. ANY DAMAGE TO THE SIDEWALLS OR PLASTIC LINING SHALL BE REPAIRED IMMEDIATELY. REPLACE THE ENTIRE CONCRETE WASHOUT AREA WHEN IT IS 75% FULL.

CONCRETE WASHOUT DETAIL

SCALE: NONE



SIDE OF CLEARING UNDISTURBED AND GRADING 2" X 2" WOOD STAKES (10' ON CENTER) -__ 3" TO 4" FILTER SOCK SEDIMENT STORAGE AREA **SECTION VIEW**

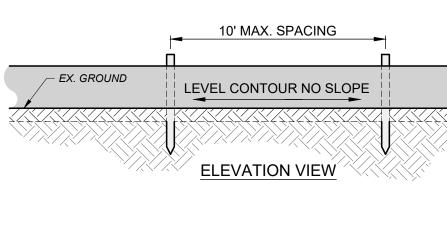
- FILTER SOCKS SHALL BE CONTINUOUS, TUBULAR, HDPE KNITTED MESH NETTING MATERIAL, FILLED WITH COMPOST.
- COMPOST SHALL BE WEED, PATHOGEN AND INSECT FREE, FREE OF REFUSE, CONTAMINANTS OR MATERIALS TOXIC TO PLANT GROWTH, BE DERIVED FROM A WELL-DECOMPOSED SOURCE OF ORGANIC MATTER, AND CONSIST OF PARTICLES RANGING FROM 3/8" TO 2".
- FILTER SOCKS SHALL BE PLACED ON A LEVEL LINE ACROSS SLOPES PARALLEL TO THE BASE OF THE SLOPE. ON SLOPES APPROACHING 2:1, ADDITIONAL SOCKS SHALL BE PROVIDED AT THE TOP AND MID-SLOPE.
- THE FLAT DIMENSION OF THE SOCK SHALL BE AT LEAST 1.5 TIMES THE NOMINAL DIAMETER
- FILTER SOCKS SHALL BE PLACED AT LEAST 5' FROM THE TOE OF SLOPE FOR SEDIMENT DEPOSIT.
- TRAFFIC SHALL NOT BE PERMITTED TO CROSS FILTER SOCKS.
- BUILT UP SEDIMENT SHALL BE REMOVED WHEN IT HAS REACHED 1/3 THE FILTER SOCK HEIGHT.
- BIODEGRADABLE FILTER SOCKS SHALL BE REPLACED AFTER 6 MONTHS; PHOTODEGRADABLE SOCKS AFTER 1 YEAR. POLYPROPYLENE SOCKS SHALL BE REPLACED ACCORDING TO MANUFACTURER'S RECOMMENDATIONS.
- WHEN A FILTER SOCK IS NO LONGER REQUIRED, IT SHALL BE DISPERSED ON-SITE.
- THE MAXIMUM DRAINAGE AREA PER 100 FEET OF FILTER SOCK IS 1/2 ACRE AND IS DEPENDENT ON THE SLOPE PER THE CHARTS BELOW:

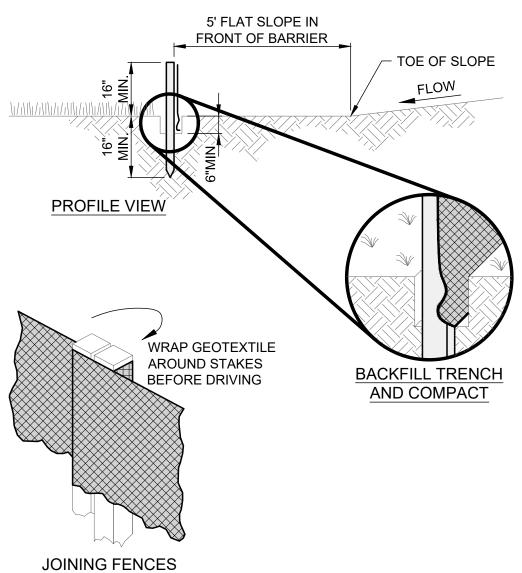
RANGE OF SLOPE PER INDIVIDUAL DRAINAGE AREA
<2% (50H:1V)
≥2% (50H:1V) BUT <20% (5H:1V)
≥20% (5H:1V) BUT <50% (2H:1V)

(*) FILTER SOCK CANNOT BE USED FOR SLOPES ≥50% (2H:1V).

MAX. S	MAX. SLOPE LENGTH ABOVE FILTER SOCK			
SLOPE (%)	RATIO (H:V)	12"	18"	24"
0% TO <2%	0 TO <50:1	250'	300'	350'
≥2% TO <10%	≥50:1 TO <10:1	125'	200'	25'
≥10% TO <20%	≥10:1 TO <5:1	100'	150'	200'
≥20% TO <50%	≥5:1 TO ≥2:1	50'	75'	100'

FILTER SOCK DETAIL SCALE: NONE





- PRESERVE VEGETATION FOR 5 FEET OR AS MUCH AS POSSIBLE UPSLOPE FROM THE SILT FENCE. IF VEGETATION IS REMOVED, IT SHALL BE RE-ESTABLISHED WITHIN 7 DAYS FROM SILT FENCE INSTALLATION.
- SILT FENCE MAY ONLY PASS RUNOFF AS DIFFUSE FLOW THROUGH THE GEOTEXTILE. IF RUNOFF OVERTOPS THE SILT FENCE, FLOWS UNDER OR AROUND THE ENDS, OR IN ANY OTHER WAY BECOMES A CONCENTRATED FLOW, THEN CHANGE THE LAYOUT OF THE SILT FENCE, REMOVE ACCUMULATED SEDIMENT OR INSTALL OTHER PRACTICES.
- SILT FENCE SHALL BE INSPECTED FOR DEPTH OF SEDIMENT, TEARS, VERIFICATION FABRIC IS SECURELY ATTACHED TO FENCE POSTS, AND VERIFICATION FENCE POSTS ARE FIRMLY IN THE GROUND. BUILT UP SEDIMENT SHALL BE REMOVED FROM SILT FENCE WHEN IT HAS REACHED 1/3 THE FENCE HEIGHT.
- THE MAXIMUM DRAINAGE AREA PER 100 FEET OF SILT FENCE IS 1/2 ACRE AND IS DEPENDENT ON THE SLOPE PER THE CHART BELOW:

MAX. DRAINAGE AREA (AC.) PER 100-FT OF SILT FENCE (*)	RANGE OF SLOPE PER INDIVIDUAL DRAINAGE AREA
0.50 AC.	<2% (50H:1V)
0.25 AC.	≥2% (50H:1V) BUT <20% (5H:1V)
0.125 AC.	≥20% (5H:1V) BUT <50% (2H:1V)

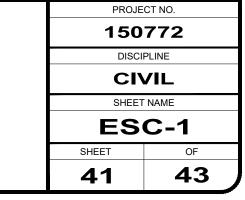
(*) SILT FENCE CANNOT BE USED FOR SLOPES ≥50% (2H:1V).

SILT FENCE DETAIL

SCALE: NONE

ISSUED FOR: ISSUE DATE: 02/07/25 SCALE: AS SHOWN **DESIGNED BY** DRAWN BY: TJM CHECKED BY:

EROSION & SEDIMENT CONTROL DETAILS



verdantas

REVISION DATE

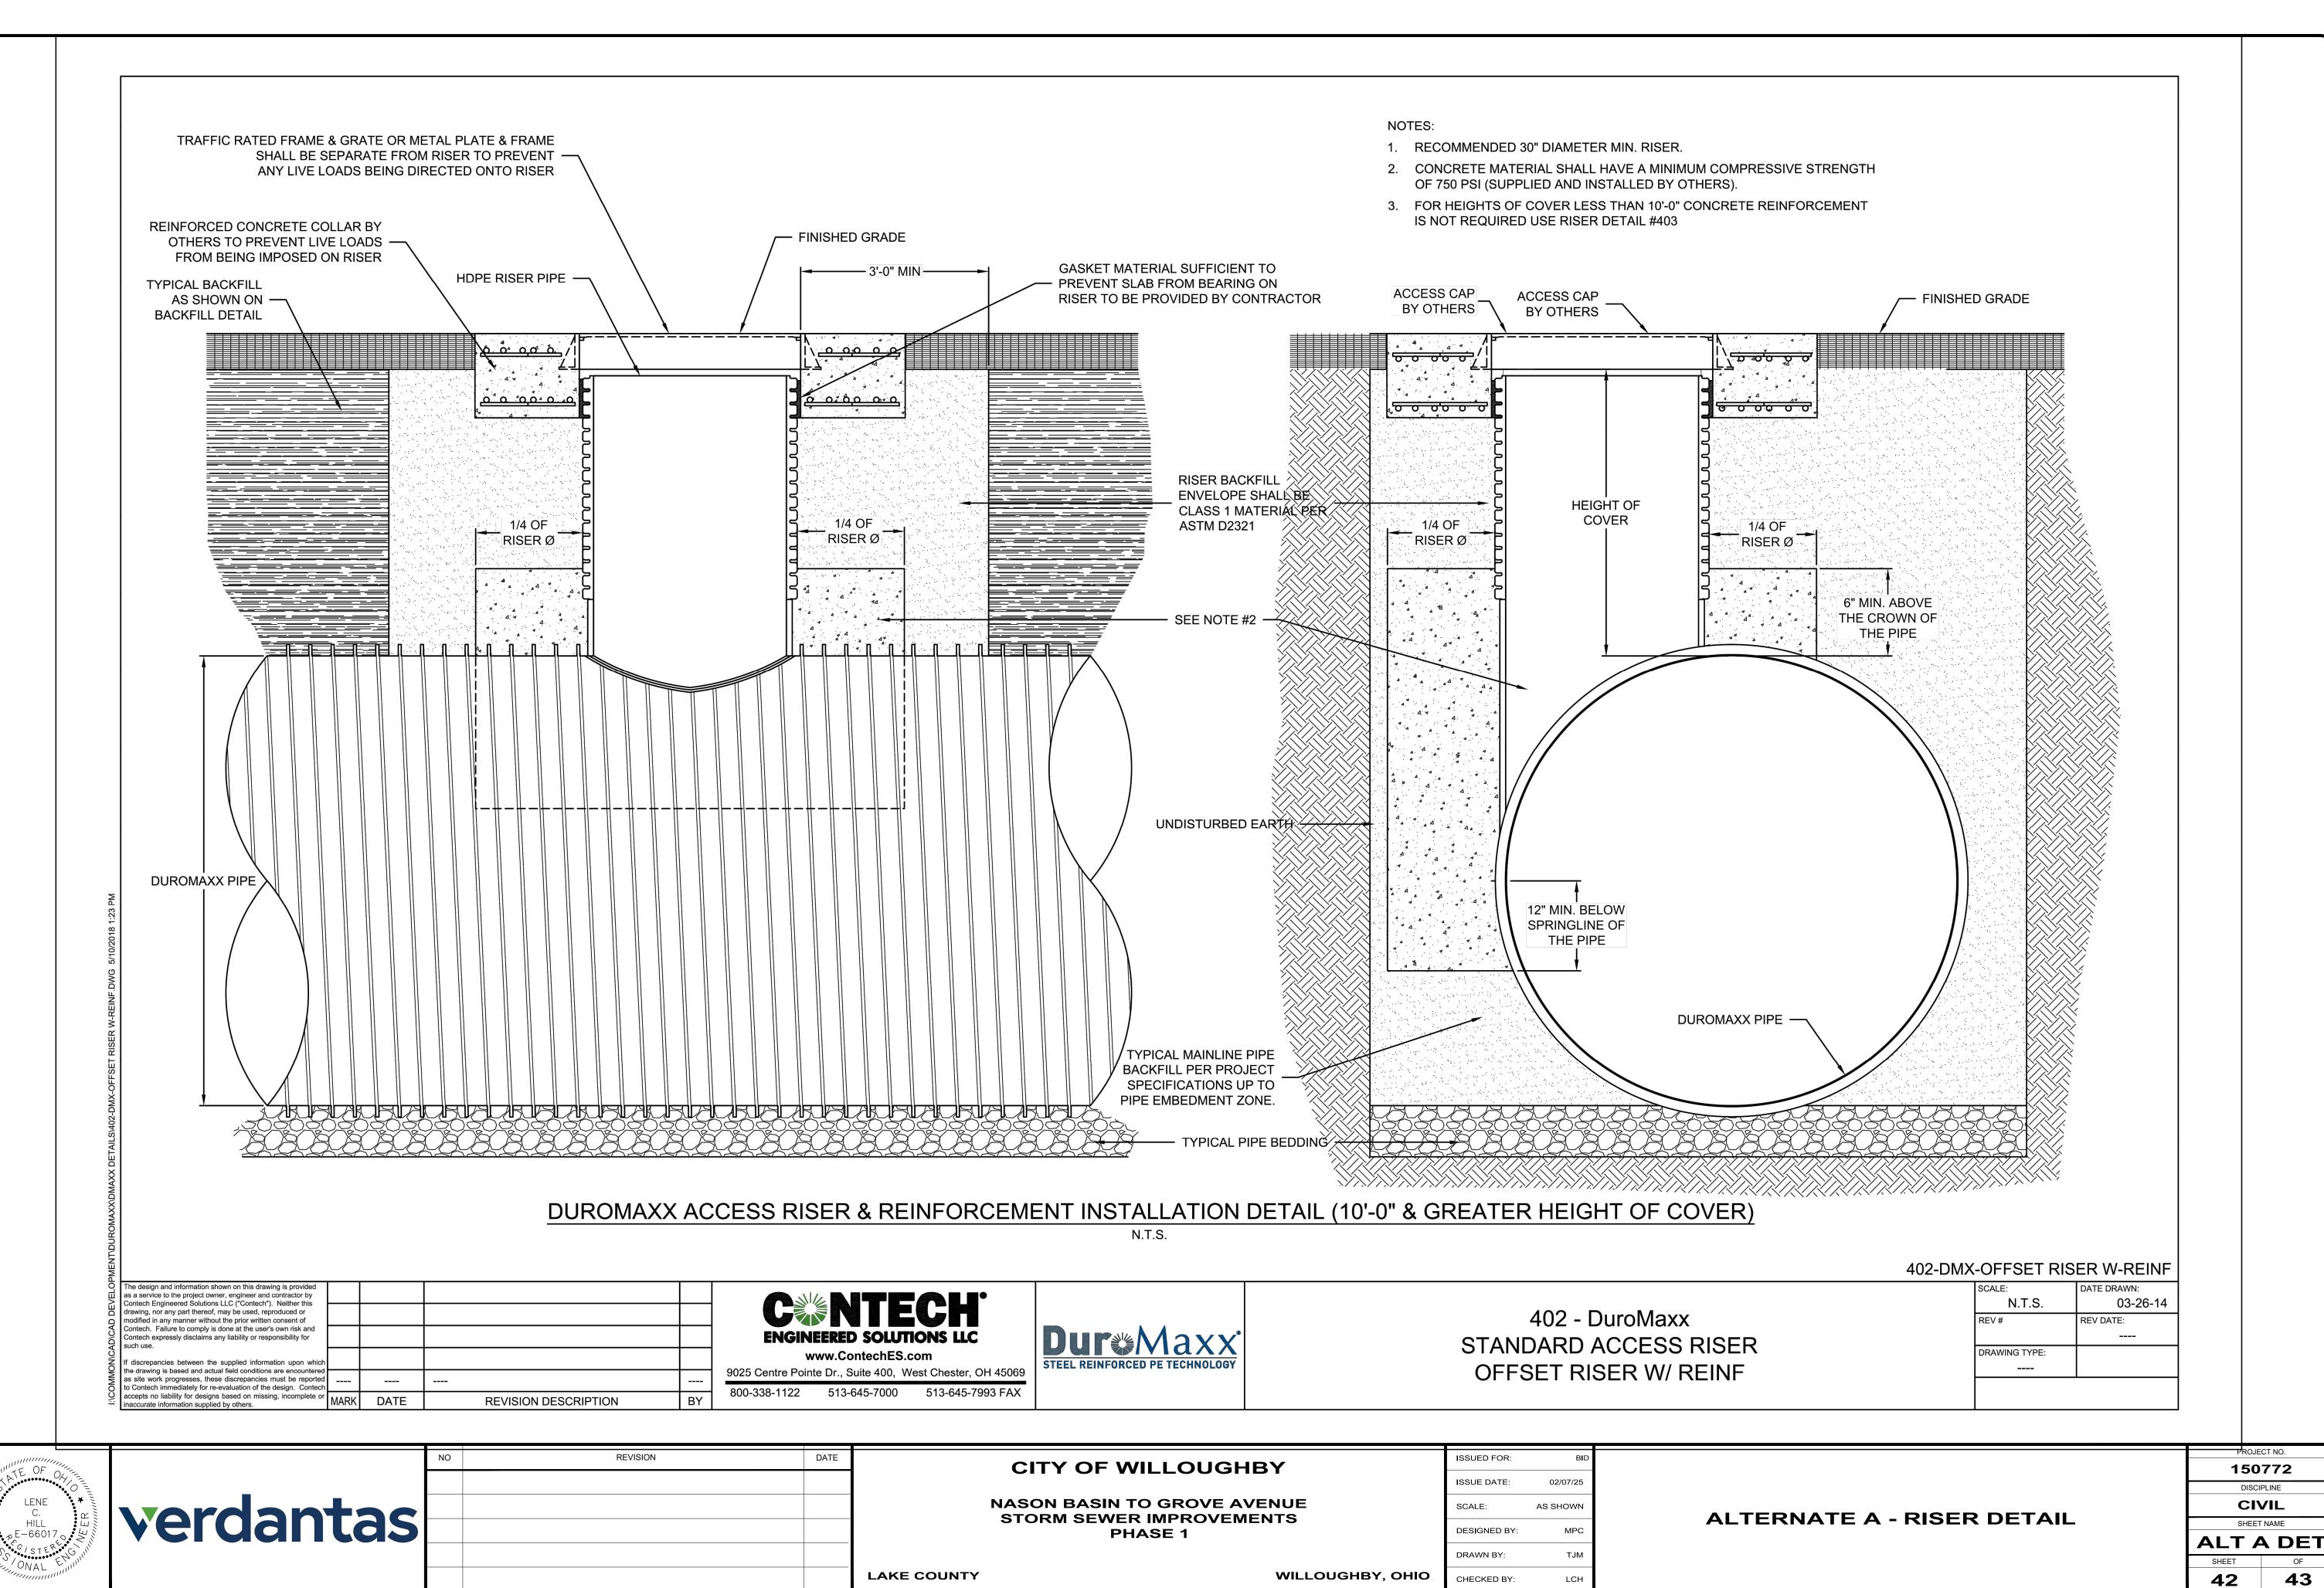
CITY OF WILLOUGHBY

NASON BASIN TO GROVE AVENUE **STORM SEWER IMPROVEMENTS** PHASE 1

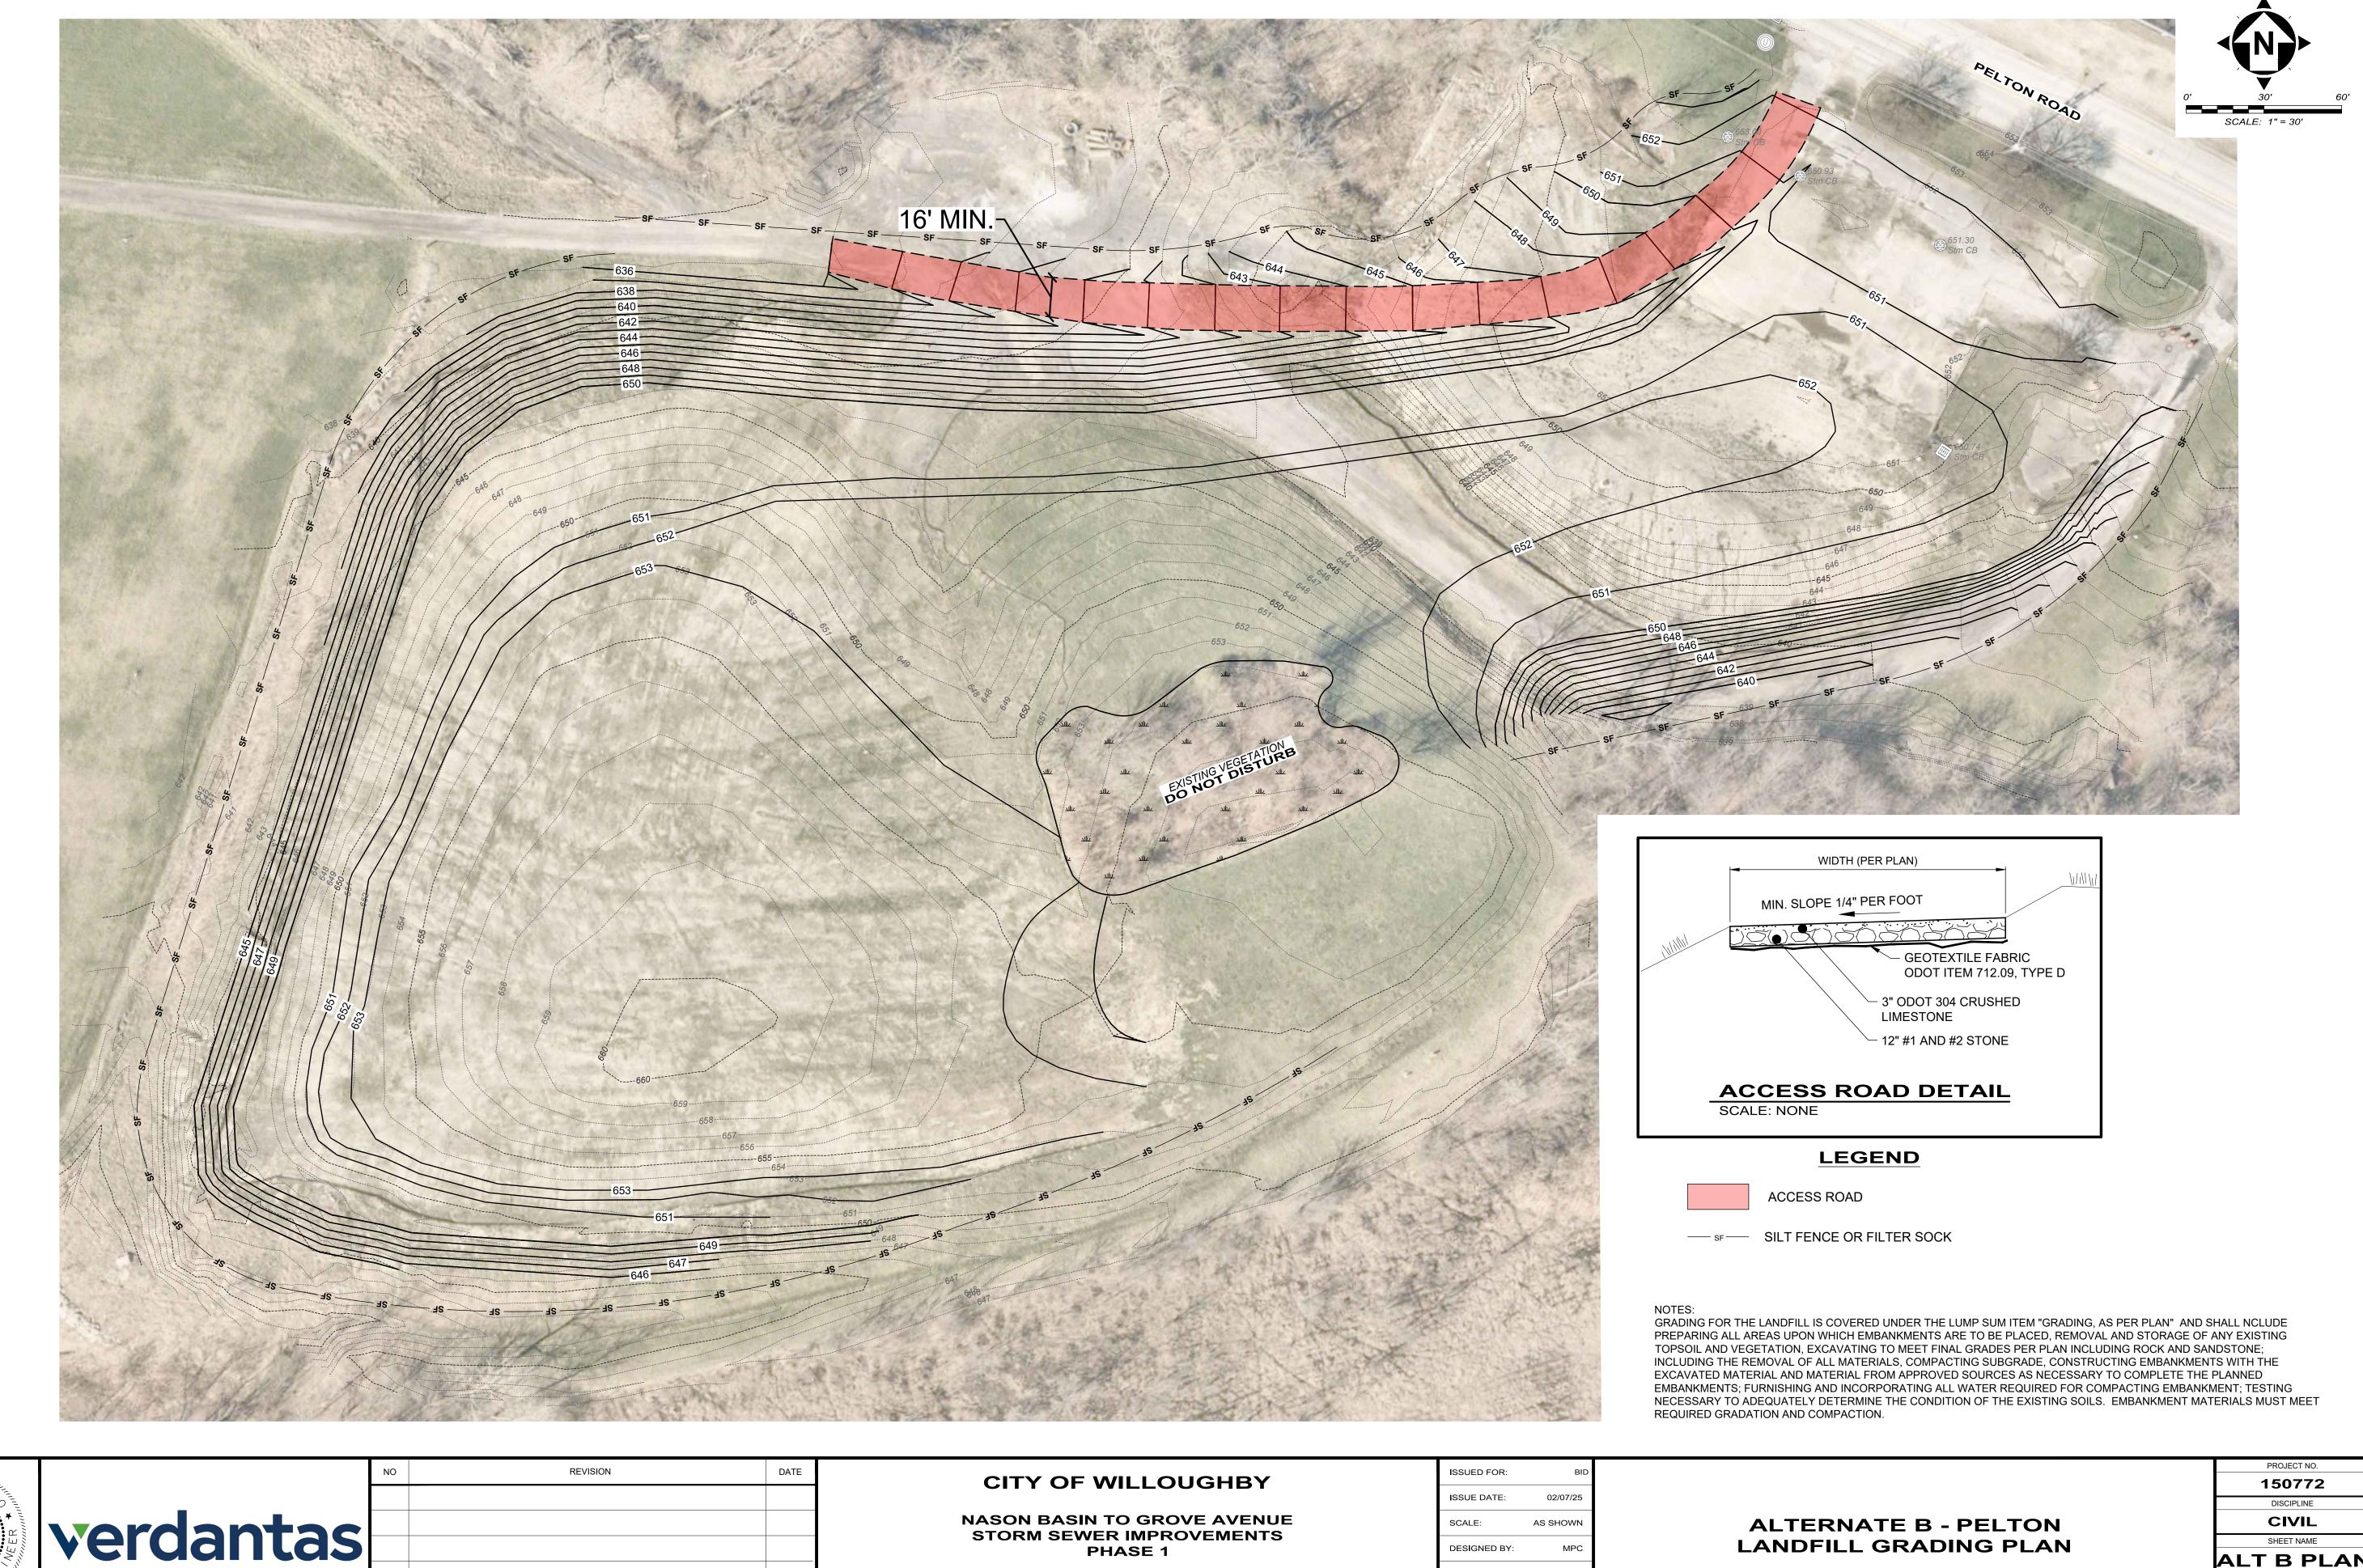
WILLOUGHBY, OHIO

LAKE COUNTY

H:\2015\150772\DWG\SHEETS\C_150772-51_EC DETAILS.DWG - ESC-1 - 2/3/2025 10:24:11 AM - TYLER MINTUS



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WILLOUGHBY, OHIO CHECKED BY: LCH LAKE COUNTY

ISSUE DATE:	02/07/25
SCALE:	AS SHOWN
DESIGNED BY:	MPC
DRAWN BY:	TJM
CHECKED BY:	LCH

ALT B PLAN