

TYPICAL SECTION KEMPER RD.
STA. 2+91.34 TO 15.56.93

LEGEND

- ① EX ASPHALT REMOVED
- ② EX CURB & GUTTER REMOVED
- ③ ITEM 254 - PAVEMENT PLANNING, ASPHALT CONCRETE (3" MIN.) PROFILE MILL
- ④ ITEM 407 - NON-TRACKING TACK COAT @ 0.075 GAL/ SY
- ⑤ ITEM 407 - NON-TRACKING TACK COAT FOR INTERMEDIATE COURSE @ 0.05 GAL/ SY
- ⑥ ITEM 441 - 1-1/2" ASPHALT CONCRETE INTERMEDIATE COURSE, TYPE 2, (448)
- ⑦ ITEM 441 - 1-1/2" ASPHALT CONCRETE SURFACE COURSE, TYPE 1, (446), PG64-22, 100% CRUSHED LIMESTONE
- ⑧ ITEM 609 - COMBINATION CURB & GUTTER, TYPE 2
- ⑨ ITEM 653 - TOPSOIL FURNISHED AND PLACED (4") & ITEM 659 - SEEDING & MULCHING CLASS 1 (SEE NOTE 4)
- ⑩ ITEM 608 - 5" CONCRETE WALK (9" WALK AT APRONS AND CURB RAMPS)
- ⑪ SHARED USE PATH (SEE DETAIL)
- ⑫ ITEM SPC - RETAINING WALL
- ⑬ EXISTING ASPHALT
- ⑭ ITEM 609 CURB, TYPE 7, AS PER PLAN
- ⑮ ITEM 605 UNDERDRAIN, MISC.: 6" SHALLOW PIPE UNDERDRAIN
- ⑯ CLEAN #57'S GRANULAR MATERIAL BACKFILL (INCIDENTAL TO ITEM 605 - UNDERDRAIN, MISC.: 6" SHALLOW PIPE UNDERDRAIN)
- ⑰ ITEM SPL - NON-WOVEN GEOTEXTILE FABRIC - MIRIFI 140N OR EQUIVALENT. PLACED ON 3 SIDES OF UNDERDRAIN TRENCH. (INCIDENTAL TO ITEM 605 UNDERDRAIN, MISC.: 6" SHALLOW PIPE UNDERDRAIN)

NOTES:

1. SEE INTERSECTION DETAILS:
-STA 1+21.66 TO STA 2+91.34
-STA 6+59.41 TO STA 7+51.42
-STA 15+9717 TO STA 16+98.06
2. SAWCUT TO A CLEAN EDGE WHERE NOTED ON THE PLANS. A 6" WIDTH WITH CONCRETE INFILL IS ASSUMED TO BE NECESSARY AND INCIDENTAL.
3. PROFILE AND ALIGNMENT PLACE THE PROPOSED PAVEMENT TO FOLLOW THE ALIGNMENT AND PROFILE OF THE EXISTING PAVEMENT. PLACE THE PROPOSED ASPHALT CONCRETE OVERLAY (WITH A UNIFORM THICKNESS OF THREE (3) INCHES AFTER PLANING THE EXISTING ASPHALT PAVEMENT AS SHOWN ON THE TYPICAL SECTIONS.
4. THE FOLLOWING QUANTITIES ARE ESTIMATED TO PROMOTE GROWTH AND CARE OF PERMANENT SEEDED AREAS:

ITEM 659, TOPSOIL	278 CY
ITEM 659, SEEDING AND MULCHING	2,505 SY
ITEM 659, COMMERCIAL FERTILIZER	0.34 TON
ITEM 659, WATER	1.5 MGAL

ITEM 659, WATER ASSUMES UP TO 6 WATERING TO A MINIMUM DEPTH OF 1" AS REQUESTED BY THE CITY.

USE TURF TYPE SEED (10% PERENNIAL RYE, 80 FESCUE - TALL TURF AND/OR TITAN TYPE, AND 10 KENTUCKY BLUEGRASS) + FERTILIZER (12-12-12).

APPLY SEEDING AND MULCHING TO ALL AREAS OF EXPOSED SOIL WITHIN THE CONSTRUCTION LIMITS. QUANTITY CALCULATIONS FOR SEEDING AND MULCHING ARE BASED ON THESE LIMITS. THE COST FOR ALL THE ABOVE NOTED ITEMS SHALL BE INCIDENTAL TO THE CONTRACT.

*2.5' GRASS STRIP AT B/C THEN 5' WALK, STA 12+51 TO STA. 14+90.87

NO	REVISION	DATE

ISSUED FOR:	BID NO:	ISSUE DATE:	SCALE:	DESIGNED BY:	DRAWN BY:	CHECKED BY:

PROJECT NO.	
242429	
DISCIPLINE	
CIVIL	
SHEET NAME	
TYP	
SHEET	OF
2	47

MAINTENANCE OF TRAFFIC NOTES

ITEM 614, MAINTAINING TRAFFIC

THE REQUIREMENTS FOR MAINTAINING TRAFFIC SHALL BE AS INDICATED IN THE 'OHIO MANUAL OF UNIFORM TRAFFIC CONTROL DEVICES FOR STREETS AND HIGHWAYS'...

THE CONTRACTOR SHALL NOTIFY THE ENGINEER AND THE CITY OF SPRINGDALE, AT LEAST 48 HOURS IN ADVANCE (EXCLUSIVE OF SATURDAY, SUNDAY OR HOLIDAYS)...

THE CONTRACTOR SHALL MAINTAIN PEDESTRIAN TRAFFIC THROUGHOUT THE PROJECT CONSTRUCTION.

A. IT SHALL BE THE CONTRACTOR'S RESPONSIBILITY TO SUBMIT TO THE ENGINEER AND THE OWNER A TRAFFIC CONTROL PLAN FOR THIS PROJECT. BEFORE WORK BEGINS...

B. TRAFFIC SHALL BE MAINTAINED AT ALL INTERSECTIONS AND DRIVES AT ALL TIMES, AND SHALL BE CONTROLLED WITH FLAGGERS AND TRAFFIC CONTROL DEVICES AS REQUIRED...

C. UNLESS OTHERWISE NOTED IN THE PLANS, THE CONTRACTOR WILL BE PERMITTED TO CLOSE UP TO TWO LANES ON W. KEMPER ROAD TO MAINTAIN A MINIMUM OF TWO LANES OF TRAFFIC IN EACH DIRECTION.

D. LENGTH AND DURATION OF LANE CLOSURES AND RESTRICTIONS SHALL BE AT THE APPROVAL OF THE ENGINEER. IT IS THE INTENT TO MINIMIZE THE IMPACT TO THE TRAVELING PUBLIC...

G. ANY COST FOR ITEMS NOT SPECIFICALLY NOTED UNDER THE MAINTENANCE OF TRAFFIC NOTE OR TEMPORARY PAVEMENT MARKING REQUIRED TO REOPEN LANES SHALL BE INCLUDED IN THE BID PRICE FOR ITEM 614, MOT.

THE CONTRACTOR SHALL OBEY ALL LOCAL LAWS AND ORDINANCES INCLUDING ANY NOISE RESTRICTIONS.

THE CONTRACTOR SHALL MAINTAIN LOCAL TRAFFIC AT ALL TIMES IN ACCORDANCE WITH THE REQUIREMENTS OF SPEC. 614.

SPECIFIC ATTENTION WILL BE DIRECTED TOWARD THE PROPER USE OF FLAGGERS, LIGHTS, DRUMS, AND TEMPORARY PAVEMENT MARKINGS. THE CONTRACTOR SHALL FURNISH, ERECT AND MAINTAIN ALL NECESSARY SIGNS...

MAINTENANCE OF TRAFFIC SHALL BE ONGOING THROUGH THE PROJECT, INCLUDING ALL PERIODS OF INACTIVITY BY THE CONTRACTOR, UNTIL FINAL ACCEPTANCE OF THE PROJECT.

MAINTAINING ADJACENT STREET TRAFFIC THE CONTRACTOR SHALL MAINTAIN TRAFFIC TO ALL ROADWAYS INTERSECTING THE CONSTRUCTION AREAS.

OPEN TRENCHES ALL OPEN TRENCHES FOR STORM SEWERS, WATERMANS, ETC., SHALL BE PROPERLY DELINEATED FROM THE TRAVELED ROADWAY BY REFLECTIVE DRUMS. TRENCHES SHALL EITHER BE BACKFILLED OR COVERED FOR ANY EXTENDED PERIODS OF NO CONSTRUCTION...

MAINTENANCE OF DRIVEWAYS THE CONTRACTOR WILL BE RESPONSIBLE FOR MAINTAINING ALL DRIVEWAYS IN GOOD CONDITION WITH RESPECT TO BOTH SAFETY AND SMOOTHNESS OF TRAVEL FOR THE DURATION OF THE PROJECT.

COORDINATION WITH LOCAL BUSINESS OWNERS BUSINESS OWNERS: THE CONTRACTOR SHALL WORK WITH LOCAL BUSINESS OWNERS TO ENSURE ACCESS TO ALL PROPERTIES AT ALL TIMES. HOWEVER, SOME INCONVENIENCES WILL OCCUR...

CONSTRUCTION STIPULATION

- A. THE CONTRACTOR SHALL NOT STORE MATERIALS AND EQUIPMENT, OPERATE EQUIPMENT ON OR OVER PROPERTY OTHER THAN THE PUBLIC RIGHT-OF-WAY OR AREAS THAT ARE A PART OF THE PROJECT CONSTRUCTION.
B. THE CONTRACTOR SHALL SUBMIT, IN WRITING, A SCHEDULE OF OPERATIONS TO THE ENGINEER AND RECEIVE APPROVAL BEFORE STARTING WORK ON THIS PROJECT.
C. IT IS THE RESPONSIBILITY OF THE CONTRACTOR TO ORGANIZE THE WORK IN SUCH A MANNER TO PROVIDE THE MOST SAFETY WITH THE LEAST INCONVENIENCE TO THE TRAVELING PUBLIC.
D. THE CONTRACTOR SHALL ALSO FURNISH, INSTALL, MAINTAIN, AND REMOVE ALL ADDITIONAL SIGNS OR TRAFFIC CONTROL DEVICES DEEMED NECESSARY BY THE ENGINEER WITH ALL ASSOCIATED COSTS INCLUDED IN THE LUMP SUM PRICE BID FOR ITEM 614 - "MAINTENANCE OF TRAFFIC AS PER PLAN."
E. THE CONTRACTOR SHALL BE RESPONSIBLE FOR PROVIDING AND MAINTAINING SAFE AND EFFECTIVE TRAFFIC CONTROL 24-HOURS A DAY FOR THE DURATION OF THIS PROJECT...

MAINTENANCE OF TRAFFIC NOTES

SEQUENCE OF CONSTRUCTION IT IS THE INTENT OF THE FOLLOWING SEQUENCE OF CONSTRUCTION TO PROVIDE A WORK AREA FOR THE CONTRACTOR WHILE ALSO MAINTAINING TRAFFIC IN A MANNER WHICH IS SAFE FOR THE TRAVELING PUBLIC...

ALL TEMPORARY OR PERMANENT PAVEMENT MARKINGS SHALL BE IN PLACE BEFORE ANY PAVEMENT IS OPENED TO TRAFFIC.

PHASE ONE THE CONTRACTOR SHALL PERFORM THE WORK ON THE SOUTH SIDE.
• REMOVE CURRENT STRIPING AND STRIPE FOR PHASE 1 MOT
• WHILE TRAFFIC IS MAINTAINED ON EXISTING PAVEMENT, CONSTRUCT SOUTH SIDE IMPROVEMENTS.

PHASE TWO THE CONTRACTOR SHALL PERFORM THE WORK ON THE NORTH SIDE.
• REMOVE CURRENT STRIPING AND STRIPE FOR PHASE 2 MOT
• WHILE TRAFFIC IS MAINTAINED ON EXISTING PAVEMENT, CONSTRUCT NORTH SIDE IMPROVEMENTS.

PHASE THREE THE CONTRACTOR SHALL GRIND AND INSTALL THE FINAL ASPHALT SURFACE AND PAVEMENT MARKINGS BY MAINTAINING TRAFFIC BY USE OF A-LANE CLOSURE PER STANDARD DRAWINGS MT-95.31, MT-95.32, AND MT-95.60. THIS WORK SHALL BE PERFORMED ON ALL LANES IN BOTH DIRECTIONS.

ALL PROJECT WORK MUST BE CONSIDERED TO BE SUBSTANTIALLY COMPLETE AND OPEN TO TRAFFIC BY OCTOBER 30, 2026.

IF THE CONTRACTOR SO ELECTS, HE MAY SUBMIT AN ALTERNATE METHOD FOR MAINTAINING TRAFFIC, PROVIDED THAT THE INTENT OF THE PROVISIONS ARE FOLLOWED AND NOT ADDITIONAL INCONVENIENCE TO THE TRAVELING PUBLIC RESULTS THEREFROM. NO ALTERNATE PLAN SHALL BE PLACED INTO EFFECT UNTIL APPROVAL HAS BEEN GRANTED IN WRITING BY THE CITY ADMINISTRATION AND THE CITY ENGINEER.

PAVEMENT DROP-OFF A PAVEMENT EDGE THAT TRAFFIC IS NOT EXPECTED TO CROSS, EXCEPT ACCIDENTALLY, SHOULD BE TREATED AS FOLLOWS:

- LESS THAN TWO INCHES - NO PROTECTION REQUIRED. WARNING SIGNS SHOULD BE PLACED IN ADVANCE AND THROUGHOUT THE DROP-OFF AREA.
• TWO TO FOUR INCHES - PLASTIC DRUMS, VERTICAL PANELS OR BARRICADES EVERY 100 FEET ON TANGENT SECTIONS FOR SPEEDS OF 50 MPH OR GREATER. CONES MAY BE USED IN PLACE OF PLASTIC DRUMS, PANELS AND BARRICADES DURING DAYLIGHT HOURS...
• GREATER THAN FOUR INCHES - POSITIVE SEPARATION OR WEDGE WITH 3:1 OR FLATTER SLOPE NEEDED. IF THERE IS FIVE FEET OR MORE DISTANCE BETWEEN THE EDGE OF THE PAVEMENT AND THE DROP-OFF, THEN DRUMS, PANEL, OR POSITIVE SEPARATION IS STRONGLY ENCOURAGED...

FOR TEMPORARY CONDITIONS, DROP-OFFS GREATER THAN FOUR INCHES MAY BE PROTECTED WITH PLASTIC DRUMS, VERTICAL PANELS OR BARRICADES FOR SHORT DISTANCES DURING DAYLIGHT HOURS WHILE WORK IS BEING DONE IN THE DROP-OFF AREA.

LESSER TREATMENTS THAN THOSE DESCRIBED ABOVE MAY BE CONSIDERED FOR LOW-VOLUME LOCAL STREETS.

THERE SHALL BE NO PAYMENT FOR MATERIAL USED FOR WEDGING AS THIS WORK SHALL BE CONSIDERED INCIDENTAL TO THE CONTRACT.

TEMPORARY PAVEMENT WEDGE TEMPORARY PAVEMENT WEDGES SHALL BE PROVIDED AT ALL TIMES WHERE TRAFFIC IS REQUIRED TO TRAVEL FROM OR ONTO A PAVEMENT SURFACE OF A DIFFERENT ELEVATION. THE MINIMUM SLOPE OF TEMPORARY PAVEMENT WEDGE SHALL BE 3:1 ALONG LOGITUDINAL JOINTS AND 120:1 AT TRANVERSE JOINTS. THESE WEDGES SHALL BE REMOVED TO PLACING THE SPECIFIED PAVEMENT COURSE...

SIDEWALK DROP-OFF PROTECTIVE EDGING WITH A 2" MIN. HEIGHT SHALL BE INSTALLED WHEN A CURB RAMP OR LANDING PLATFORM HAS A VERTICAL DROP OF 6" OR GREATER OR HAS SIDE APRON SLOPE STEEPER THAN 1:3 (33%). PROTECTIVE EDGING SHOULD BE CONSIDERED WHEN CURB RAMPS OR LANDING PLATFORMS HAVE A VERTICAL DROP OF 3" OR MORE.

HOLIDAY TRAFFIC LIMITATION NO WORK SHALL BE PERFORMED, AND ALL EXISTING LANES WHICH ARE NOT INSIDE A DESIGNATED WORK ZONE SHALL BE OPEN TO TRAFFIC DURING THE FOLLOWING DESIGNATED HOLIDAY OR EVENTS:

- NEW YEARS DAY (JANUARY 1)
MARTIN LUTHER KING DAY (THIRD MONDAY IN JANUARY)
EASTER SUNDAY (APRIL 5, 2026)
MEMORIAL DAY (LAST MONDAY IN MAY)
INDEPENDENCE Day (JULY 4)
LABOR DAY (FIRST MONDAY IN SEPTEMBER)
THANKSGIVING DAY (FOURTH THURSDAY IN NOVEMBER)
CHRISTMAS DAY (DECEMBER 25)

NO EXTENSIONS OF TIME SHALL BE GRANTED FOR DELAYS IN MATERIAL DELIVERIES, UNLESS SUCH DELAYS ARE INDUSTRY-WIDE, OR FOR LABOR STRIKES, UNLESS SUCH STRIKES ARE AREA-WIDE.

MAINTENANCE OF TRAFFIC NOTES

PEDESTRIAN ACCESS PEDESTRIAN ACCESS SHALL BE MAINTAINED TO ALL EXISTING BUSINESSES, A WORK AREA FOR THE CONTRACTOR SHALL PROVIDE ADA COMPLIANT TEMPORARY WALK SURFACES TO BUSINESS ENTRANCES DURING SIDEWALK RECONSTRUCTION OR OTHER OPERATIONS THAT WOULD OTHERWISE INHIBIT ACCESS.

THE CONTRACTOR SHALL PROVIDE MEASURES THAT ESTABLISH AND MAINTAIN TEMPORARY PEDESTRIAN ACCESS ROUTES (TPAR) THROUGH THE WORK ZONES IN COMPLIANCE WITH THE MOST CURRENT AMERICANS WITH DISABILITIES ACT ACCESSIBILITY GUIDELINES (ADAAG) AND THE PUBLIC RIGHT OF WAY ACCESSIBILITY GUIDELINES (PROWAG)...

THE CONTRACTOR SHALL FOLLOW THE CURRENT EDITION OF THE OHIO MUTCD PART 6 STANDARDS AND GUIDANCE FOR PEDESTRIAN AND WORKER SAFETY AND TTC DEVICES. WHEN EXISTING PEDESTRIAN FACILITIES ARE DISRUPTED, CLOSED, OR RELOCATED IN A CONSTRUCTION ZONE, THE TEMPORARY PEDESTRIAN ACCOMMODATION FACILITIES SHALL BE DETECTABLE AND SHALL INCLUDE ACCESSIBILITY FEATURES CONSISTENT WITH THE FEATURES PRESENT IN THE EXISTING PEDESTRIAN FACILITY...

THE CONTRACTOR SHALL REFER TO FIGURE 6H-28 FOR SIDEWALK DETOUR OR DIVERSIONS, AND FIGURE 6H-29 FOR CROSSWALK CLOSURES AND PEDESTRIAN DETOURS IN THE 2009 MUTCD FOR GUIDANCE ON MANAGING PEDESTRIANS IN THE VICINITY OF WORK ZONES WITHIN SIDEWALK AREAS. THE CONTRACTOR SHALL PROVIDE AS A MINIMUM THESE LEVELS OF TEMPORARY PEDESTRIAN SIGNING AND PROTECTION MEASURES FOR THIS PROJECT...

THE CONTRACTOR SHALL PLACE TEMPORARY BARRIERS AT THE LIMITS OF WORK TO ASSURE PUBLIC SAFETY DURING CONSTRUCTION.

ALL ITEMS OF WORK NECESSARY TO MAINTAIN PEDESTRIAN TRAFFIC IS INCIDENTAL TO THE LUMP SUM LUMP SUM CONTRACT PRICE FOR ITEM 614, MAINTAINING TRAFFIC.

EQUIPMENT AND MATERIAL STORAGE TO PROVIDE FOR THE SAFETY OF THE TRAVELING PUBLIC, THE CONTRACTOR'S ATTENTION IS DIRECTED TO ITEM 614.03. IN ADDITION, THE FOLLOWING PROVISIONS SHALL APPLY:
1. ANY REMOVED ITEMS SHALL NOT BE STORED ON THE RIGHT-OF-WAY FOR MORE THAN THIRTY DAYS.
2. ALL DISTURBED AREAS SHALL BE RETURNED TO THEIR ORIGINAL CONDITION AT NO EXPENSE TO THE CITY.

CONSTRUCTION TRAFFIC ALL CONSTRUCTION TRAFFIC SHALL USE ACCEPTABLE TRUCK ROUTES TO ACCESS THE CONSTRUCTION AREA. USE OF LOCAL RESIDENTIAL STREETS IS STRICTLY PROHIBITED UNLESS ALLOWED IN WRITING BY THE LOCAL ENFORCEMENT AUTHORITY.

INSTALLATION OF WORK ZONE PAVEMENT MARKINGS AND SIGNS ALL WORK ZONE PAVEMENT MARKINGS AND SIGNS REQUIRED FOR A PARTICULAR LANE CLOSURE OR TRAFFIC PATTERN SHALL BE INSTALLED ON A SINGLE WORKDAY, AND THE CORRESPONDING TRAFFIC PATTERN, AS DETAILED ON THE PLANS, SHALL BE IMPLEMENTED IMMEDIATELY. IN ADDITION, THE REQUIREMENTS OF 614.11(G) SHALL APPLY. THE CONTRACTOR SHALL BE RESPONSIBLE WITH THE ASSISTANCE OF THE ENGINEER, FOR THE ENTIRE LAYOUT AND LOCATIONS OF THE REQUIRED PAVEMENT MARKINGS.

UTILITIES DATA IS BASED UPON INFORMATION PROVIDED BY THE UTILITY COMPANIES AND HAS NOT BEEN VERIFIED BY THE ENGINEER, THE ENGINEER OR THE OWNER IS NOT RESPONSIBLE OR LIABLE FOR DATA SUPPLIED BY OTHERS. UTILITIES NOT UNDERGROUND, AND PRIVATE SEPTIC SYSTEMS IN SINGLE OR DOUBLE FAMILY DWELLINGS UTILIZED FOR ONLY THAT DWELLING AND NOT CONNECTED TO ANY OTHER SYSTEM ARE NOT INCLUDED ON THE PLAN. WITHIN 10 DAYS OF THE AWARD OF THE CONTRACT, THE OWNER SHALL NOTIFY ALL UTILITIES OF THE NAME, ADDRESS AND PHONE NUMBER OF THE CONTRACTOR. THE CONTRACTOR SHALL NOTIFY THE REGISTERED UNDERGROUND UTILITY PROTECTION SERVICE AND NON-MEMBER OWNERS OF THE STARTING DATE AT LEAST TWO WORKING DAYS PRIOR TO STARTING WORK...

THE CONTRACTOR SHALL BE RESPONSIBLE FOR COORDINATING ALL UTILITY ACTIVITIES AND SCHEDULES. ALL UTILITY RELOCATIONS AND/OR ADJUSTMENTS SHALL BE COORDINATED BETWEEN CONTRACTOR AND THE UTILITY OWNERS IN SUCH A WAY AS TO AVOID AND/OR MINIMIZE ANY INCONVENIENCE TO POTENTIALLY AFFECTED CUSTOMERS. UPON THE CONTRACT AWARD, THE COORDINATION OF ALL NECESSARY UTILITY RELOCATIONS AND/OR ADJUSTMENTS SHALL BECOME THE RESPONSIBILITY OF THE CONTRACTOR.

MSD HAS EXISTING FACILITIES WITHIN THE CONSTRUCTION LIMITS OR PROJECT AREA THAT WILL STAY IN PLACE AND IN SERVICE. TO SCHEDULE AN MSD INSPECTOR, THE CONTRACTOR SHALL CONTACT RAY SCHORK OF MSD WVE INSPECTIONS AT 513.244.5537 OR MSDWVEINSPECTIONS@CINCINNATI-OH.GOV A MINIMUM OF FIVE (5) BUSINESS DAYS BEFORE STARTING CONSTRUCTION ON OR NEAR MSD SEWERS, INCLUDING ANY MANHOLE ADJUSTMENTS REQUIRED FOR THE PROJECT. MANHOLE ADJUSTMENTS MUST BE MADE PER MSD STANDARD DRAWING ACCESSION NOS. 49058 OR 49058-A

- 49058: SANITARY MANHOLE ADJUSTMENT USING BRICK AND MORTAR PRIOR TO MACHINE PAVING
49058-A: SANITARY MANHOLE ADJUSTMENT WITH PRECAST CONCRETE RING AND MORTAR PRIOR TO MACHINE PAVING

COORDINATION WITH GCWW THE CONTRACTOR SHALL CONTACT MIKE LAWSON, SUPERVISOR OF INSPECTION, AT 591-7870 A MINIMUM OF TWO (2) BUSINESS DAYS PRIOR TO THE START OF THE WORK INCLUDED ON THE GCWW CONSTRUCTION DRAWINGS.

MAINTENANCE OF TRAFFIC NOTES

COORDINATION WITH LOCAL BUSINESS OWNERS BUSINESS OWNERS: THE CONTRACTOR SHALL WORK WITH LOCAL BUSINESS OWNERS TO ENSURE ACCESS TO ALL PROPERTIES AT ALL TIMES. HOWEVER, SOME INCONVENIENCES WILL OCCUR. NO ADDITIONAL PAYMENT WILL BE MADE FOR COORDINATION OR PROVIDING ACCESS TO BUSINESSES.

THE CONTRACTOR SHALL NOTIFY AFFECTED RESIDENTS 48 HOURS IN ADVANCE BEFORE COMMENCING WORK.

TEMPORARY BLOCKING OF THE DRIVEWAY TO ANY RESIDENTIAL PROPERTY DURING CONSTRUCTION IS ALLOWABLE (MAX. 120 HOURS) HOWEVER, ACCESS TO PROPERTIES FOR DELIVERIES, SERVICE, EMERGENCY VEHICLES, ETC., SHALL BE MAINTAINED AT ALL TIMES. IN ADDITION, THE CONTRACTOR MUST NOTIFY ALL RESIDENTS IN WRITING 48 HOURS BEFORE COMMENCING TO ALLOW THEM ADEQUATE TIME TO MOVE ANY VEHICLE IN OR OUT.

THE CONTRACTOR SHALL GIVE WRITTEN NOTICE TO THE RESIDENT AND/OR BUSINESS AND GIVE A COPY OF SAID WRITTEN NOTICE TO THE PROJECT INSPECTOR 48 HOURS PRIOR TO BEING ALLOWED TO COMMENCE WORK WHICH WOULD INVOLVE ACCESS TO SAID PROPERTY.

TEMPORARY SIDEWALKS, ETC. WILL BE NECESSARY TO PREVENT PERSONS FROM WALKING IN MUD IN ORDER TO ENTER THEIR PROPERTY. TEMPORARY BRIDGES, RAILINGS ETC. WILL BECOME NECESSARY IN ORDER TO CROSS FORMED CURB LINES, EXCAVATED AREAS BEHIND CURB LINES AND WALKWAYS, ETC. THESE TEMPORARY SIDEWALKS, ETC. SHALL BE CONSIDERED INCIDENTAL TO THE COST OF THE CONTRACT.

COORDINATION WITH METRO THE CONTRACTOR SHALL CONTACT THE SOUTHWEST OHIO REGIONAL TRANSIT AUTHORITY (SORTA) AND PROVIDE A WRITTEN NOTIFICATION FOURTEEN (14) BUSINESS DAYS PRIOR TO ANY CONSTRUCTION THAT WILL AFFECT NEARBY BUS STOPS OR SERVICE.

THE CONTRACTOR SHALL NOTIFY SORTA AT LEAST TEN (10) BUSINESS DAYS IN ADVANCE OF ALL STREET CLOSURES AFFECTING TRAFFIC OPERATIONS REGARDLESS OF THE DURATION OF THE CLOSURE. THIS WILL ALLOW SORTA SUFFICIENT TIME TO PLAN DETOURS AND NOTIFY THE GENERAL PUBLIC.

THE CONTRACTOR SHALL WORK WITH SORTA TO ESTABLISH AN APPROVED TEMPORARY BUS STOP LOCATION AS DEEMED NECESSARY BY SORTA.

SORTA WILL PROVIDE AND POST THE APPROPRIATE TEMPORARY BUS SIGN SIGNAGE.

THE CONTRACTOR SHALL NOTIFY SORTA AT LEAST TEN (10) BUSINESS DAYS IN ADVANCE OF CONSTRUCTION COMPLETION SO THE PERMANENT BUS STOP SIGNS CAN BE RE-INSTALLED BY SORTA

CONTRACTO MAY NOT REMOVE ANY BUS STOP SIGNS WITHOUT PRIOR AUTHORIZATION FROM SORTA.

COST FOR COORINATION IS INCLUDED IN THE LUMP SUM CONTRACT BID PRICE FOR ITEM 614 - MAINTAINING TRAFFIC.

UTILITY NOTES

UTILITIES DATA IS BASED UPON INFORMATION PROVIDED BY THE UTILITY COMPANIES AND HAS NOT BEEN VERIFIED BY THE ENGINEER, THE ENGINEER OR THE OWNER IS NOT RESPONSIBLE OR LIABLE FOR DATA SUPPLIED BY OTHERS.

UTILITIES NOT UNDERGROUND, AND PRIVATE SEPTIC SYSTEMS IN SINGLE OR DOUBLE FAMILY DWELLINGS UTILIZED FOR ONLY THAT DWELLING AND NOT CONNECTED TO ANY OTHER SYSTEM ARE NOT INCLUDED ON THE PLAN.

WITHIN 10 DAYS OF THE AWARD OF THE CONTRACT, THE OWNER SHALL NOTIFY ALL UTILITIES OF THE NAME, ADDRESS AND PHONE NUMBER OF THE CONTRACTOR. THE CONTRACTOR SHALL NOTIFY THE REGISTERED UNDERGROUND UTILITY PROTECTION SERVICE AND NON-MEMBER OWNERS OF THE STARTING DATE AT LEAST TWO WORKING DAYS PRIOR TO STARTING WORK. THE UTILITY SHALL MARK, STAKE OR OTHERWISE DESIGNATE THE LOCATION OF THE UNDERGROUND FACILITIES WITHIN 48 HOURS OF RECEIVING THE CONTRACTORS' NOTICE OF A STARTING DATE. THE MARKING OR LOCATING SHALL BE COORDINATED TO STAY APPROXIMATELY TWO DAYS AHEAD OF THE PLANNED CONSTRUCTION.

DURING CONSTRUCTION, THE CONTRACTOR SHALL REPORT IMMEDIATELY TO THE OWNERS OF THE UNDERGROUND FACILITIES ANY BREAK OR LEAK IN THE FACILITIES, OR ANY DENT, GOUGE, GROOVE OR OTHER DAMAGE. THE CONTRACTOR SHALL NOTIFY NEARBY OCCUPANTS OF ANY EMERGENCY SITUATION THAT MAY ARISE.

THE CONTRACTOR SHALL BE RESPONSIBLE FOR COORDINATING ALL UTILITY ACTIVITIES AND SCHEDULES.

ALL UTILITY RELOCATIONS AND/OR ADJUSTMENTS SHALL BE COORDINATED BETWEEN CONTRACTOR AND THE UTILITY OWNERS IN SUCH A WAY AS TO AVOID AND/OR MINIMIZE ANY INCONVENIENCE TO POTENTIALLY AFFECTED CUSTOMERS. UPON THE CONTRACT AWARD, THE COORDINATION OF ALL NECESSARY UTILITY RELOCATIONS AND/OR ADJUSTMENTS SHALL BECOME THE RESPONSIBILITY OF THE CONTRACTOR.

MSD HAS EXISTING FACILITIES WITHIN THE CONSTRUCTION LIMITS OR PROJECT AREA THAT WILL STAY IN PLACE AND IN SERVICE. TO SCHEDULE AN MSD INSPECTOR, THE CONTRACTOR SHALL CONTACT RAY SCHORK OF MSD WVE INSPECTIONS AT 513.244.5537 OR MSDWVEINSPECTIONS@CINCINNATI-OH.GOV A MINIMUM OF FIVE (5) BUSINESS DAYS BEFORE STARTING CONSTRUCTION ON OR NEAR MSD SEWERS, INCLUDING ANY MANHOLE ADJUSTMENTS REQUIRED FOR THE PROJECT. MANHOLE ADJUSTMENTS MUST BE MADE PER MSD STANDARD DRAWING ACCESSION NOS. 49058 OR 49058-A

- 49058: SANITARY MANHOLE ADJUSTMENT USING BRICK AND MORTAR PRIOR TO MACHINE PAVING
49058-A: SANITARY MANHOLE ADJUSTMENT WITH PRECAST CONCRETE RING AND MORTAR PRIOR TO MACHINE PAVING


COORDINATION WITH GCWW THE CONTRACTOR SHALL CONTACT MIKE LAWSON, SUPERVISOR OF INSPECTION, AT 591-7870 A MINIMUM OF TWO (2) BUSINESS DAYS PRIOR TO THE START OF THE WORK INCLUDED ON THE GCWW CONSTRUCTION DRAWINGS.

SYMBOL LEGEND


Table with 3 columns: Symbol, Description, and Proposed/Existing Item. Includes symbols for gas lines, electric, water, storm sewers, fences, and various utility markers.

Table with 3 columns: Symbol, Description, and Proposed/Existing Item. Includes symbols for flagpoles, mailboxes, signs, pedestals, ground lights, light poles, electric meters, manholes, cleanouts, catch basins, storm cleanouts, telephone manholes, fire hydrants, water meters, valves, bushes, and survey benchmarks.


Project information block including the Verdantas logo, project name 'EAST KEMPER ROAD IMPROVEMENTS AND SHARED USE PATH, PH. 1', location 'CITY OF SPRINGDALE - HAMILTON COUNTY, OHIO', and sheet details 'PROJECT NO. 242429', 'DISCIPLINE CIVIL', 'SHEET NAME NOTES', 'SHEET 4 OF 47'.

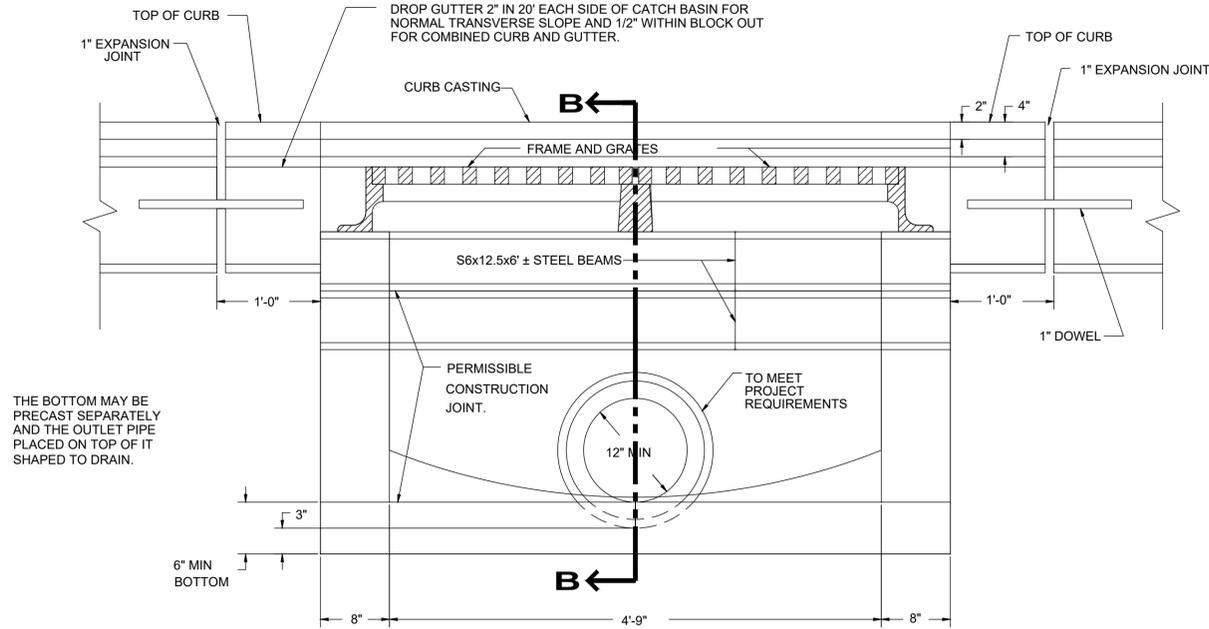


SECTION A-A

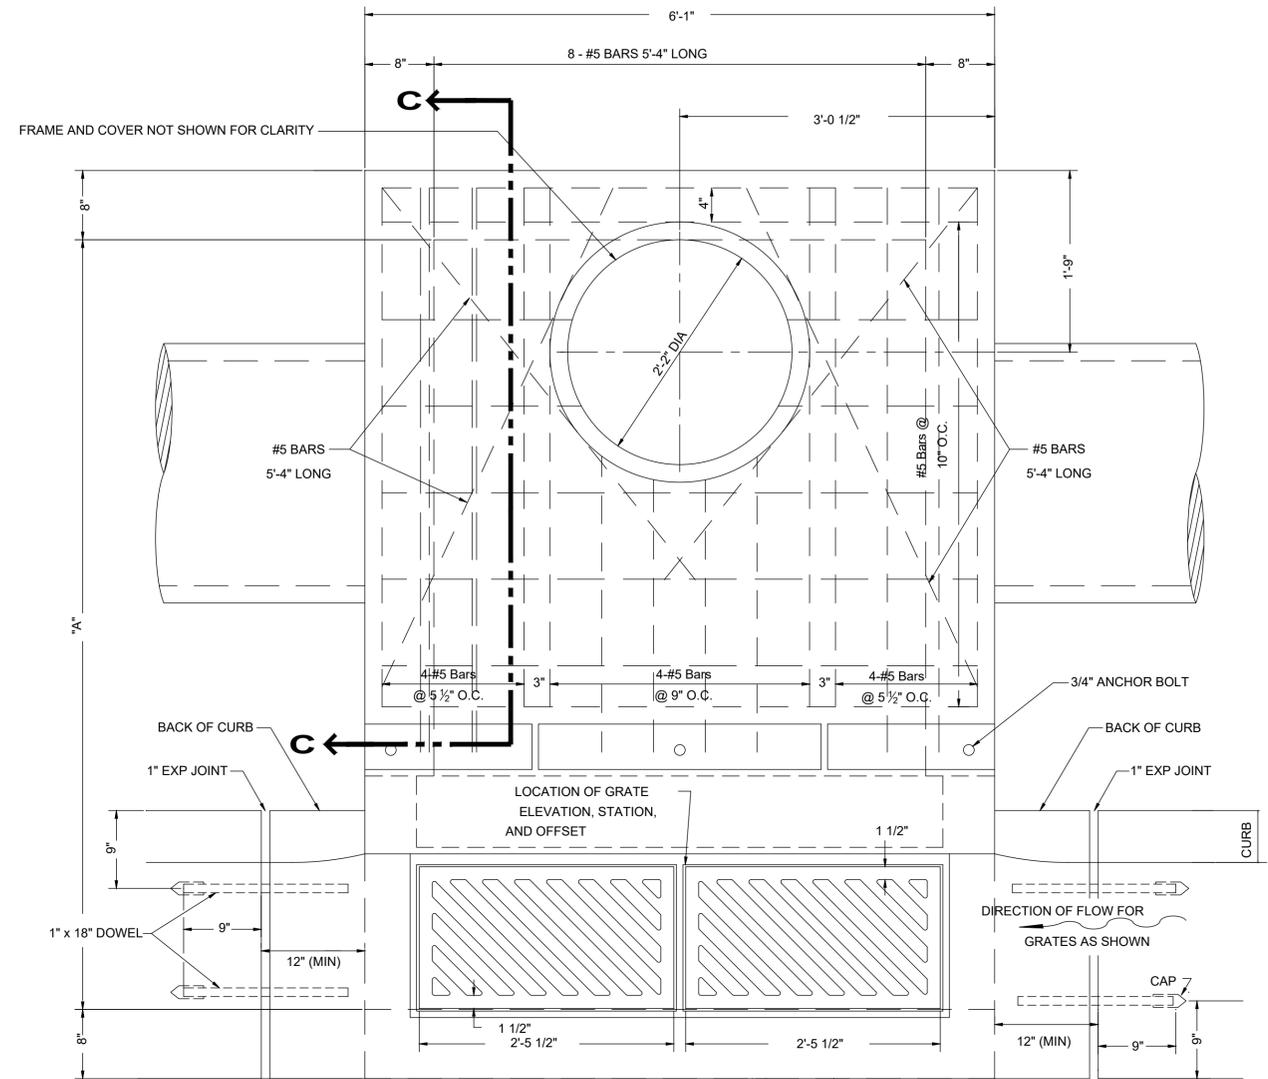


PLAN OF CATCH BASIN AND PAVEMENT JOINTS
* DOWEL LOCATION FOR CURB AND GUTTER

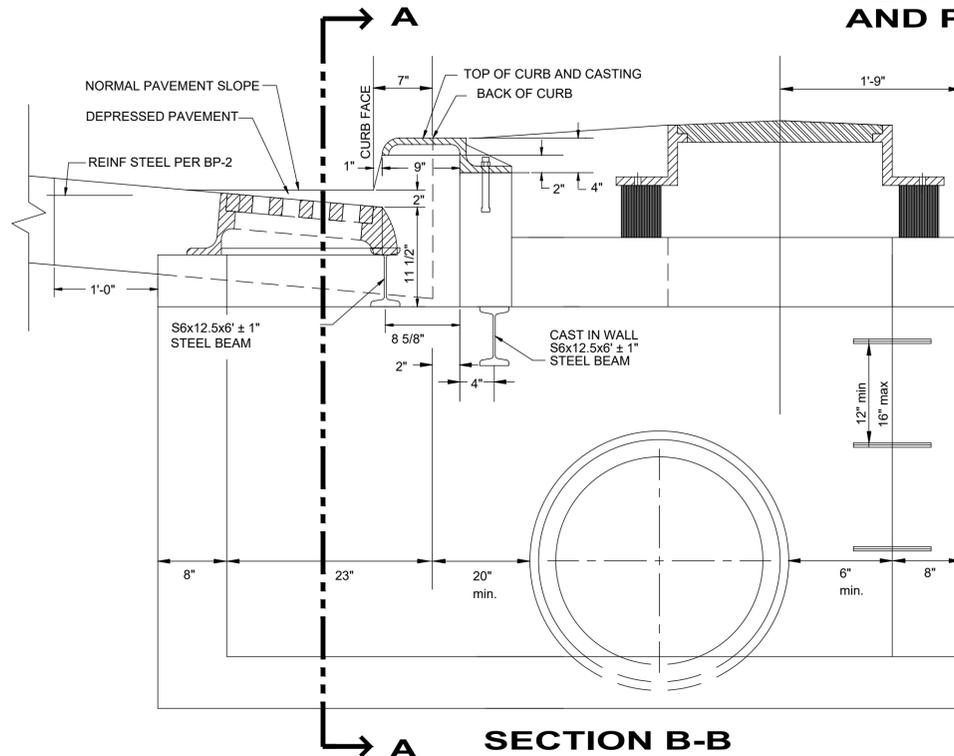

SECTION B-B

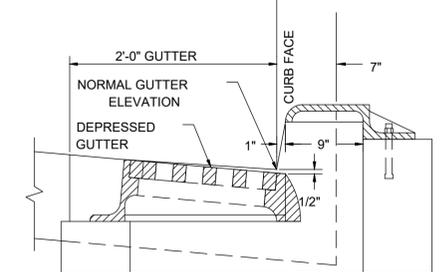

SECTION B-B WITH CURB & GUTTER

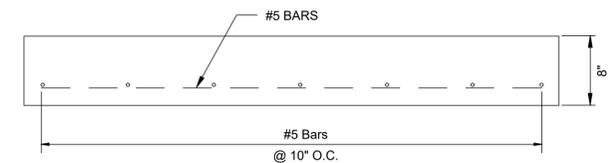

SLAB DETAIL SECTION C-C

NOTES

GRATES: TWO REQUIRED. FOR DETAILS, SEE SCD CB-2.2. GRATE "V" SHALL BE PROVIDED UNLESS THE PLANS SPECIFICALLY REQUIRE THE DIAGONAL GRATE. IF THE DIAGONAL GRATE IS SPECIFIED, IT SHALL BE PLACED SO THAT THE DIAGONAL BARS DIRECT DRAINAGE FLOW TOWARD THE CURB.

CASTINGS: THE DESIGN SHALL BE ESSENTIALLY THE SAME AND CASTINGS: EQUALLY AS STRONG AS SHOWN. MINIMUM WEIGHT [MASS]:

CURB CASTING 305 LBS. [138 KG]
TWO GRATES 254 LBS. [115 KG],
FRAME 590 LBS. [267 KG],
AND TWO GRATE "V" 210 LBS. [95 KG].

LIGHTER WEIGHT FRAMES AND GRATES THAT MEET THE REQUIREMENTS OF CMS 711.14 MAY ALSO BE PROVIDED. GRATE OPENINGS AND DIMENSIONS SHALL NOT DIFFER FROM THOSE SHOWN, UNLESS OTHERWISE SHOWN IN THE PLANS.

THE FOLLOWING TEXT SHALL BE CAST INTO THE TOP OF THE CURB CASTING:

"DUMP NO WASTE" "DRAINS TO WATERWAY"

TEXT SHALL BE PRINTED IN BOLD, CAPITAL LETTERS WITH A MINIMUM HEIGHT OF 3/4". SEE EXAMPLE ON PLAN & SECTION. "WATERWAY" MAY BE SUBSTITUTED WITH "STREAM", "RIVER", "LAKE", ETC. ACTUAL PLACEMENT AND LOGO MAY VARY PER MANUFACTURER.

BEARING AREAS: THE FRAME AND GRATE SHALL BE SO FITTED AND FINISHED AS TO PROVIDE A FIRM AND EVEN SEAT. NO PROJECTIONS SHALL EXIST ON BEARING AREAS AND THE GRATE SHALL SEAT IN ITS FRAME WITHOUT RACKING.

WALLS: WHEN USED IN PLACE OF CONCRETE, BRICK SIDE WALLS SHALL BE 8" [200] NOMINAL THICKNESS.

PRECAST CONSTRUCTION: PERMITTED, EXCEPT FOR THE APRON. CONCRETE SHALL MEET REQUIREMENTS OF CMS 706.13. PRECAST WALLS SHALL HAVE A MINIMUM THICKNESS OF 6" [150] AND REINFORCING SHALL BE SUFFICIENT TO PERMIT SHIPPING AND PLACEMENT WITHOUT DAMAGE. THE WALL THICKNESS REDUCTION SHALL BE FROM THE OUTSIDE.

MINIMUM DEPTH: THE MINIMUM DEPTH IS PER THE COVER REQUIREMENTS FOR THAT PIPE TYPE.

NOTES (CONT.)

OPENINGS: ANY PIPE OPENINGS GREATER THAN 4" [100] FROM THE OUTSIDE OF THE PIPE TO THE STRUCTURE REQUIRE THE ENGINEER'S APPROVAL. FILL ALL VOIDS PER CMS 604.

DOWELS: FOUR 1"X18" [25X450] DOWELS ARE REQUIRED FOR DOWELS: CONCRETE PAVEMENT OR GUTTER BLOCKOUT. SEE SCD BP-2.2 FOR DOWEL DETAILS.

BLOCKOUT: BLOCKOUTS SHALL BE PAVED WITH CLASS C CON-CRETE IN PCC PAVEMENT OR GUTTER, AND PAID FOR AS PART OF THE PAVEMENT OR GUTTER WITH NO DEDUCTION IN PAVE-MENT, CURB OR GUTTER QUANTITIES BECAUSE OF THE CASTINGS. A CLASS C CONCRETE APRON, THE SIZE OF THE 2'-0" [600] GUTTER BLOCKOUT, SHALL BE CAST-IN-PLACE IN ASPHALT PAVEMENT (NO DOWELS REQUIRED) WITH THE COST INCLUDED IN THE CATCH BASIN BID PRICE. NO DEDUCTION TO BE MADE IN CURB QUANTITIES.

REINFORCING STEEL: ALL REINFORCING STEEL SHALL HAVE 2" CLEAR COVER UNLESS OTHERWISE NOTED.

STEPS: SHALL BE PROVIDED WHERE THE DEPTH EXCEEDS 48" AND SHALL MEET THE REQUIREMENTS OF DRAWING MH-1.

PAYMENT: ALL MATERIALS AND LABOR, INCLUDING EXCAVATION AND BACKFILLING, SHALL BE PAID FOR UNDER ITEM 604 -CATCH BASIN, NO. 3 MODIFIED.


NO	REVISION	DATE

ISSUED FOR:	BID	SRIG
ISSUE DATE:	02/04/2026	
SCALE:	AS NOTED	
DESIGNED BY:	PMAD	
DRAWN BY:	PMAD	
CHECKED BY:		

PROJECT NO.	242429
DISCIPLINE	CIVIL
SHEET NAME	DET3
SHEET	7
OF	47

EAST KEMPER ROAD IMPROVEMENTS AND SHARED USE PATH, PH. 1
CITY OF SPRINGDALE - HAMILTON COUNTY, OHIO

DETAILS 3

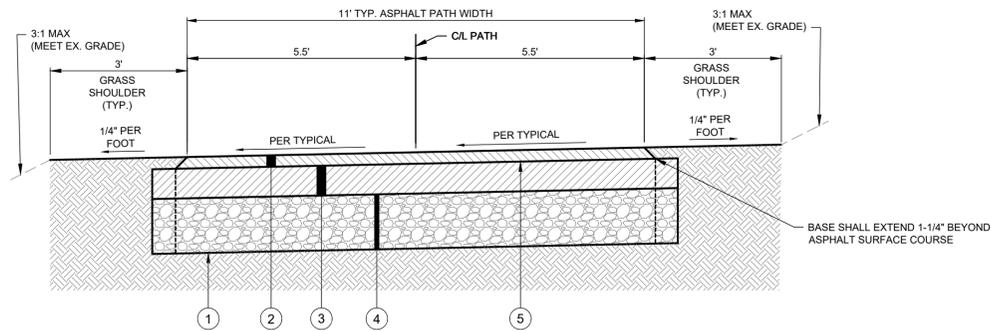


MULTI-USE PATH TYPICAL SECTION
NTS


LEGEND:

- ① ITEM 204 REGRADE, SHAPE, & COMPACT EX. GROUND TO CREATE A LEVEL, UNIFORM SURFACE.
- ② ITEM 441 1-1/4" ASPHALT CONCRETE SURFACE COURSE, TYPE 1 (448), PG64-22
- ③ ITEM 442 3-1/4" ASPHALT CONCRETE INTERMEDIATE COURSE, TYPE 2
- ④ ITEM 304 LIMESTONE AGGREGATE BASE (2 - 3" LIFTS)
- ⑤ ITEM 407 NON-TRACKING TACK COAT

NOTE: ALL CHANGES TO MULTI-USE PATH GEOMETRY SHALL INCORPORATE ROUNDED TRANSITIONS. HARD ANGLES ARE NOTE PERMITTED.

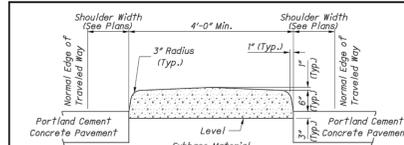


Widths 12'-0" and Less

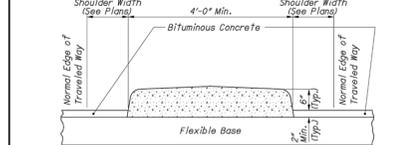


Widths Over 12'-0"

VARIABLE GRADE SEPARATION WITH CURB

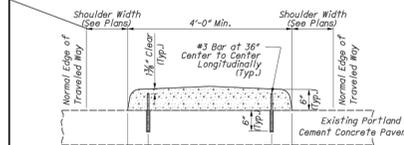

CONCRETE MEDIANS

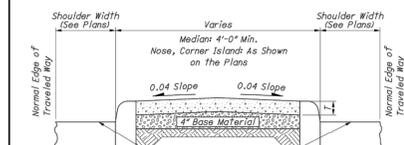


CONCRETE MEDIANS/CORNERS WITH CURB


NOTES
CONCRETE MEDIANS & TRAFFIC ISLANDS: Construct as specified in CMS 609.
ANCHORS AND GROUITS: For median widths of 18" or less, use one line of #3 rebars at 3'-0" on center spacing.
SHOULDER WIDTH: See Location and Design Manual Volume 1 for shoulder width if not specified in the plans.
CONCRETE MEDIAN THICKNESS: Thickness of the median/nose "T" shall be 4" unless otherwise specified in the plans.
DISTANCE TO BREAK: The Distance To Break "W" shall be 2'-6" unless otherwise specified in the plans.
BASE: Thickness of the base shall be 4" and the same material as an adjacent roadway unless otherwise specified in the plans.

LEGEND


- Concrete Median
- Base Material
- Subgrade

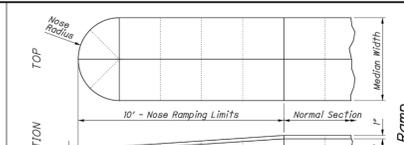

Median Nose Ramp

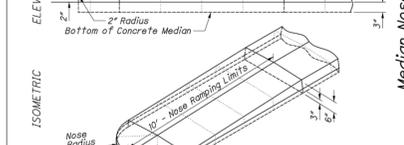

Corner Nose Ramp

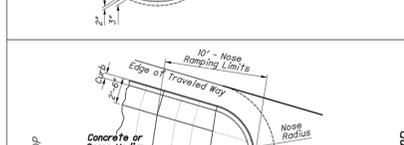

NOSE RAMPING AT APPROACH END OF MEDIAN OR CORNER

PROJECT NO.	242429
DISCIPLINE	CIVIL
SHEET NAME	DET4
SHEET	8
OF	47


verdantas

OFFICE OF PROFESSIONAL ENGINEERING
 REGISTERED PROFESSIONAL ENGINEER
 D. Fisher
 7-20-2018

STANDARD INDUSTRY CONVENTION DRAWING
 TRAFFIC DIVISIONS
 RM-3-1
 THIS DRAWING REPLACES RM-3.1 DATED 7-9-2014.

NO	REVISION	DATE


ISSUED FOR: 02/04/2026
 ISSUE DATE: AE NOTED
 SCALE: PMAD
 DESIGNED BY: PMAD
 DRAWN BY: PMAD
 CHECKED BY: SRIG

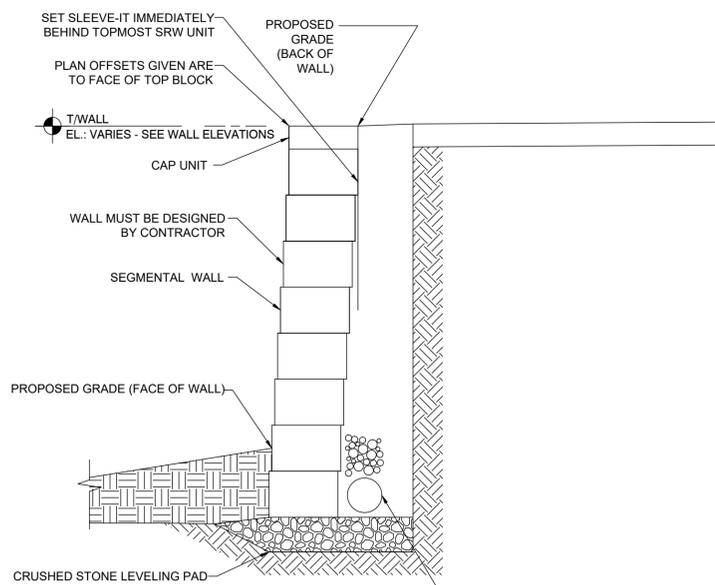


TYPICAL SEGMENTAL WALL SECTION
NTS

NOTES
 ITEM SPECIAL - STRUCTURE, MISC.: MODULAR RETAINING WALL, EXTENSION 530E00600
 SEE SPEC BOOK FOR INFORMATION. THIS IS AN ALL INCLUSIVE BID ITEM BASED ON SQUARE FOOTAGE (SF) OF EXPOSED MODULAR WALL.


NEW SIDEWALK STANDARD SINGLE MAILBOX

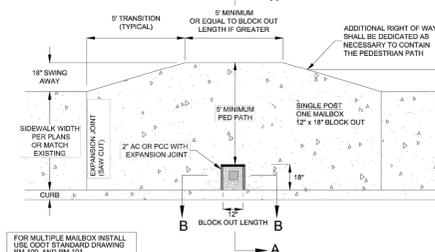

CURB SIDE SIDEWALK

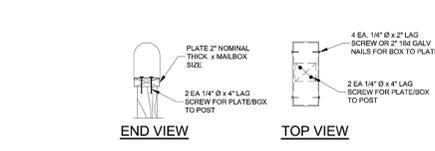





SETBACK SIDEWALK

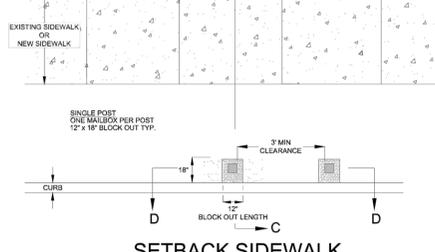

ITEM SPL: NEW MAILBOX & PLACEMENT
NTS















NOTES
 THIS ITEM IS AN ALL INCLUSIVE COST TO REMOVE EXISTING MAILBOX AND PLACE NEW PER ABOVE DETAIL, AND SHALL BE PAID BE EACH (EA).

ITEM 609: CONCRETE MEDIAN
NTS

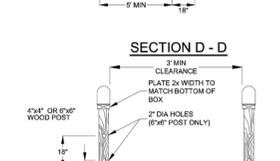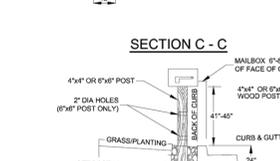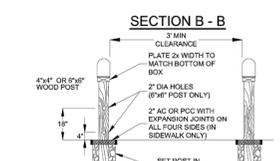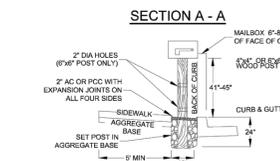

THIS DRAWING HAS BEEN CHECKED FOR CONFORMANCE WITH THE REQUIREMENTS OF THE 2018 INTERNATIONAL BUILDING CODE (IBC) AND THE 2018 INTERNATIONAL PLUMBING AND MECHANICAL CODE (IMC) BY TOLAR MANUFACTURING COMPANY, INC.'S ENGINEERING DEPARTMENT.





- GENERAL NOTES:**
1. ALL STRUCTURAL STEEL, UNLESS OTHERWISE NOTED, SHALL BE ASTM A-36, MINIMUM YIELD STRENGTH 36,000 PSI.
 2. ALL STRUCTURAL ALUMINUM MEMBERS, UNLESS OTHERWISE NOTED, SHALL BE OF ALLOY 6063-T5 OR GREATER.
 3. ALL HOLES TO BE DRILLED OR PUNCHED.
 4. STEEL WELDING SHALL CONFORM TO AMERICAN WELDING SOCIETY STANDARD D1. 1-10. ELECTRODES SHALL CONFORM TO AWS 5.1, CLASS E70S-6.
 5. ALUMINUM WELDING SHALL CONFORM TO AMERICAN WELDING SOCIETY STANDARD D1. 2-08. ELECTRODES SHALL CONFORM TO AWS/ASFA 5.10 CLASS ER4043.
 6. ALL WELDING TO BE DONE AT TOLAR MANUFACTURING COMPANY, INC. FACILITY.
 7. ALL CORPORATE PROCEDURES, INCLUDING FABRICATION, MUST BE IN COMPLIANCE WITH TOLAR MANUFACTURING CO., INC.'S QUALITY CONTROL MANUAL.
 8. MINIMUM 240 HOURS SLAB CURE TIME PRIOR TO ANCHOR INSTALLATION.

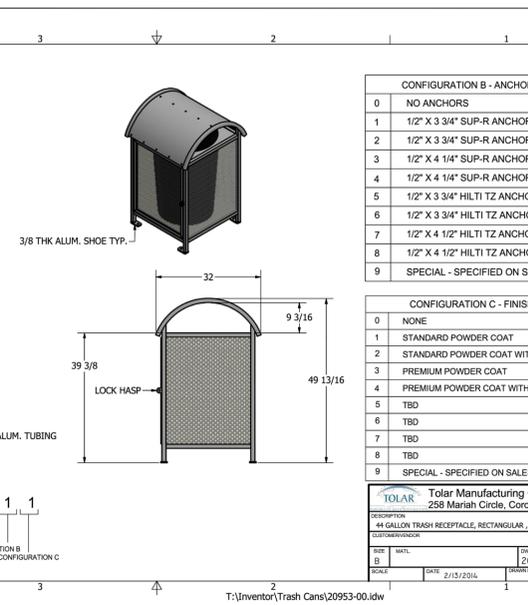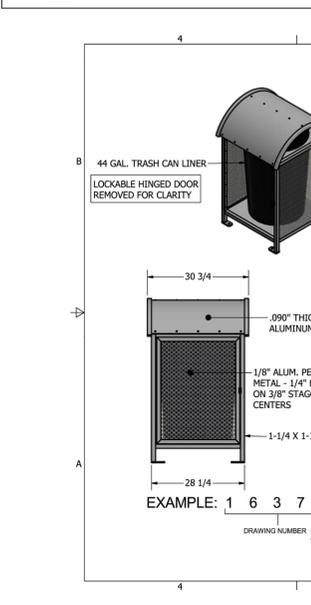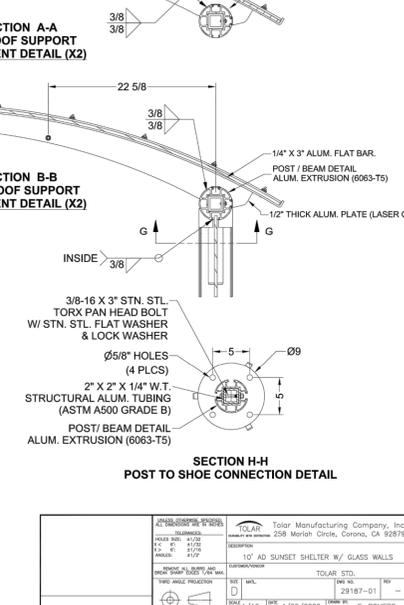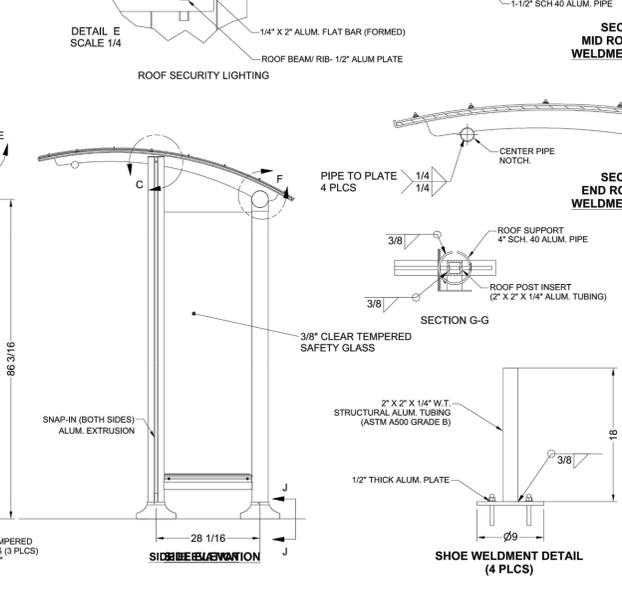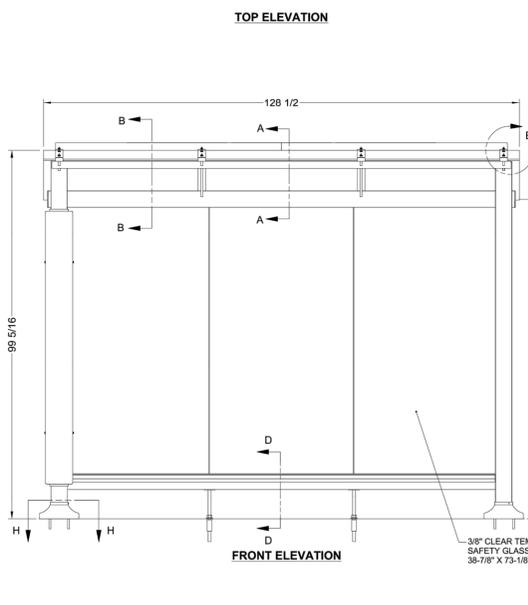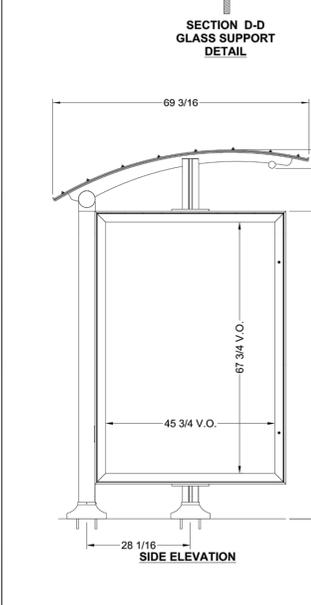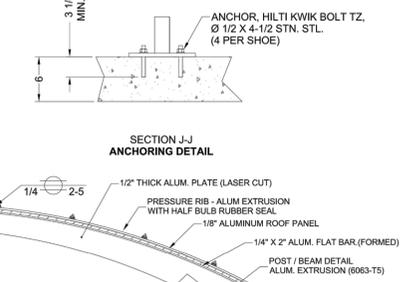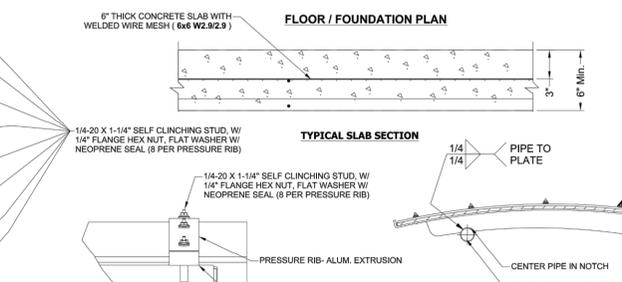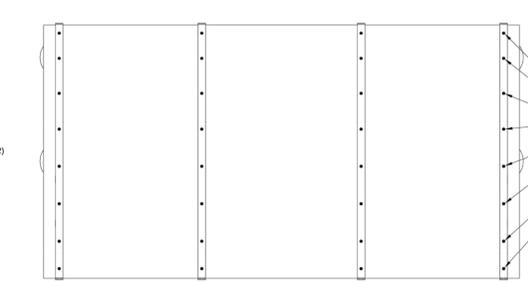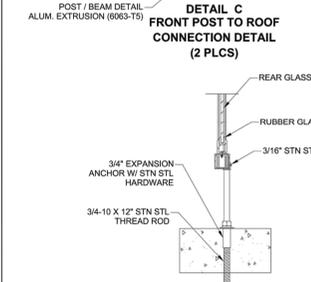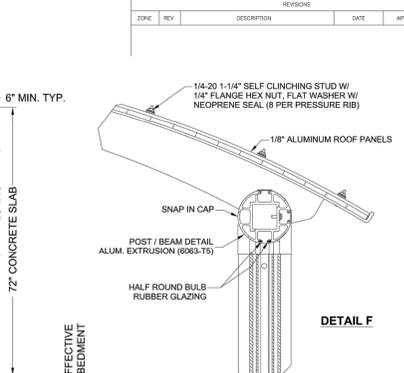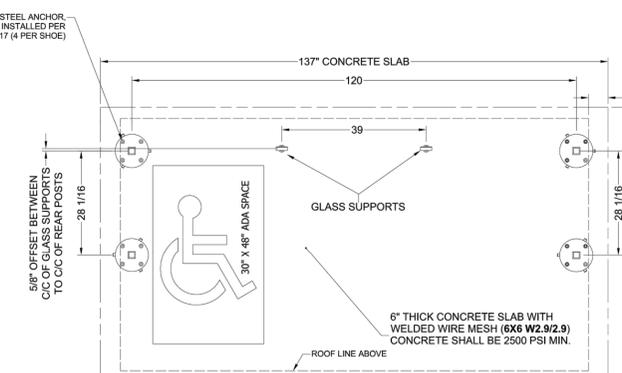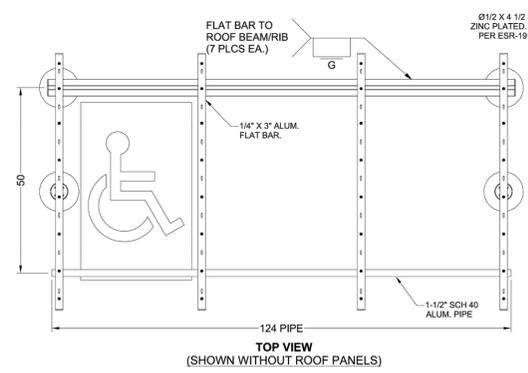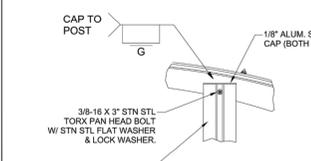

ITEM 690: SPECIAL - REMOVE EXISTING BUS SHELTER, PROVIDE AND INSTALL NEW SHELTER NTS

NOTES

THIS ITEM IS AN ALL INCLUSIVE COST TO REMOVE EXISTING BUS SHELTER AND INSTALL NEW PER DETAILS ON THIS SHEET, AND SPECIFICATIONS PROVIDED IN THE BID DOCUMENTS, AND SHALL BE PAID BE AS A LUMP SUM (LS).

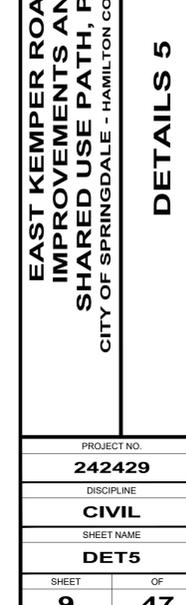
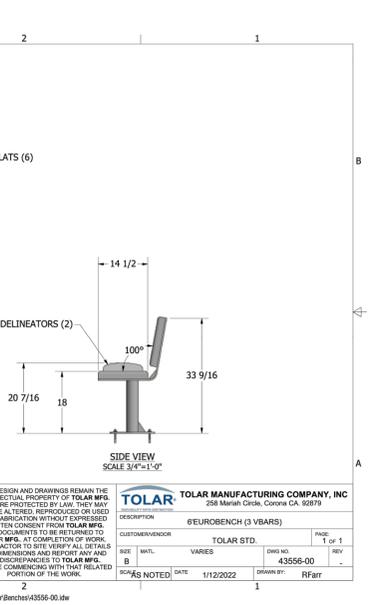
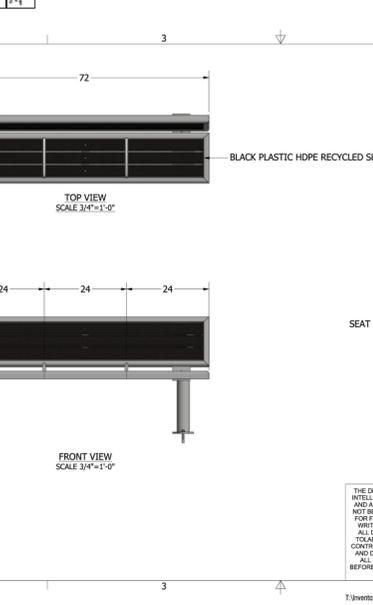
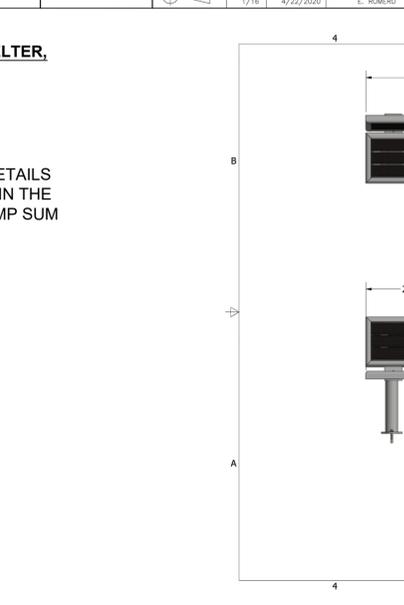


NO	REVISION	DATE

ISSUED FOR:	BID	ISSUE DATE:	SCALE:	DESIGNED BY:	DRAWN BY:	CHECKED BY:
		02/04/2026	AS NOTED	PMAD	PMAD	SRIG

EAST KEMPER ROAD IMPROVEMENTS AND SHARED USE PATH, PH. 1
CITY OF SPRINGDALE - HAMILTON COUNTY, OHIO

PROJECT NO.	242429
DISCIPLINE	CIVIL
SHEET NAME	DET5
SHEET	9
OF	47

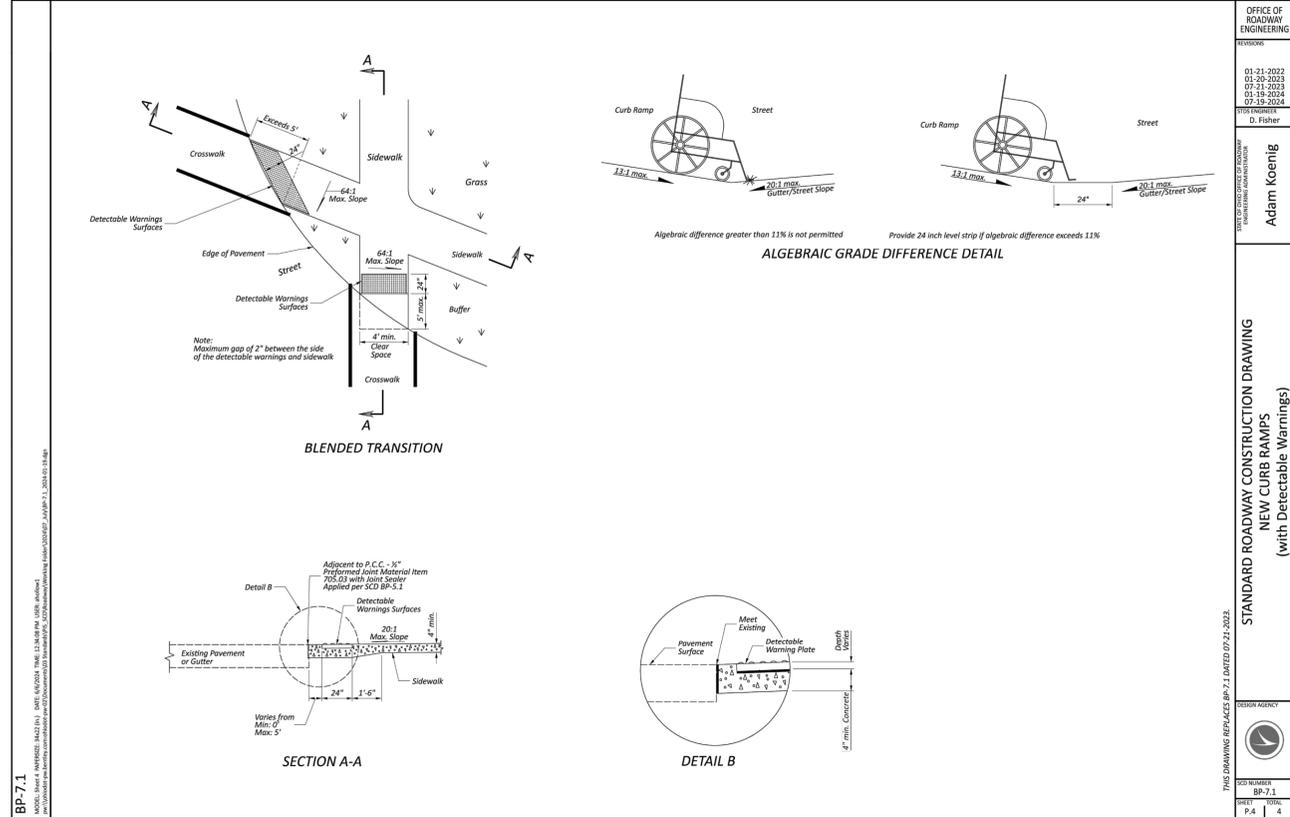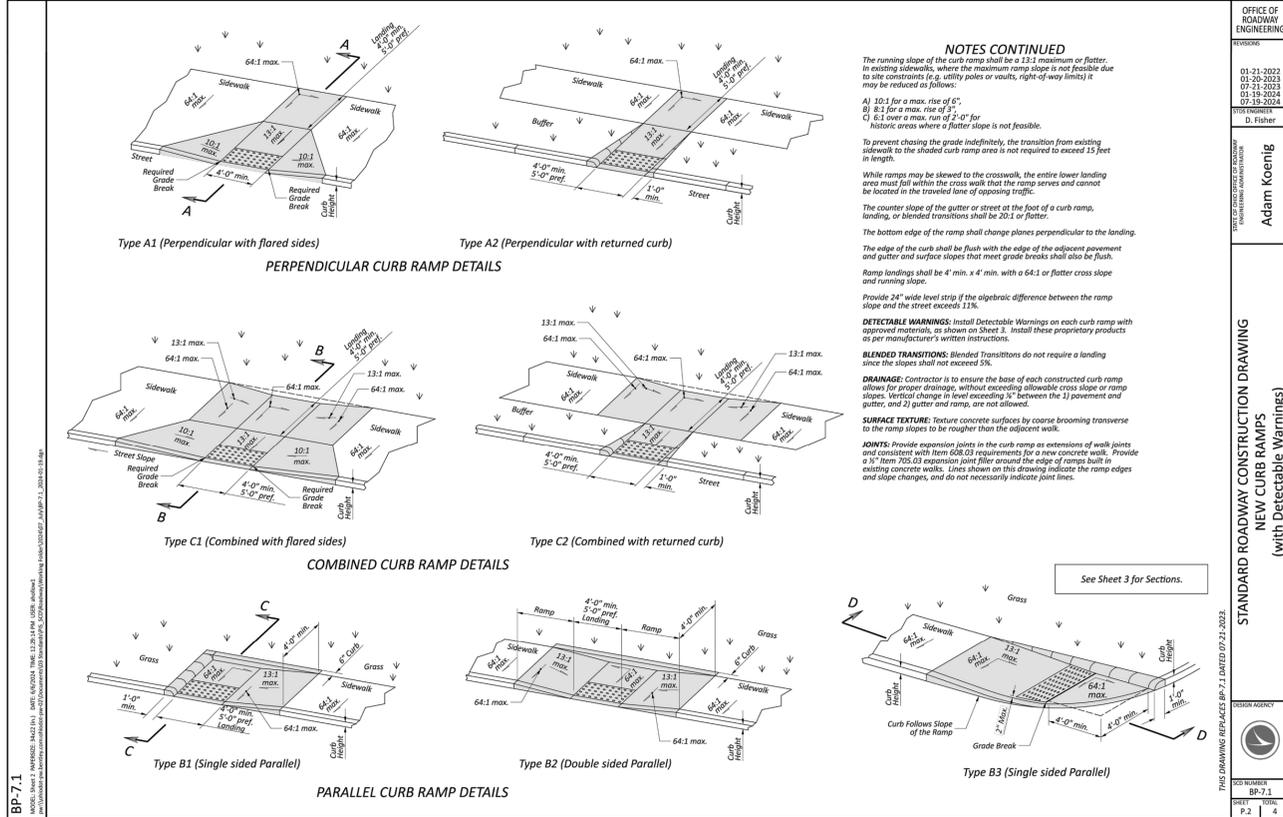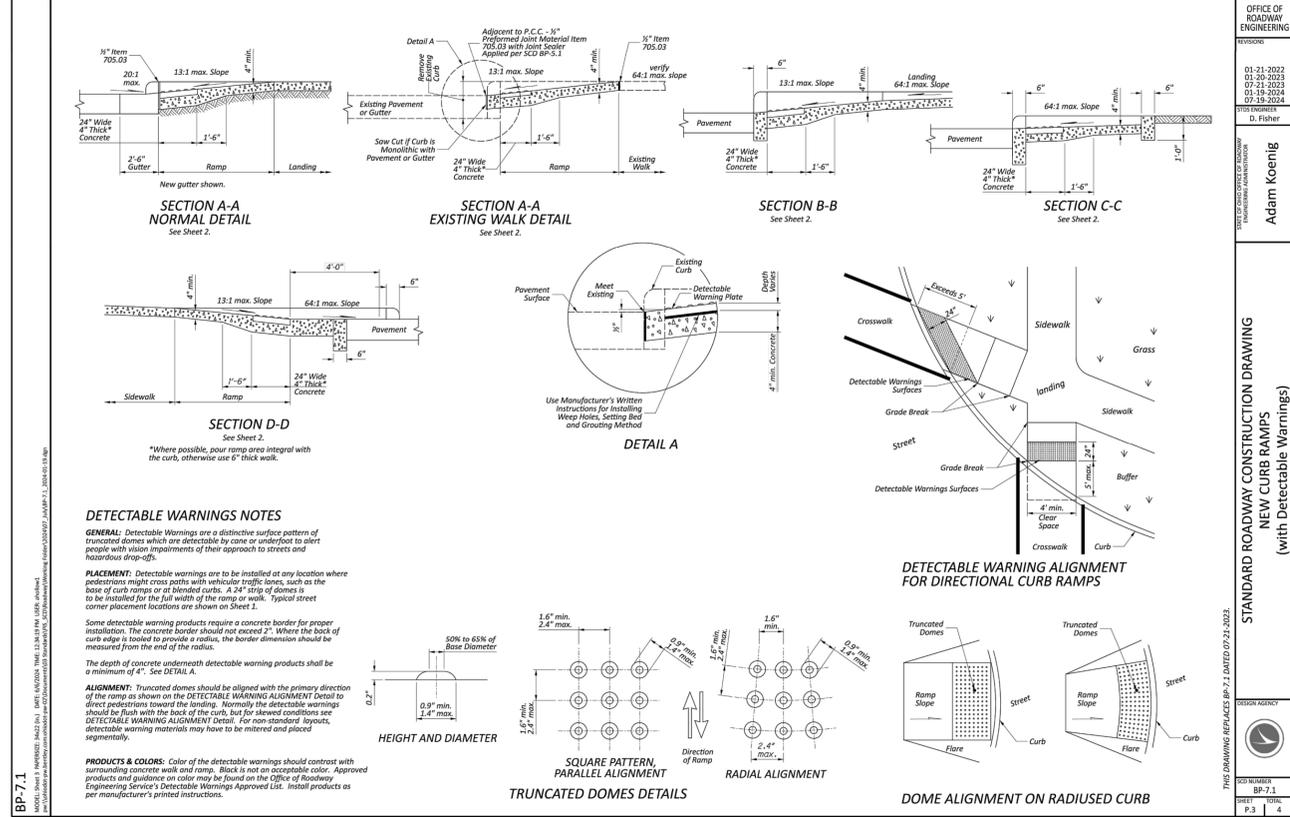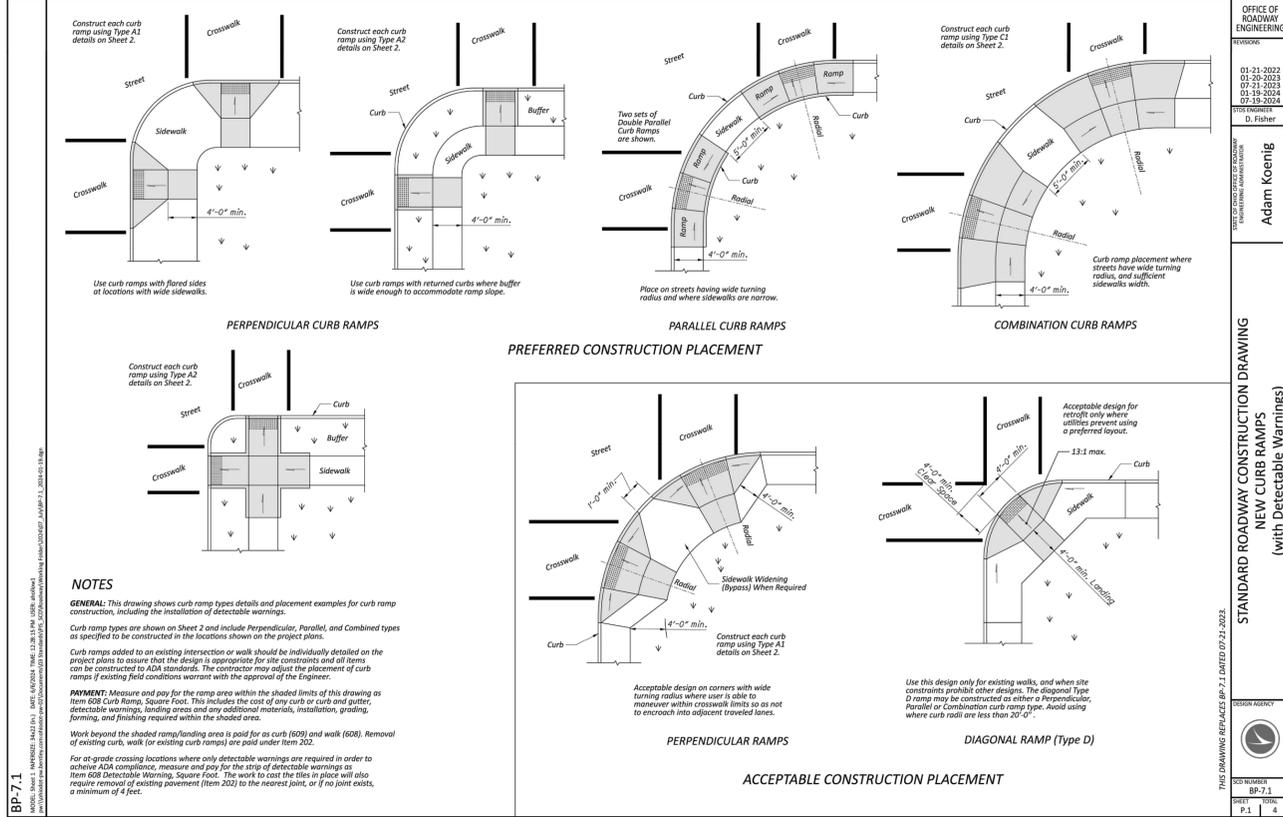

BP-7.1

MODEL: BENCH: INVENTORY: BACED (N) DATE: 6/20/24 TIME: 12:29:24 PM USER: AWH/STW
 LAYOUT: BENCH: INVENTORY: BACED (N) DATE: 6/20/24 TIME: 12:29:24 PM USER: AWH/STW
 LAYOUT: BENCH: INVENTORY: BACED (N) DATE: 6/20/24 TIME: 12:29:24 PM USER: AWH/STW

OFFICE OF ROADWAY ENGINEERING

REVISIONS:

01-21-2022
 01-26-2023
 03-13-2023
 03-19-2024
 07-19-2024

DESIGNED BY: D. FISHER

ADAM KOENIG

STANDARD ROADWAY CONSTRUCTION DRAWING
 NEW CURB RAMPS
 (with Detectable Warnings)

DATE OF REVISION OF DRAWING: 07/21/2023

DESIGN AGENCY:

CD NUMBER: BP-7.1

SHEET: P.2 TOTAL: 4

BP-7.1

MODEL: BENCH: INVENTORY: BACED (N) DATE: 6/20/24 TIME: 12:29:24 PM USER: AWH/STW
 LAYOUT: BENCH: INVENTORY: BACED (N) DATE: 6/20/24 TIME: 12:29:24 PM USER: AWH/STW
 LAYOUT: BENCH: INVENTORY: BACED (N) DATE: 6/20/24 TIME: 12:29:24 PM USER: AWH/STW

OFFICE OF ROADWAY ENGINEERING

REVISIONS:

01-21-2022
 01-26-2023
 03-13-2023
 03-19-2024
 07-19-2024

DESIGNED BY: D. FISHER

ADAM KOENIG

STANDARD ROADWAY CONSTRUCTION DRAWING
 NEW CURB RAMPS
 (with Detectable Warnings)

DATE OF REVISION OF DRAWING: 07/21/2023

DESIGN AGENCY:

CD NUMBER: BP-7.1

SHEET: P.2 TOTAL: 4

verdantas

EAST KEMPER ROAD IMPROVEMENTS AND SHARED USE PATH, PH. 1

CITY OF SPRINGDALE - HAMILTON COUNTY, OHIO

DETAILS 6

NO	DATE	REVISION

ISSUED FOR:	BID	NO	DATE

PROJECT NO.	DISCIPLINE	SHEET NAME
242429	CIVIL	DET6

ISSUE DATE:	SCALE:	DESIGNED BY:	DRAWN BY:	CHECKED BY:
02/04/2026	AS NOTED	PMAD	PMAD	SRIG


SHEET	OF
10	47



LEGEND & KEYNOTES

- 3" PAVEMENT PLANNING AND OVERLAY - SEE TYPICAL SECTION, SHEET 2
- ASPHALT SHARED USE PATH
- ASPHALT DRIVEWAY REMOVAL AND REPLACEMENT, AS PER PLAN
- *NON REINFORCED CONCRETE PAVEMENT, MISC. 1" PLAN PORTLAND CEMENT CONCRETE DRIVEWAY REMOVAL & REPLACEMENT, AS PER PLAN
- SIDEWALK REMOVED
- 5" CONCRETE SIDEWALK
- 5" CONCRETE WALK REMOVE & REPLACE
- 11" CONCRETE BUS PAD, SEE DETAIL
- DETECTABLE WARNINGS
- GRADING LIMITS
- TEMPORARY EASEMENT
- PR WATER (SEE GCWW PLANS)

- 1 EXISTING TO BE REMOVED
- 2 ADJUST TO GRADE
- 3 TO BE RELOCATED (BY OTHERS)
- 4 COMBINATION CURB AND GUTTER, TYPE 2, APP
- 5 CURB, TYPE 7, AS PER PLAN
- 6 CURB, TYPE 6
- 7 DO NOT DISTURB
- 8 MODULAR RETAINING WALL
- 9 CONVERT EX CB TO MH, SEE SHEET 6
- 10 DRAINAGE STRUCTURE, MISC.: CONVERT EX DB OUTLET STRUCTURE TO MH AND ADD PR. DETENTION BASIN OUTLET STRUCTURE (CB2-4)
- 11 CURB SHALL BE REPLACED TO MATCH EX WHERE SIDEWALK IS BEING REMOVED AND ALSO ALONG NEW DRIVE APRON TO MATCH EXISTING ENTRANCE. COST FOR SAID WORK SHALL BE INCIDENTAL TO THE CONTRACT
- 12 ITEM 625 PULL BOX, 725.08 24" & CONDUIT, 2', 725.051. -PROVIDE AND INSTALL NEW SERVICE METER AND REQUIRED WIRING. THE COST FOR THIS WORK SHALL BE INCIDENTAL TO ITEM 625.
- 13 ITEM SPECIAL - REMOVE EXISTING BUS SHELTER, PROVIDE AND INSTALL NEW SHELTER
- 14 ITEM 609 CONCRETE MEDIAN
- 15 CONNECT 6" CPP TO UNDERDRAIN

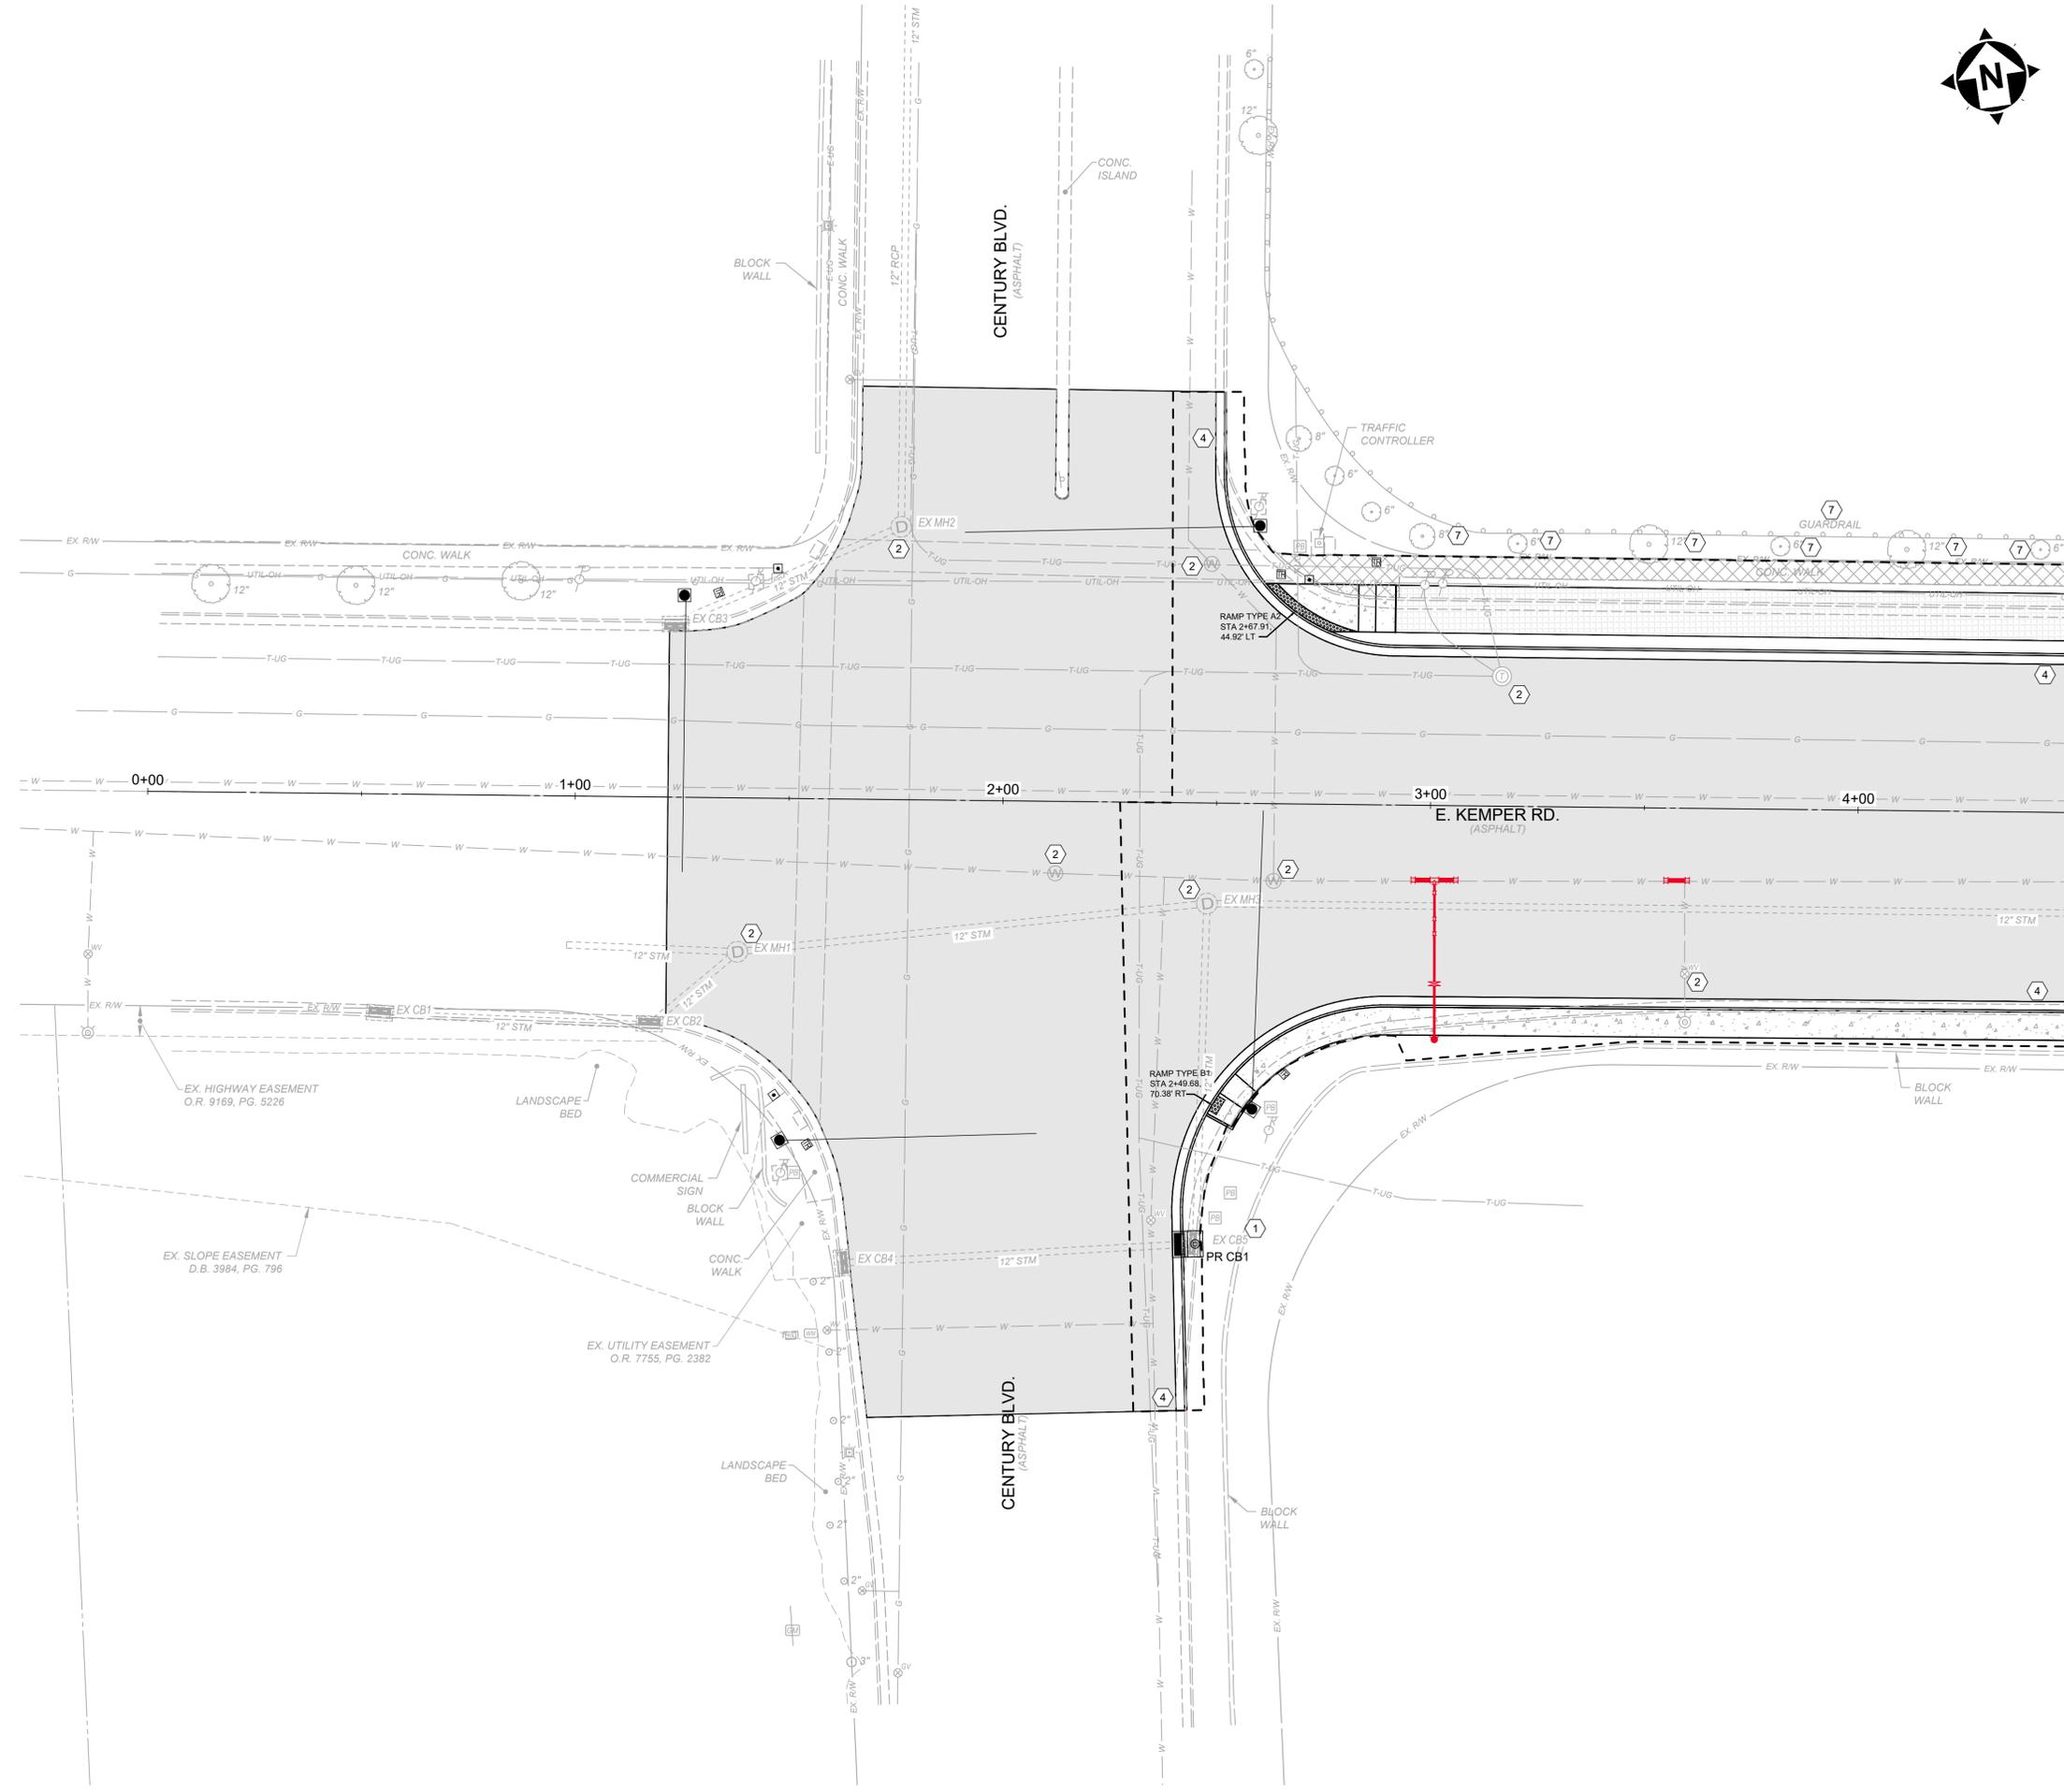

MATCHLINE 4+50

STRUCTURE TABLE	
STRUCTURE NAME:	DETAILS:
EX CB1, ODOT CB-3 STA. 0+54.78, 51.3' R	T/G = 710.39 INV 12" (E) = 707.16
EX CB2, ODOT CB-3 STA. 1+17.89, 53.2' R	T/G = 710.18 INV 12" (W) = 706.85 INV 12" (NE) = 706.68
EX CB3, ODOT CB-3 STA. 1+22.96, -40.7' L	T/G = 708.88 INV 12" (E) = 705.98
EX CB4, ODOT CB-3 STA. 1+63.30, 108.2' R	T/G = 713.61 INV 12" (E) = 711.16
EX CB5, ODOT CB-3 STA. 2+46.17, 102.8' R	T/G = 713.08 INV 12" (W) = 710.48 INV 12" (N) = 710.08
EX MH1, ODOT MH-3 STA. 1+38.27, 35.9' R	T/G = 709.96 INV 12" (SW) = 705.82 INV 12" (W) = 705.82 INV 12" (E) = 705.82
EX MH2, ODOT MH-3 STA. 1+75.53, -63.6' L	T/G = 706.61 INV 12" (W) = 702.82 INV 12" (N) = 702.82
EX MH3, ODOT MH-3 STA. 2+47.98, 23.4' R	T/G = 706.68 INV 12" (S) = 701.40 INV 12" (W) = 701.40 INV 12" (E) = 701.40
PR CB1, ODOT CB-3, MOD. STA. 2+42.78, 102.97' RT	T/G = 713.17 INV 12" (W) = 710.50 INV 12" (N) = 710.08



DATE	REVISION	NO	BID	ISSUED FOR:	ISSUE DATE:	SCALE:	DESIGNED BY:	DRAWN BY:	CHECKED BY:
			02/04/2026		02/04/2026	1"=20'	PMAD	PMAD	SRIG

EAST KEMPER ROAD IMPROVEMENTS AND SHARED USE PATH, PH. 1
 CITY OF SPRINGDALE - HAMILTON COUNTY, OHIO
PLAN


PROJECT NO.	242429
DISCIPLINE	CIVIL
SHEET NAME	PL1
SHEET	11
OF	47



LEGEND & KEYNOTES

- 3" PAVEMENT PLANNING AND OVERLAY - SEE TYPICAL SECTION, SHEET 2
- ASPHALT SHARED USE PATH
- ASPHALT DRIVEWAY REMOVAL AND REPLACEMENT, AS PER PLAN
- *NON REINFORCED CONCRETE PAVEMENT, MISC.: 9" PLAN PORTLAND CEMENT CONCRETE DRIVEWAY REMOVAL & REPLACEMENT, AS PER PLAN
- SIDEWALK REMOVED
- 5" CONCRETE SIDEWALK
- 5" CONCRETE WALK REMOVE & REPLACE
- 11" CONCRETE BUS PAD, SEE DETAIL
- DETECTABLE WARNINGS
- GRADING LIMITS
- TEMPORARY EASEMENT
- PR WATER (SEE GCWW PLANS)

- 1 EXISTING TO BE REMOVED
- 2 ADJUST TO GRADE
- 3 TO BE RELOCATED (BY OTHERS)
- 4 COMBINATION CURB AND GUTTER, TYPE 2, APP
- 5 CURB, TYPE 7, AS PER PLAN
- 6 CURB, TYPE 6
- 7 DO NOT DISTURB
- 8 MODULAR RETAINING WALL
- 9 CONVERT EX CB TO MH, SEE SHEET 6
- 10 DRAINAGE STRUCTURE, MISC.: CONVERT EX DB OUTLET STRUCTURE TO MH AND ADD PR. DETENTION BASIN OUTLET STRUCTURE (CB2-4)
- 11 CURB SHALL BE REPLACED TO MATCH EX WHERE SIDEWALK IS BEING REMOVED AND ALSO ALONG NEW DRIVE APRON TO MATCH EXISTING ENTRANCE. COST FOR SAID WORK SHALL BE INCIDENTAL TO THE CONTRACT
- 12 ITEM 625 PULL BOX, 725 08 24" & CONDUIT, 2', 725.051. -PROVIDE AND INSTALL NEW SERVICE METER AND REQUIRED WIRING. THE COST FOR THIS WORK SHALL BE INCIDENTAL TO ITEM 625.
- 13 ITEM SPECIAL - REMOVE EXISTING BUS SHELTER, PROVIDE AND INSTALL NEW SHELTER
- 14 ITEM 609 CONCRETE MEDIAN
- 15 CONNECT 6" CPP TO UNDERDRAIN

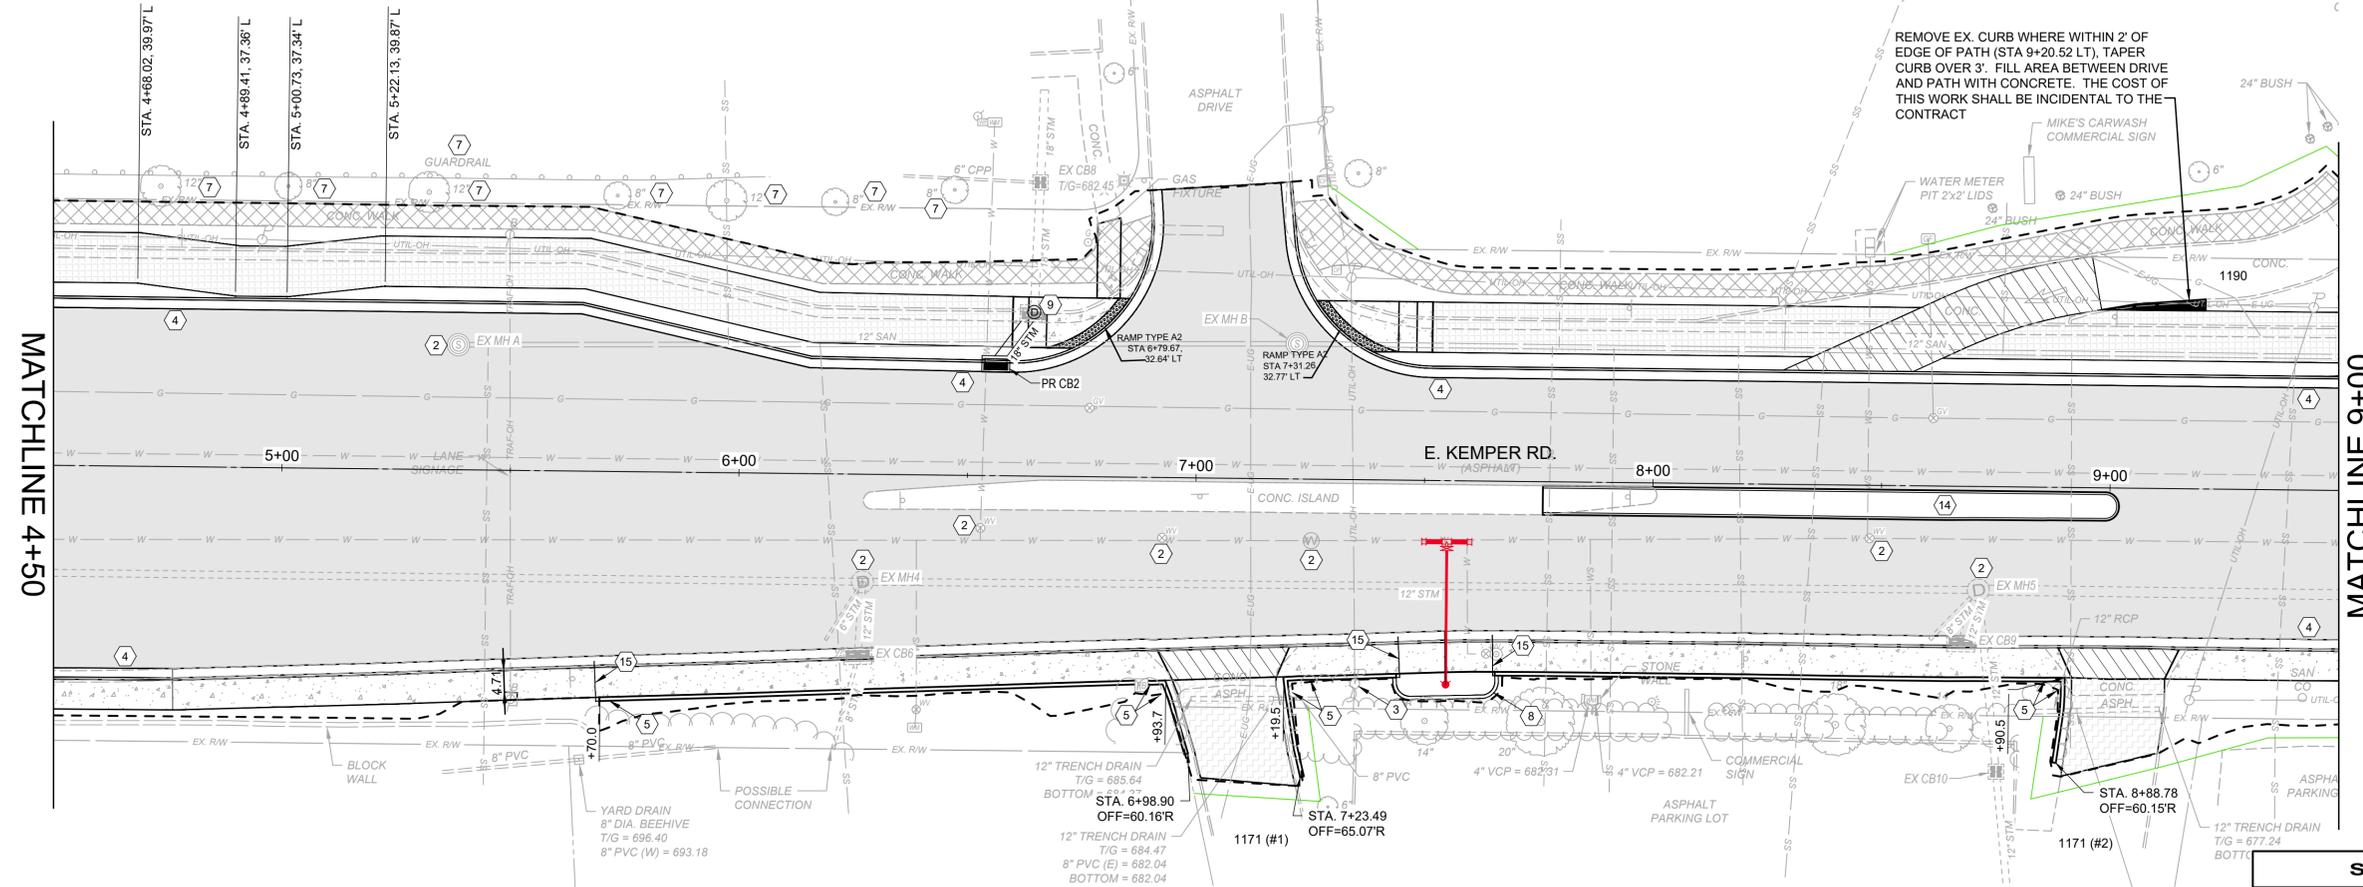

STRUCTURE TABLE	
STRUCTURE NAME:	DETAILS:
EX CB6, ODOT CB-3 STA. 6+26.42, 40.0' R	T/G = 687.42 INV 8" (SW) = 685.32 INV 12" (N) = 684.17
EX CB7 [CONVERT TO PR MH1], ODOT CB-3 STA. 6+64.19, -35.8' L	T/G = 685.22 INV 18" (SW) = 681.97 INV 18" (N) = 681.97
EX CB8, ODOT CB 2-2-B STA. 6+65.25, -64.1' L	T/G = 682.45 INV 18" (S) = 678.35 INV 18" (N) = 678.25
EX CB9, ODOT CB-3 STA. 8+67.70, 34.6' R	T/G = 677.46 INV 12" (NE) = 674.06
EX MH A, SAN MH STA. 5+38.32, -27.3' L	T/G = 691.98 INV 12" (E) = 677.37
EX MH B, SAN MH STA. 7+21.80, -29.5' L	T/G = 683.10 INV 12" (W) = 668.46 INV 12" (E) = 668.46
EX MH4, ODOT MH-3 STA. 6+27.25, 23.5' R	T/G = 687.94 INV 12" (W) = 683.09 INV 6" (SW) = 683.28 INV 12" (S) = 683.85 INV 12" (E) = 683.09
EX MH5, ODOT MH-3 STA. 8+71.40, 22.6' R	T/G = 677.83 INV 12" (S) = 673.92 INV 12" (SW) = 673.50 INV 8" (SW) = 672.73 INV 12" (W) = 672.76 INV 18" (E) = 672.16
PR CB2, ODOT CB-3 STA. 6+55.94, -24.7' L	T/G = 686.27 INV 18" (NE) = 683.27



DATE	REVISION	BID	ISSUED FOR
		02/04/2026	
		1"=20'	
		PMAD	
		PMAD	
		SRIG	

EAST KEMPER ROAD IMPROVEMENTS AND SHARED USE PATH, PH. 1
CITY OF SPRINGDALE - HAMILTON COUNTY, OHIO

PROJECT NO.	242429
DISCIPLINE	CIVIL
SHEET NAME	PL2
SHEET	12
OF	47

MATCHLINE 4+50


MATCHLINE 9+00



LEGEND & KEYNOTES

- 3" PAVEMENT PLANNING AND OVERLAY - SEE TYPICAL SECTION, SHEET 2
- ASPHALT SHARED USE PATH
- ASPHALT DRIVEWAY REMOVAL AND REPLACEMENT, AS PER PLAN
- *NON REINFORCED CONCRETE PAVEMENT, MISC.; 9" PLAN PORTLAND CEMENT CONCRETE DRIVEWAY REMOVAL & REPLACEMENT, AS PER PLAN
- SIDEWALK REMOVED
- 5' CONCRETE SIDEWALK
- 5' CONCRETE WALK REMOVE & REPLACE
- 11" CONCRETE BUS PAD, SEE DETAIL
- DETECTABLE WARNINGS
- GRADING LIMITS
- TEMPORARY EASEMENT
- PR WATER (SEE GCWW PLANS)

- ① EXISTING TO BE REMOVED
- ② ADJUST TO GRADE
- ③ TO BE RELOCATED (BY OTHERS)
- ④ COMBINATION CURB AND GUTTER, TYPE 2, APP
- ⑤ CURB, TYPE 7, AS PER PLAN
- ⑥ CURB, TYPE 6
- ⑦ DO NOT DISTURB
- ⑧ MODULAR RETAINING WALL
- ⑨ CONVERT EX CB TO MH, SEE SHEET 6
- ⑩ DRAINAGE STRUCTURE, MISC.: CONVERT EX DB OUTLET STRUCTURE TO MH AND ADD PR. DETENTION BASIN OUTLET STRUCTURE (CB2-4)
- ⑪ CURB SHALL BE REPLACED TO MATCH EX WHERE SIDEWALK IS BEING REMOVED AND ALSO ALONG NEW DRIVE APRON TO MATCH EXISTING ENTRANCE. COST FOR SAID WORK SHALL BE INCIDENTAL TO THE CONTRACT
- ⑫ ITEM 625 PULL BOX, 725 08 24" & CONDUIT, 2, 725.051. -PROVIDE AND INSTALL NEW SERVICE METER AND REQUIRED WIRING. THE COST FOR THIS WORK SHALL BE INCIDENTAL TO ITEM 625.
- ⑬ ITEM SPECIAL - REMOVE EXISTING BUS SHELTER, PROVIDE AND INSTALL NEW SHELTER
- ⑭ ITEM 609 CONCRETE MEDIAN
- ⑮ CONNECT 6" CPP TO UNDERDRAIN

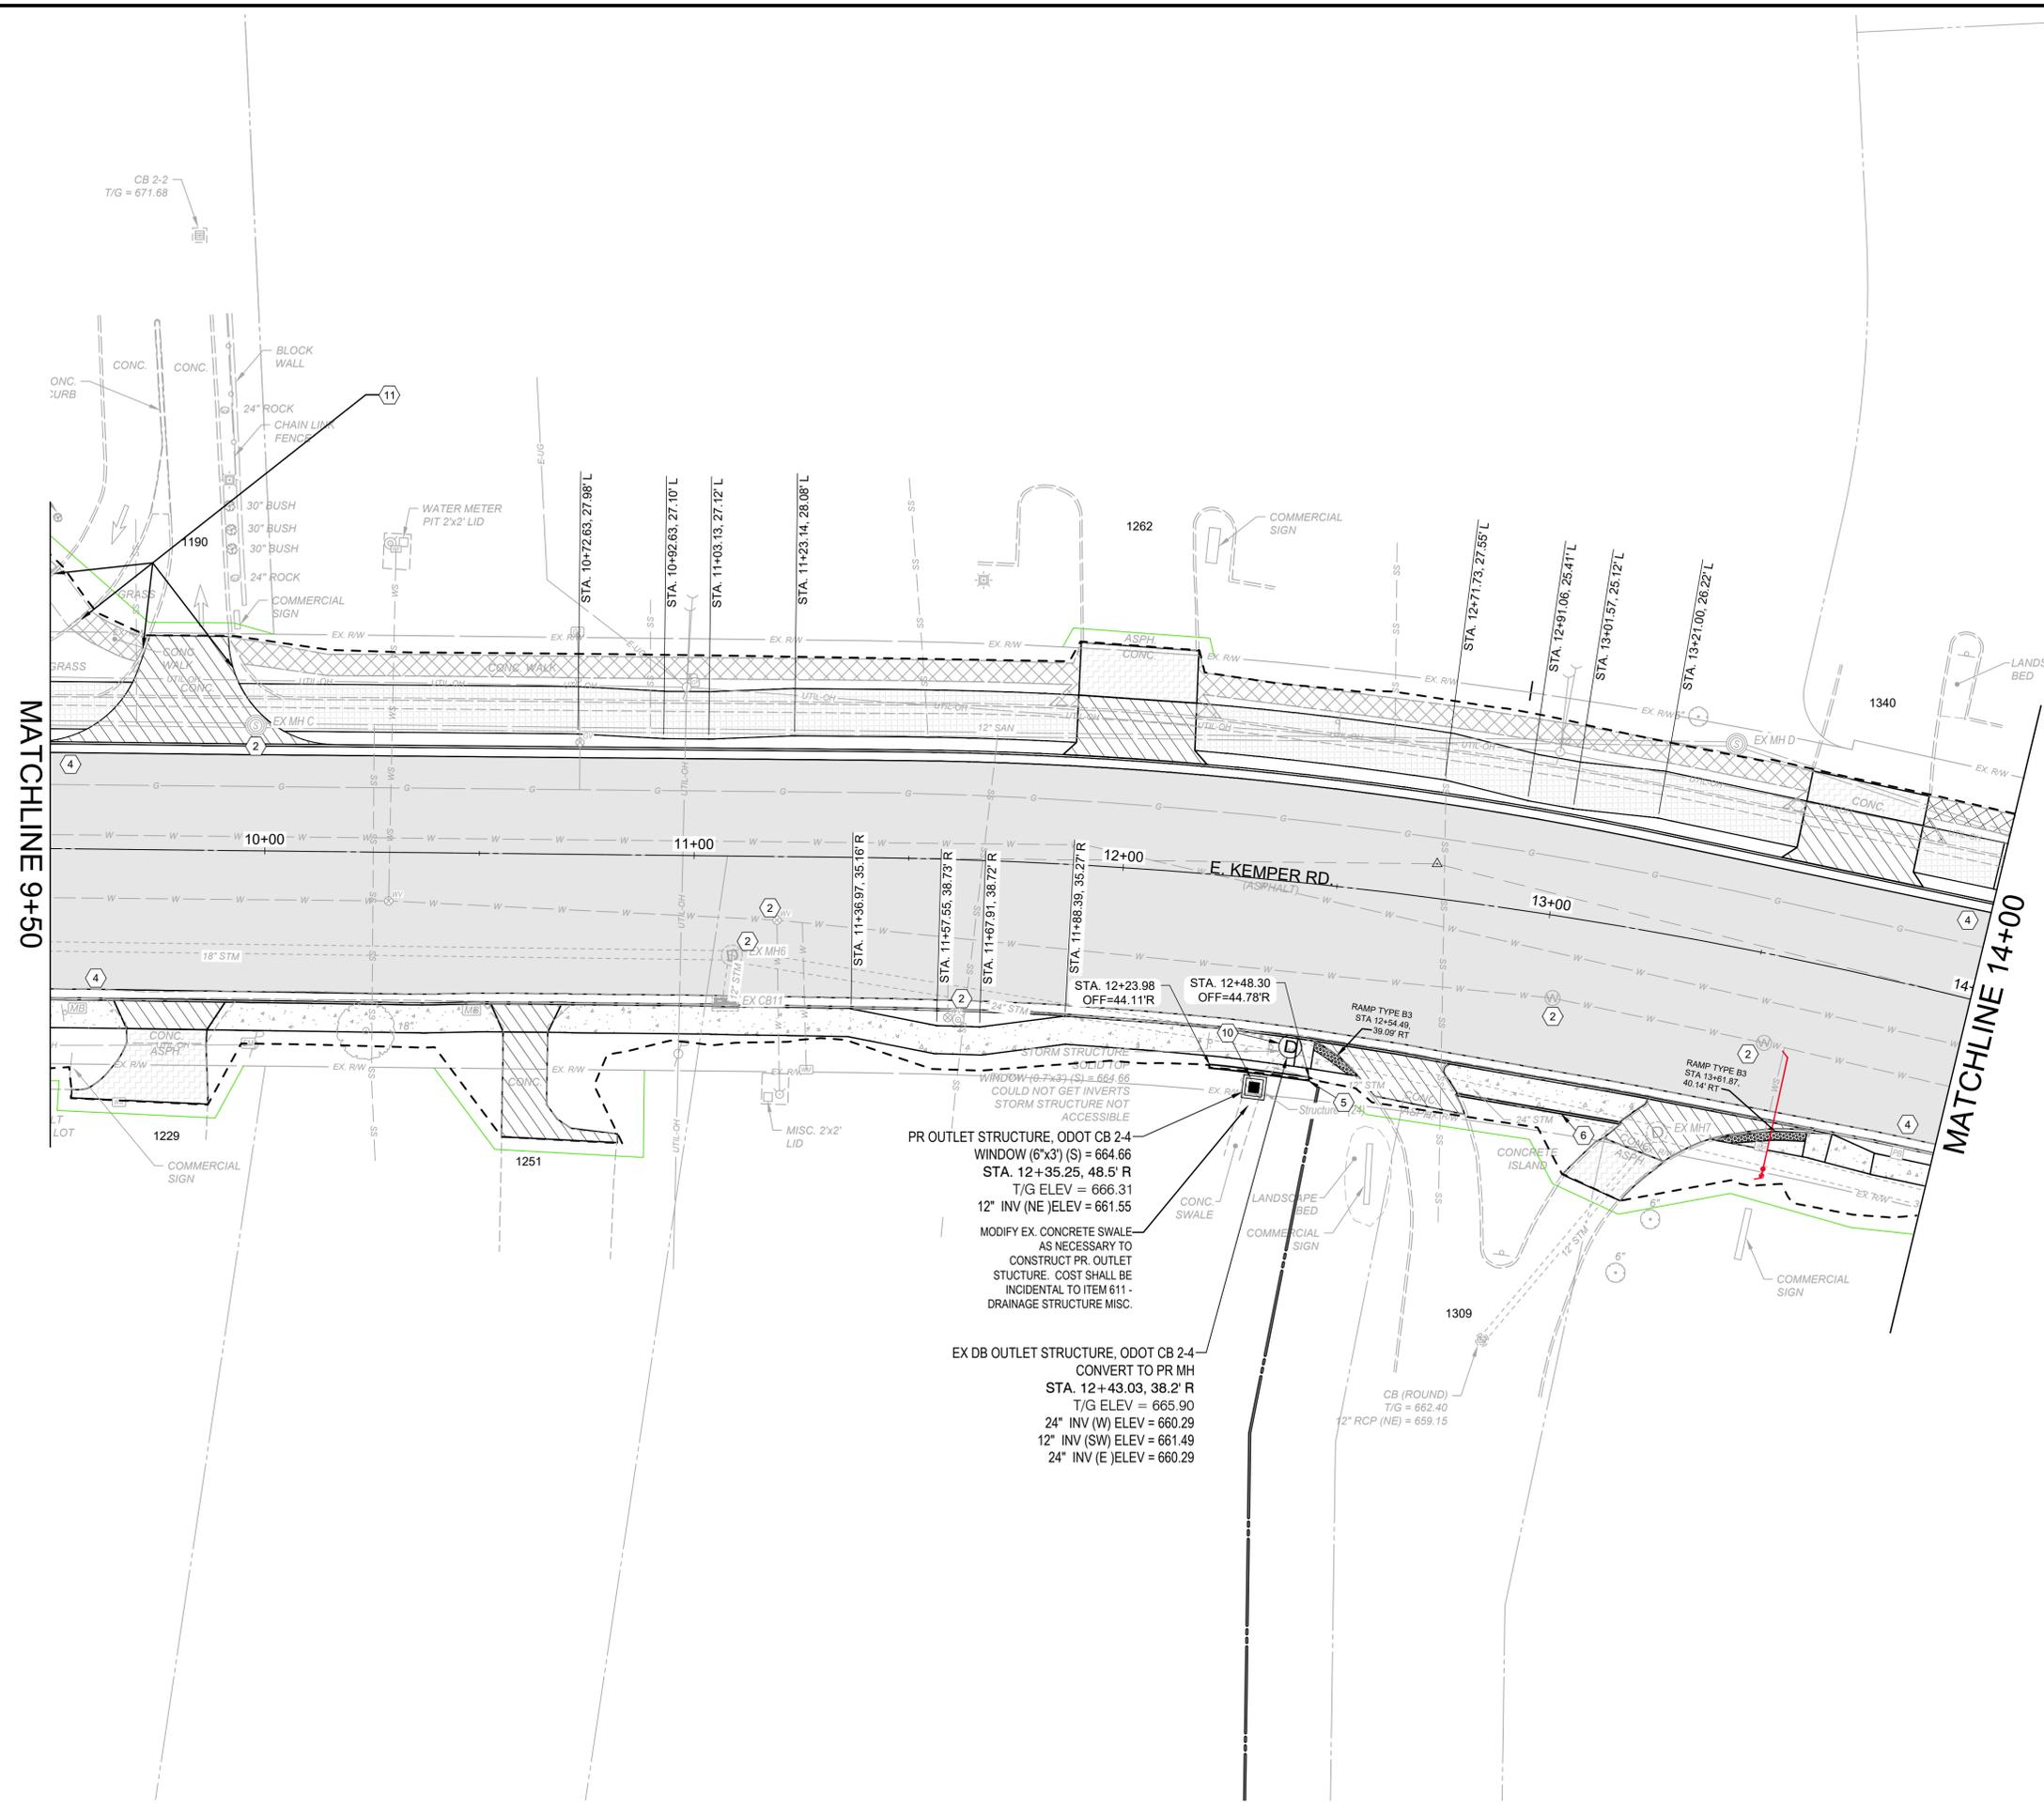

PR OUTLET STRUCTURE, ODOT CB 2-4 WINDOW (6'x3') (S) = 664.66 STA. 12+35.25, 48.5' R T/G ELEV = 666.31 12" INV (NE) ELEV = 661.55
 MODIFY EX. CONCRETE SWALE AS NECESSARY TO CONSTRUCT PR. OUTLET STRUCTURE. COST SHALL BE INCIDENTAL TO ITEM 611 - DRAINAGE STRUCTURE MISC.

EX DB OUTLET STRUCTURE, ODOT CB 2-4 CONVERT TO PR MH STA. 12+43.03, 38.2' R T/G ELEV = 665.90 24" INV (W) ELEV = 660.29 12" INV (SW) ELEV = 661.49 24" INV (E) ELEV = 660.29


STRUCTURE TABLE	
STRUCTURE NAME:	DETAILS:
EX CB11, ODOT CB-3 STA. 11+07.63, 34.5' R	T/G = 669.30 INV 12" (N) = 665.64
EX DB OUTLET STRUCTURE, ODOT CB 2-4 STA. 12+43.03, 38.2' R	T/G = 665.90 INV 24" (W) = 660.29 INV 12" (SW) = 661.49 INV 24" (E) = 660.29
EX MH C, SAN MH STA. 9+97.62, -29.1' L	T/G = 673.55 INV 12" (W) = 662.87 INV 12" (E) = 662.87
EX MH D, SAN MH STA. 13+35.51, -46.4' L	T/G = 661.93 INV 12" (W) = 637.73 INV 12" (SE) = 637.73
EX MH6, ODOT MH-3 STA. 11+09.06, 23.1' R	T/G = 669.84 INV 12" (S) = 665.35 INV 18" (W) = 664.35 INV 24" (E) = 664.35
EX MH7, ODOT MH-3 STA. 13+33.79, 45.7' R	T/G = 662.38 INV 24" (W) = 657.60 INV 12" (SW) = 658.03 INV 30" (E) = 657.38
PR OUTLET STRUCTURE, ODOT CB 2-4 WINDOW (6'x3') (S) = 664.66 STA. 12+35.25, 48.5' R	T/G = 666.31 INV 12" (NE) = 661.55
Structure - (24), ODOT HW-1 STA. 12+35.25, 48.5' R	T/G = 663.30

DATE		REVISION		NO		ISSUED FOR:		ISSUE DATE:		SCALE:		DESIGNED BY:		DRAWN BY:		CHECKED BY:	

EAST KEMPER ROAD IMPROVEMENTS AND SHARED USE PATH, PH. 1
 CITY OF SPRINGDALE - HAMILTON COUNTY, OHIO

PLAN

PROJECT NO.	
242429	
DISCIPLINE	
CIVIL	
SHEET NAME	
PL3	
SHEET	OF
13	47

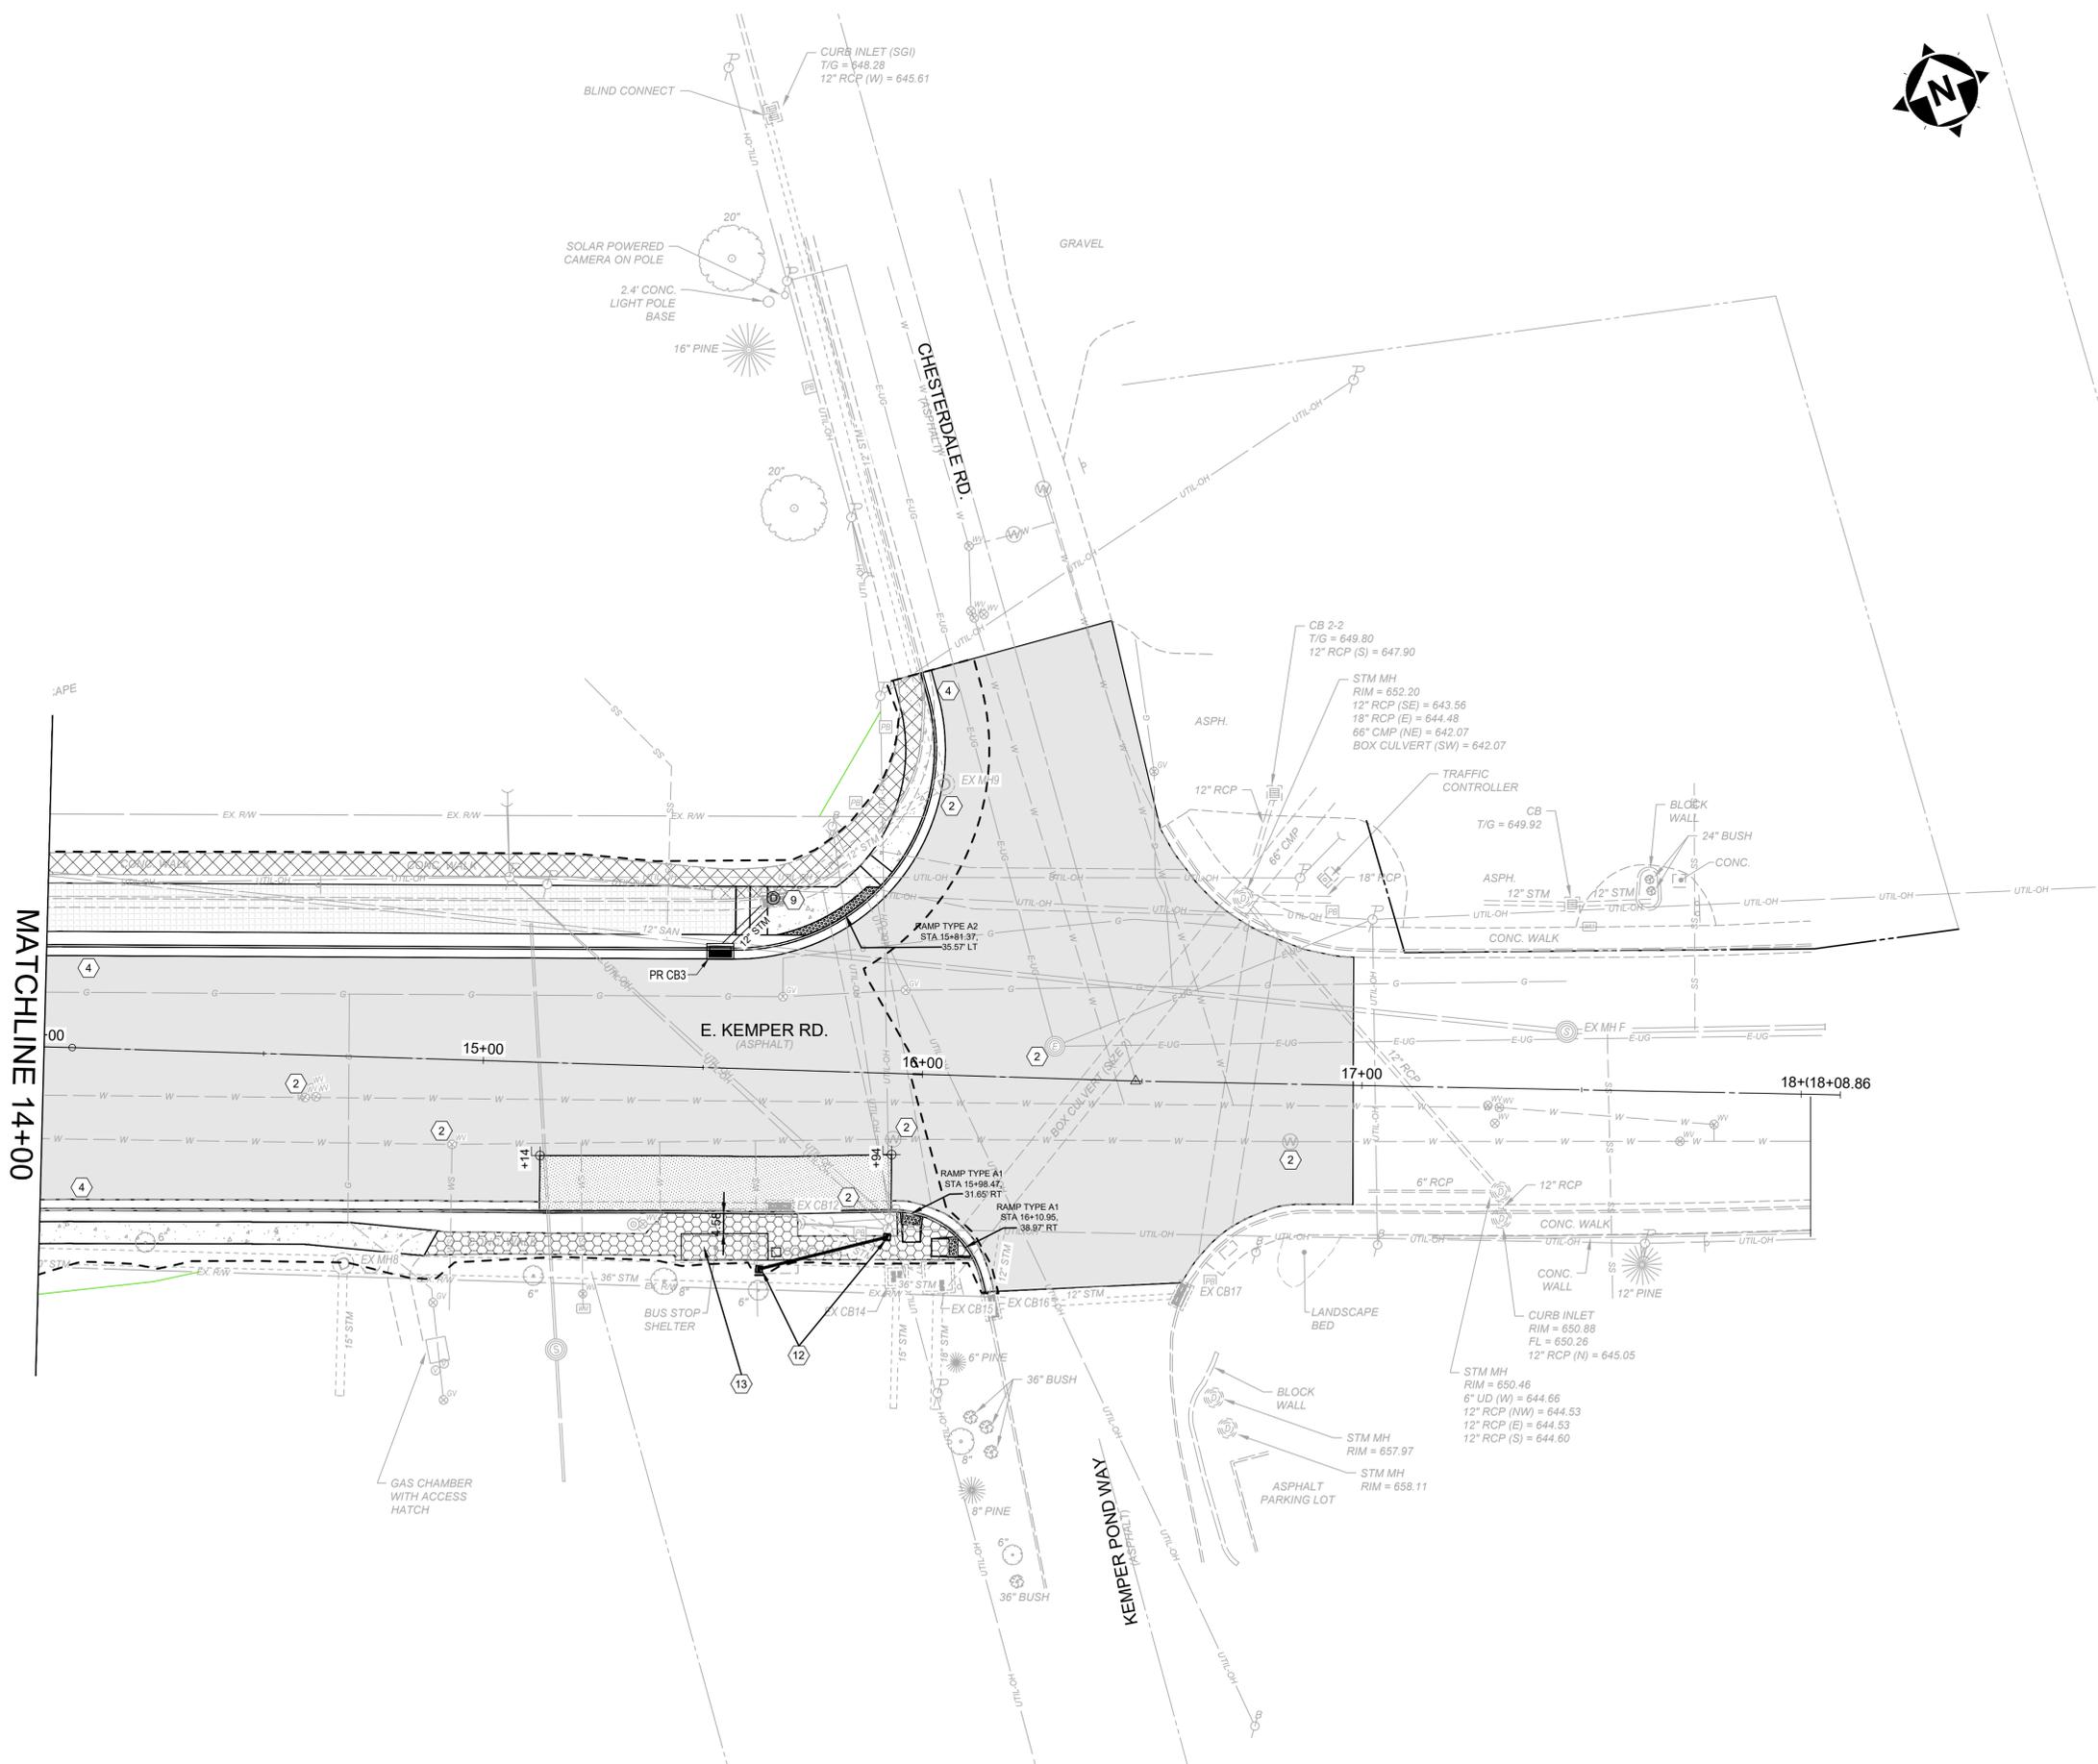

LEGEND & KEYNOTES

- 3" PAVEMENT PLANNING AND OVERLAY
SEE TYPICAL SECTION, SHEET 2
- ASPHALT SHARED USE PATH
- ASPHALT DRIVEWAY REMOVAL AND REPLACEMENT, AS PER PLAN
- *NON REINFORCED CONCRETE PAVEMENT, MISC.; 9" PLAN PORTLAND CEMENT CONCRETE DRIVEWAY REMOVAL & REPLACEMENT, AS PER PLAN
- SIDEWALK REMOVED
- 5' CONCRETE SIDEWALK
- 5' CONCRETE WALK REMOVE & REPLAC
- 11' CONCRETE BUS PAD, SEE DETAIL
- DETECTABLE WARNINGS
- GRADING LIMITS
- TEMPORARY EASEMENT
- PR WATER (SEE GCWW PLANS)

- 1 EXISTING TO BE REMOVED
- 2 ADJUST TO GRADE
- 3 TO BE RELOCATED (BY OTHERS)
- 4 COMBINATION CURB AND GUTTER, TYPE 2, A
- 5 CURB, TYPE 7, AS PER PLAN
- 6 CURB, TYPE 6
- 7 DO NOT DISTURB
- 8 MODULAR RETAINING WALL
- 9 CONVERT EX CB TO MH, SEE SHEET 6
- 10 DRAINAGE STRUCTURE, MISC.: CONVERT EX DB OUTLET STRUCTURE TO MH AND ADD PR DETENTION BASIN OUTLET STRUCTURE (CB)
- 11 CURB SHALL BE REPLACED TO MATCH EX WHERE SIDEWALK IS BEING REMOVED AND ALSO ALONG NEW DRIVE APRON TO MATCH EXISTING ENTRANCE. COST FOR SAID WORK SHALL BE INCIDENTAL TO THE CONTRACT
- 12 ITEM 625 PULL BOX, 725 08 24" & CONDUIT, 2', 725.051.
-PROVIDE AND INSTALL NEW SERVICE METER AND REQUIRED WIRING. THE COST FOR THIS WORK SHALL BE INCIDENTAL TO ITEM 625.
- 13 ITEM SPECIAL - REMOVE EXISTING BUS SHELTER, PROVIDE AND INSTALL NEW SHELTER
- 14 ITEM 609 CONCRETE MEDIAN
- 15 CONNECT 6" CPP TO UNDERDRAIN

STRUCTURE TABLE	
STRUCTURE NAME:	DETAILS:
EX CB12, ODOT CB-3 STA. 15+68.44, 31.7' R	T/G = 654.56 INV 12" (SE) = 651.46
EX CB13 [CONVERT TO PR MH2], ODOT CB-3 STA. 15+64.86, -39.0' L	T/G = 654.17 INV 12" (SW) = 650.05 INV 12" (E) = 650.05
EX CB14, ODOT CB 2-4 STA. 15+95.56, 46.1' R	T/G = 654.36 INV 15" (S) = 650.11 INV 36" (W) = 649.23 INV 36" (E) = 649.23
EX CB15, ODOT CB 2-6 STA. 16+05.03, 45.9' R	T/G = 653.92 INV 18" (S) = 649.20 INV 12" (NW) = 650.93 INV 36" (W) = 649.94
EX CB16, ODOT CB-3 STA. 16+17.04, 52.3' R	T/G = 652.87 INV 12" (E) = 649.57 INV 12" (NE) = 649.57
EX CB17, ODOT CB-3 STA. 16+60.10, 48.6' R	T/G = 652.79 INV 12" (W) = 649.90
EX MH F, SAN MH STA. 17+46.37, -13.1' L	T/G = 649.72 INV 12" (NW) = 629.81 INV 12" (E) = 629.81
EX MH8, ODOT MH-3 STA. 14+69.58, 47.1' R	T/G = 659.93 INV 30" (W) = 653.62 INV 15" (S) = 653.63 INV 36" (E) = 653.62
EX MH9, ODOT MH-3 STA. 16+02.80, -65.9' L	T/G = 651.95 INV 12" (W) = 649.83 INV 12" (N) = 649.60
PR CB3, ODOT CB-3 STA. 15+53.09, -26.7' L	T/G = 655.14 INV 12" (NE) = 652.64







DATE	REVISION	NO	BID	ISSUED FOR:	ISSUE DATE:	SCALE:	DESIGNED BY:	DRAWN BY:	CHECKED BY:
			02/04/2026		1"=20'	PMAD			

EAST KEMPER ROAD IMPROVEMENTS AND SHARED USE PATH, PH. 1
CITY OF SPRINGDALE - HAMILTON COUNTY, OHIO

PROJECT NO.	242429
DISCIPLINE	CIVIL
SHEET NAME	PL4
SHEET	14
OF	47

MATCHLINE 14+00

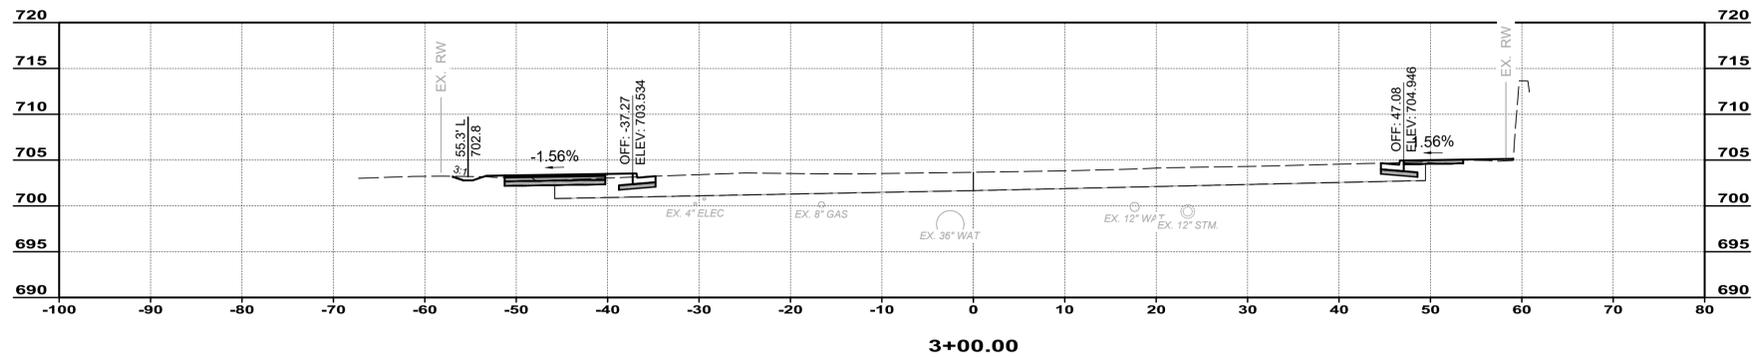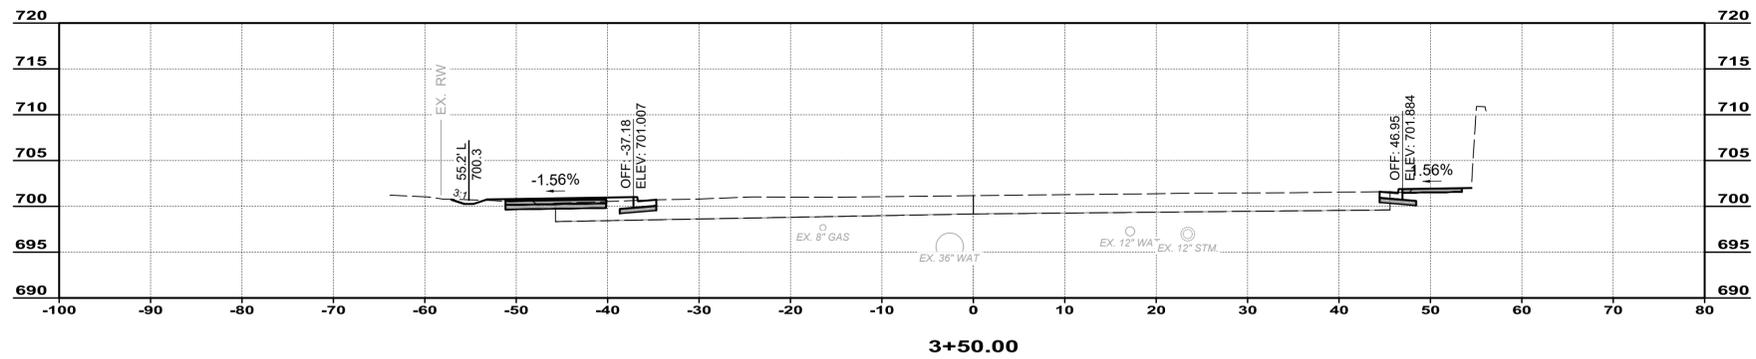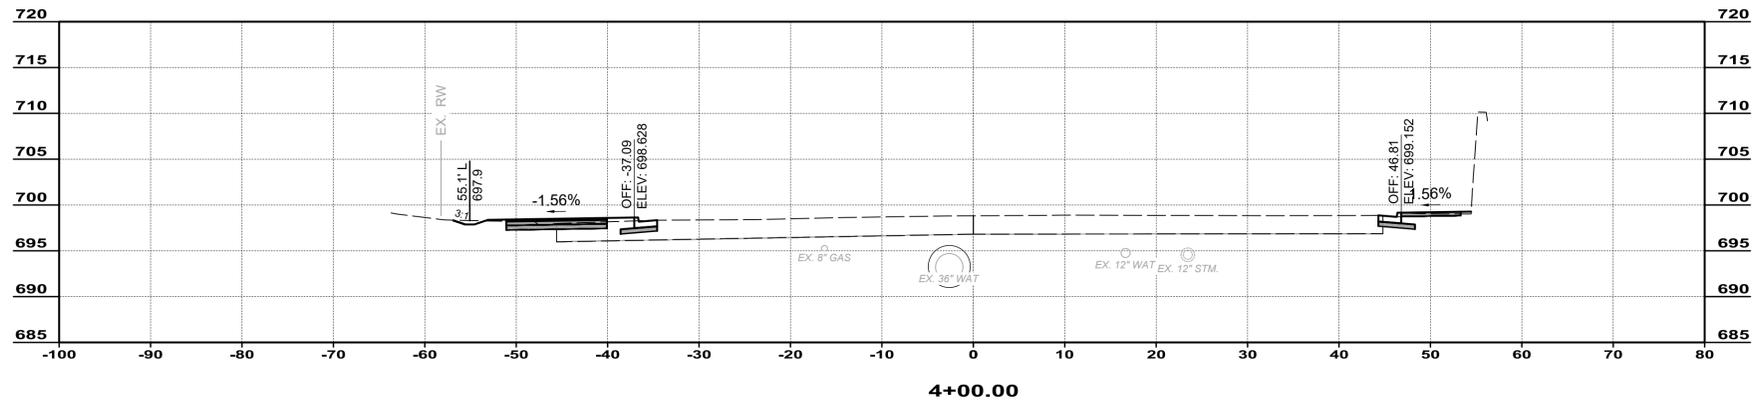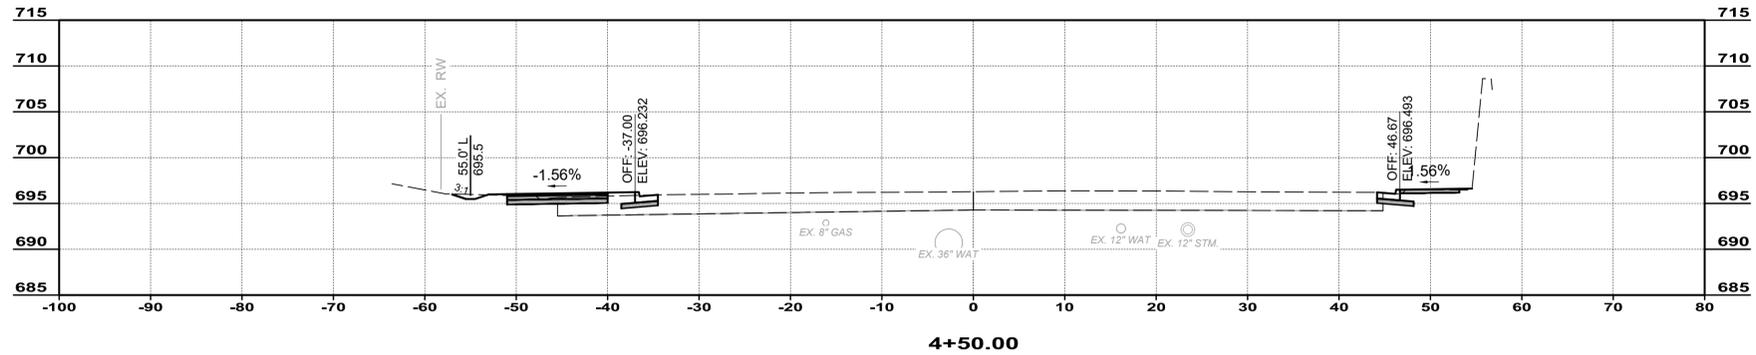


ISSUED FOR:	BID NO.	REVISION	DATE
ISSUE DATE: 02/04/2026			
SCALE: 1"=10'			
DESIGNED BY: PMAD			
DRAWN BY: PMAD			
CHECKED BY: SRG			


EAST KEMPER ROAD IMPROVEMENTS AND SHARED USE PATH, PH. 1
 CITY OF SPRINGDALE - HAMILTON COUNTY, OHIO

CROSS SECTIONS


PROJECT NO.	242429
DISCIPLINE	CIVIL
SHEET NAME	XS1
SHEET	15
OF	47

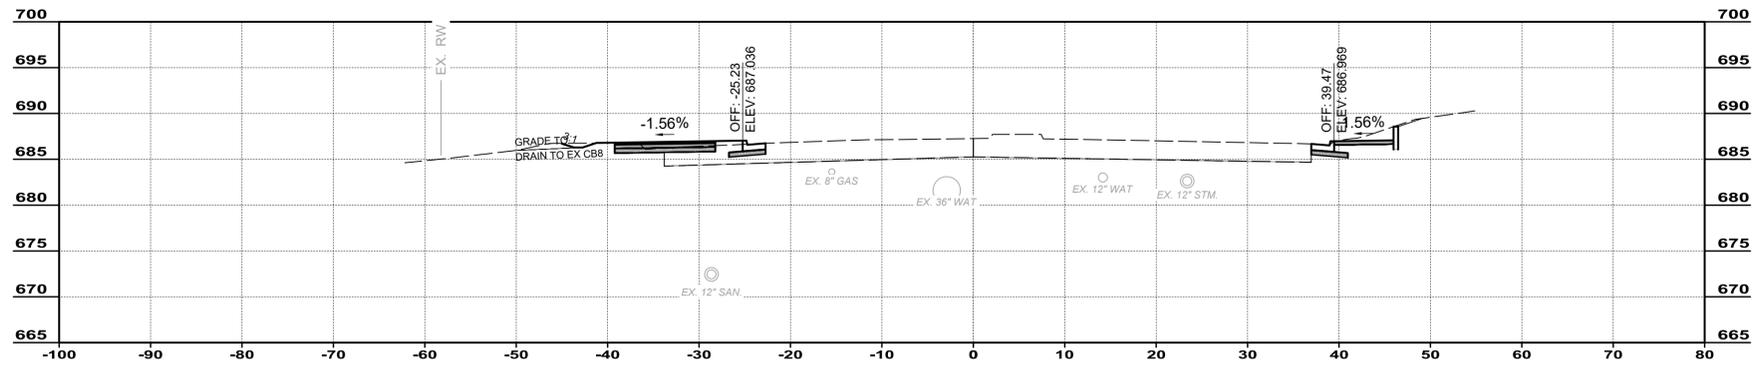


6+50.00

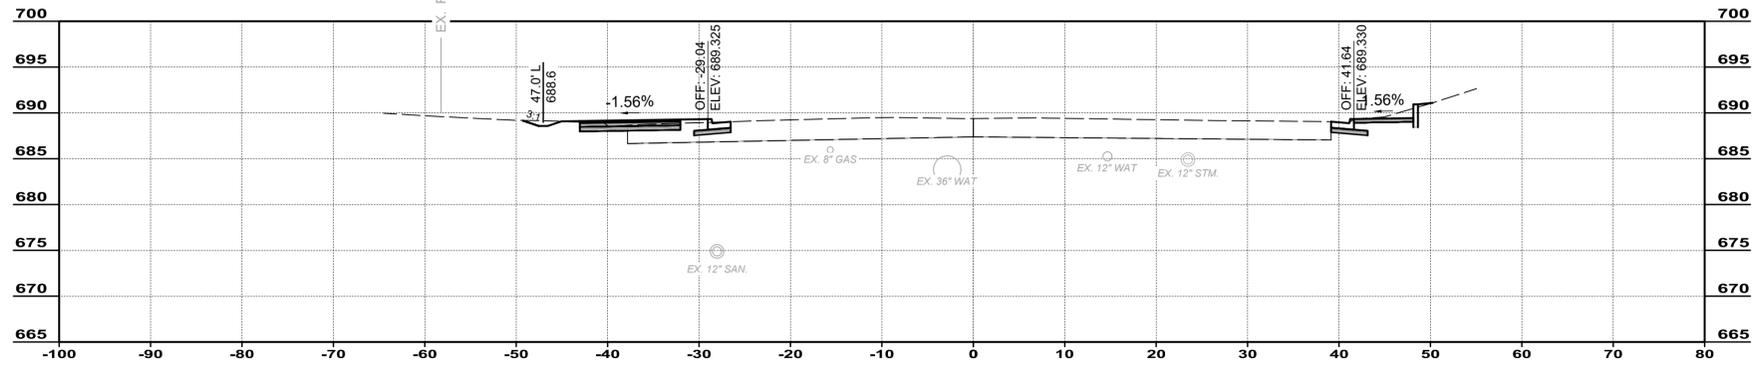

6+00.00

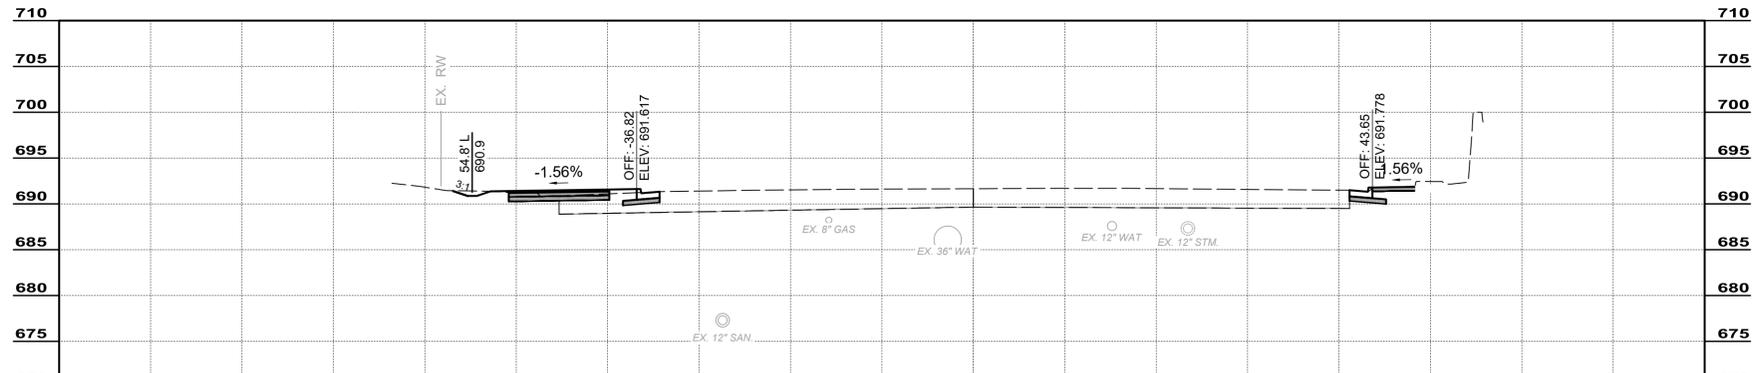

5+50.00

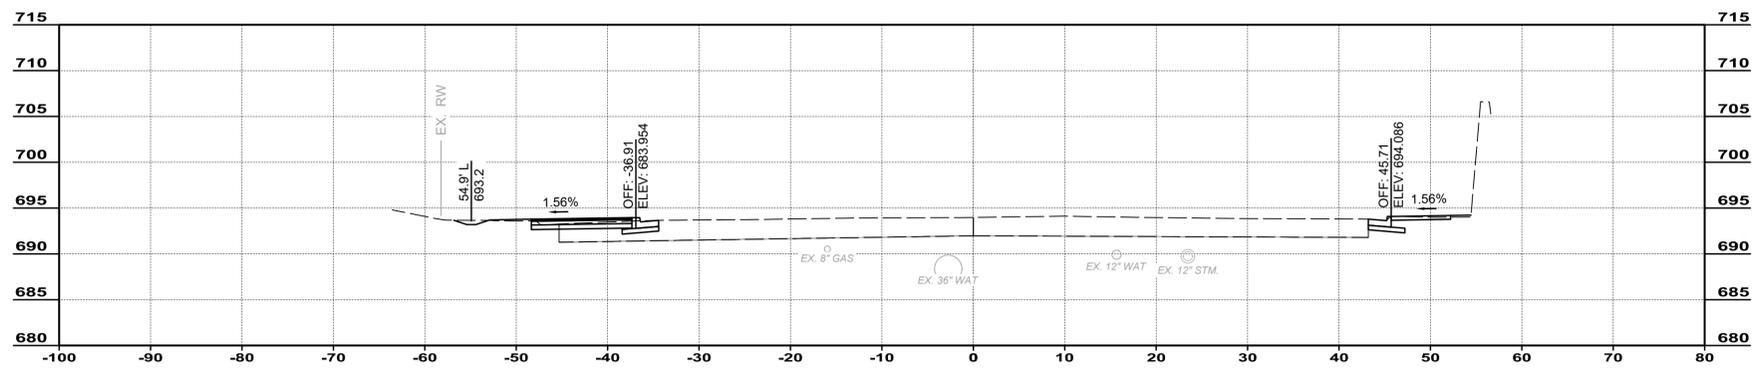

5+00.00







NO	REVISION	DATE

ISSUED FOR:	BID	SRG
ISSUE DATE:	02/04/2026	
SCALE:	1"=10'	
DESIGNED BY:	PMAD	
DRAWN BY:	PMAD	
CHECKED BY:		

**EAST KEMPER ROAD
IMPROVEMENTS AND
SHARED USE PATH, PH. 1**
CITY OF SPRINGDALE - HAMILTON COUNTY, OHIO

CROSS SECTIONS

PROJECT NO.	242429
DISCIPLINE	CIVIL
SHEET NAME	XS2
SHEET	OF
16	47

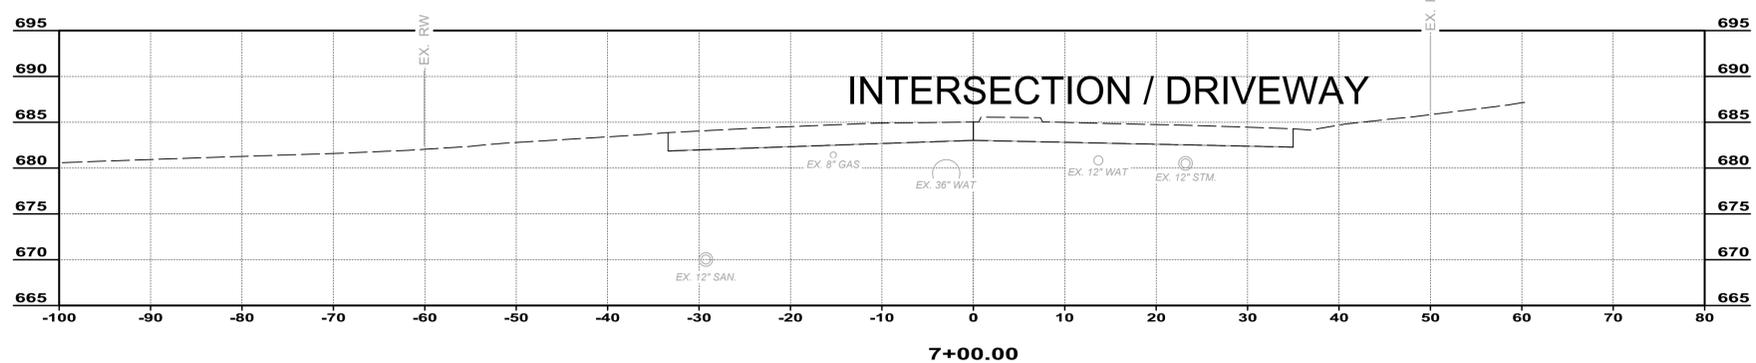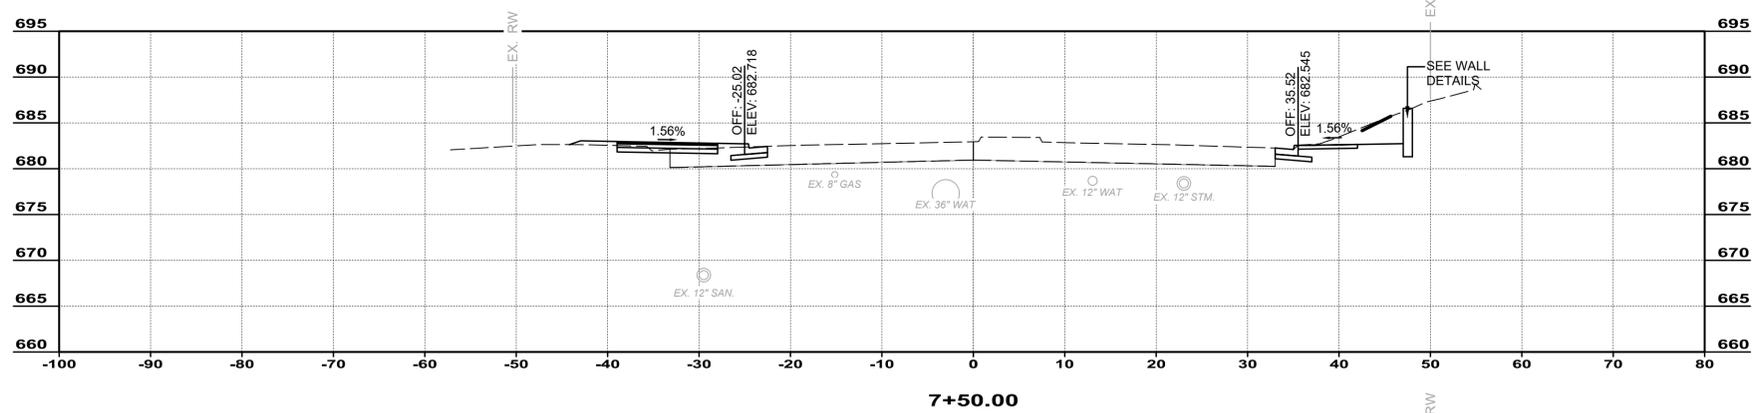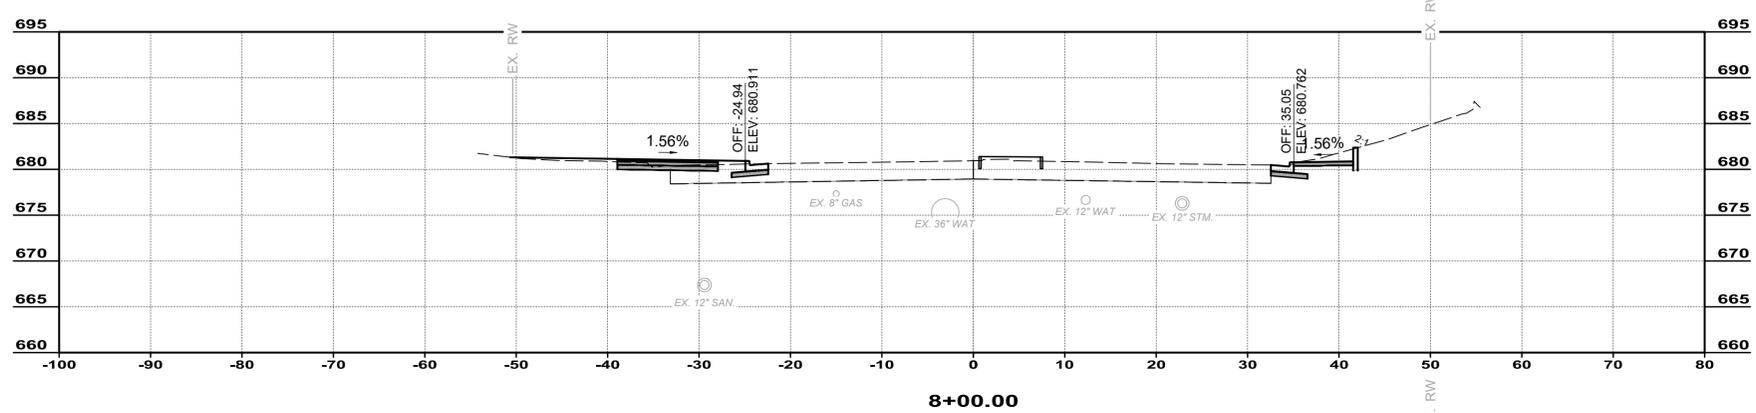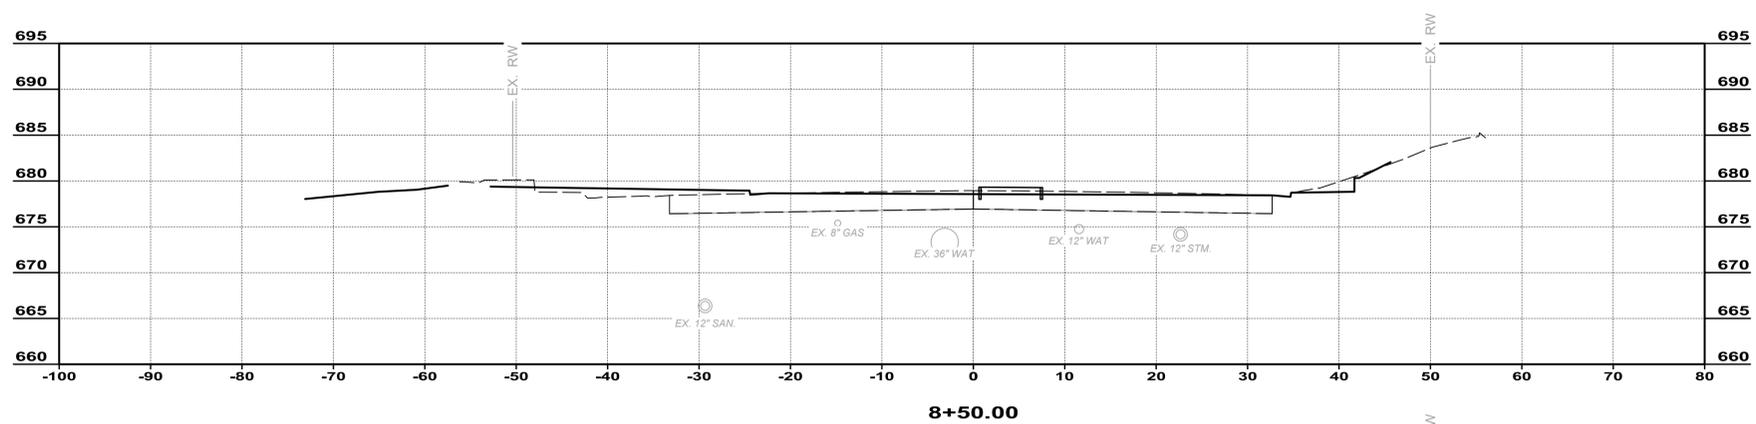






NO	REVISION	DATE

ISSUED FOR:	BID	SRG
ISSUE DATE:	02/04/2026	
SCALE:	1"=10'	
DESIGNED BY:	PMAD	
DRAWN BY:	PMAD	
CHECKED BY:		

EAST KEMPER ROAD IMPROVEMENTS AND SHARED USE PATH, PH. 1
 CITY OF SPRINGDALE - HAMILTON COUNTY, OHIO

CROSS SECTIONS


PROJECT NO.	
242429	
DISCIPLINE	
CIVIL	
SHEET NAME	
XS3	
SHEET	OF
17	47

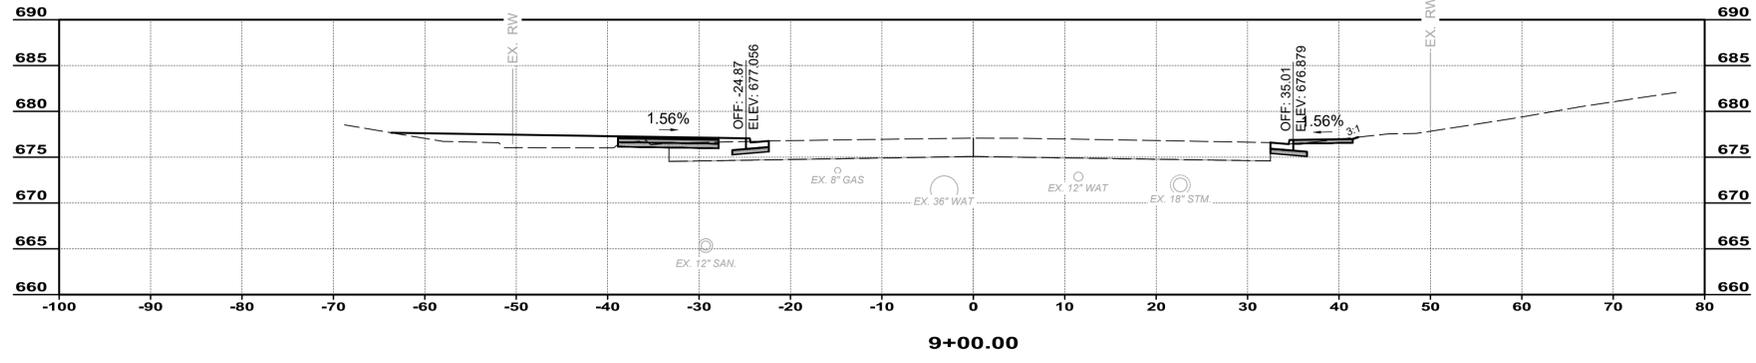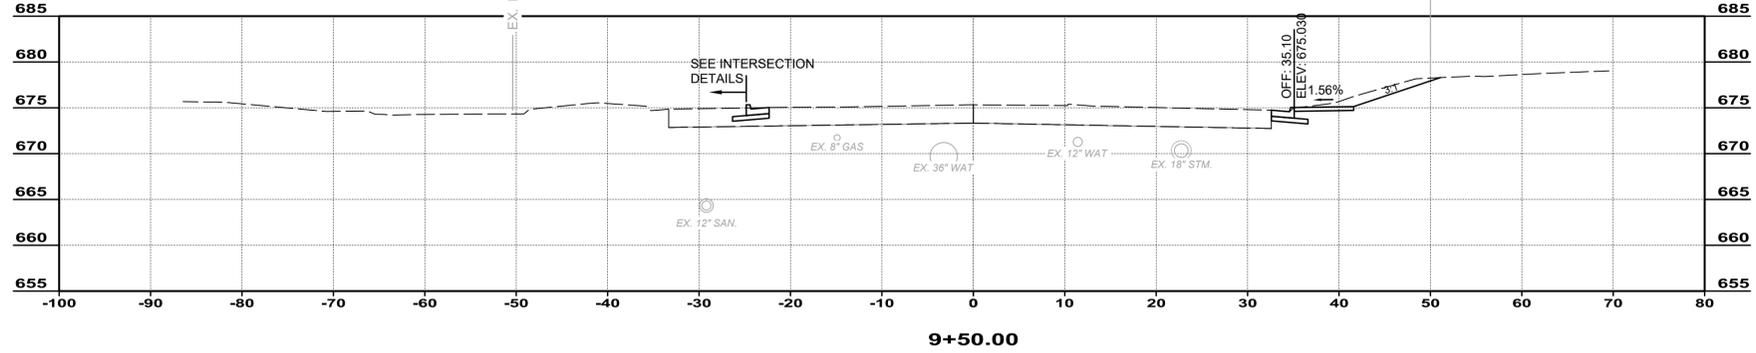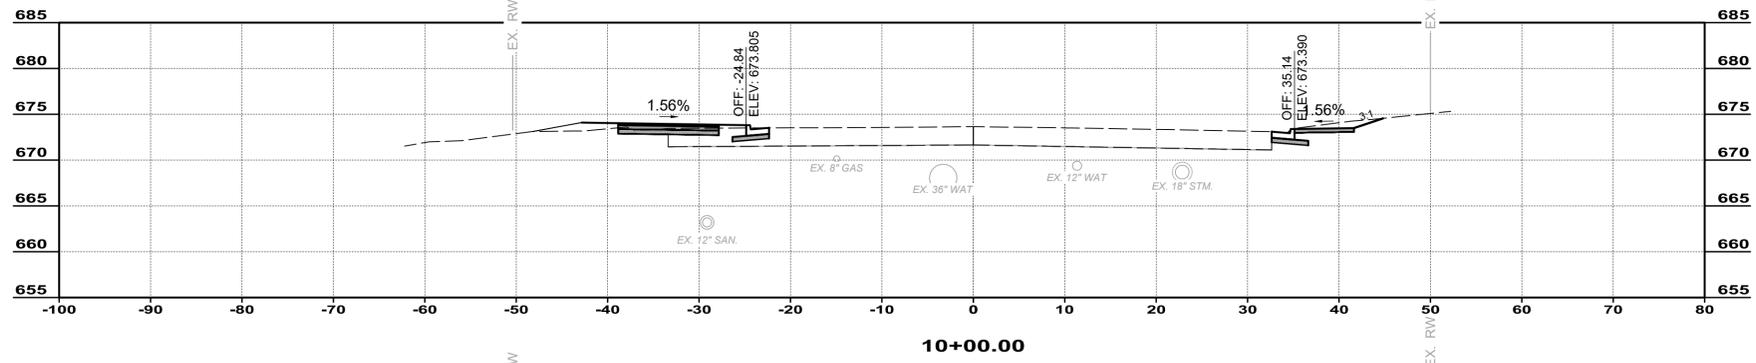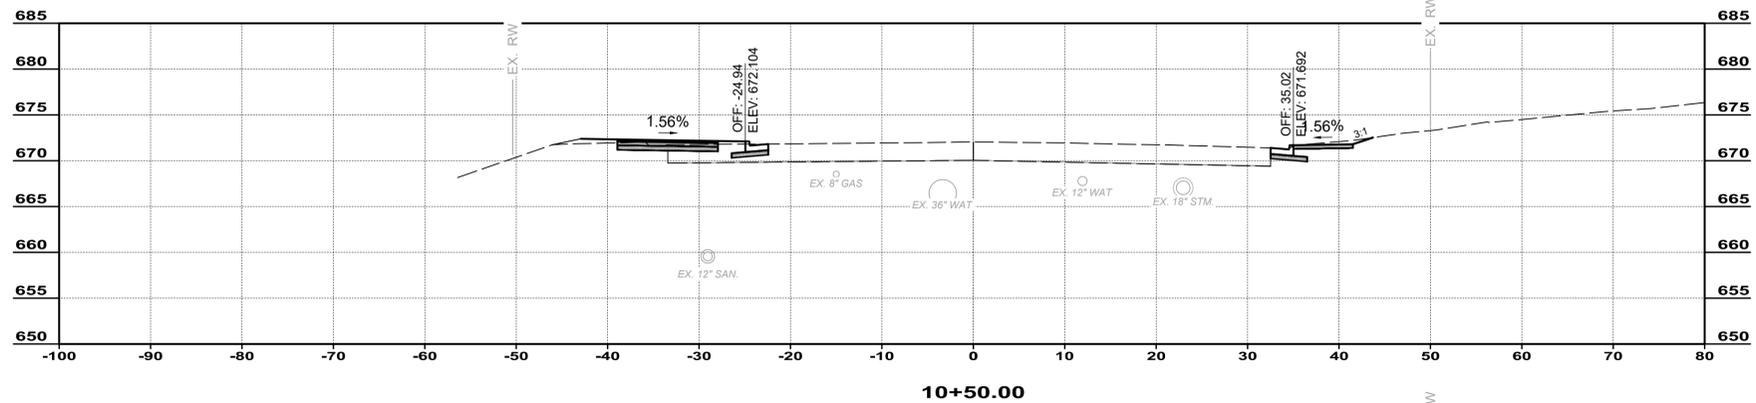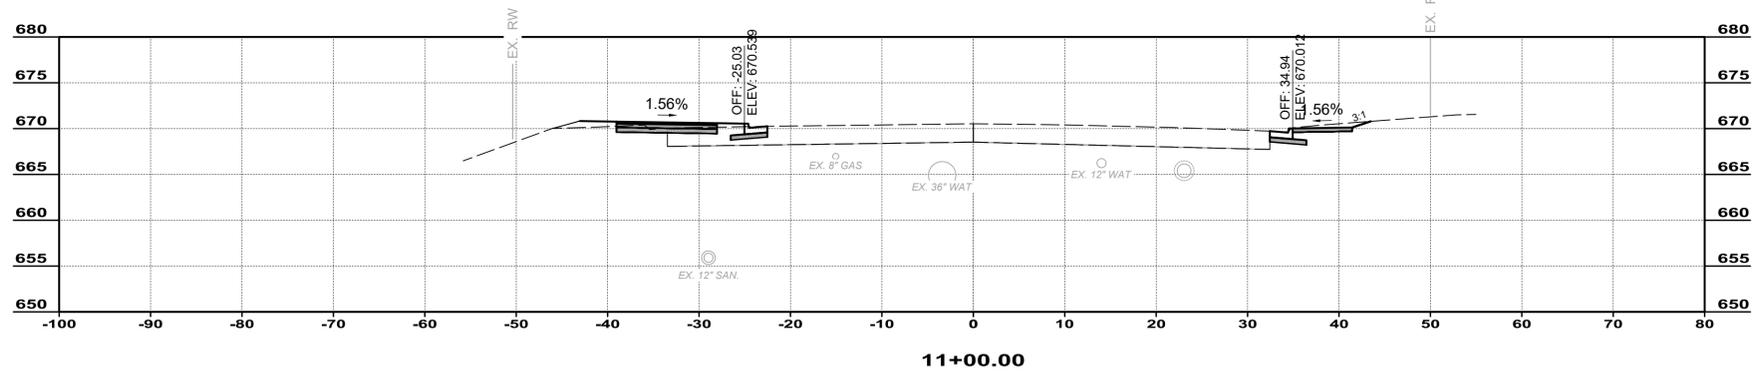


ISSUED FOR:	BID NO.	REVISION	DATE
ISSUE DATE: 02/04/2026	02/04/2026		
SCALE: 1"=10'	PMAD		
DESIGNED BY: PMAD	PMAD		
DRAWN BY: PMAD	SRIG		
CHECKED BY:			

EAST KEMPER ROAD IMPROVEMENTS AND SHARED USE PATH, PH. 1
 CITY OF SPRINGDALE - HAMILTON COUNTY, OHIO
CROSS SECTIONS


PROJECT NO.	242429
DISCIPLINE	CIVIL
SHEET NAME	XS4
SHEET	OF
18	47

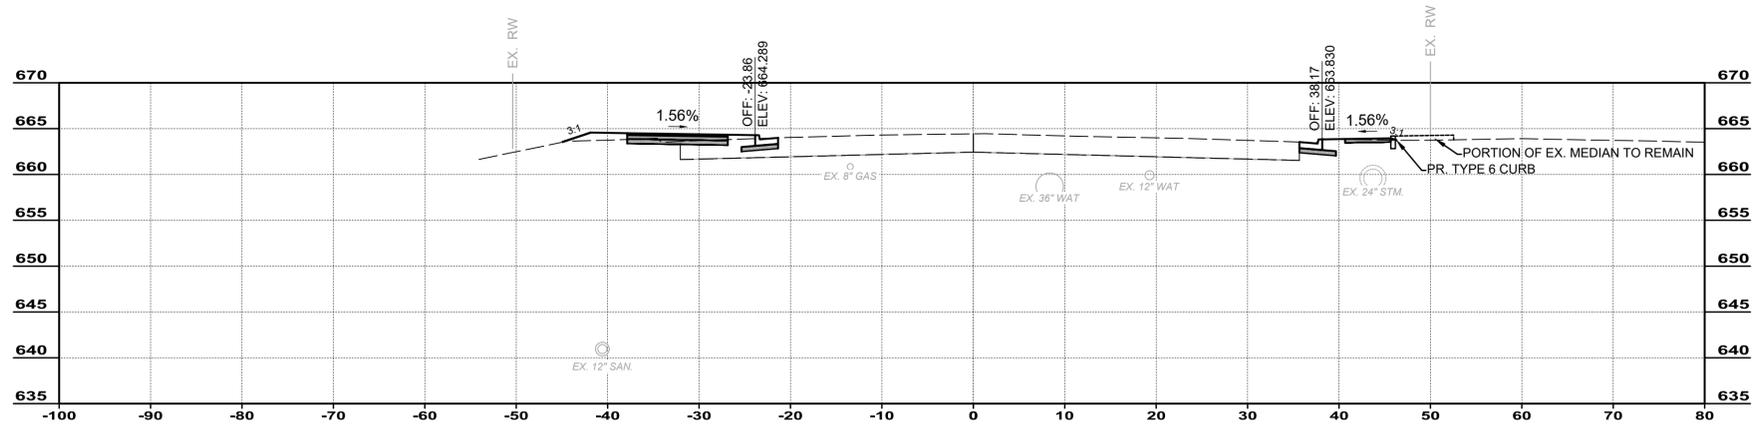


13+00.00

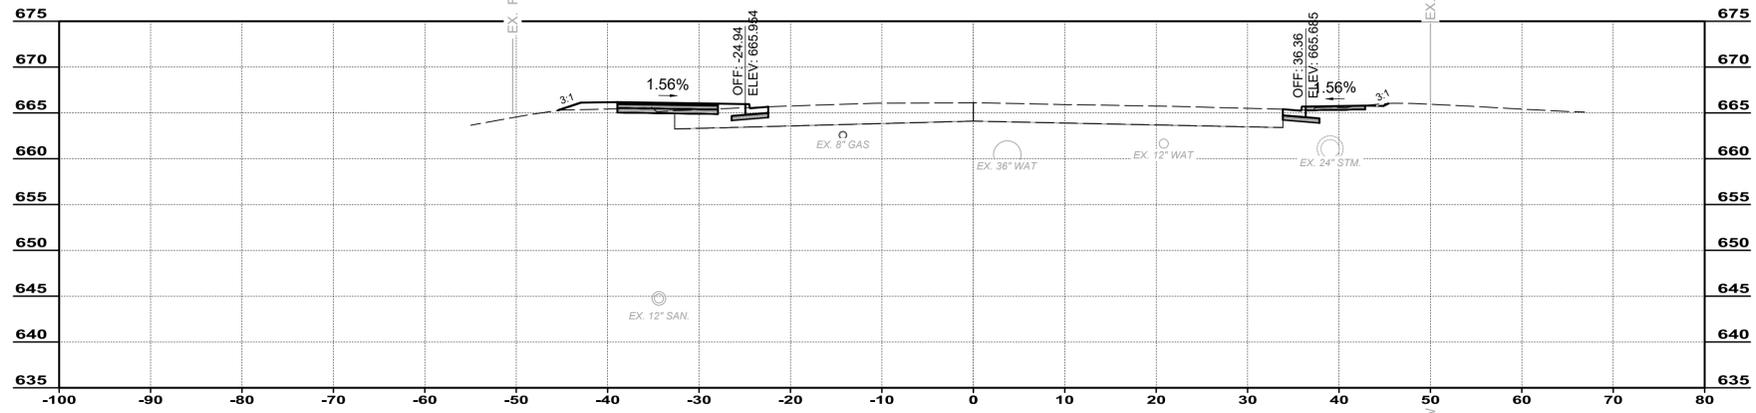

12+50.00

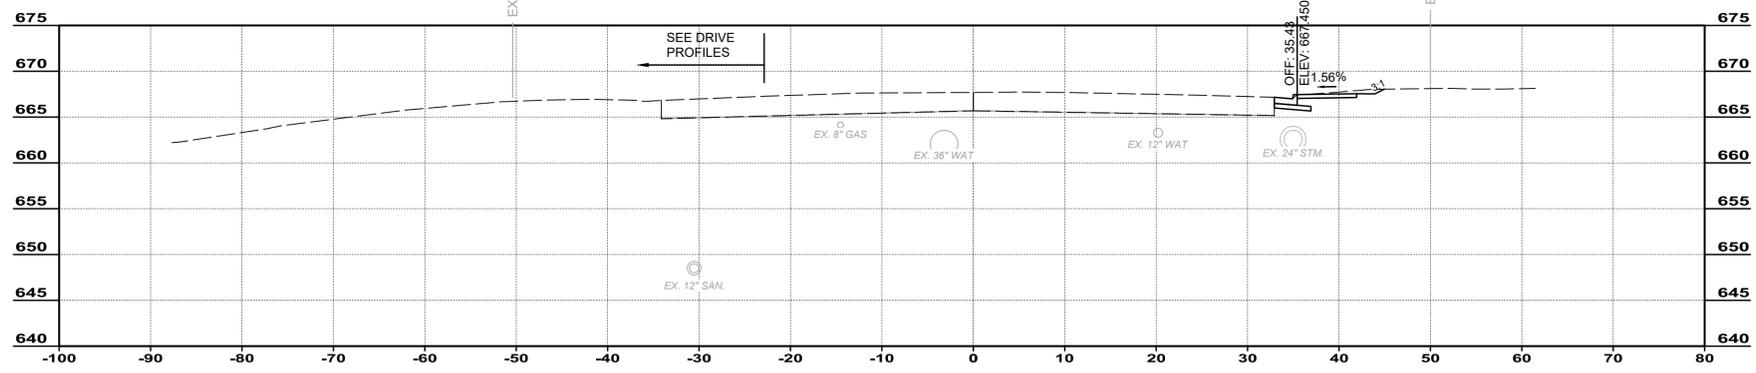

12+00.00

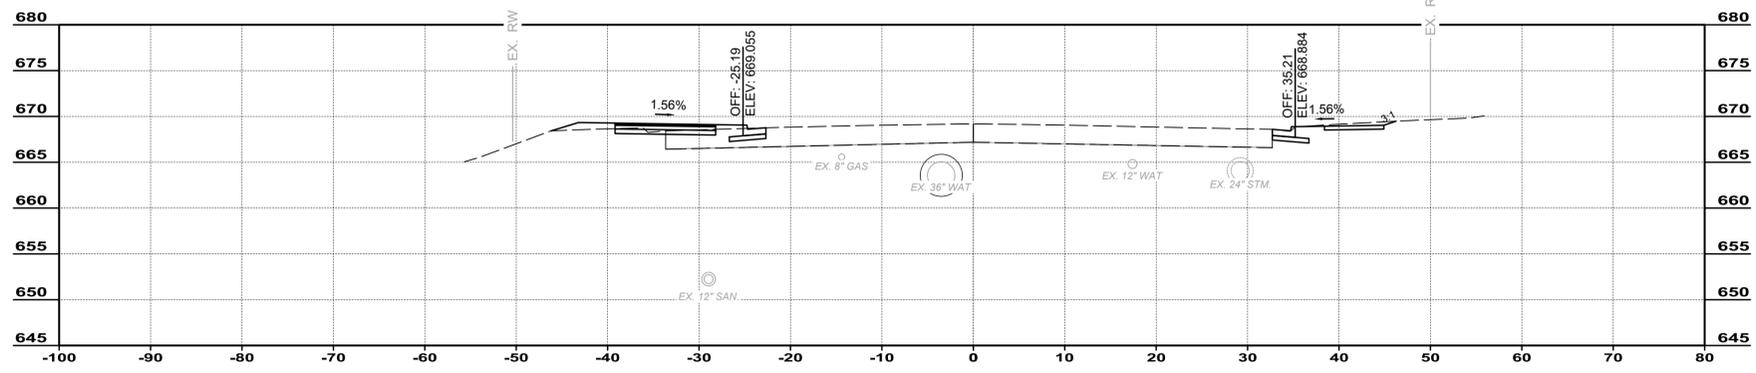

11+50.00




NO	REVISION	DATE

ISSUED FOR:	BID	SRG
ISSUE DATE:	02/04/2026	
SCALE:	1"=10'	
DESIGNED BY:	PMAD	
DRAWN BY:	PMAD	
CHECKED BY:		

**EAST KEMPER ROAD
IMPROVEMENTS AND
SHARED USE PATH, PH. 1**
CITY OF SPRINGDALE - HAMILTON COUNTY, OHIO

CROSS SECTIONS

PROJECT NO.	242429
DISCIPLINE	CIVIL
SHEET NAME	XS5
SHEET	OF
19	47

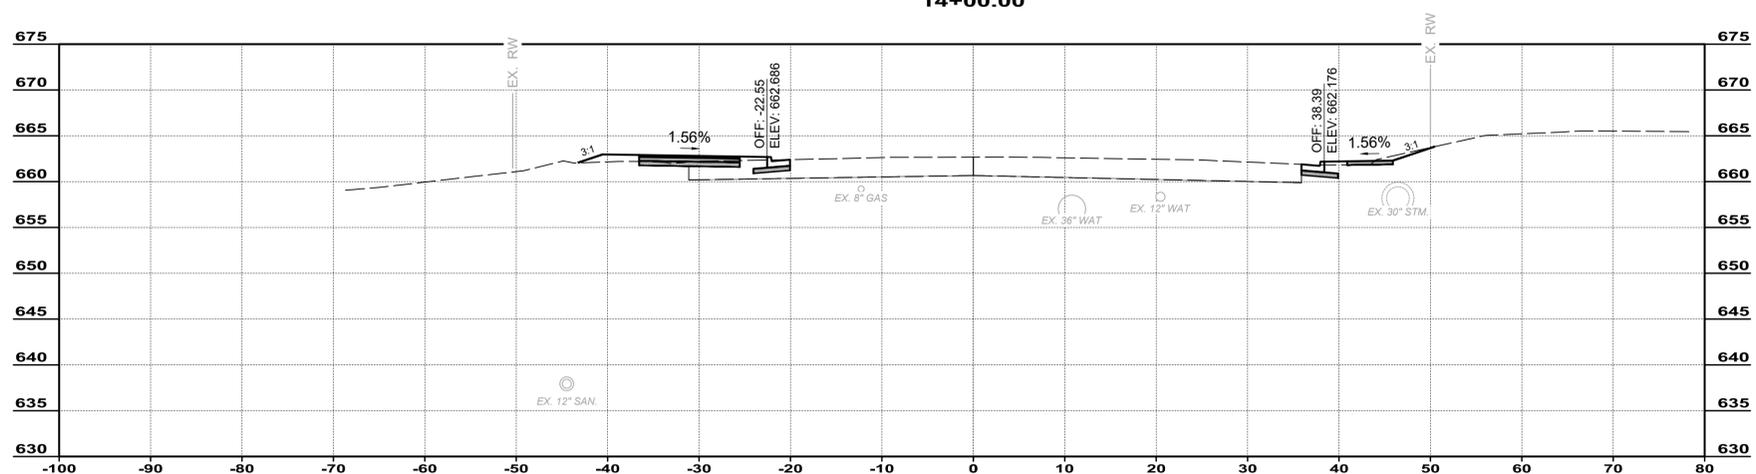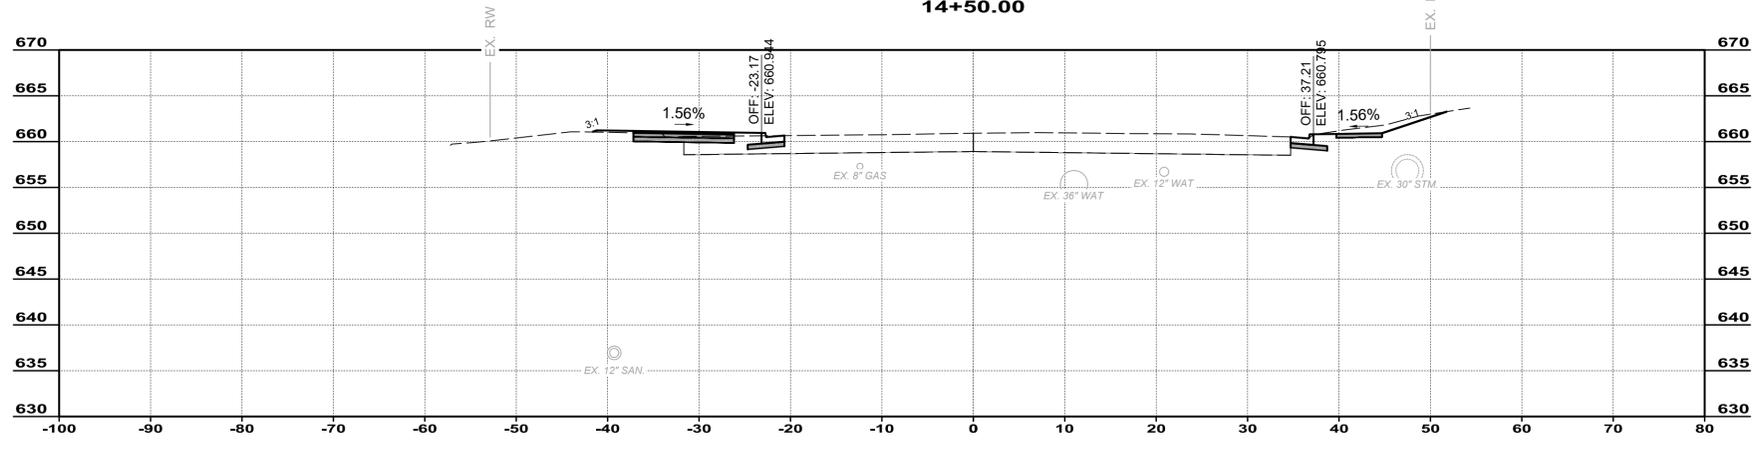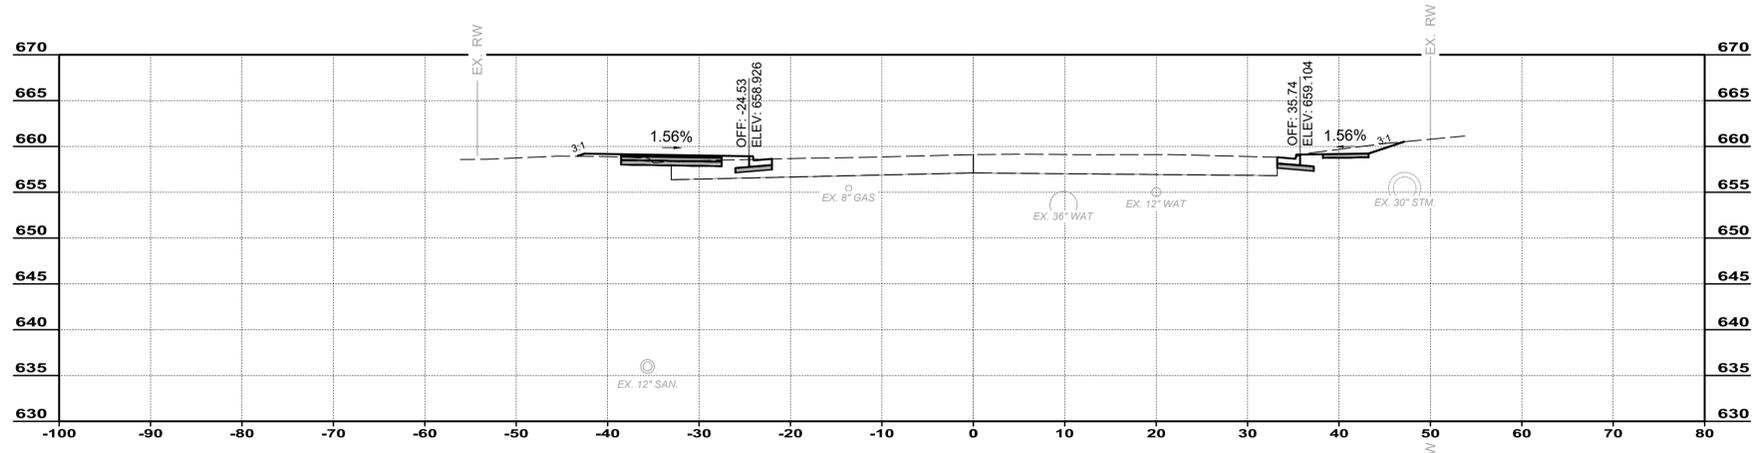

NO	REVISION	DATE

ISSUED FOR:	BID	SRIG
ISSUE DATE:	02/04/2026	
SCALE:	1"=10'	
DESIGNED BY:	PMAD	
DRAWN BY:	PMAD	
CHECKED BY:		

PROJECT NO. 242429	
DISCIPLINE CIVIL	
SHEET NAME XS6	
SHEET 20	OF 47



**EAST KEMPER ROAD
IMPROVEMENTS AND
SHARED USE PATH, PH. 1**
CITY OF SPRINGDALE - HAMILTON COUNTY, OHIO


CROSS SECTIONS

NO	REVISION	DATE


ISSUED FOR:
 ISSUE DATE: 02/04/2026
 SCALE: 1"=10'
 DESIGNED BY: PMAD
 DRAWN BY: PMAD
 CHECKED BY: SRIG

PROJECT NO. 242429	
DISCIPLINE CIVIL	
SHEET NAME XS7	
SHEET 21	OF 47

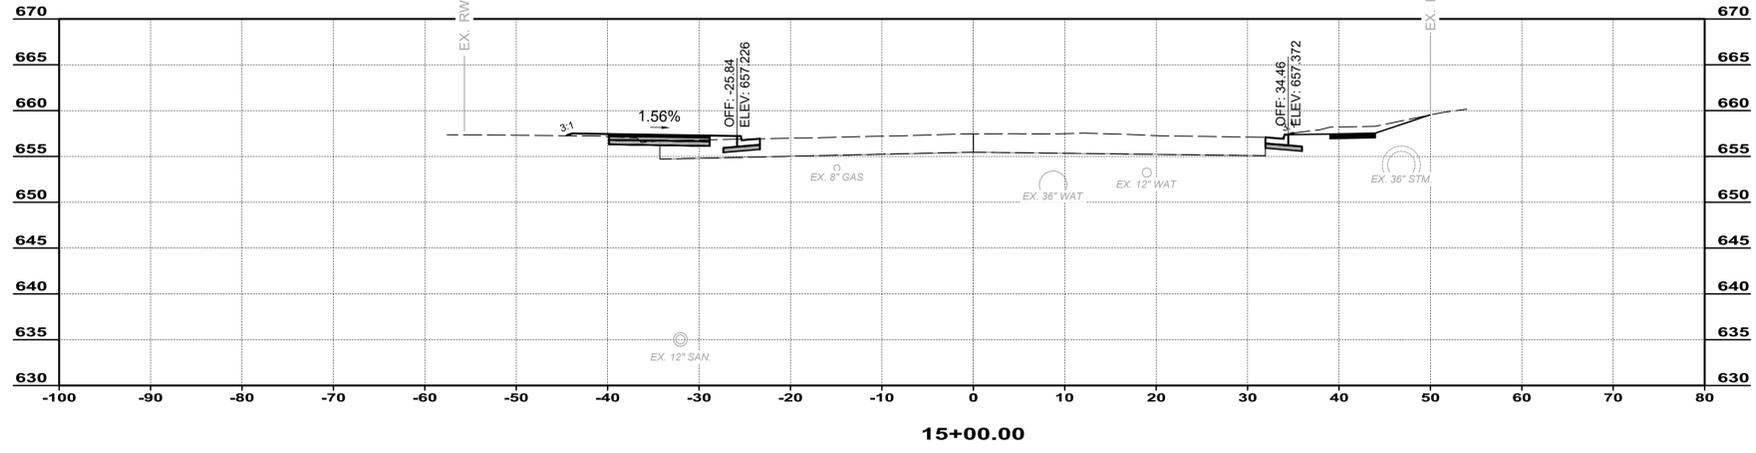
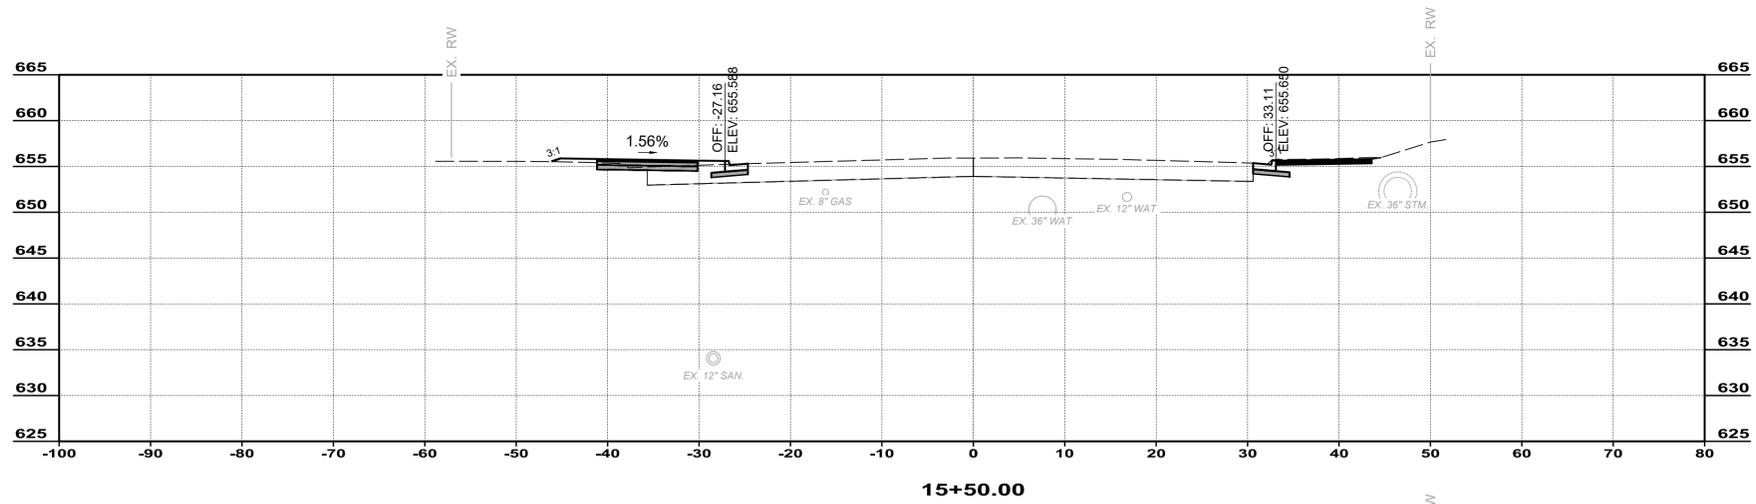


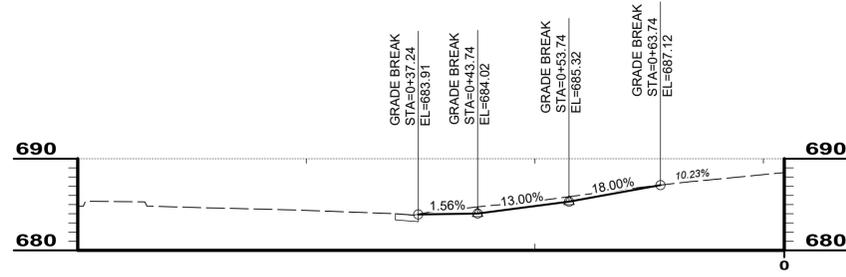

1171 E KEMPER RD #1

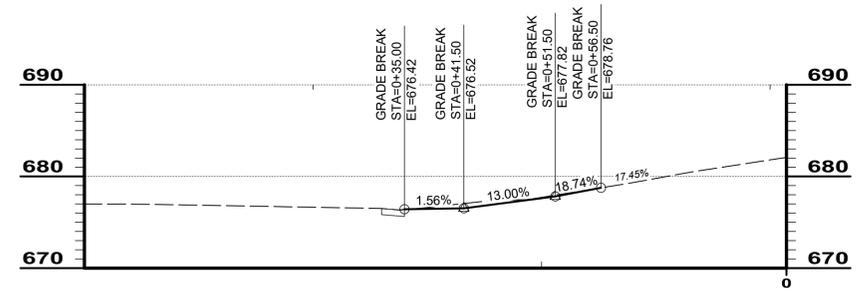


1171 E KEMPER RD #2

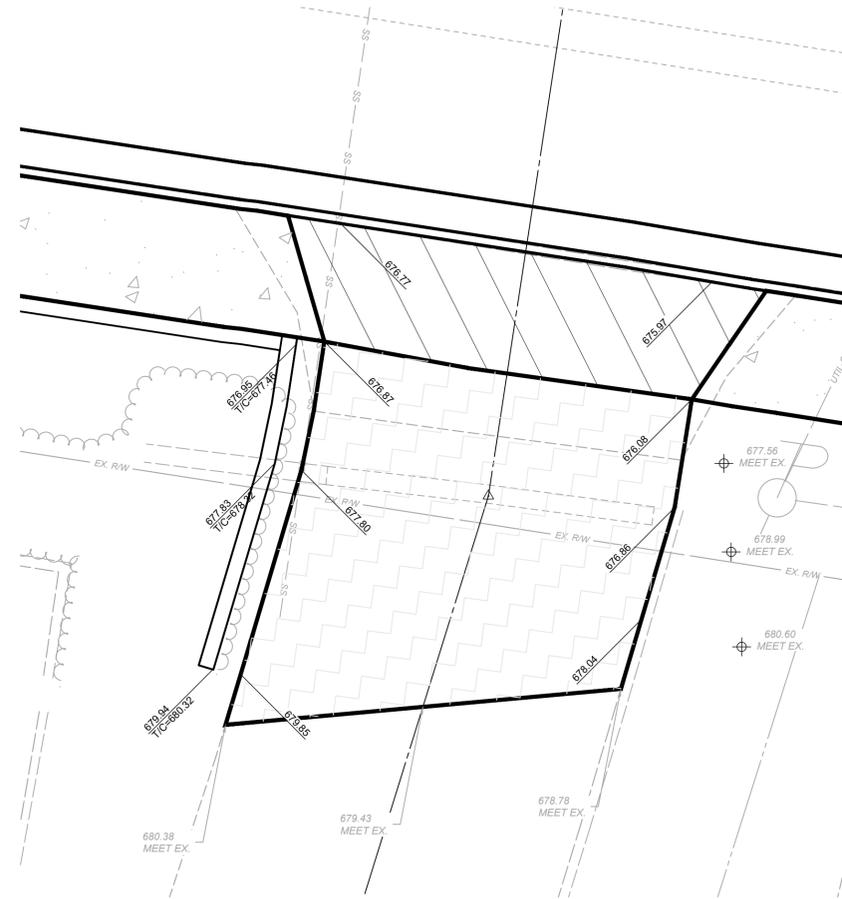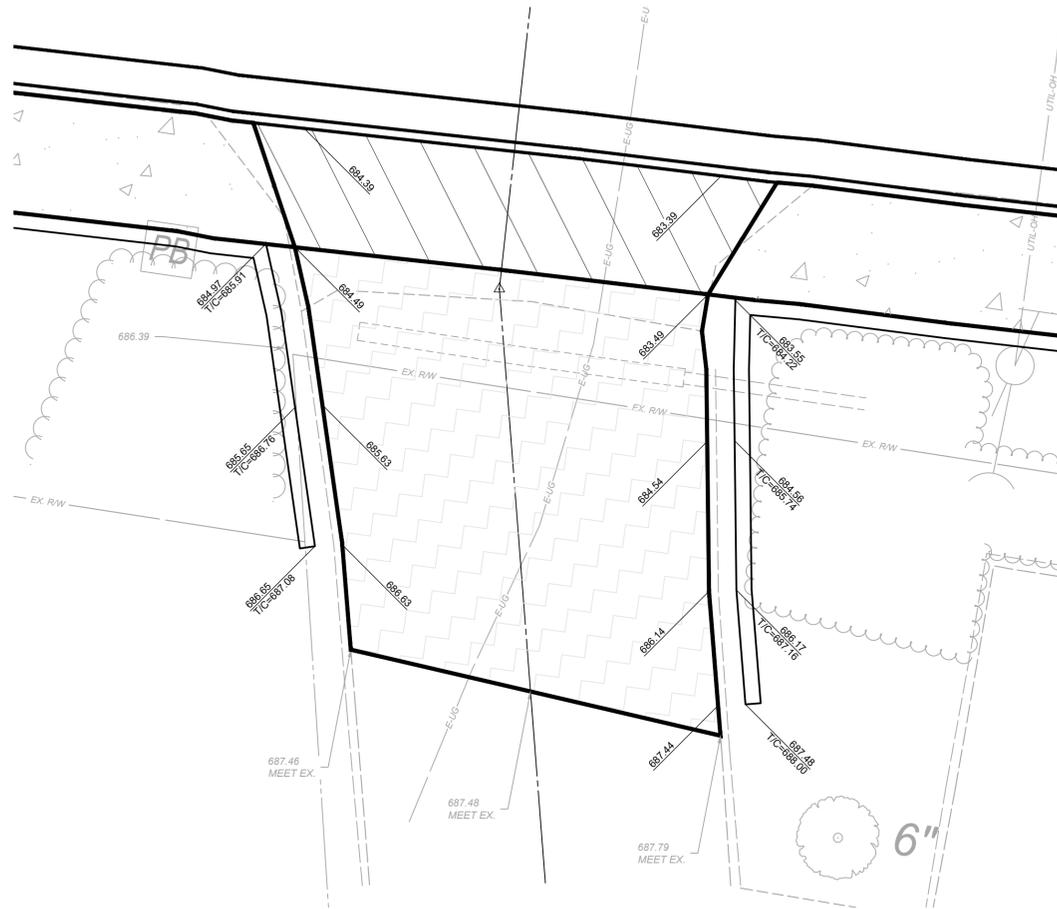



ISSUED FOR:	BID NO:	REVISION	DATE
ISSUE DATE: 02/04/2026			
SCALE: 1"=5'			
DESIGNED BY: PMAD			
DRAWN BY: PMAD			
CHECKED BY: SRIG			

EAST KEMPER ROAD IMPROVEMENTS AND SHARED USE PATH, PH. 1
 CITY OF SPRINGDALE - HAMILTON COUNTY, OHIO
DRIVE PROFILES & DETAILS


PROJECT NO.	242429
DISCIPLINE	CIVIL
SHEET NAME	PRO
SHEET	22
OF	47

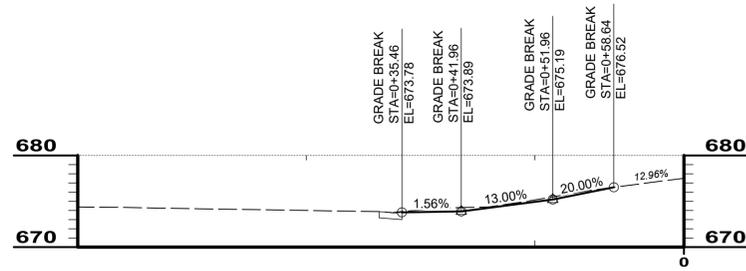

1229 E KEMPER

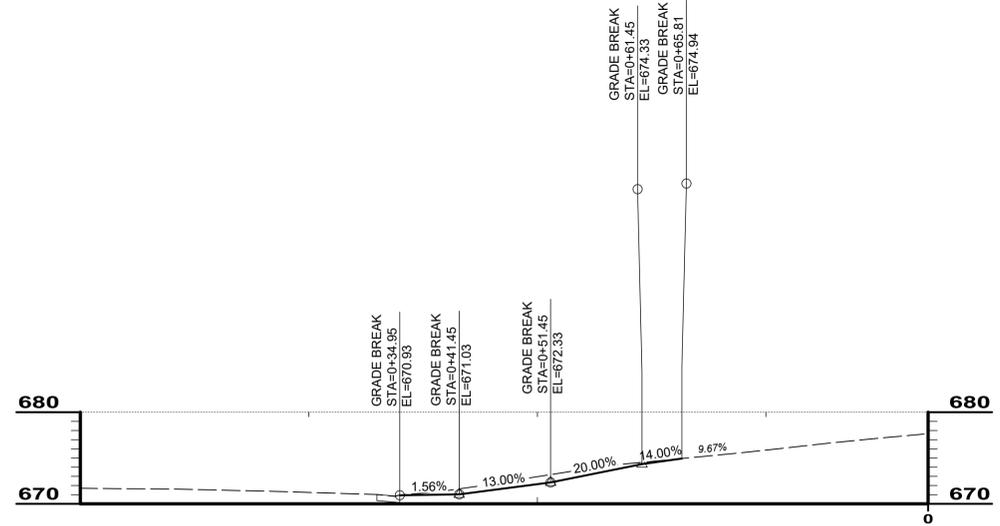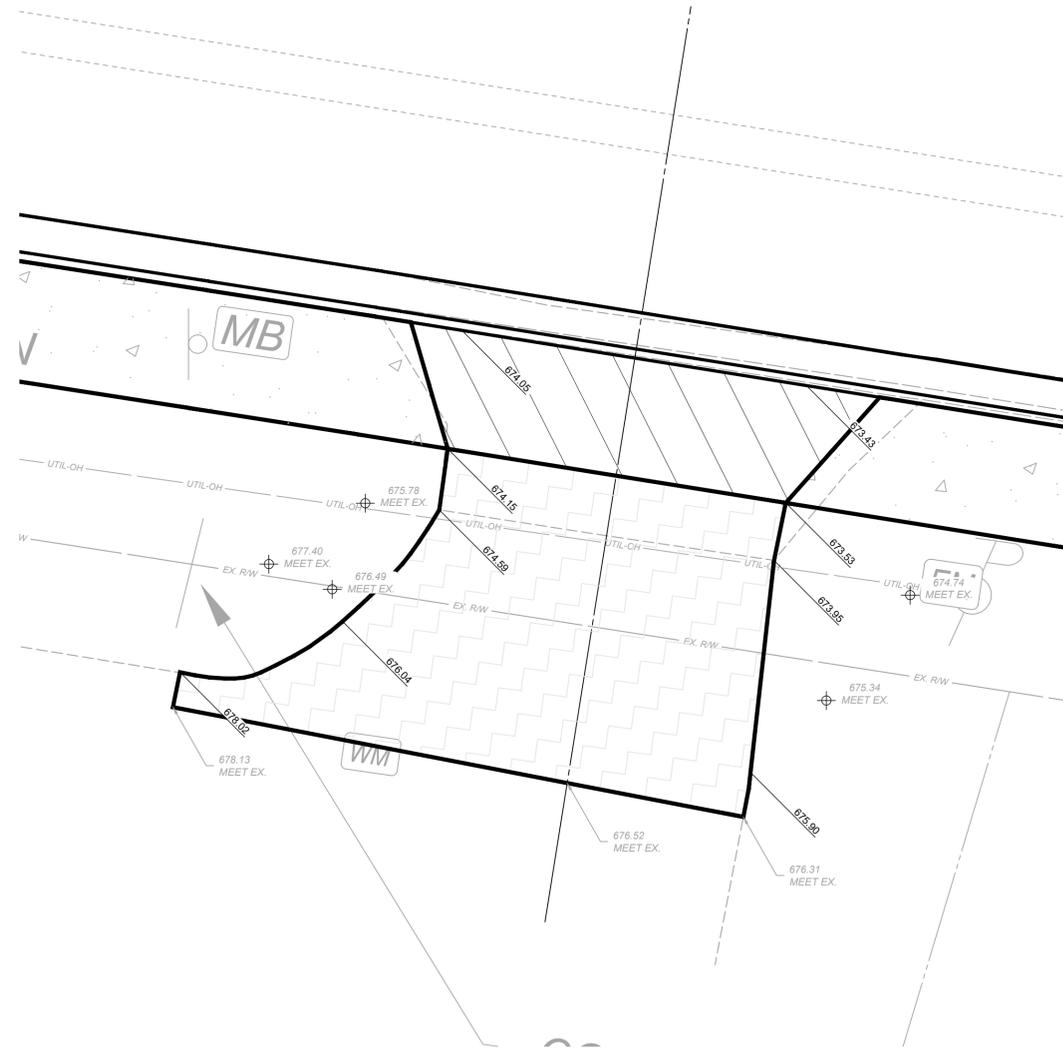



1251 E KEMPER

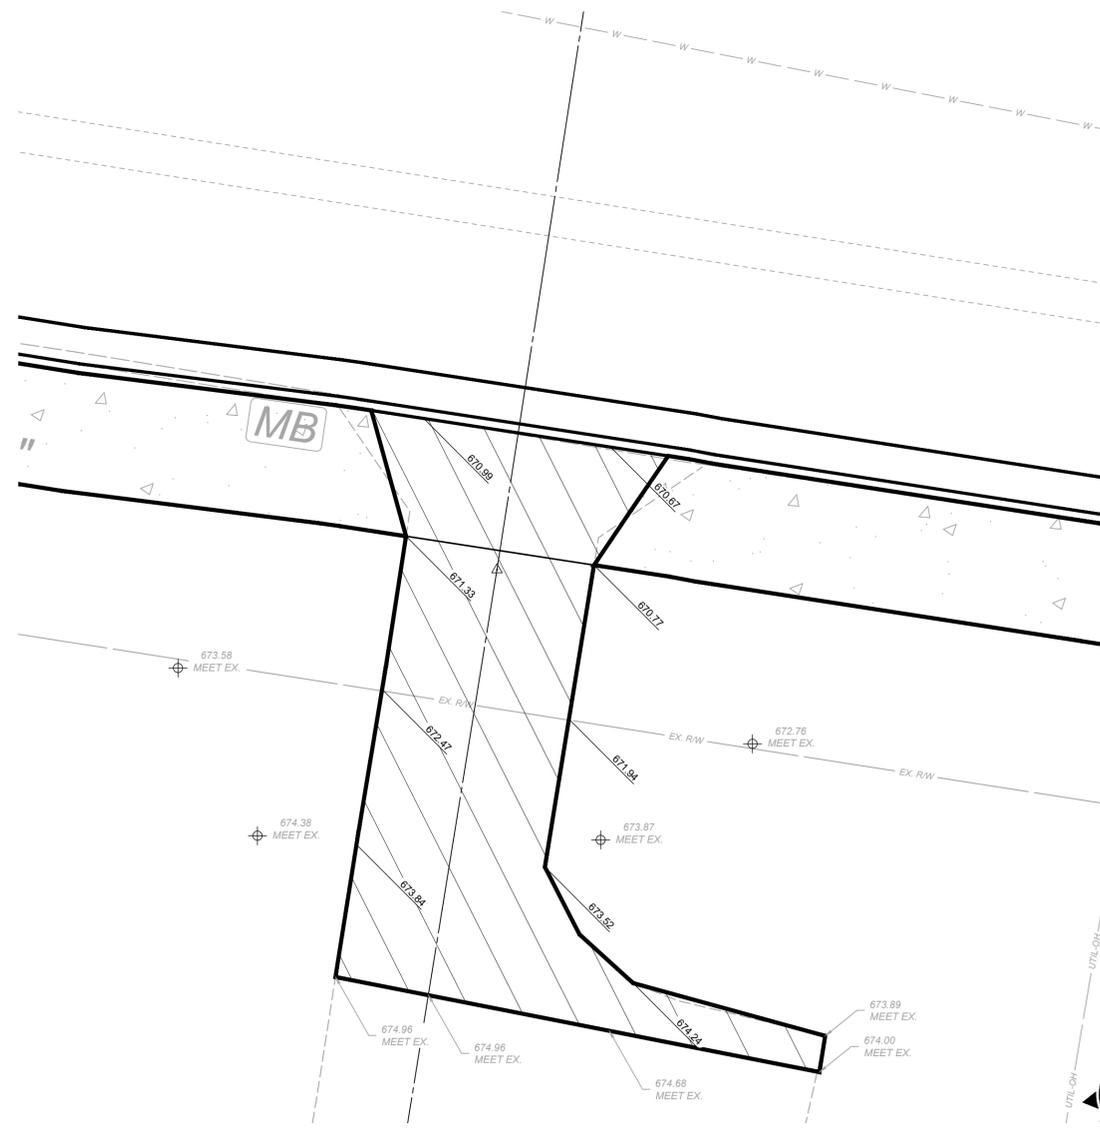


ISSUED FOR:	BID NO.	REVISION	DATE
ISSUE DATE:	02/04/2026		
SCALE:	1"=5'		
DESIGNED BY:	PMAD		
DRAWN BY:	PMAD		
CHECKED BY:	SRIG		

EAST KEMPER ROAD IMPROVEMENTS AND SHARED USE PATH, PH. 1
 CITY OF SPRINGDALE - HAMILTON COUNTY, OHIO
DRIVE PROFILES & DETAILS

PROJECT NO.	242429
DISCIPLINE	CIVIL
SHEET NAME	DP2
SHEET	23
OF	47

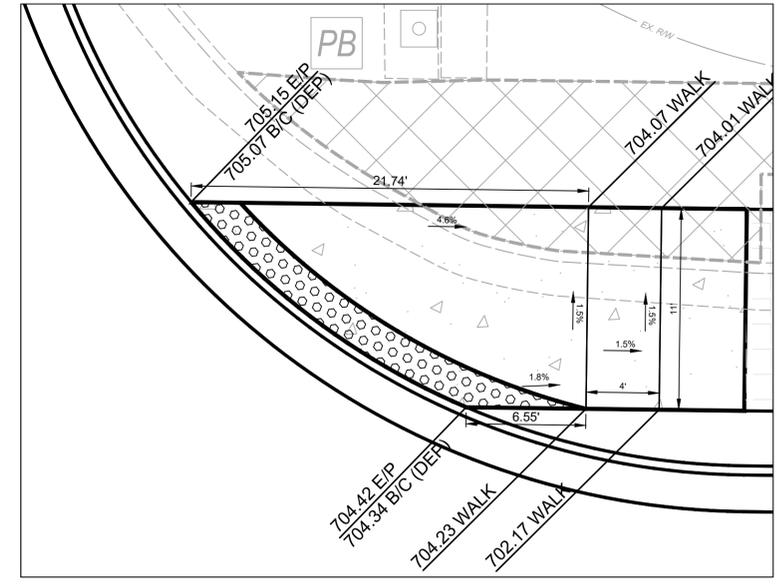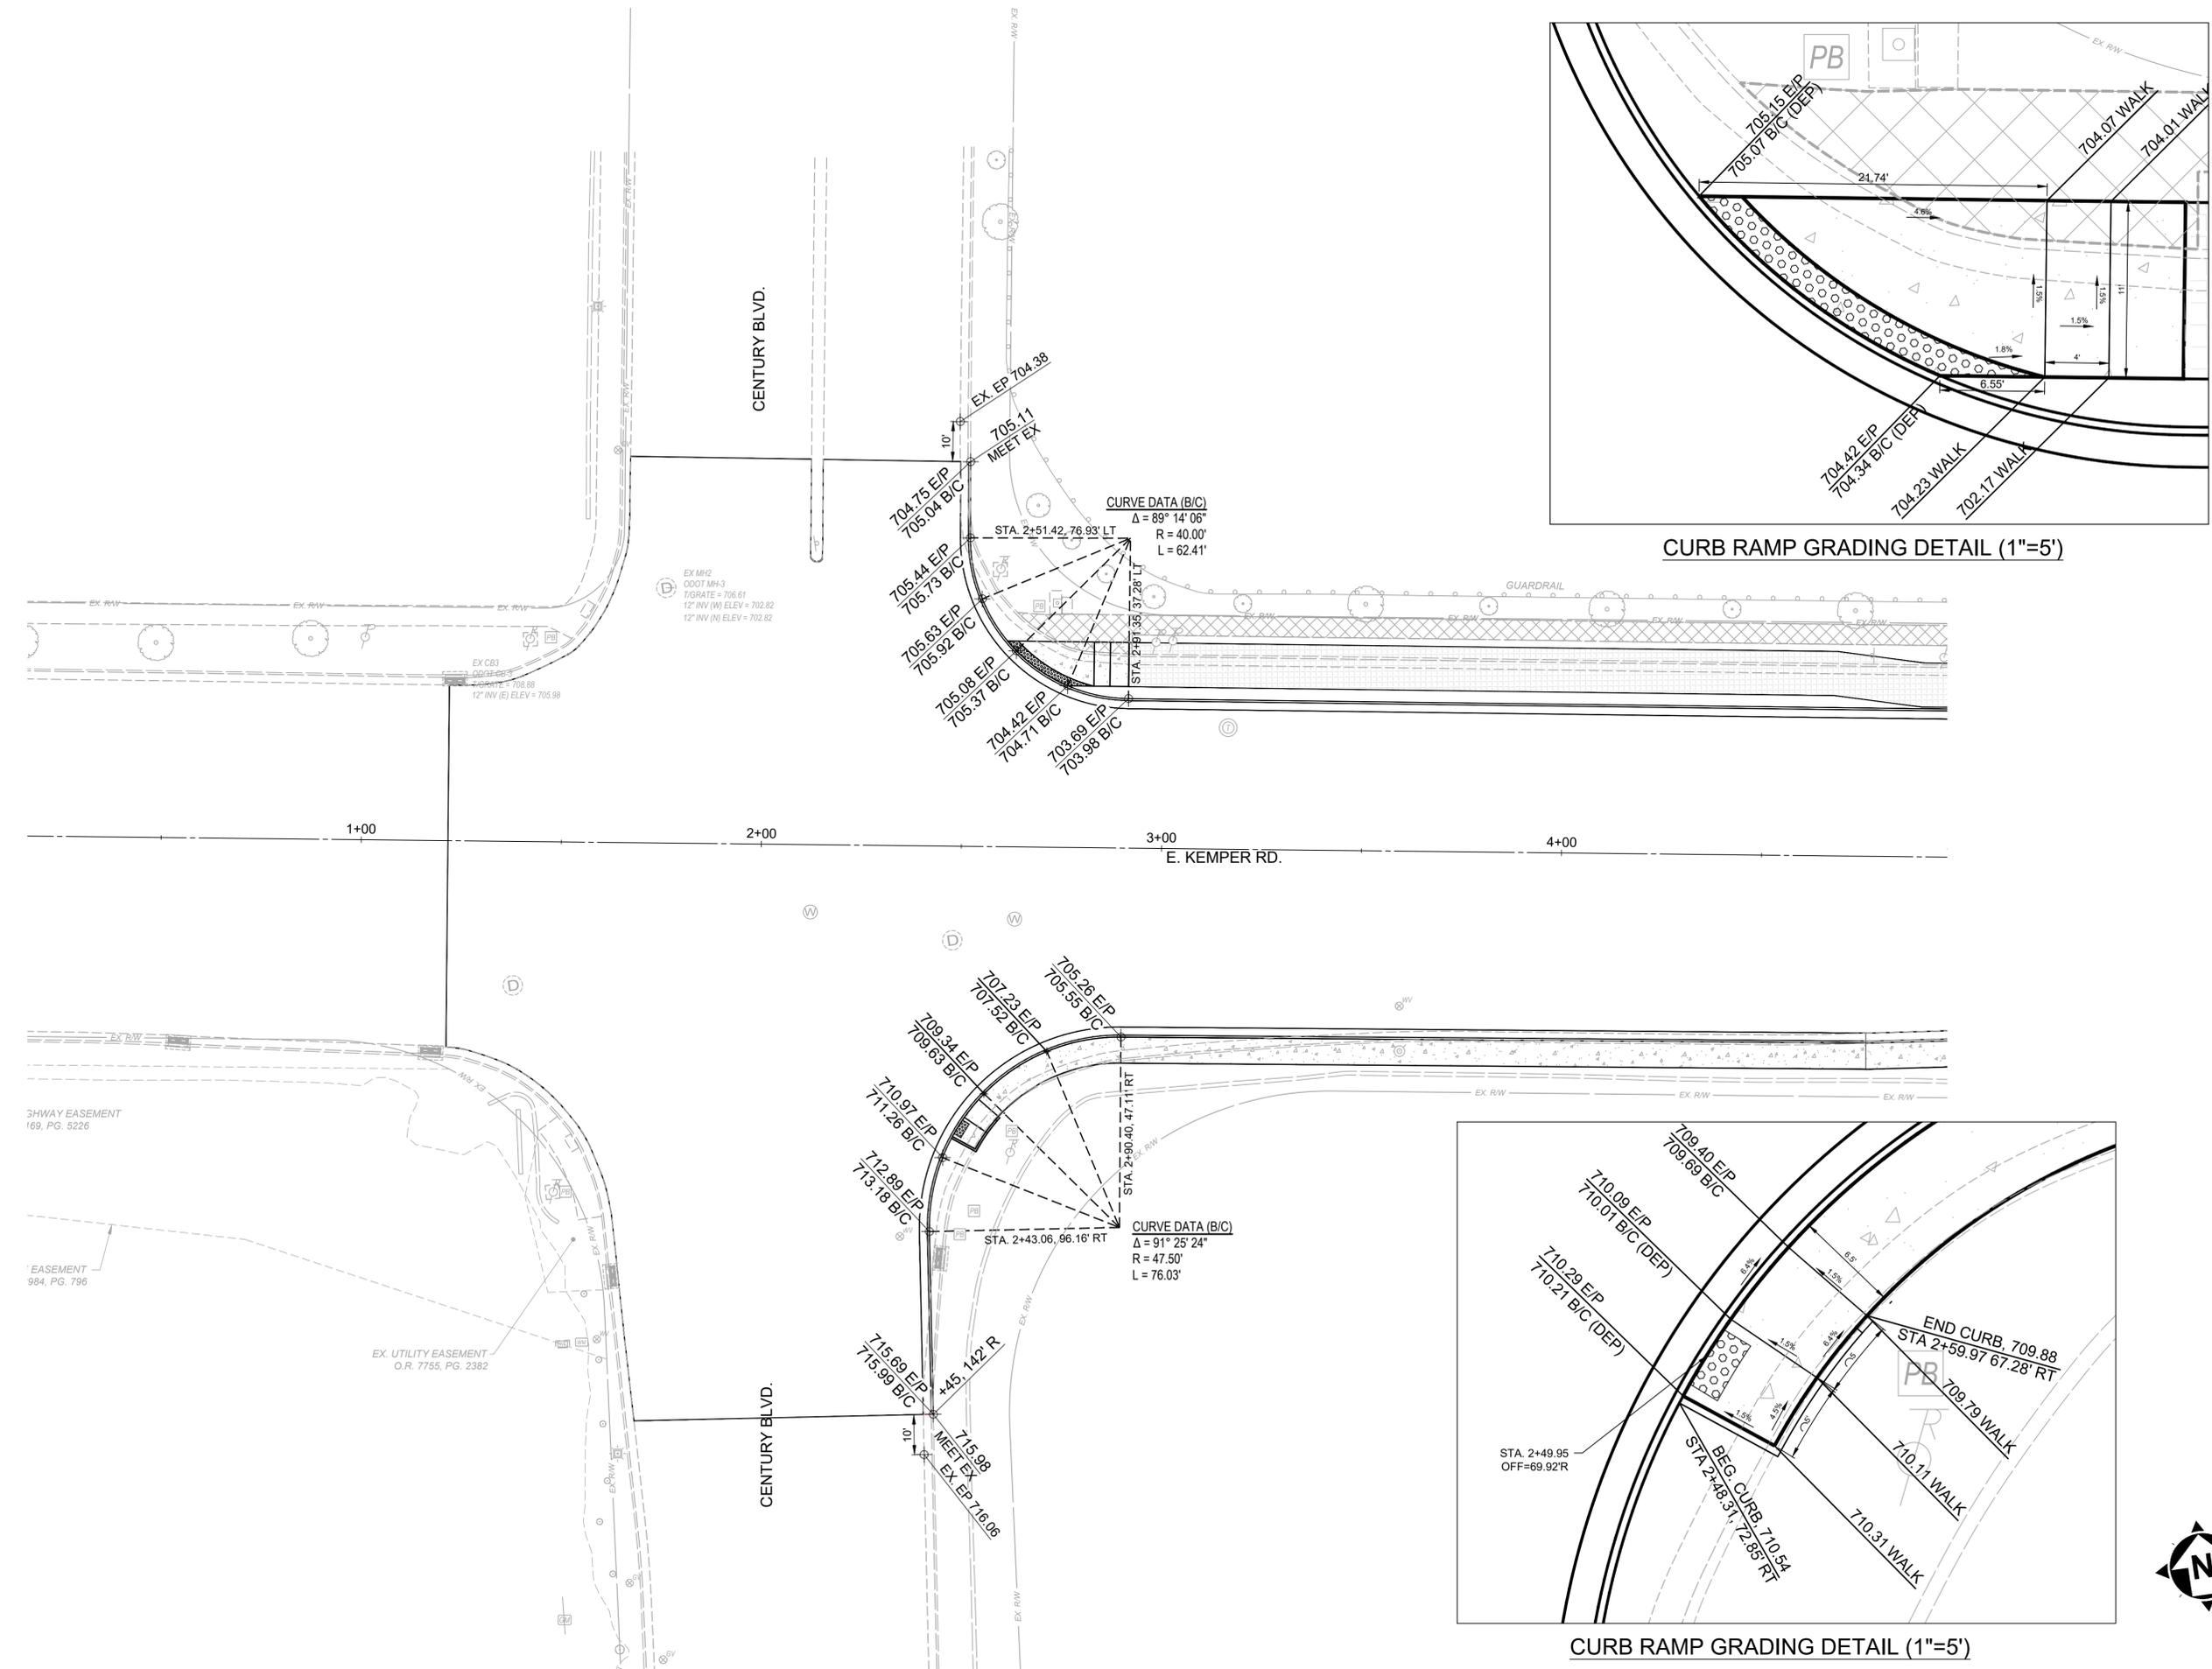

CURB RAMP GRADING DETAIL (1"=5')

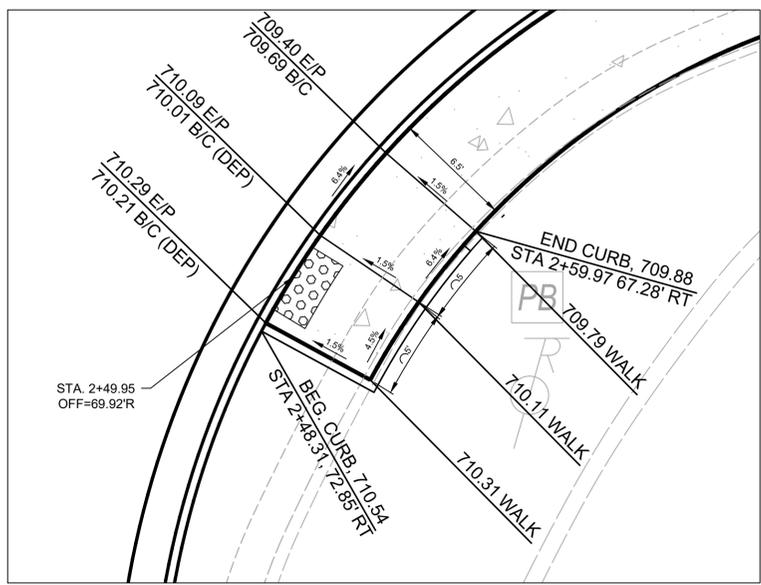


CURB RAMP GRADING DETAIL (1"=5')





ISSUED FOR:	BID NO.	DATE
ISSUE DATE:	02/04/2026	
SCALE:	1"=20'	
DESIGNED BY:	PMAD	
DRAWN BY:	PMAD	
CHECKED BY:	SRIG	

EAST KEMPER ROAD IMPROVEMENTS AND SHARED USE PATH, PH. 1
 CITY OF SPRINGDALE - HAMILTON COUNTY, OHIO
INTERSECTION DETAILS

PROJECT NO.	242429
DISCIPLINE	CIVIL
SHEET NAME	INT1
SHEET	25
OF	47

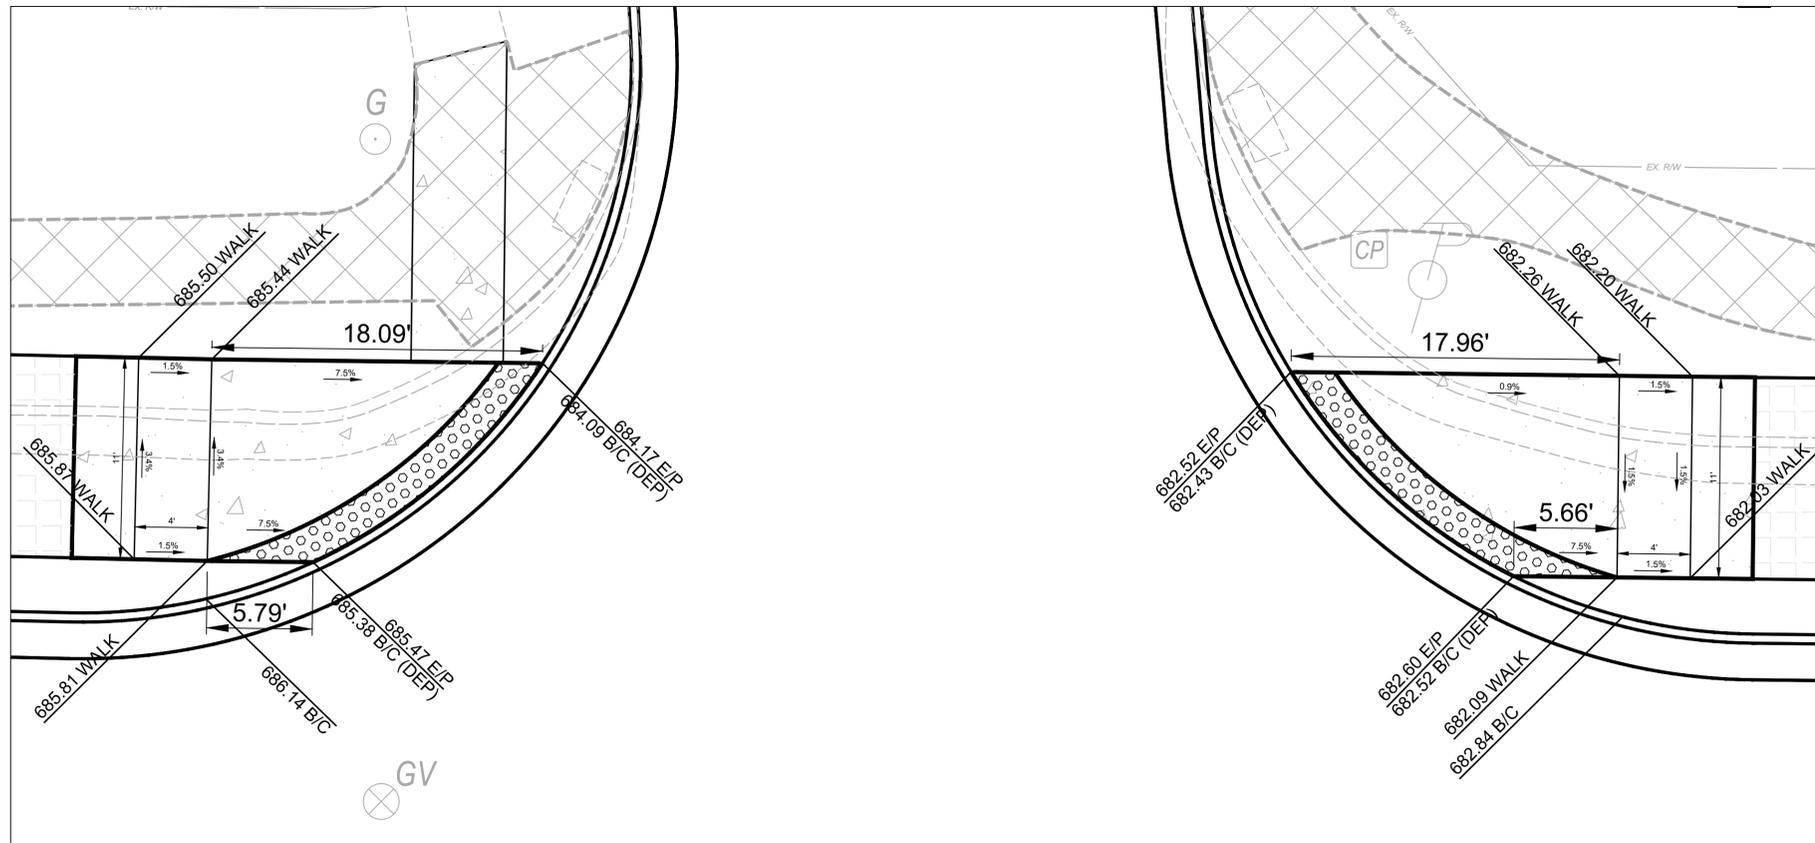

CURB RAMP GRADING DETAIL (1"=5')




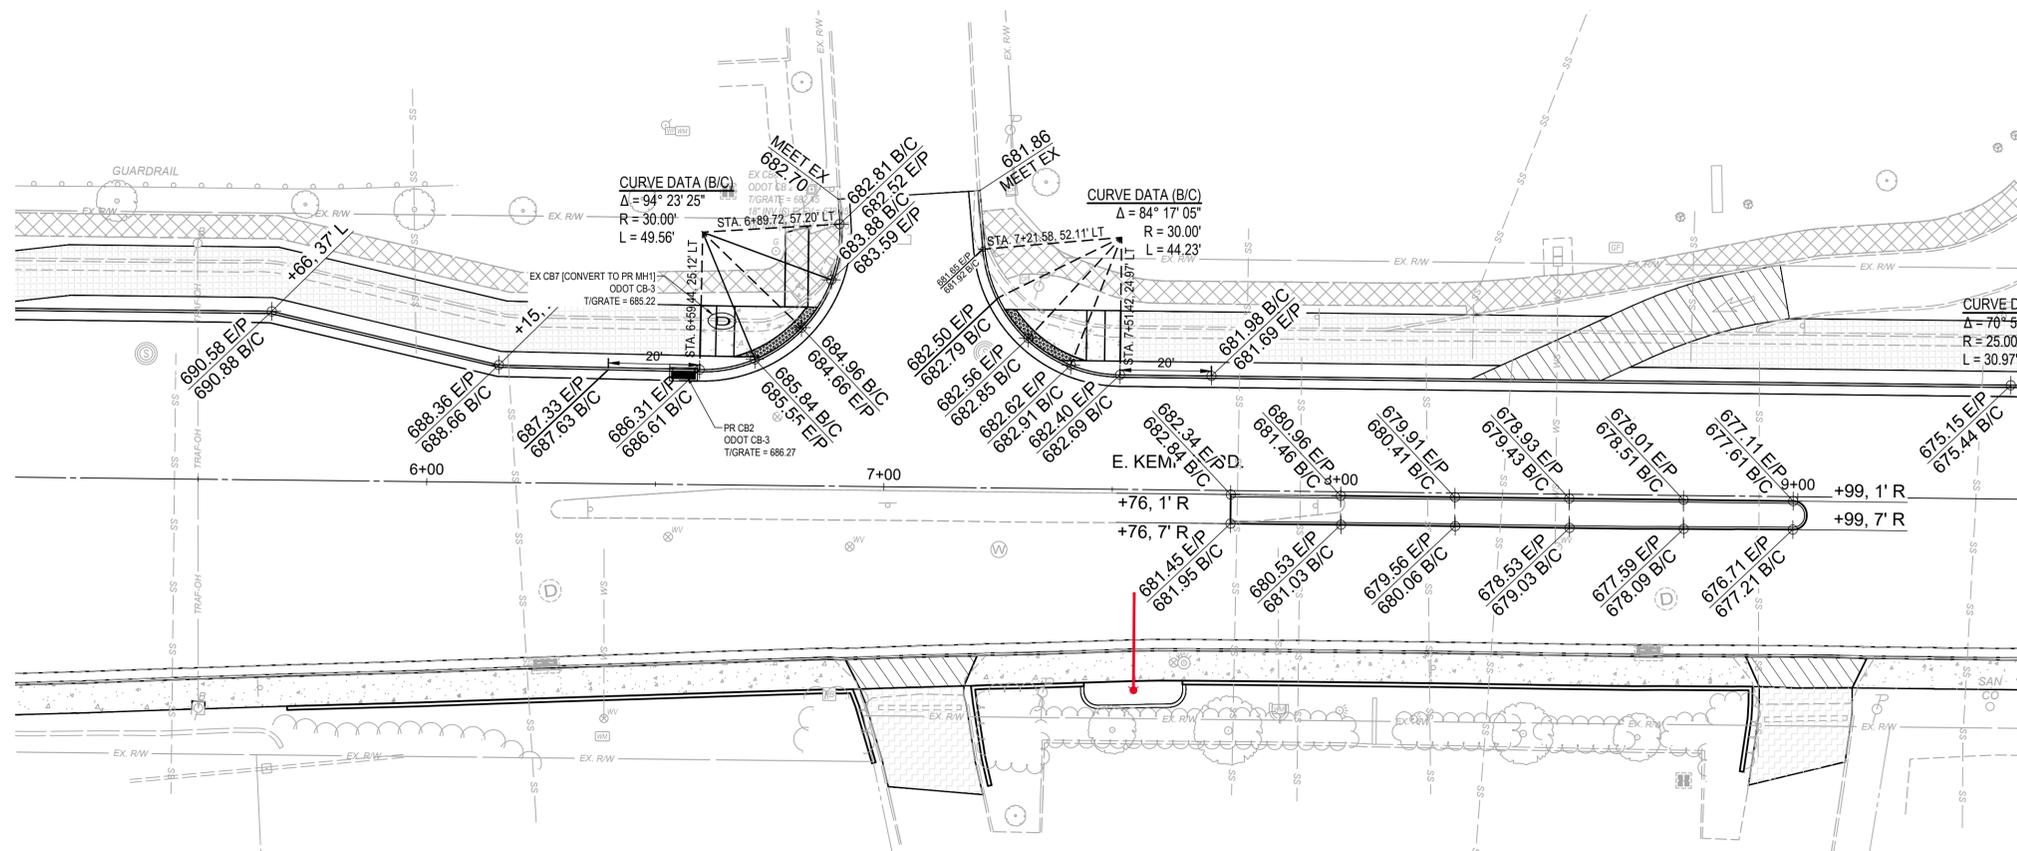
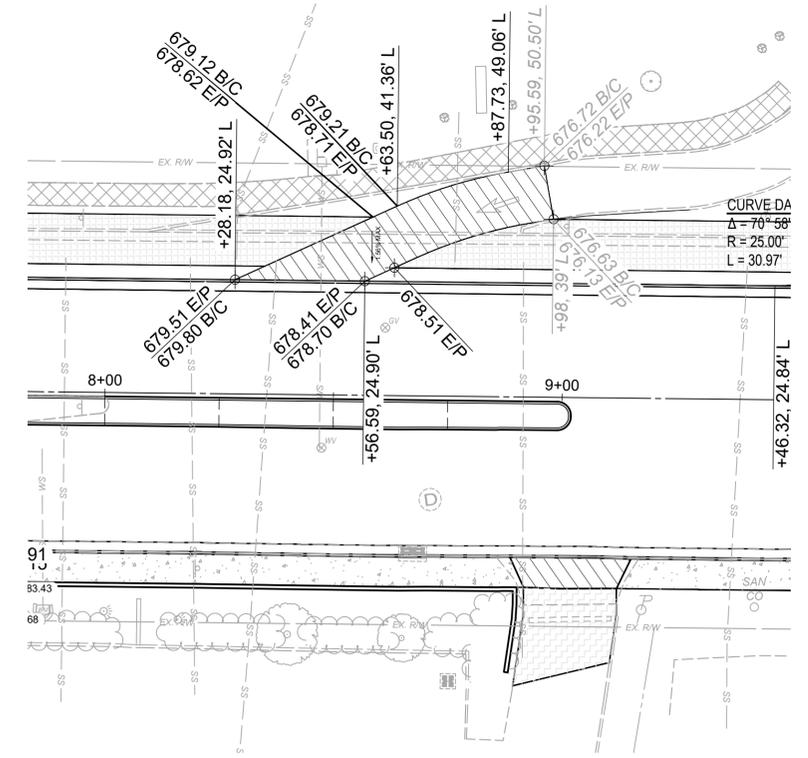


ISSUED FOR:	BID NO.	REVISION	DATE
ISSUE DATE:	02/04/2026		
SCALE:	1"=20'		
DESIGNED BY:	PMAD		
DRAWN BY:	PMAD		
CHECKED BY:	SRIG		


**EAST KEMPER ROAD
IMPROVEMENTS AND
SHARED USE PATH, PH. 1**
CITY OF SPRINGDALE - HAMILTON COUNTY, OHIO

INTERSECTION DETAILS

PROJECT NO.	242429
DISCIPLINE	CIVIL
SHEET NAME	INT2
SHEET	26
OF	47

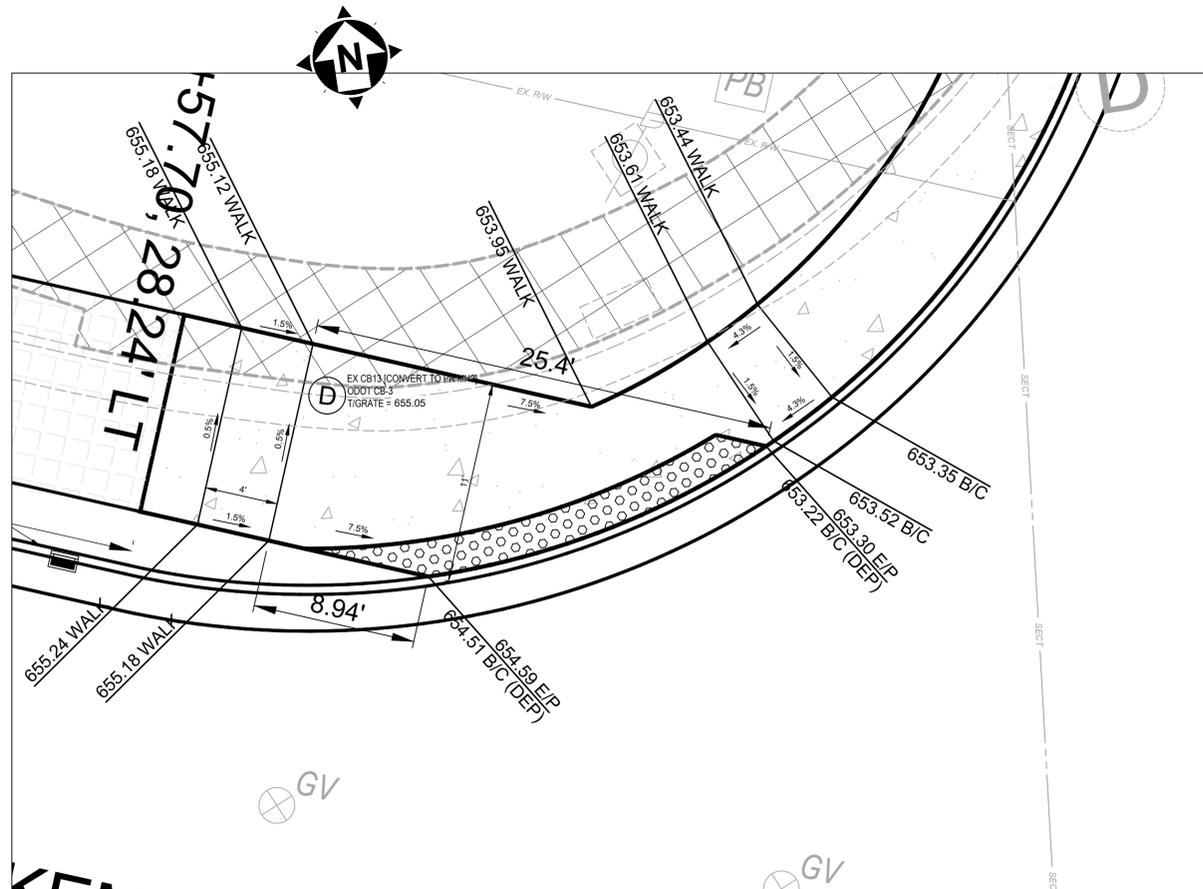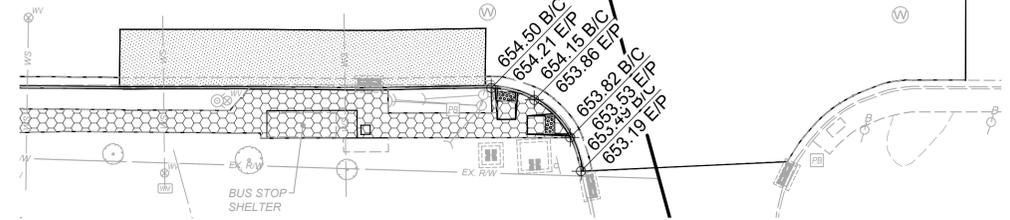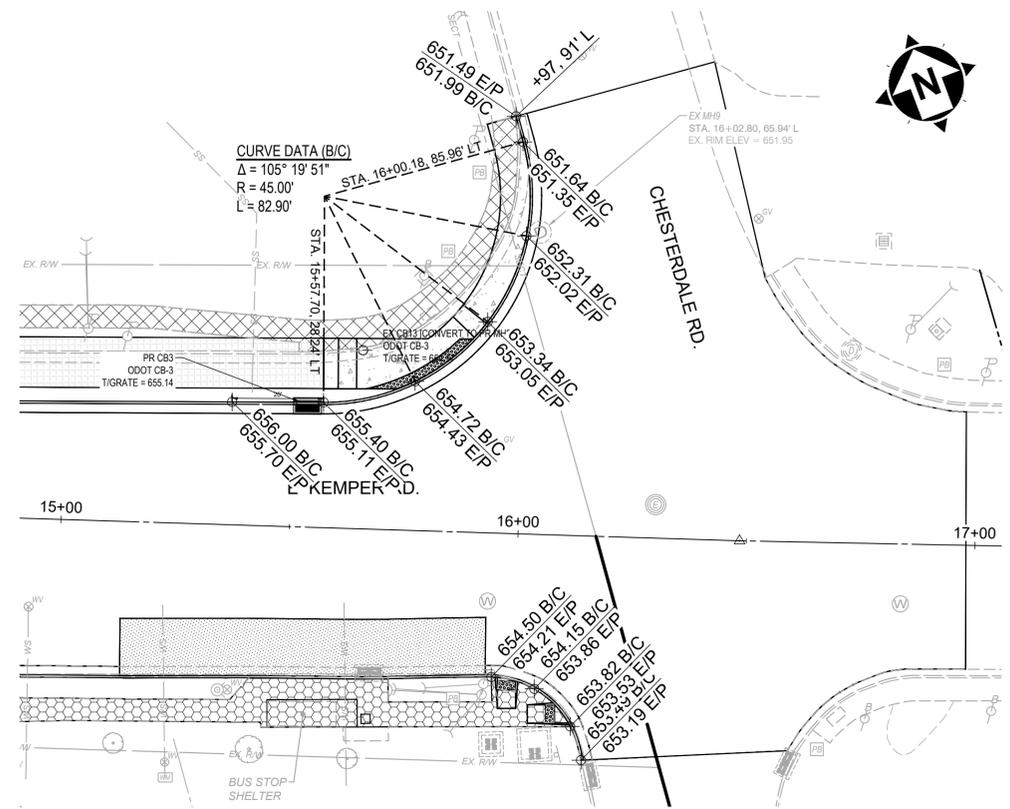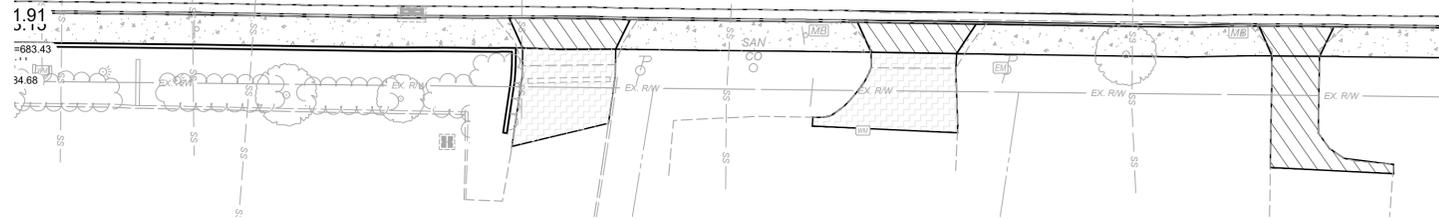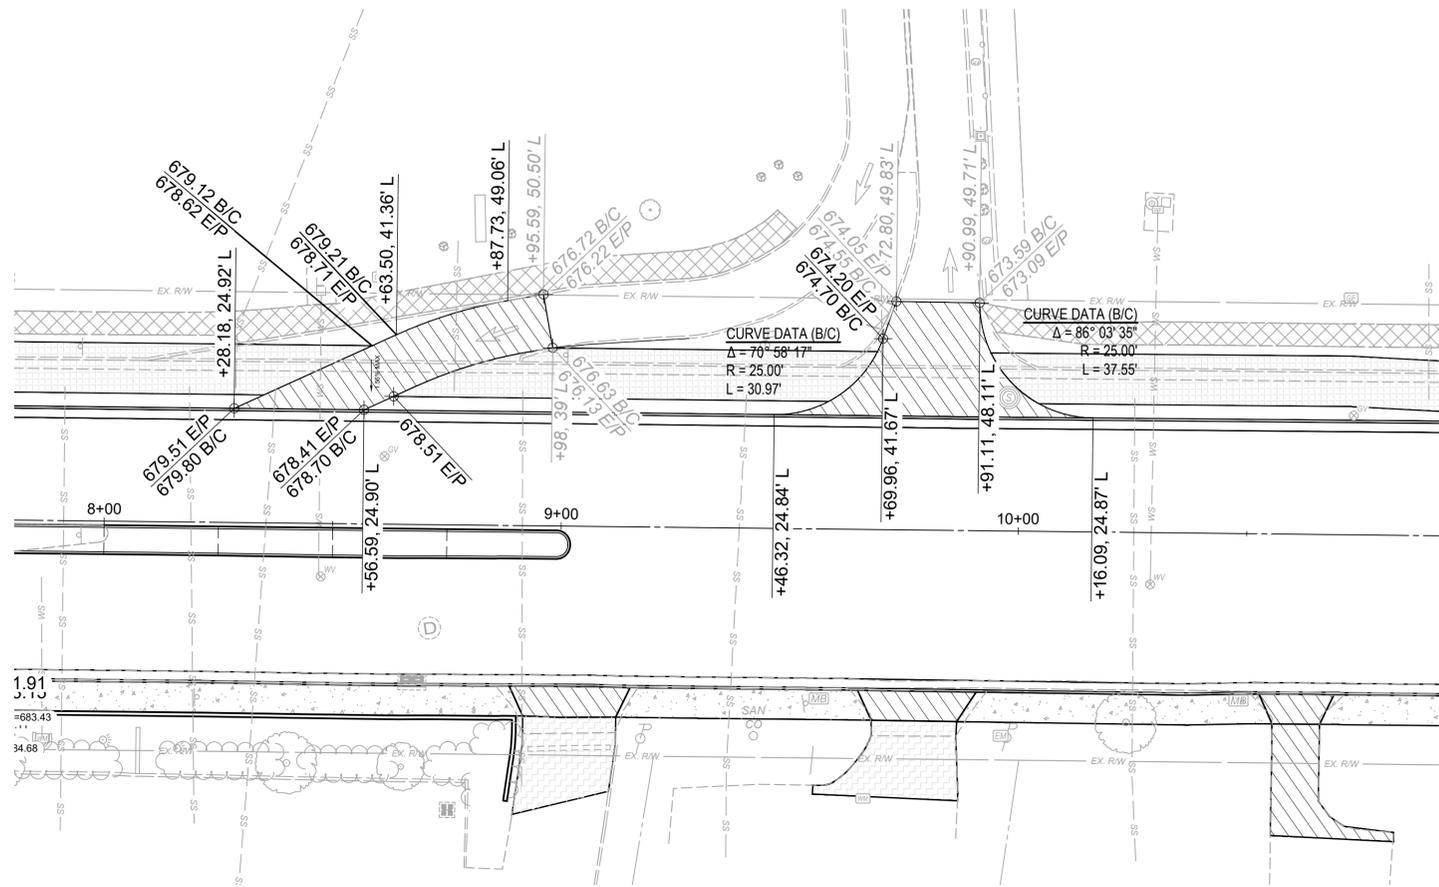

CURB RAMP GRADING DETAIL (1"=5')

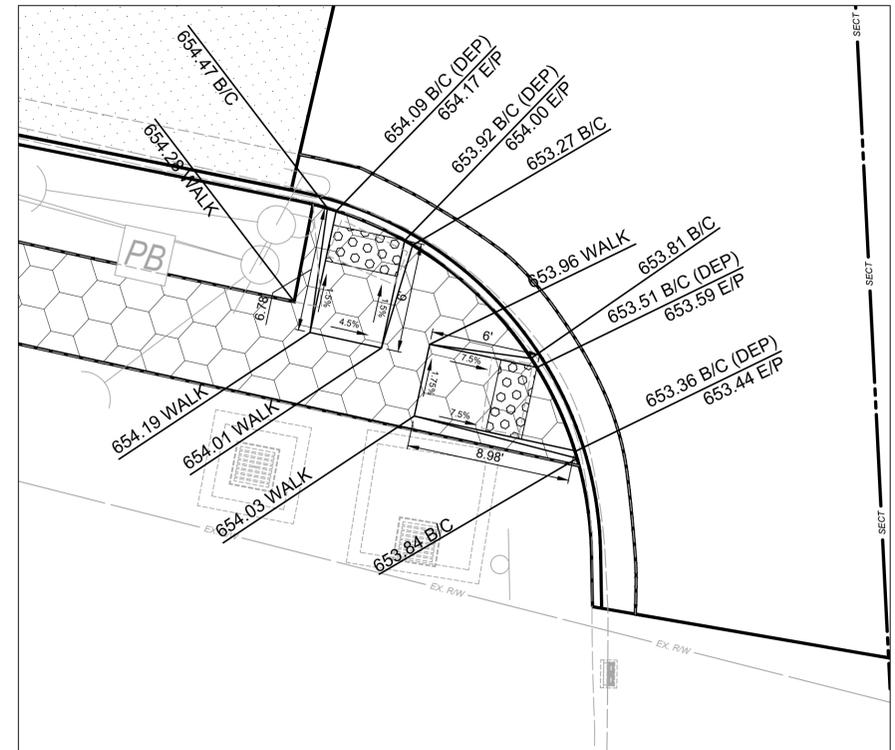


CURB RAMP GRADING DETAIL (1"=5')




ISSUED FOR:	BID NO.	REVISION	DATE
ISSUE DATE:	02/04/2026		
SCALE:	1"=20'		
DESIGNED BY:	PMAD		
DRAWN BY:	PMAD		
CHECKED BY:	SRIG		

EAST KEMPER ROAD IMPROVEMENTS AND SHARED USE PATH, PH. 1
 CITY OF SPRINGDALE - HAMILTON COUNTY, OHIO
INTERSECTION DETAILS

PROJECT NO.	242429
DISCIPLINE	CIVIL
SHEET NAME	INT3
SHEET	27
OF	47

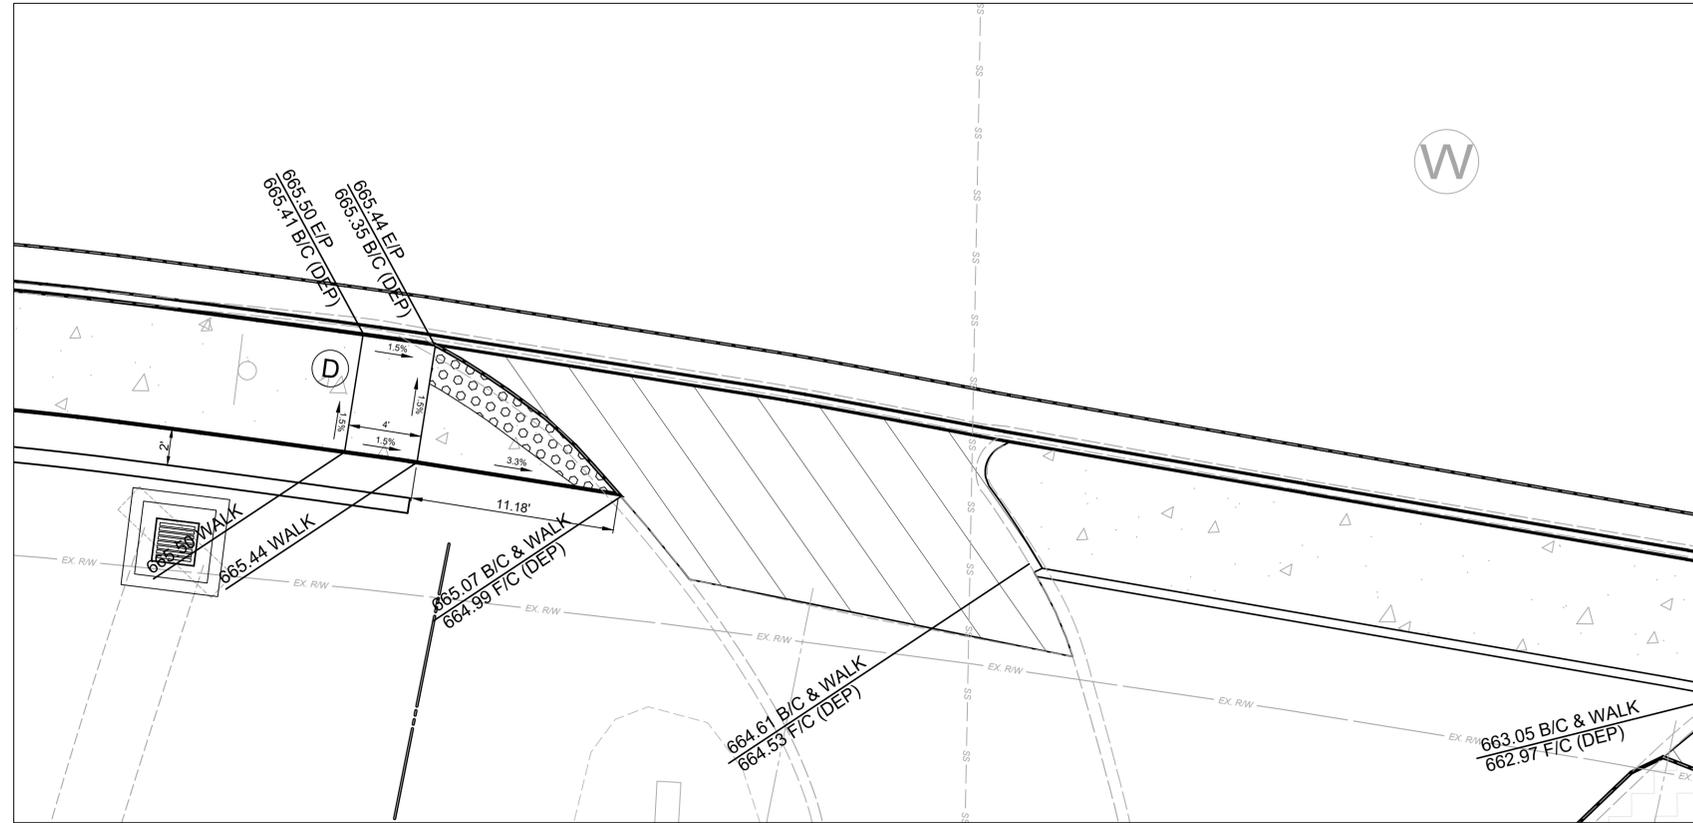

CURB RAMP GRADING DETAIL (1"=5')

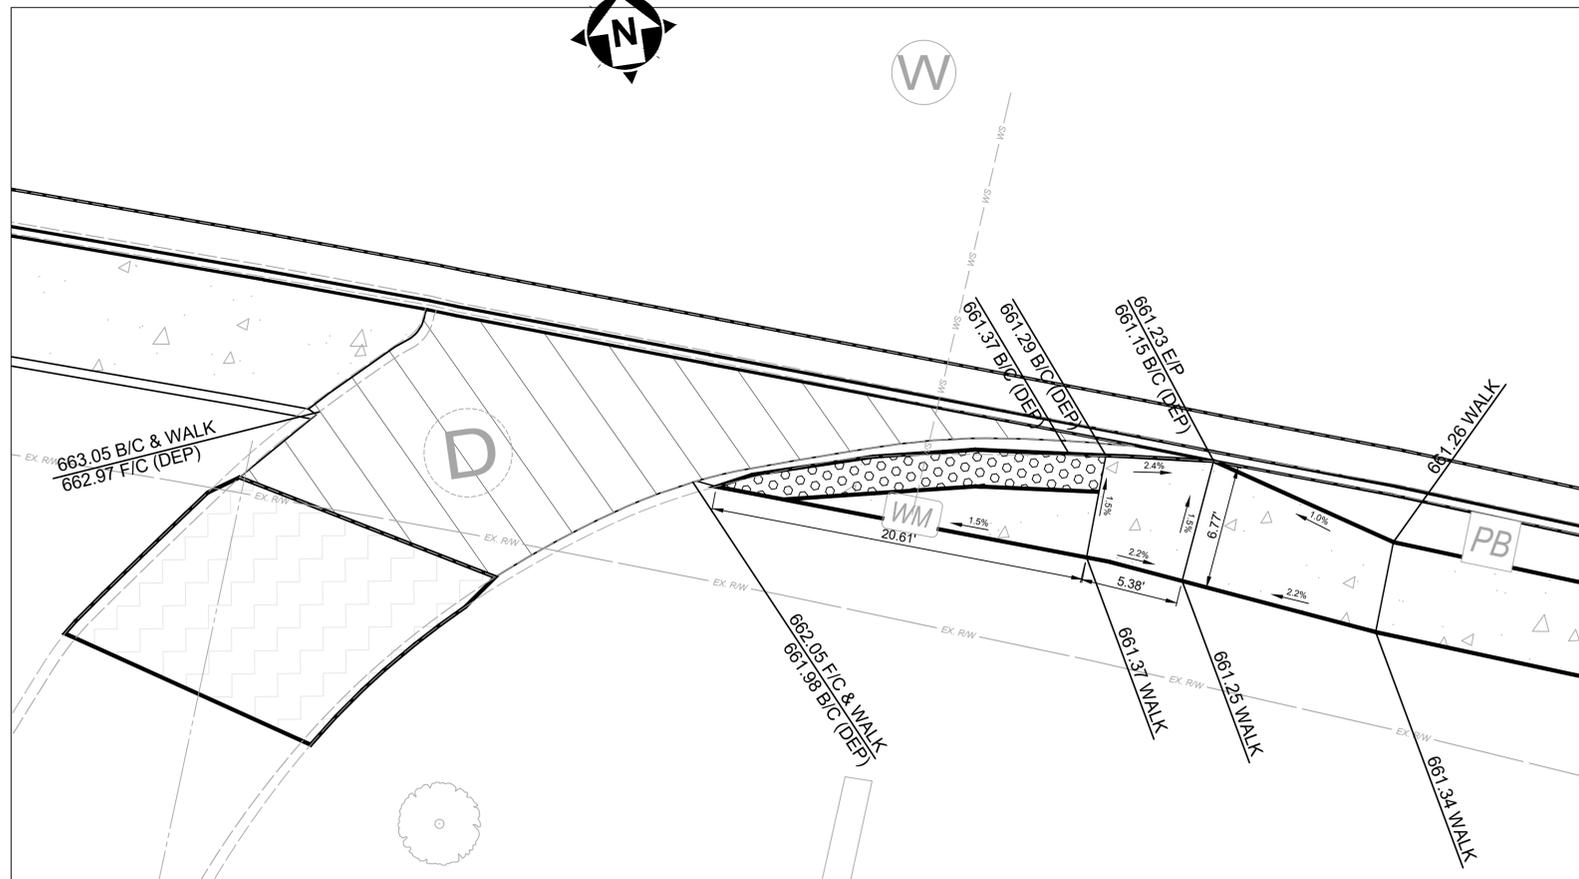



CURB RAMP GRADING DETAIL (1"=5')



ISSUED FOR:	BID NO.	REVISION	DATE
ISSUE DATE:	02/04/2026		
SCALE:	1"=20'		
DESIGNED BY:	PMAD		
DRAWN BY:	PMAD		
CHECKED BY:	SRIG		


EAST KEMPER ROAD IMPROVEMENTS AND SHARED USE PATH, PH. 1
 CITY OF SPRINGDALE - HAMILTON COUNTY, OHIO
INTERSECTION DETAILS

PROJECT NO.	242429
DISCIPLINE	CIVIL
SHEET NAME	INT4
SHEET	28
OF	47

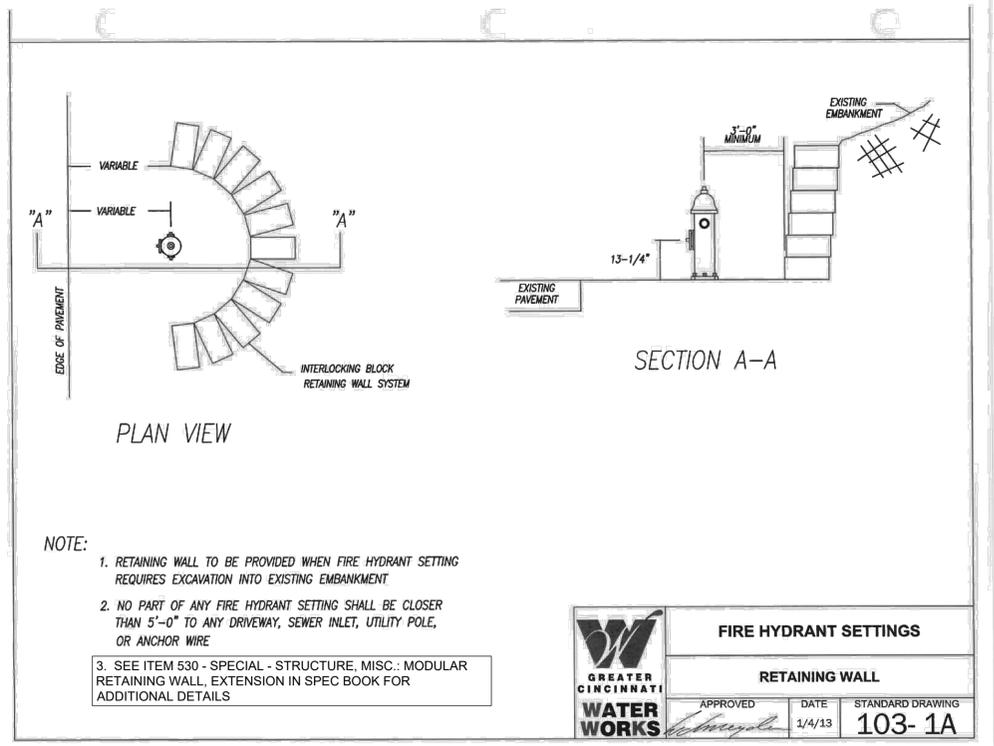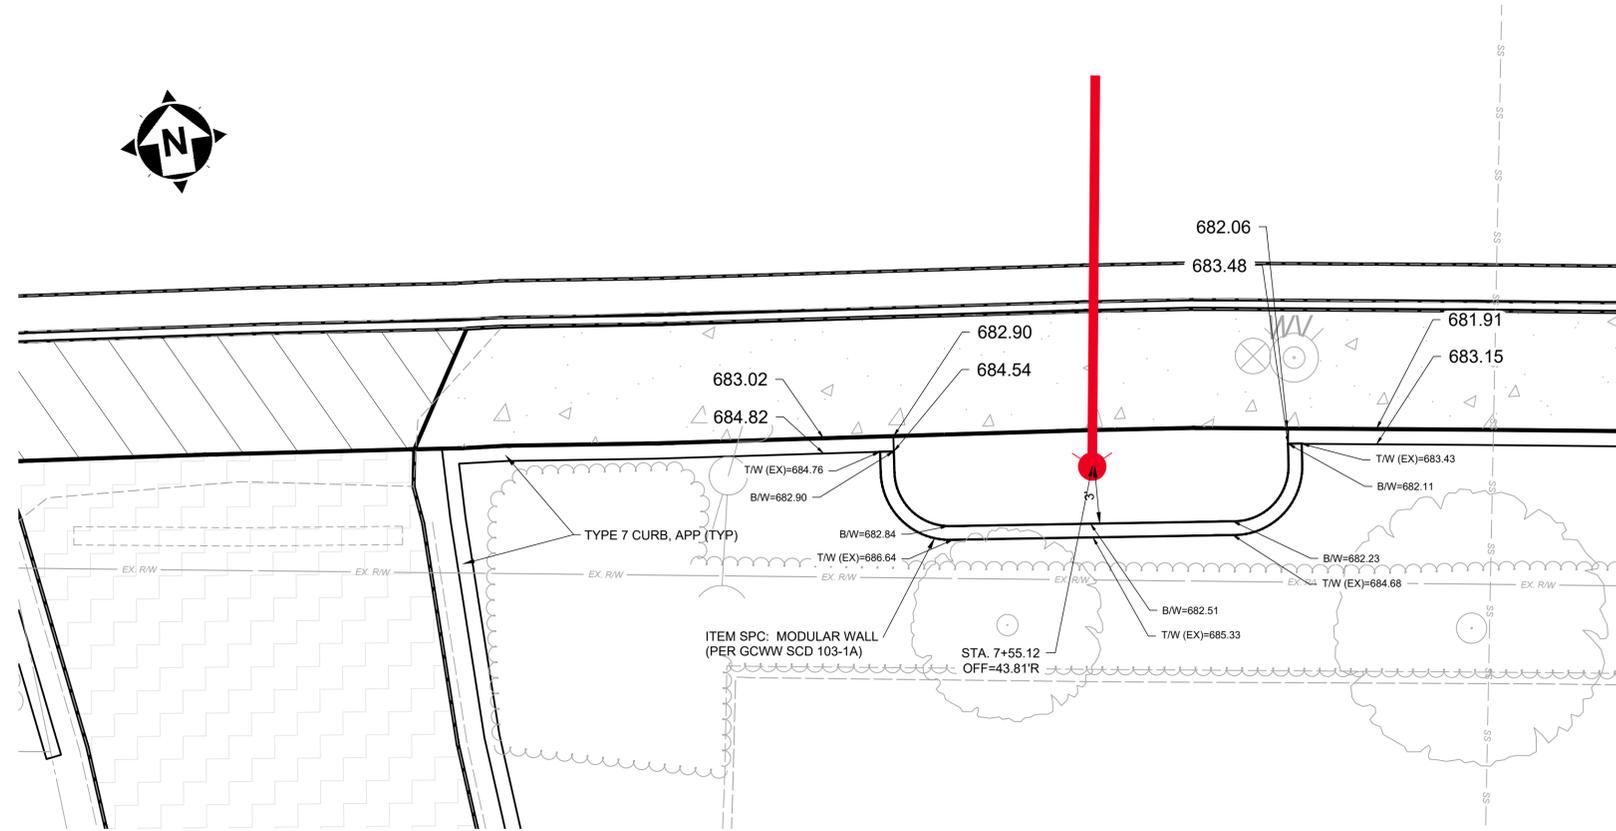

- NOTE:
1. RETAINING WALL TO BE PROVIDED WHEN FIRE HYDRANT SETTING REQUIRES EXCAVATION INTO EXISTING EMBANKMENT
 2. NO PART OF ANY FIRE HYDRANT SETTING SHALL BE CLOSER THAN 5'-0" TO ANY DRIVEWAY, SEWER INLET, UTILITY POLE, OR ANCHOR WIRE
 3. SEE ITEM 530 - SPECIAL - STRUCTURE, MISC.: MODULAR RETAINING WALL, EXTENSION IN SPEC BOOK FOR ADDITIONAL DETAILS


	FIRE HYDRANT SETTINGS		
	RETAINING WALL		
APPROVED	DATE	STANDARD DRAWING	
<i>[Signature]</i>	1/4/13	103- 1A	

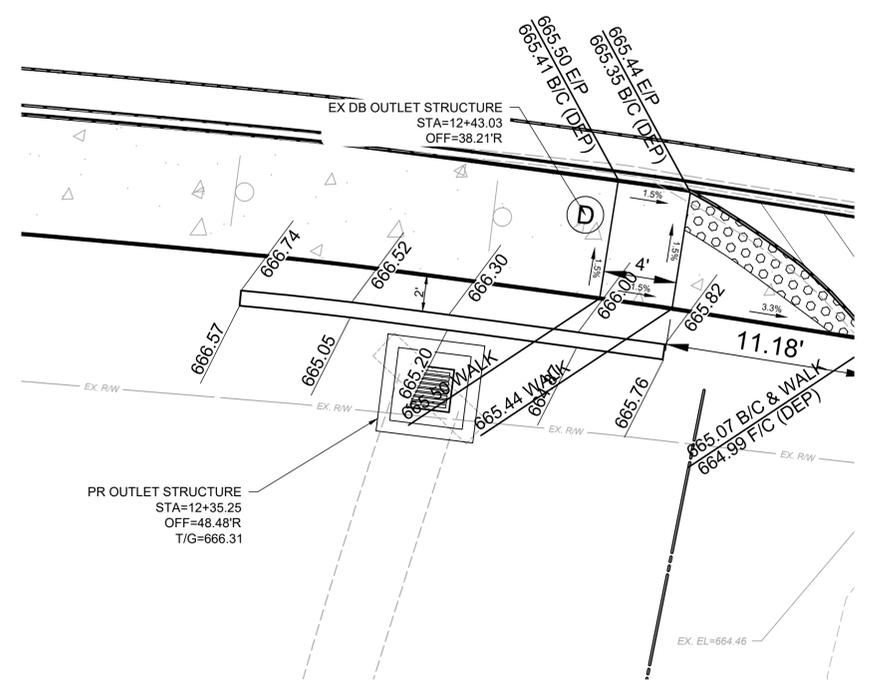


ISSUED FOR:	BID NO.	REVISION NO.	DATE
ISSUE DATE: 02/04/2026			
SCALE: 1"=5'			
DESIGNED BY: PMAD			
DRAWN BY: PMAD			
CHECKED BY: SRIG			

EAST KEMPER ROAD IMPROVEMENTS AND SHARED USE PATH, PH. 1
 CITY OF SPRINGDALE - HAMILTON COUNTY, OHIO
MODULAR WALL DETAILS


PROJECT NO.	242429
DISCIPLINE	CIVIL
SHEET NAME	MWALL
SHEET OF	29 47

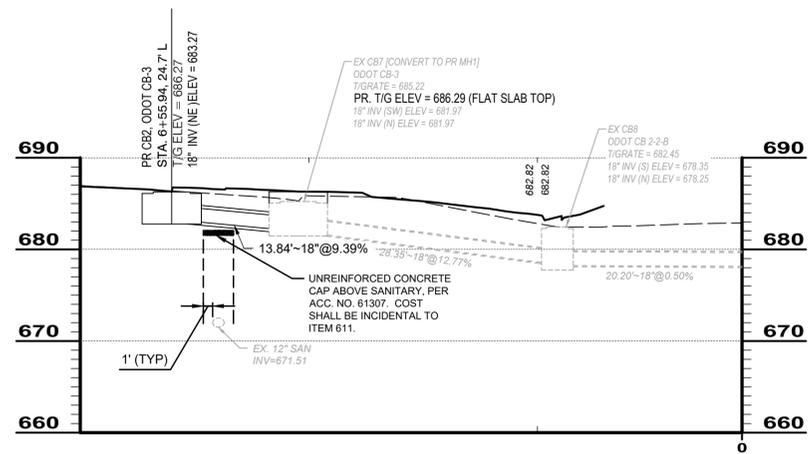

STM - STA 6+50

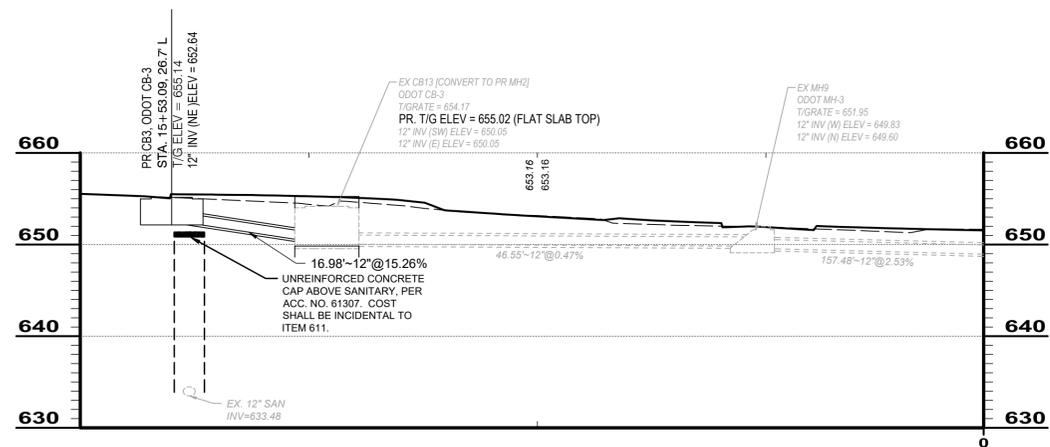

STM - STA 15+50

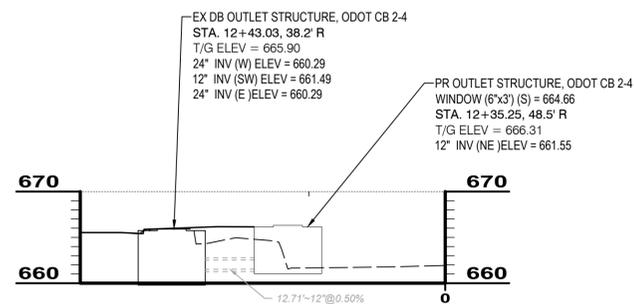


STM - DB OUTLET STRUCTURE RECONFIGURATION



ISSUED FOR:	BID NO.	REVISION	DATE
ISSUE DATE:	02/04/2026		
SCALE:	1"=10'		
DESIGNED BY:	PMAD		
DRAWN BY:	PMAD		
CHECKED BY:	SRIG		

EAST KEMPER ROAD IMPROVEMENTS AND SHARED USE PATH, PH. 1
 CITY OF SPRINGDALE - HAMILTON COUNTY, OHIO
STORM PROFILES

PROJECT NO.	242429
DISCIPLINE	CIVIL
SHEET NAME	STM PRO
SHEET	30
OF	47

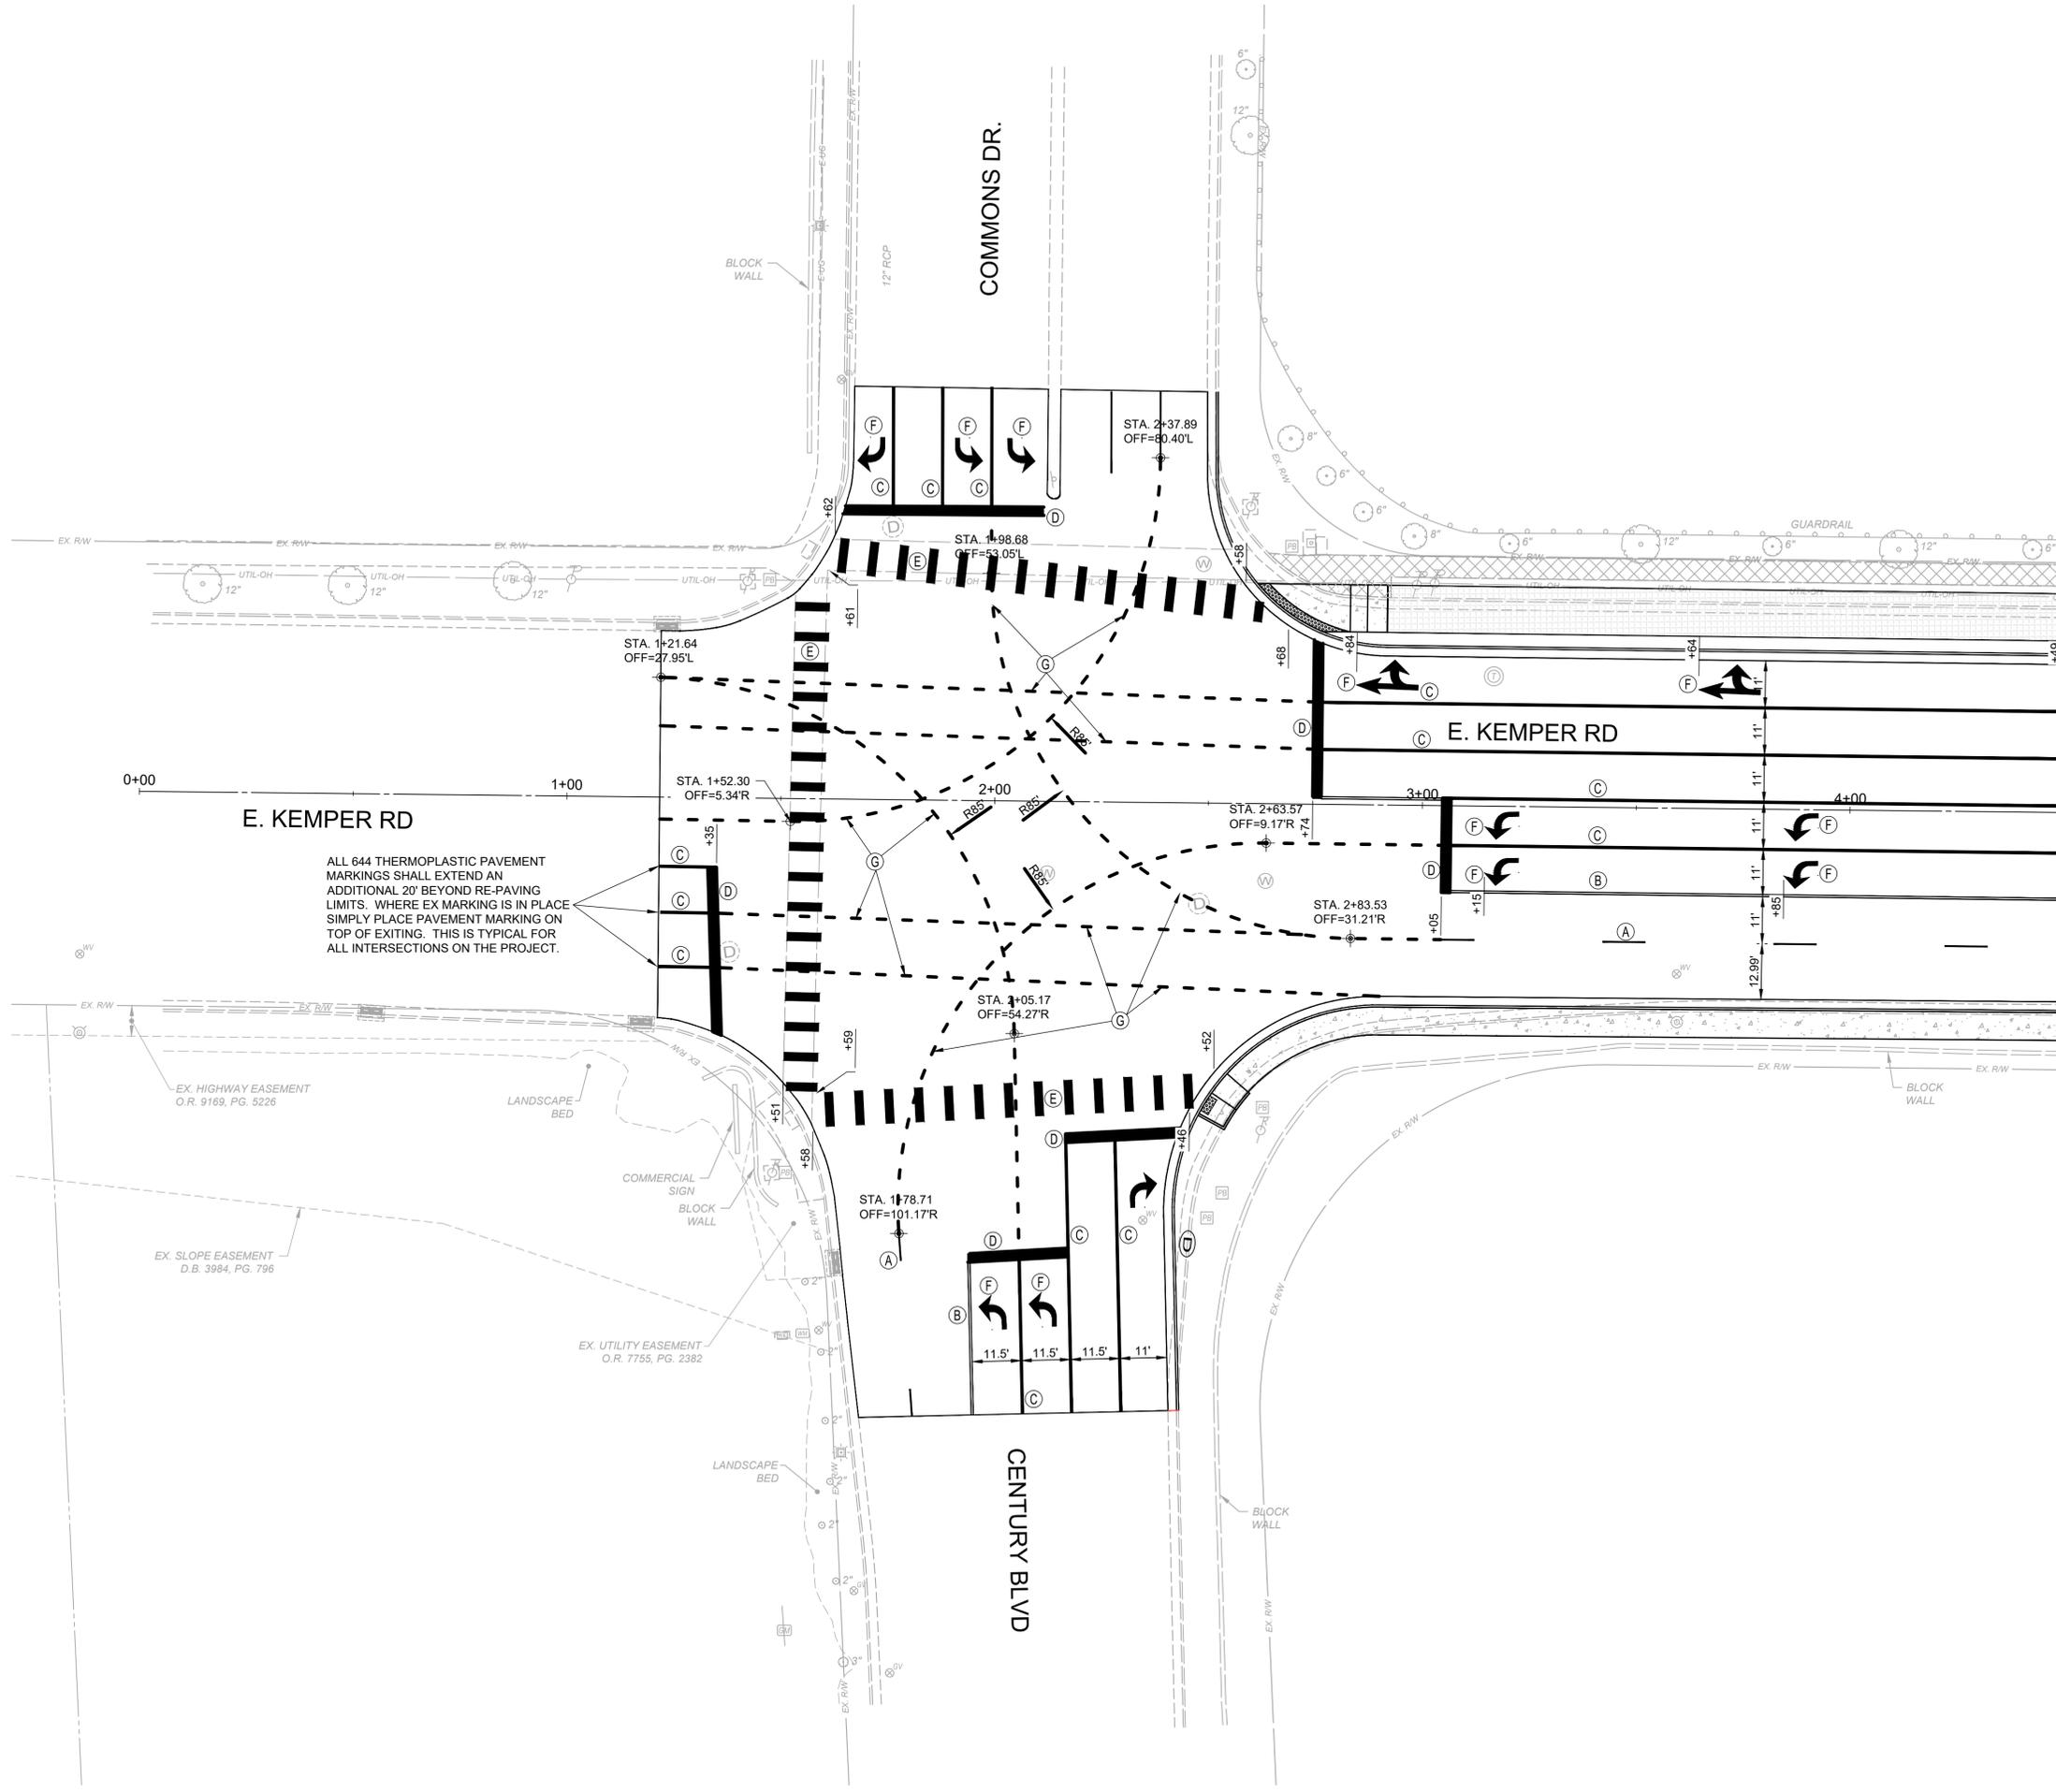

ALL 644 THERMOPLASTIC PAVEMENT MARKINGS SHALL EXTEND AN ADDITIONAL 20' BEYOND RE-PAVING LIMITS. WHERE EX MARKING IS IN PLACE SIMPLY PLACE PAVEMENT MARKING ON TOP OF EXISTING. THIS IS TYPICAL FOR ALL INTERSECTIONS ON THE PROJECT.

- KEYNOTES**
- (A) LANE LINE, 6"
 - (B) CENTER LINE, 4"
 - (C) CHANNELIZING LINE, 8"
 - (D) STOP LINE, 24"
 - (E) CROSSWALK LINE, 24" (ODOT SCD TC-74.10) (LAYOUT TO AVOID WHEEL PATH)
 - (F) LANE ARROW
 - (G) DOTTED LINE, 6" (2' LINE, 4' GAP)
 - (H) TRANSVERSE LINE, 24"
- NOTE: INSTALL RAISED PAVEMENT MARKERS WITHIN PROJECT LIMITS PER ODOT SCD TC-65.10 AND TC-65.11

ITEM 621 - RPM, AS PER PLAN
2-WAY BLUE/BLUE RPM'S AT FIRE HYDRANT LOCATION IN LANE LINE ON SAME SIDE AS FIRE HYDRANT (CITY)

NOTE:
REPLACE PAVEMENT MARKINGS IN KIND. PROVIDE TURN LANES WITH APPROPRIATE ARROWS, CHANNELIZATION MARKINGS, ETC. WITH APPROPRIATE ITEM 644 THERMOPLASTIC PAVEMENT MARKINGS.

WET PAVEMENT MARKINGS SHALL BE PLACED IN ACCORDANCE SUPPLEMENTARY SPECIFICATION 807: WET REFLECTIVE LIQUID APPLIED PAVEMENT MARKINGS. HOWEVER GROUING FOR THE WET REFLECTIVE PAVEMENT MARKINGS IS NOT REQUIRED.

NOTE:
ITEM 630 SIGN POST REFLECTOR SHALL BE ADDED TO ALL NEW SIGN POSTS, ACCORDING TO THE OHIO MANUAL OF UNIFORM TRAFFIC CONTROL DEVICES.

NOTE:
ALL SIGNAGE LOCATED INSIDE THE CONCRETE ISLAND SHALL USE KLEEN BREAK 425 ASSEMBLY - SURFACE MOUNT (XKBSM42520-G)

MATCHLINE 4+50




NO	REVISION	DATE

EAST KEMPER ROAD IMPROVEMENTS AND SHARED USE PATH, PH. 1
CITY OF SPRINGDALE - HAMILTON COUNTY, OHIO

TRAFFIC CONTROL PLAN 1

PROJECT NO.	242429
DISCIPLINE	CIVIL
SHEET NAME	PM1
SHEET	OF
31	47



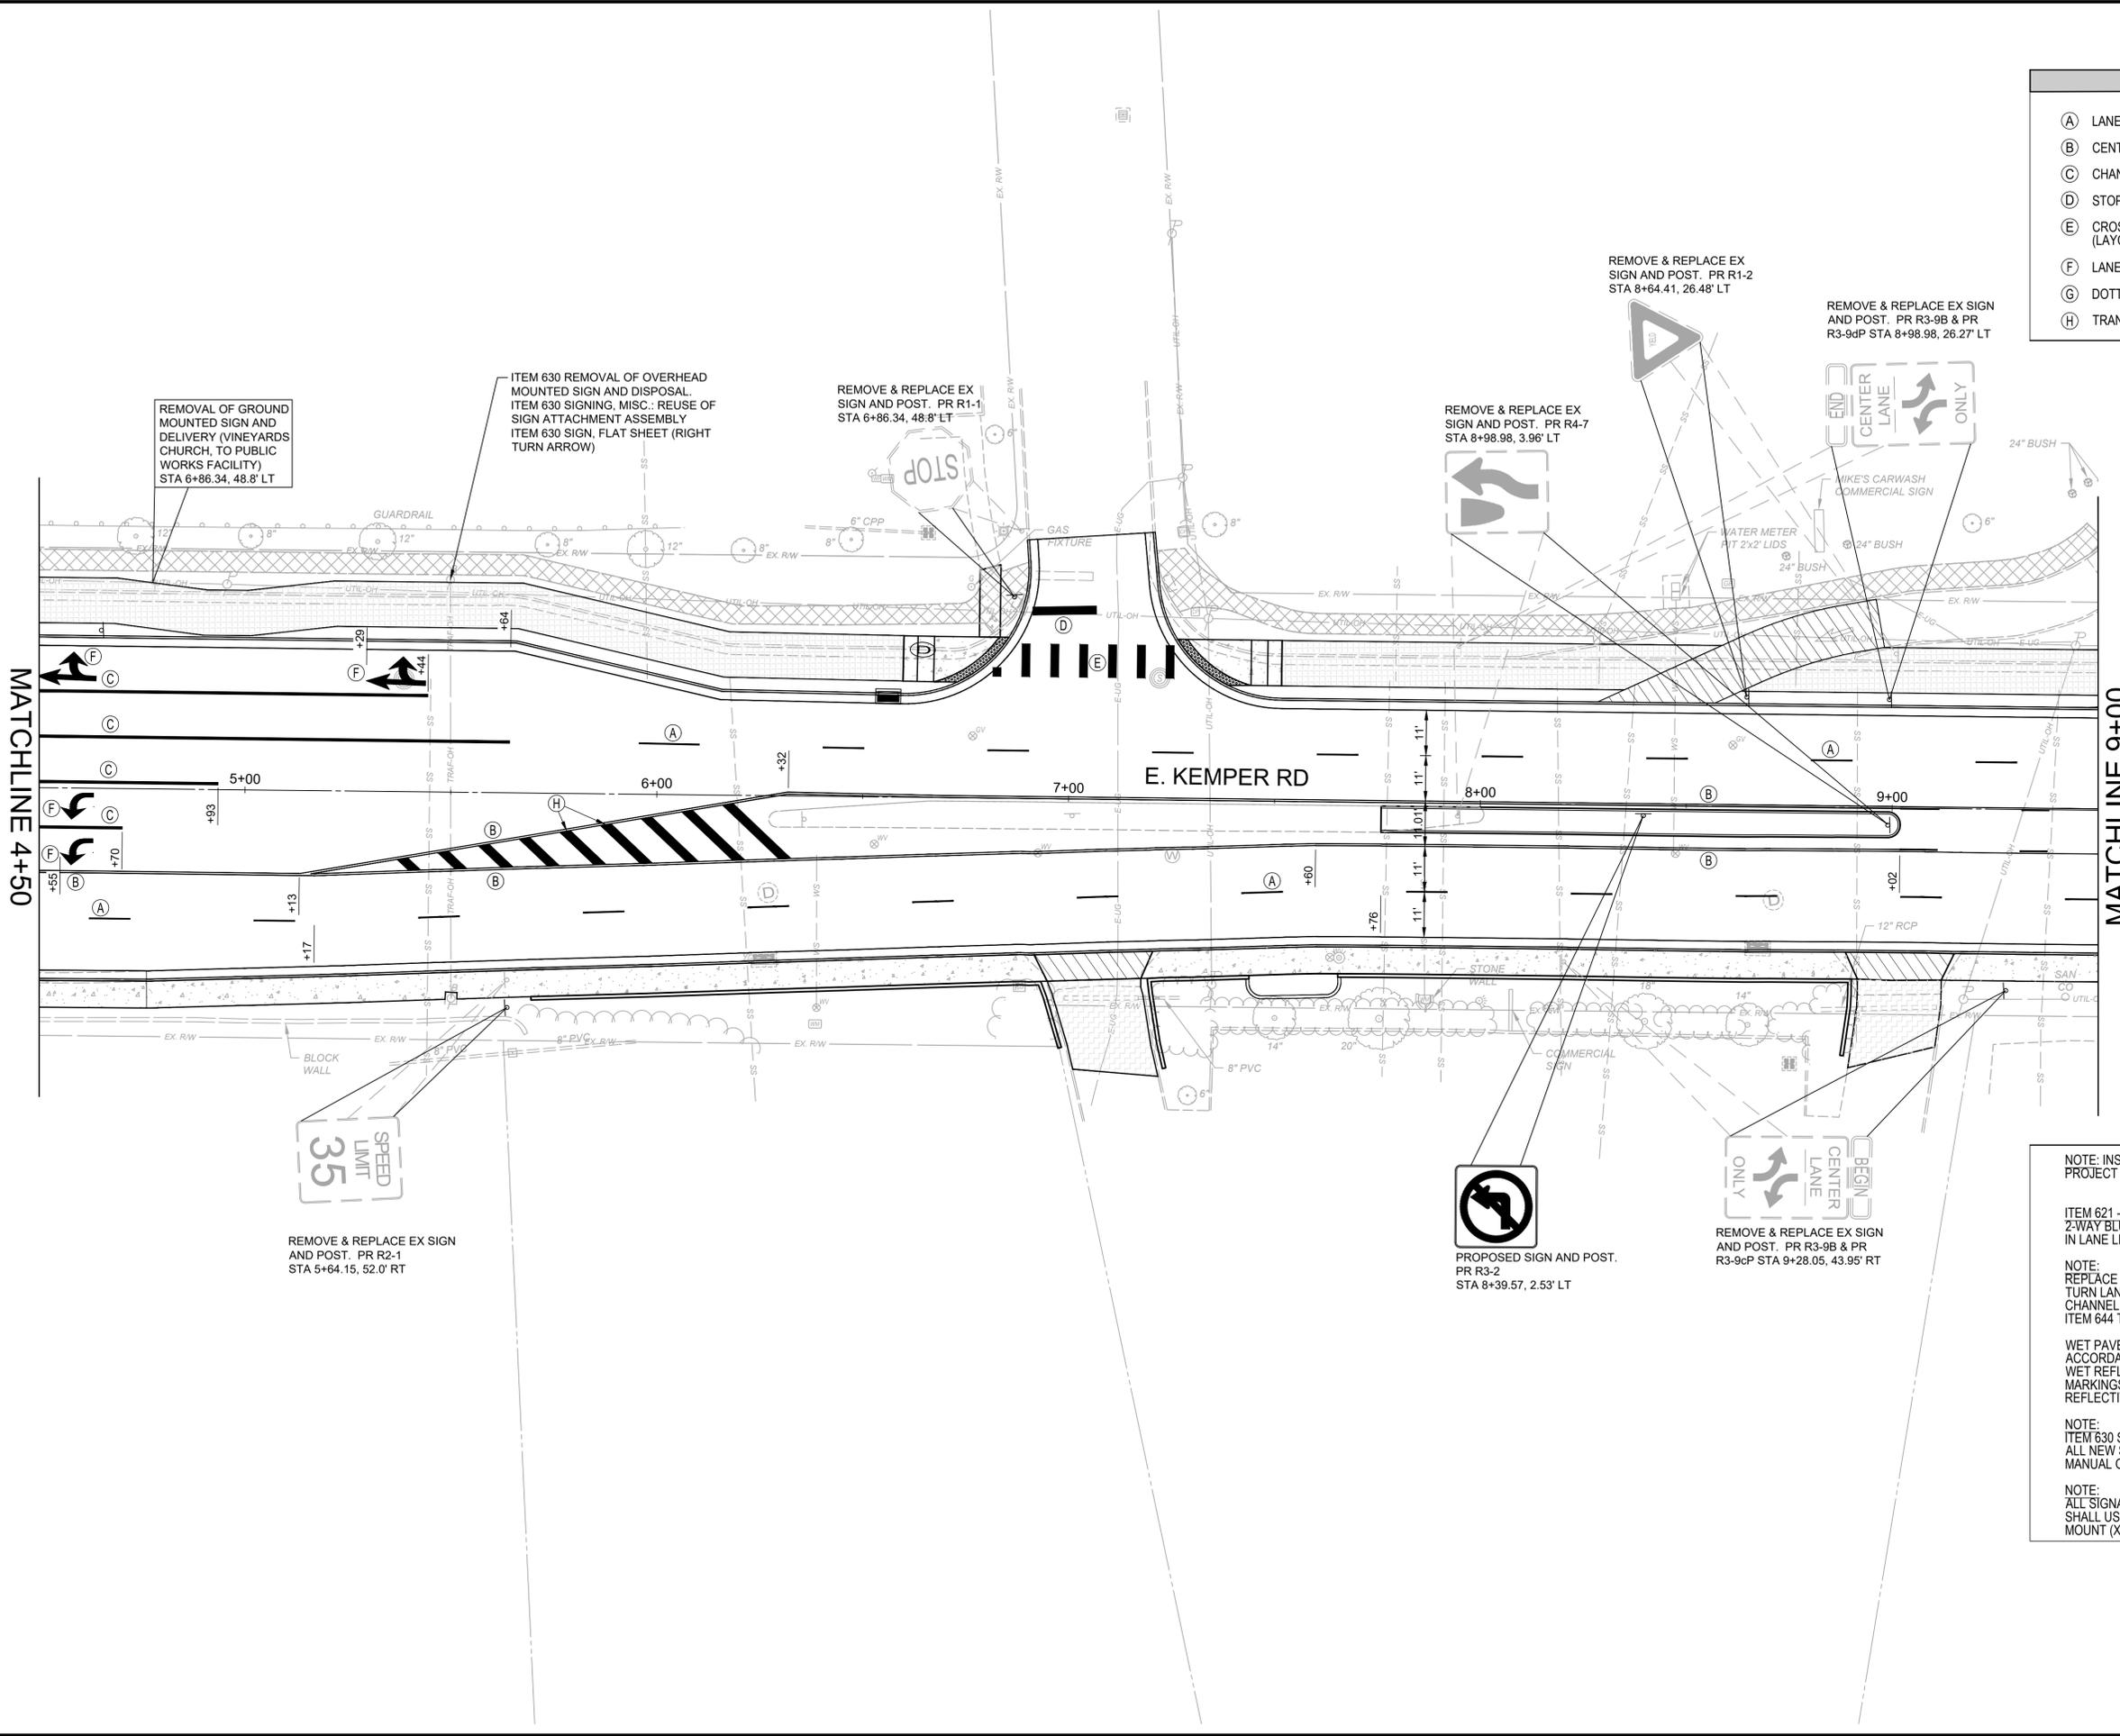

KEYNOTES	
(A)	LANE LINE, 6"
(B)	CENTER LINE, 4"
(C)	CHANNELIZING LINE, 8"
(D)	STOP LINE, 24"
(E)	CROSSWALK LINE, 24" (ODOT SCD TC-74.10) (LAYOUT TO AVOID WHEEL PATH)
(F)	LANE ARROW
(G)	DOTTED LINE, 6" (2' LINE, 4' GAP)
(H)	TRANSVERSE LINE, 24"

NOTE: INSTALL RAISED PAVEMENT MARKERS WITHIN PROJECT LIMITS PER ODOT SCD TC-65.10 AND TC-65.11

ITEM 621 - RPM, AS PER PLAN
2-WAY BLUE/BLUE RPM'S AT FIRE HYDRANT LOCATION IN LANE LINE ON SAME SIDE AS FIRE HYDRANT (CITY)

NOTE:
REPLACE PAVEMENT MARKINGS IN KIND. PROVIDE TURN LANES WITH APPROPRIATE ARROWS, CHANNELIZATION MARKINGS, ETC. WITH APPROPRIATE ITEM 644 THERMOPLASTIC PAVEMENT MARKINGS.

WET PAVEMENT MARKINGS SHALL BE PLACED IN ACCORDANCE SUPPLEMENTARY SPECIFICATION 807: WET REFLECTIVE LIQUID APPLIED PAVEMENT MARKINGS. HOWEVER GROUING FOR THE WET REFLECTIVE PAVEMENT MARKINGS IS NOT REQUIRED.

NOTE:
ITEM 630 SIGN POST REFLECTOR SHALL BE ADDED TO ALL NEW SIGN POSTS, ACCORDING THE THE OHIO MANUAL OF UNIFORM TRAFFIC CONTROL DEVICES.

NOTE:
ALL SIGNAGE LOCATED INSIDE THE CONCRETE ISLAND SHALL USE KLEEN BREAK 425 ASSEMBLY - SURFACE MOUNT (XKBSM42520-G)



ISSUED FOR:	BID NO:	REVISION:	DATE:
ISSUE DATE: 02/04/2026	02/04/2026		
SCALE: XX"=XX'			
DESIGNED BY: PMAD			
DRAWN BY: PMAD			
CHECKED BY: SRIG			

EAST KEMPER ROAD IMPROVEMENTS AND SHARED USE PATH, PH. 1
CITY OF SPRINGDALE - HAMILTON COUNTY, OHIO


TRAFFIC CONTROL PLAN 2

PROJECT NO.	242429
DISCIPLINE	CIVIL
SHEET NAME	PM2
SHEET OF	32 OF 47

ISSUED FOR:	BID NO.	REVISION	DATE
ISSUE DATE: 02/04/2026			
SCALE: XX"=XX'			
DESIGNED BY: PMAD			
DRAWN BY: PMAD			
CHECKED BY: SRIG			

EAST KEMPER ROAD IMPROVEMENTS AND SHARED USE PATH, PH. 1
 CITY OF SPRINGDALE - HAMILTON COUNTY, OHIO
TRAFFIC CONTROL PLAN 3

PROJECT NO.	242429
DISCIPLINE	CIVIL
SHEET NAME	PM3
SHEET	33
OF	47

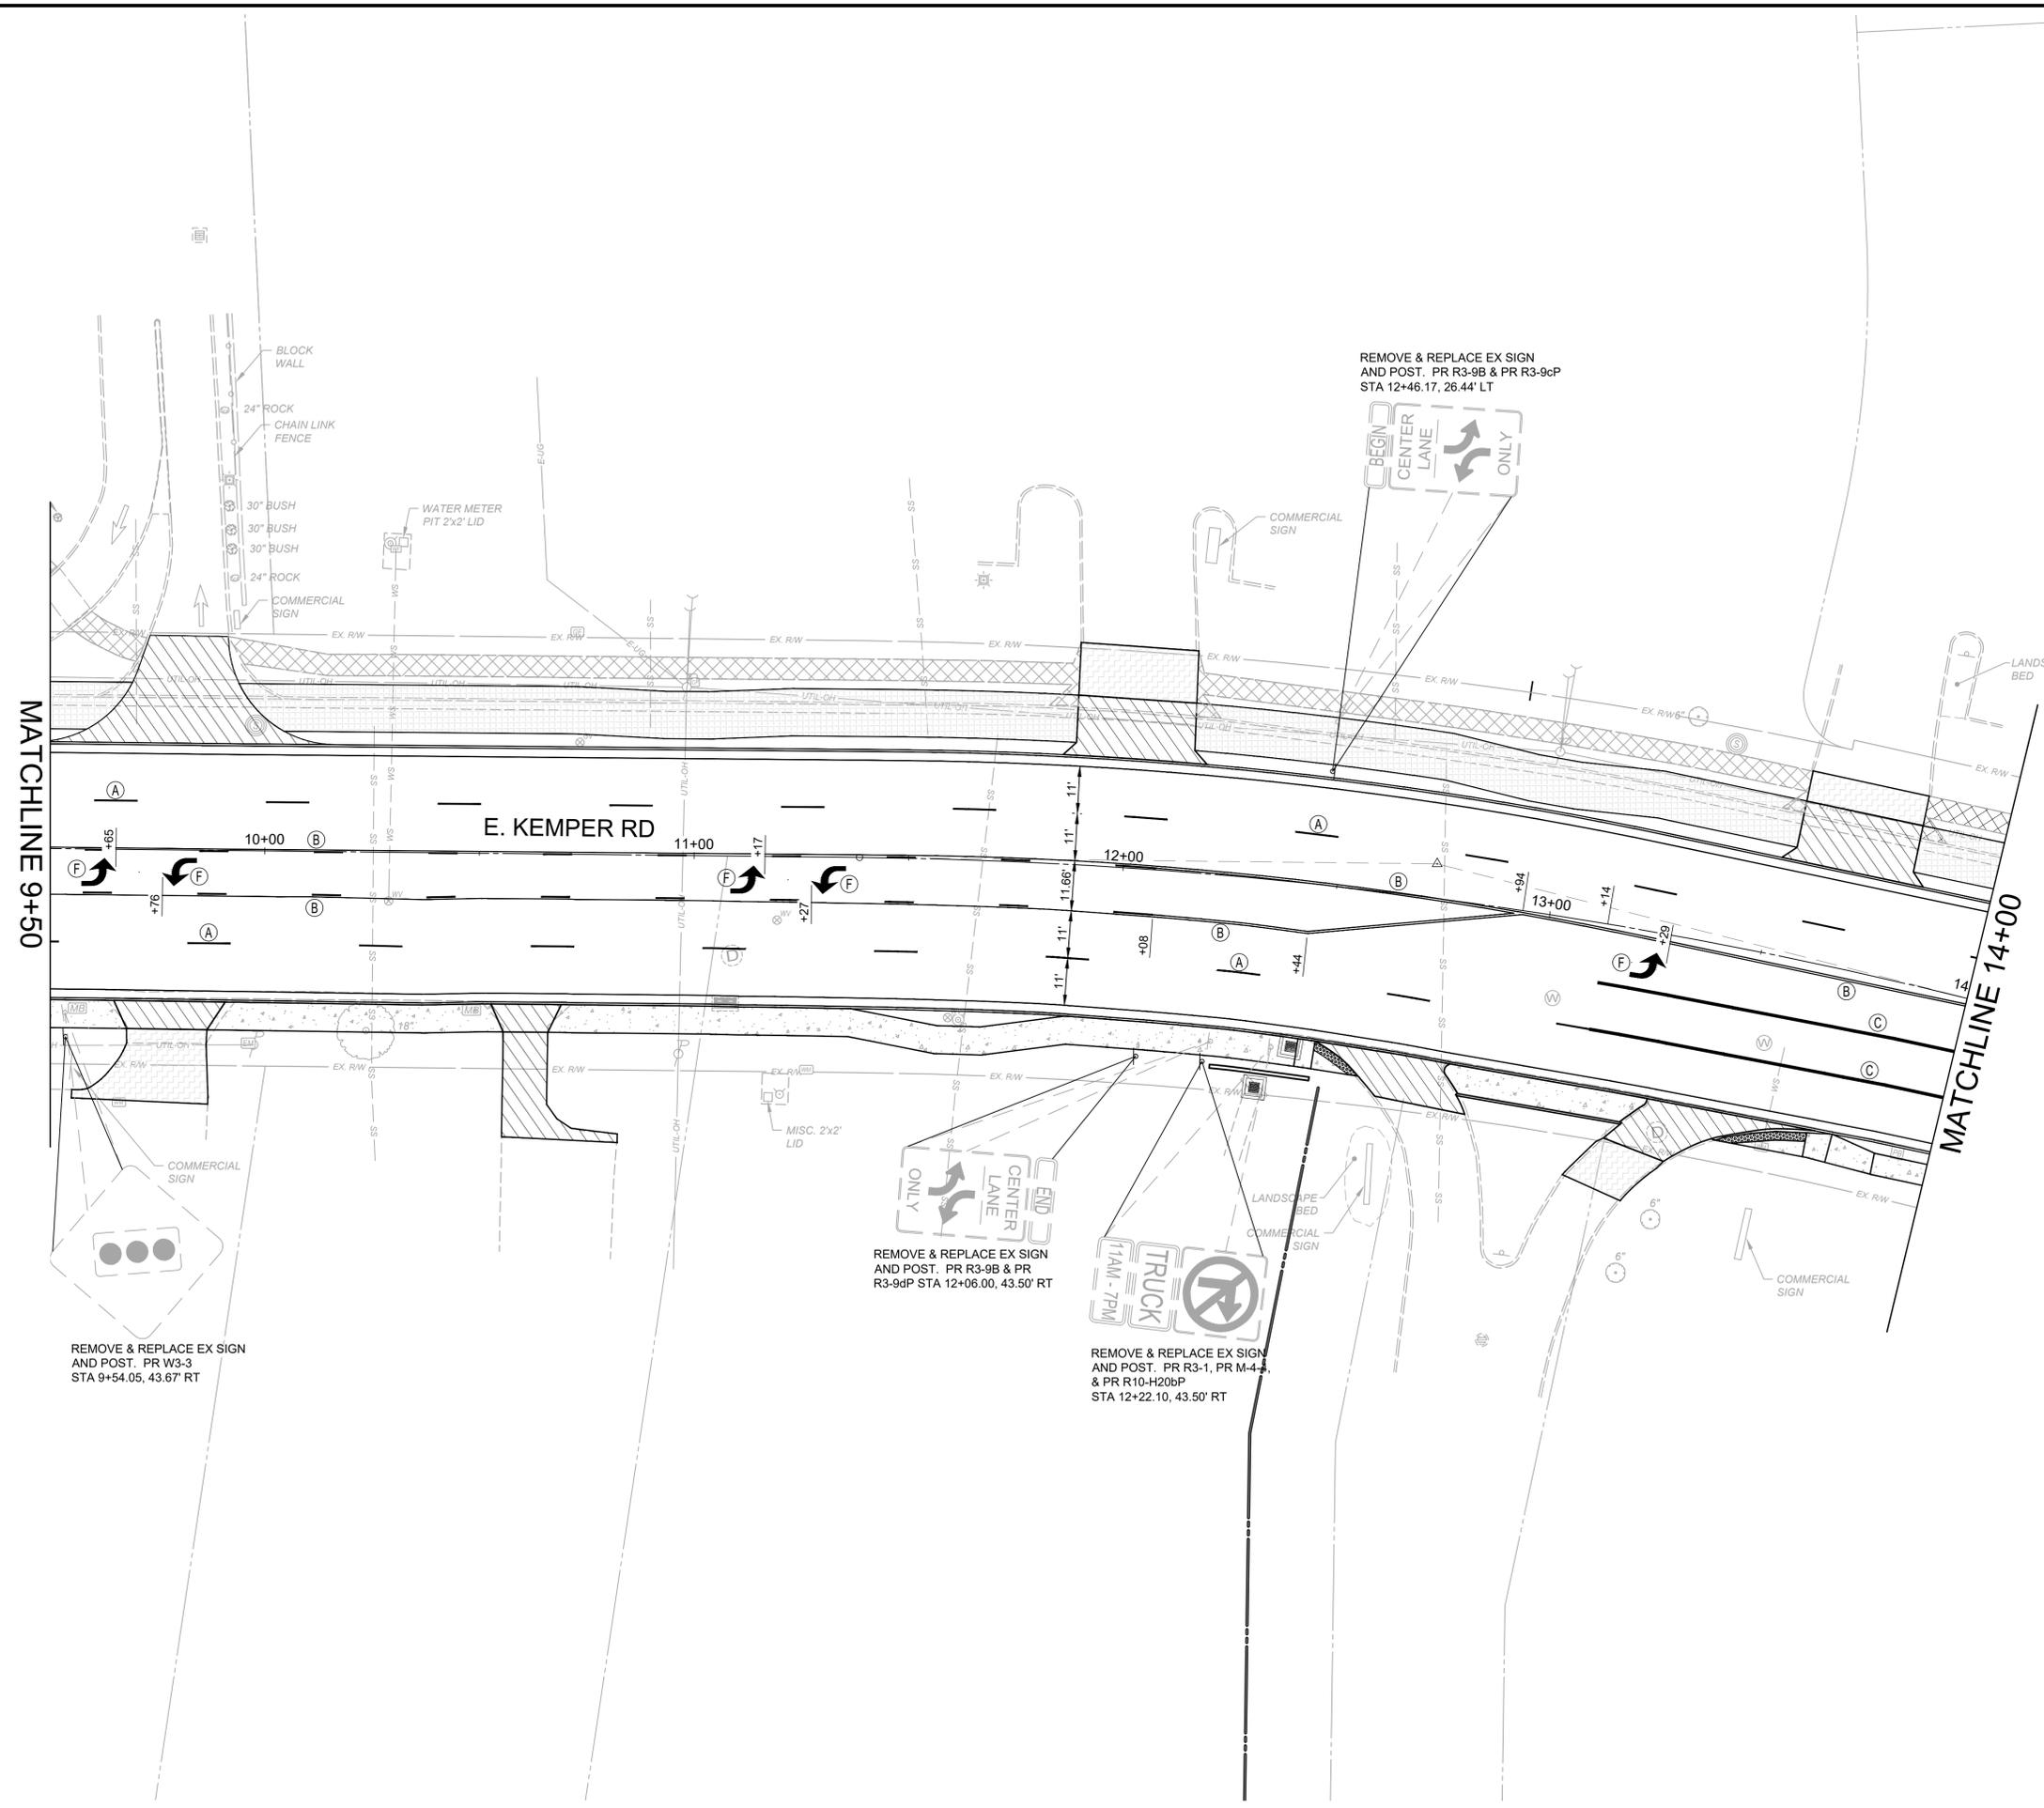

KEYNOTES

- (A) LANE LINE, 6"
- (B) CENTER LINE, 4"
- (C) CHANNELIZING LINE, 8"
- (D) STOP LINE, 24"
- (E) CROSSWALK LINE, 24" (ODOT SCD TC-74.10) (LAYOUT TO AVOID WHEEL PATH)
- (F) LANE ARROW
- (G) DOTTED LINE, 6" (2' LINE, 4' GAP)
- (H) TRANSVERSE LINE, 24"

NOTE: INSTALL RAISED PAVEMENT MARKERS WITHIN PROJECT LIMITS PER ODOT SCD TC-65.10 AND TC-65.11

ITEM 621 - RPM. AS PER PLAN
 2-WAY BLUE/BLUE RPM'S AT FIRE HYDRANT LOCATION IN LANE LINE ON SAME SIDE AS FIRE HYDRANT (CITY)


NOTE:
 REPLACE PAVEMENT MARKINGS IN KIND, PROVIDE TURN LANES WITH APPROPRIATE ARROWS, CHANNELIZATION MARKINGS, ETC. WITH APPROPRIATE ITEM 644 THERMOPLASTIC PAVEMENT MARKINGS.

WET PAVEMENT MARKINGS SHALL BE PLACED IN ACCORDANCE SUPPLEMENTARY SPECIFICATION 807: WET REFLECTIVE LIQUID APPLIED PAVEMENT MARKINGS. HOWEVER GROVING FOR THE WET REFLECTIVE PAVEMENT MARKINGS IS NOT REQUIRED.

NOTE:
 ITEM 630 SIGN POST REFLECTOR SHALL BE ADDED TO ALL NEW SIGN POSTS, ACCORDING THE THE OHIO MANUAL OF UNIFORM TRAFFIC CONTROL DEVICES.

NOTE:
 ALL SIGNAGE LOCATED INSIDE THE CONCRETE ISLAND SHALL USE KLEEM BREAK 425 ASSEMBLY - SURFACE MOUNT (XKBSM42520-G)



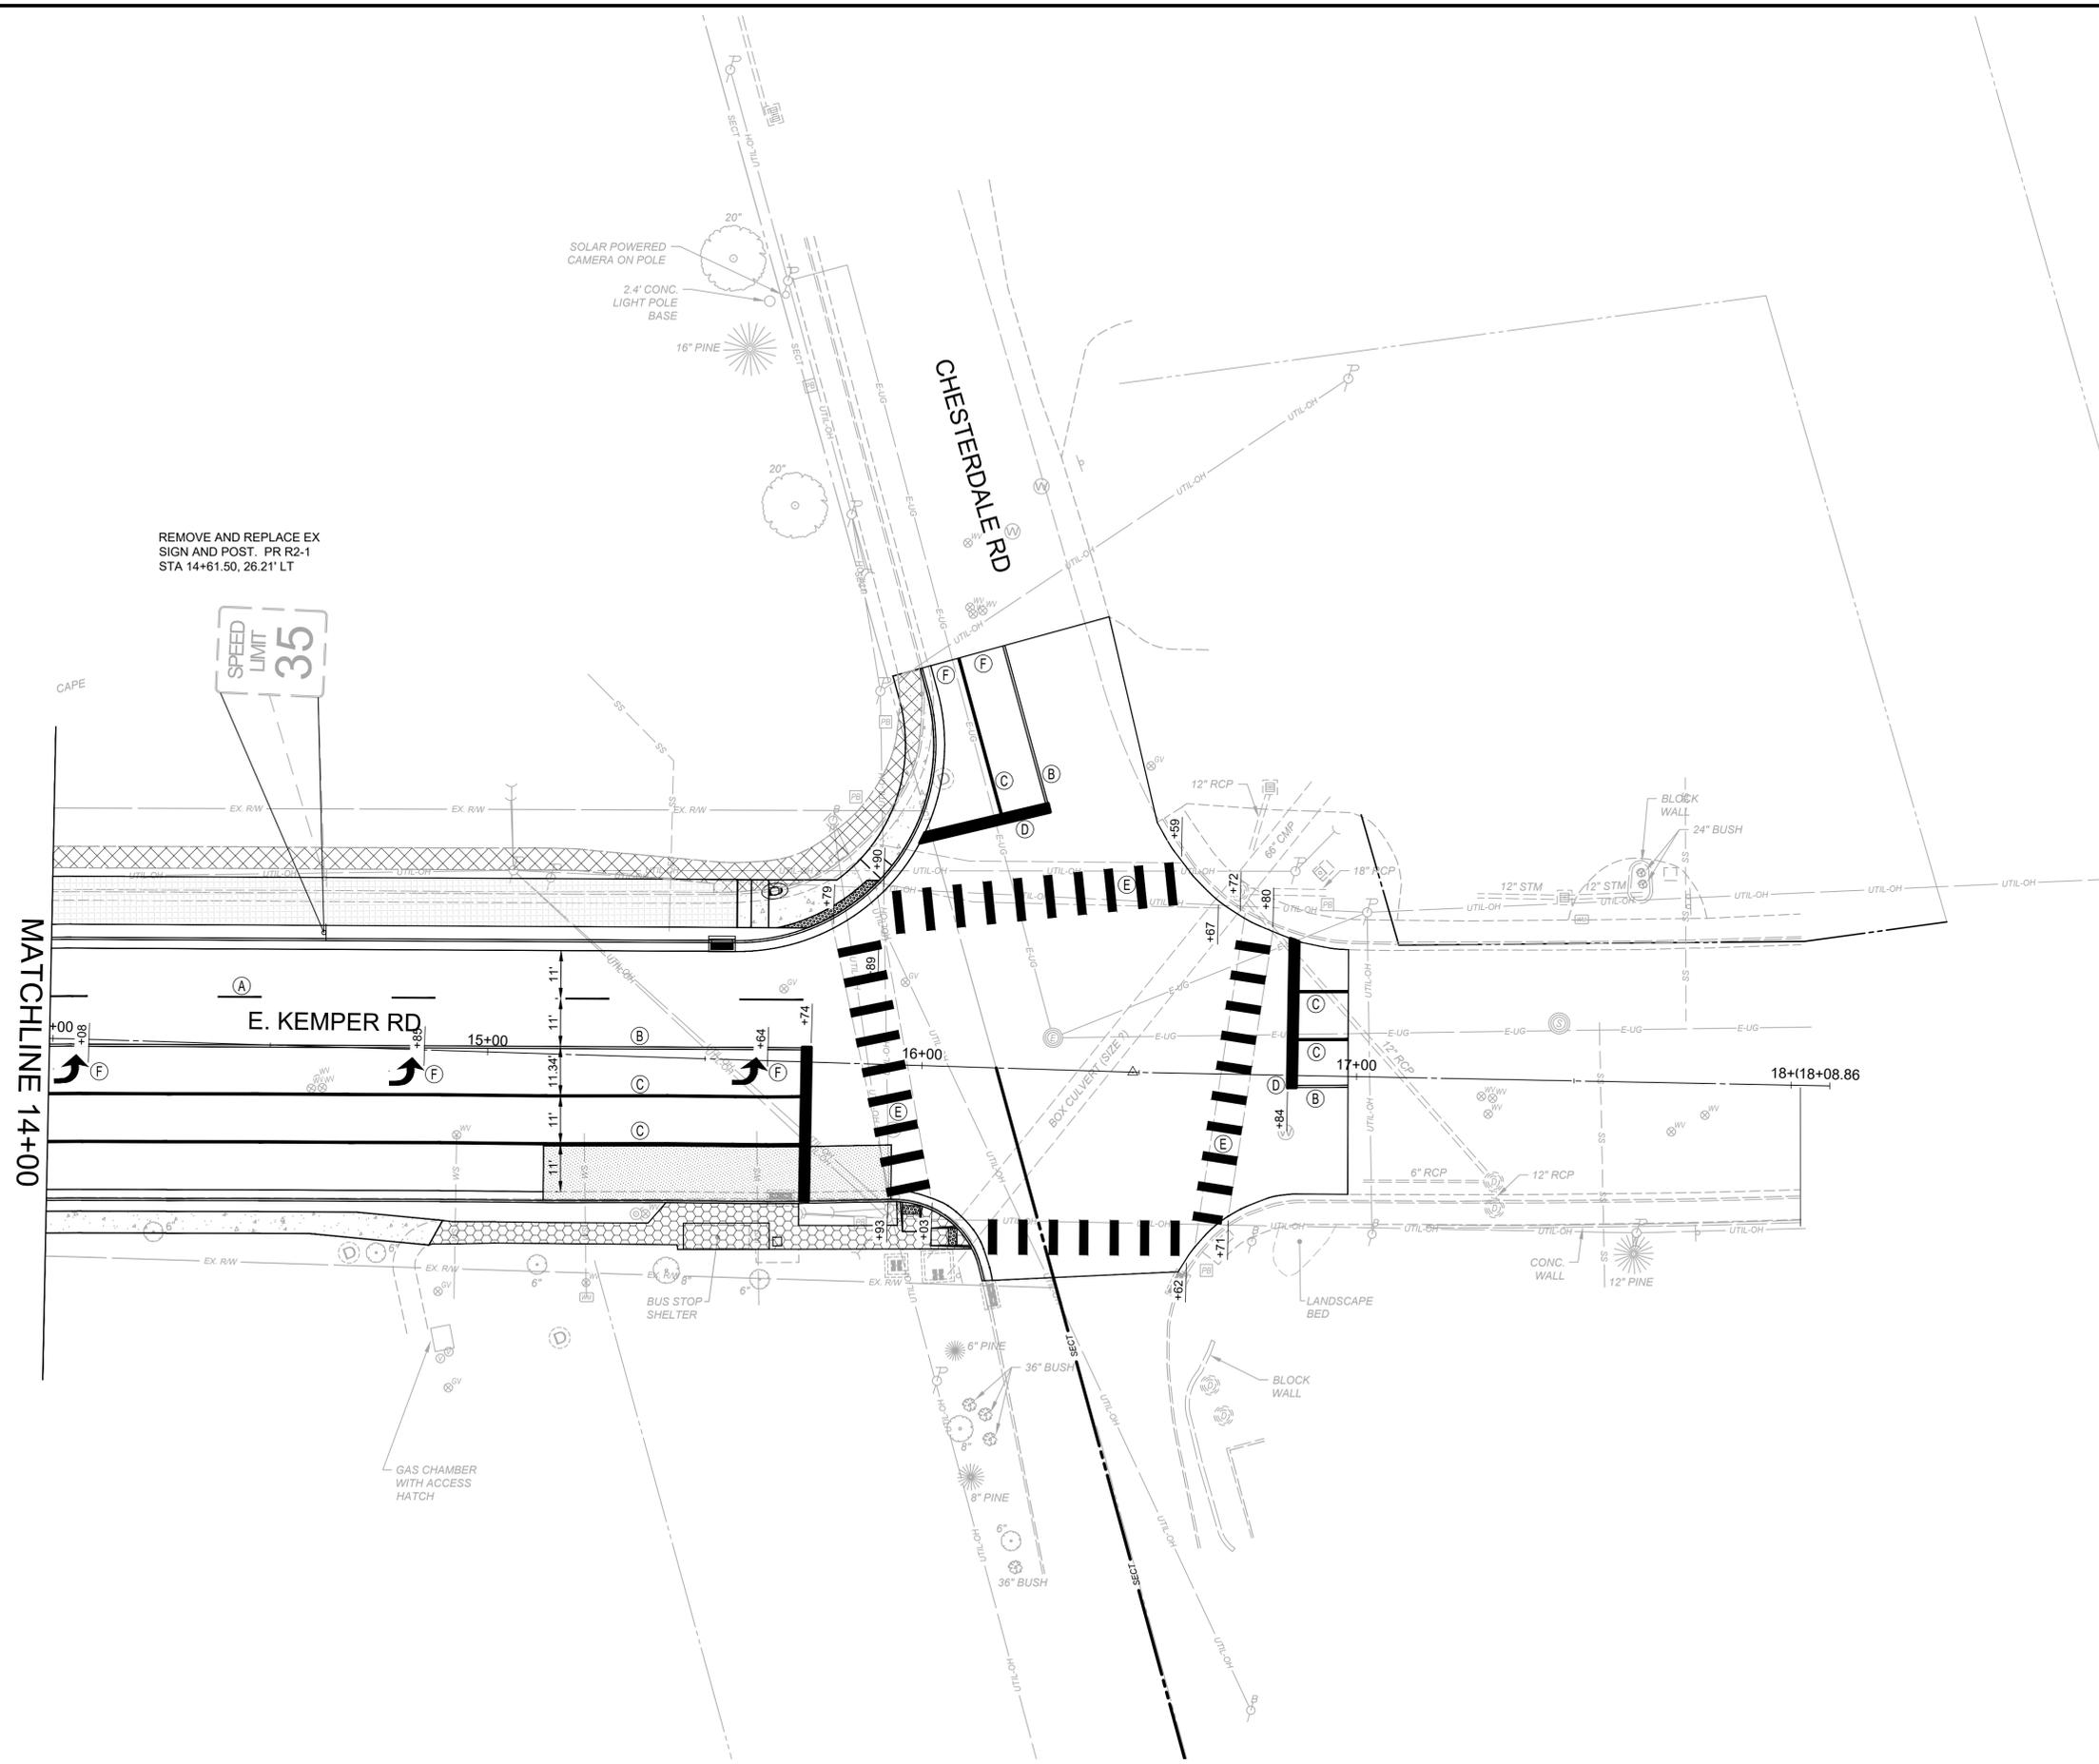

REMOVE AND REPLACE EX SIGN AND POST. PR R2-1 STA 14+61.50, 26.21' LT



- KEYNOTES**
- (A) LANE LINE, 6"
 - (B) CENTER LINE, 4"
 - (C) CHANNELIZING LINE, 8"
 - (D) STOP LINE, 24"
 - (E) CROSSWALK LINE, 24" (ODOT SCD TC-74.10) (LAYOUT TO AVOID WHEEL PATH)
 - (F) LANE ARROW
 - (G) DOTTED LINE, 6" (2' LINE, 4' GAP)
 - (H) TRANSVERSE LINE, 24"
- NOTE: INSTALL RAISED PAVEMENT MARKERS WITHIN PROJECT LIMITS PER ODOT SCD TC-65.10 AND TC-65.11
- ITEM 621 - RPM, AS PER PLAN
2-WAY BLUE/BLUE RPM'S AT FIRE HYDRANT LOCATION IN LANE LINE ON SAME SIDE AS FIRE HYDRANT (CITY)
- NOTE:
REPLACE PAVEMENT MARKINGS IN KIND. PROVIDE TURN LANES WITH APPROPRIATE ARROWS, CHANNELIZATION MARKINGS, ETC. WITH APPROPRIATE ITEM 644 THERMOPLASTIC PAVEMENT MARKINGS.
- WET PAVEMENT MARKINGS SHALL BE PLACED IN ACCORDANCE SUPPLEMENTARY SPECIFICATION 807:
WET REFLECTIVE LIQUID APPLIED PAVEMENT MARKINGS, HOWEVER GROUING FOR THE WET REFLECTIVE PAVEMENT MARKINGS IS NOT REQUIRED.
- NOTE:
ITEM 630 SIGN POST REFLECTOR SHALL BE ADDED TO ALL NEW SIGN POSTS, ACCORDING THE THE OHIO MANUAL OF UNIFORM TRAFFIC CONTROL DEVICES.
- NOTE:
ALL SIGNAGE LOCATED INSIDE THE CONCRETE ISLAND SHALL USE KLEEN BREAK 425 ASSEMBLE - SURFACE MOUNT (XKBSM42520-G)



NO	REVISION	DATE

ISSUED FOR:	BID	SRIG
ISSUE DATE:	02/04/2026	
SCALE:	XX"=XX'	
DESIGNED BY:	PMAD	
DRAWN BY:	PMAD	
CHECKED BY:		

EAST KEMPER ROAD IMPROVEMENTS AND SHARED USE PATH, PH. 1
CITY OF SPRINGDALE - HAMILTON COUNTY, OHIO

TRAFFIC CONTROL PLAN 4



PROJECT NO.	242429
DISCIPLINE	CIVIL
SHEET NAME	PM4
SHEET	OF
34	47

SIGNAL ACTIVATION

PRIOR TO ACTIVATING THE NEW TRAFFIC SIGNAL TO STOP-AND-GO MODE AND/OR REMOVING THE EXISTING TRAFFIC SIGNAL FROM SERVICE, ALL ITEMS IN THE PROPOSED SIGNAL PLAN SHALL BE FULLY COMPLETED, (I.E., VEHICLE DETECTION, PEDESTRIAN SIGNAL HEADS, ETC.) IF THERE ARE CONSTRUCTABILITY ISSUES (I.E., ROADWAY WIDENING, ETC.) THAT PREVENT THE SIGNAL FROM BEING COMPLETED PRIOR TO ACTIVATION, IT SHALL BE BROUGHT TO THE ATTENTION OF THE PROJECT ENGINEER AND CITY TRAFFIC ENGINEER. THE CITY TRAFFIC ENGINEER WILL THEN REVIEW, APPROVE OR REJECT PROPOSALS TO ACTIVATE THE TRAFFIC SIGNAL PRIOR TO COMPLETION.

THE CONTRACTOR SHALL NOTIFY THE PROJECT ENGINEER AND CITY TRAFFIC ENGINEER AT LEAST 10 WORKING DAYS PRIOR TO SCHEDULING THE FINAL INSPECTION OF THE SIGNAL INSTALLATION. FINAL INSPECTION IS NOT CONSIDERED COMPLETE UNTIL DESIGNATED DISTRICT TRAFFIC PERSONNEL INSPECT THE TRAFFIC SIGNAL AND ISSUE WRITTEN APPROVAL. IF ISSUES ARE FOUND DURING THE FINAL INSPECTION THAT AFFECT THE SAFETY OF THE TRAVELING PUBLIC AND/OR THE EFFICIENCY OF THE INTERSECTION, THE SIGNAL SHALL NOT BE ACTIVATED ON THE PROPOSED DATE. ANY PUNCH LIST ITEMS THAT ARE FOUND SHALL BE CORRECTED AND REINSPECTED BY CITY TRAFFIC PERSONNEL PRIOR TO FINAL ACCEPTANCE. CITY FORCES SHALL ONLY ASSUME DAY TO DAY MAINTENANCE OF THE TRAFFIC SIGNAL AFTER FINAL WRITTEN ACCEPTANCE HAS BEEN ISSUED.

DETECTION MAINTENANCE

IF VEHICLE DETECTION BECOMES UNEXPECTEDLY DISABLED, REQUIRES MODIFICATION, OR IS SCHEDULED TO BE TEMPORARILY REMOVED DURING THE CONSTRUCTION PROJECT, THE CONTRACTOR SHALL IMMEDIATELY NOTIFY THE PROJECT ENGINEER AND CITY TRAFFIC ENGINEER.

IF THE LOSS OF VEHICLE DETECTION IS KNOWN PRIOR TO THE START OF CONSTRUCTION, IT SHALL BE DISCUSSED AT THE PRECONSTRUCTION MEETING. AT SUCH TIME, THE CITY TRAFFIC ENGINEER SHALL ADVISE THE PROJECT ENGINEER AND CONTRACTOR ON THE APPROPRIATE ACTION TO RECTIFY ANY LOSS OF VEHICLE DETECTION. THIS MAY INCLUDE PLACING THE TRAFFIC SIGNAL ON MINIMUM OR MAXIMUM RECALL, MODIFYING THE MINIMUM GREEN TIMES, AND REMOVING THE MALFUNCTIONING DETECTION FROM SERVICE. WHERE NON-INTRUSIVE DETECTION (I.E. VIDEO, RADAR) ALREADY EXISTS, THE CONTRACTOR SHALL INSURE THAT DETECTION IS OPERATING AND MAINTAINED BY RECONFIGURING THE DETECTION UNITS ACCORDINGLY DURING ALL CONSTRUCTION PHASES. THIS IS TO AVOID THE SIGNAL FROM MAXING OUT THE AFFECTED SIGNAL PHASE AND CREATING UNNECESSARY DELAYS.

LOCATIONS WHERE NON-INTRUSIVE DETECTION IS PROPOSED AND THE EXISTING VEHICLE DETECTION IS TO BE ABANDONED, THE NON-INTRUSIVE VEHICLE DETECTION SHALL BE INSTALLED, CONFIGURED AND MADE FULLY FUNCTIONAL PRIOR TO THE EXISTING DETECTION BEING DISABLED. THE CONTRACTOR SHALL CONTINUE TO MAINTAIN AND MODIFY THE DETECTION UNTIL FINAL ACCEPTANCE OF THE TRAFFIC SIGNAL. THIS IS TO ENSURE VEHICLE DETECTION REMAINS FULLY FUNCTIONAL THROUGHOUT CONSTRUCTION.

WORK INSPECTION

THE CONTRACTOR SHALL PROVIDE THE PROJECT ENGINEER AND CITY TRAFFIC ENGINEER WITH 72-HOUR NOTICE OF ANY SIGNAL WORK TO BE PERFORMED AT THE INTERSECTION SITE(S) SO THAT INSPECTION SERVICES CAN BE SUPPLIED.

GUARANTEE

THE CONTRACTOR SHALL GUARANTEE THAT THE TRAFFIC CONTROL SYSTEM INSTALLED AS PART OF THIS CONTRACT SHALL OPERATE SATISFACTORILY FOR A PERIOD OF 90 DAYS FOLLOWING COMPLETION OF THE 10-DAY PERFORMANCE TEST. IN THE EVENT OF UNSATISFACTORY OPERATION, THE CONTRACTOR SHALL CORRECT FAULTY INSTALLATIONS, MAKE REPAIRS AND REPLACE DEFECTIVE PARTS WITH NEW PARTS OF EQUAL OR BETTER QUALITY.

EQUIPMENT, MATERIAL AND LABOR COSTS INCURRED IN CORRECTING AN UNSATISFACTORY OPERATION SHALL BE BORNE BY THE CONTRACTOR.

GUARANTEE (CONT.)

THE GUARANTEE SHALL COVER THE FOLLOWING ITEMS OF THE TRAFFIC CONTROL SYSTEM: CONTROLLER, CABINET, UNINTERRUPTIBLE POWER SUPPLY, VEHICLE DETECTION EQUIPMENT, LED LAMP UNITS, NETWORK AND COMMUNICATION/INTERCONNECT EQUIPMENT.

CUSTOMARY MANUFACTURER'S GUARANTEES FOR THE FOREGOING ITEMS SHALL BE TURNED OVER TO THE STATE OR THE MAINTAINING AGENCY FOLLOWING ACCEPTANCE OF THE EQUIPMENT.

THE COST OF GUARANTEEING THE TRAFFIC CONTROL SYSTEM WILL BE INCIDENTAL TO AND INCLUDED IN THE CONTRACT UNIT PRICE OF THE VARIOUS ITEMS MAKING UP THE SYSTEM.

GROUNDING AND BONDING

THE REQUIREMENTS OF THE CONSTRUCTION AND MATERIAL SPECIFICATIONS (C&MS) AND THE TC SERIES OF STANDARD CONSTRUCTION DRAWINGS ARE MODIFIED AS FOLLOWS:

1. ALL METALLIC PARTS CONTAINING ELECTRICAL CONDUCTORS SHALL BE PERMANENTLY JOINED TO FORM AN EFFECTIVE GROUND FAULT CURRENT PATH BACK TO THE GROUNDED CONDUCTOR IN THE POWER SERVICE DISCONNECT SWITCH.

A. PROVIDE AN EQUIPMENT GROUNDING CONDUCTOR IN METALLIC CONDUITS (725.04) IN ADDITION TO THE CONDUCTORS SPECIFIED AND BOND THE CONDUIT TO THIS GROUNDING CONDUCTOR.

B. WHEN AN EQUIPMENT GROUNDING CONDUCTOR IS REQUIRED IN PLASTIC CONDUIT (725.05), THE INSTALLATION SHALL INCLUDE A SEPARATE EQUIPMENT GROUNDING CONDUCTOR IN ADDITION TO THE CONDUCTORS SPECIFIED.

C. METALLIC CONDUIT CARRYING THE LOOP WIRES FROM IN THE PAVEMENT TO THE PULL BOX SPLICE LOCATION WILL ONLY BE BONDED AT THE PULL BOX END, AND WILL NOT CONTAIN AN EQUIPMENT GROUNDING CONDUCTOR.

D. IF MULTIPLE CONDUIT RUNS BEGIN AND END AT THE SAME POINTS, ONLY ONE EQUIPMENT GROUNDING CONDUCTOR IS REQUIRED.

E. IF AN EQUIPMENT GROUNDING CONDUCTOR IS NEEDED IN CONDUIT BETWEEN SIGNALIZED INTERSECTIONS FOR UNDERGROUND INTERCONNECT CABLE, THE GROUNDING SYSTEM FOR EACH SIGNALIZED INTERSECTION WILL BE SEPARATED ABOUT MIDWAY BETWEEN THE INTERSECTIONS.

F. THE MESSENGER WIRE AT SIGNALIZED INTERSECTIONS WILL BE USED AS THE CONDUCTIVE PATH FROM CORNER TO CORNER IF CONDUIT IS NOT PROVIDED UNDER THE ROADWAY. WHEN CONDUIT CONNECTS THE CORNERS OF AN INTERSECTION, AN EQUIPMENT GROUNDING CONDUCTOR SHALL BE USED IN THE CONDUIT.

2. CONDUITS.

A. THE 725.04 CONDUIT SHALL HAVE GROUNDING BUSHINGS INSTALLED AT ALL TERMINATION POINTS. THE BUSHING MATERIAL SHALL BE COMPATIBLE WITH GALVANIZED STEEL CONDUIT AND THE GROUNDING LUG MATERIAL SHALL BE COMPATIBLE FOR USE WITH COPPER WIRE. THREADED OR COMPRESSION TYPE BUSHINGS MAY BE USED.

B. THE 725.05 CONDUIT SHALL HAVE THE INSIDE AND OUTSIDE DIAMETERS OF THE CONDUIT DEBURRED AT ALL TERMINATION POINTS.

C. BOTH ENDS OF METALLIC CONDUIT SHALL BE BONDED TO THE EQUIPMENT GROUNDING CONDUCTOR.

D. METALLIC CONDUIT MAY BE BONDED TO METALLIC BOXES THROUGH THE USE OF CONDUIT FITTINGS UL APPROVED FOR THIS TYPE OF CONNECTION, WITH THE BOX BONDED TO THE EQUIPMENT GROUNDING CONDUCTOR.

GROUNDING AND BONDING (CONT.)

3. WIRE FOR GROUNDING AND BONDING.

A. USE INSULATED, COPPER WIRE FOR THE EQUIPMENT GROUNDING CONDUCTOR. BONDING JUMPERS IN BOXES AND ENCLOSURES MAY BE BARE OR INSULATED COPPER WIRE. WIRE SIZE SHALL BE AS FOLLOWS:

i. USE 4 AWG BETWEEN THE POWER SERVICE AND SUPPORTS, POLES, PEDESTALS, CONTROLLER OR FLASHER CABINETS.

ii. USE A MINIMUM 8 AWG BETWEEN LOOP DETECTOR PULL BOXES AND THE FIRST CONDUIT THAT REQUIRES A LARGER SIZE AS SPECIFIED IN 3.A.I ABOVE.

iii. USE A MINIMUM 8 AWG BETWEEN THE "PREPARE TO STOP WHEN FLASHING" INSTALLATION (INCLUDING SUPPORT) AND THE FIRST CONDUIT THAT REQUIRES A LARGER SIZE AS SPECIFIED IN 3.A.I ABOVE.

iv. THE INSULATION SHALL BE GREEN OR GREEN WITH YELLOW STRIPE(S). FOR 4 AWG OR LARGER, INSULATION MAY ALSO BE BLACK WITH GREEN TAPE/LABELS INSTALLED AT ALL ACCESS POINTS.

B. IN A HIGHWAY LIGHTING SYSTEM, THE EQUIPMENT GROUNDING CONDUCTOR SHALL BE THE SAME WIRE SIZE AS THE DUCT CABLE OR DISTRIBUTION CABLE CIRCUIT CONDUCTORS, WITH THE MINIMUM CONDUCTOR SIZE OF 4 AWG. BONDING JUMPERS WILL BE MINIMUM SIZE 4 AWG.

4. GROUND ROD.

A. A 3/4-INCH SCHEDULE 40 PVC CONDUIT WILL BE USED IN FOUNDATIONS AND CONCRETE WALLS FOR THE GROUNDING CONDUCTOR (GROUND WIRE) RACEWAY TO THE GROUND ROD. SHOULD METALLIC CONDUIT BE USED, BOTH ENDS OF THE CONDUIT SHALL BE BONDED TO THE GROUNDING CONDUCTOR.

B. THE TYPICAL GROUNDING CONDUCTOR (GROUND WIRE) SHALL BE 4 AWG INSULATED, COPPER.

5. THE GREEN CONDUCTOR IN SIGNAL CABLES (CONDUCTOR #4) SHALL NOT BE USED TO SUPPLY POWER TO A SIGNAL INDICATION. IT WILL BE CONNECTED TO THE SIGNAL BODY AS AN EQUIPMENT GROUND IN ALUMINUM HEADS AND IT WILL BE UNUSED IN PLASTIC HEADS. UNUSED CONDUCTORS SHALL BE GROUNDED IN THE CABINET. TYPICAL USE OF CONDUCTORS IS AS FOLLOWS:

NO.	COLOR	VEHICLE SIGNAL	PEDESTRIAN SIGNAL
1	BLACK	GREEN BALL	#1 WALK
2	WHITE	AC NEUTRAL	AC NEUTRAL
3	RED	RED BALL	#1 DW/FDW
4	GREEN	EQUIPMENT GROUND	EQUIPMENT GROUND
5	ORANGE	YELLOW BALL	#2 DW/FDW
6	BLUE	GREEN ARROW	#2 WALK
7	WHITE/BLACK	STRIPE YELLOW ARROW	NOT USED

6. POWER SERVICE AND DISCONNECT SWITCH.

A. AT THE POWER SERVICE LOCATION, THE GROUNDING CONDUCTOR (GROUND WIRE) FROM THE DISCONNECT SWITCH NEUTRAL (AC-) BAR TO THE GROUND ROD SHALL BE A CONTINUOUS, UNSPLICED CONDUCTOR. IF SPLICED, IT SHALL BE AN EXOTHERMIC WELD BUTT SPLICE.

GROUNDING AND BONDING (CONT.)

B. THE SERVICE NEUTRAL (AC-) SHALL ONLY BE CONNECTED TO GROUND AT THE PRIMARY POWER SERVICE DISCONNECT SWITCH.

i. NEMA CONTROLLER CABINETS: IF A POWER SERVICE DISCONNECT SWITCH IS LOCATED BEFORE THE CONTROLLER CABINET, THE NEUTRAL (AC-) AND THE GROUNDING BARS IN THE CONTROLLER CABINET SHALL NOT BE CONNECTED TOGETHER AS SHOWN IN NEMA TS-2, FIGURE 5-4.

ii. IF SECONDARY DISCONNECT SWITCHES ARE CONNECTED AFTER THE PRIMARY DISCONNECT SWITCH, THE NEUTRAL (AC-) SHALL ONLY BE GROUNDED AT THE PRIMARY SWITCH. EQUIPMENT GROUNDING CONDUCTORS SHALL BE BROUGHT TO THE PRIMARY SWITCH, BUT SHALL BE GROUNDED AT BOTH SECONDARY AND PRIMARY SWITCHES.

7. PAYMENT – ALL MATERIALS AND WORK REQUIRED TO COMPLETE THE EFFECTIVE GROUND FAULT CURRENT PATH SYSTEM ARE INCIDENTAL TO THE CONDUCTORS INSTALLED BY CONTRACT.

625, BRACKET ARM, (BY TYPE), AS PER PLAN

IN ADDITION TO THE REQUIREMENTS OF C&MS 625 "BRACKET ARM, (BY TYPE), AS PER PLAN", BRACKET ARMS SHALL HAVE A POWDER COAT BLACK FINISH. ALL ARMS SHALL HAVE THE ANGLE OF RISE NECESSARY TO ACHIEVE A LUMINAIRE HEIGHT OF 36'.

625, LUMINAIRE, CONVENTIONAL, SOLID STATE (LED) 120V, TYPE III DISTRIBUTION, AS PER PLAN

IN ADDITION TO THE REQUIREMENTS OF C&MS 625 "LUMINAIRE, CONVENTIONAL, SOLID STATE (LED) 120V, TYPE III DISTRIBUTION", LUMINAIRE HOUSING SHALL BE BLACK IN COLOR.

625, SIGN HANGER ASSEMBLY, AS PER PLAN

IN ADDITION TO THE REQUIREMENTS OF C&MS 625 "SIGN HANGER ASSEMBLY", THE SIGN HANGER ASSEMBLY SHALL BE BLACK IN COLOR.

625, SIGN ATTACHMENT ASSEMBLY, AS PER PLAN

IN ADDITION TO THE REQUIREMENTS OF C&MS 625 "SIGN ATTACHMENT ASSEMBLY", THE ATTACHMENT ASSEMBLY SHALL BE BLACK IN COLOR.

632, POWER SERVICE, AS PER PLAN

CONSTRUCT A COMPLETE AND OPERATIONAL METERED POWER SERVICE IN ACCORDANCE WITH THE RULES AND REGULATIONS SET FORTH BY THE OHIO ELECTRIC CODE, DUKE ENERGY AND ODOT SCD HL-40.20. ALL NECESSARY MATERIAL AND LABOR, INCLUDING BUT NOT LIMITED TO ELECTRIC METER, RISER, AND HOUSING, SHALL BE SUPPLIED BY THE CONTRACTOR AS PART OF THIS ITEM.



TEC Engineering, Inc.
PLAN PREPARED BY:
TEC Engineering, Inc.
7280 North Central Blvd.
Mason, OH 45040

DATE	REVISION	NO	REVIEW	ISSUED FOR:	ISSUE DATE:	SCALE:	DESIGNED BY:	DRAWN BY:	CHECKED BY:
					1/13/2026		AFS	AFS	ALH

**EAST KEMPER ROAD
IMPROVEMENTS AND
SHARED USE PATH, PH. 1**
CITY OF SPRINGDALE - HAMILTON COUNTY, OHIO

TRAFFIC SIGNAL NOTES

PROJECT NO. 242429
DISCIPLINE CIVIL
SHEET NAME TSN
SHEET 35
OF 47

633, CONTROLLER ITEM, MISC.: MANAGED ETHERNET SWITCH WITH GIGABIT UPLINK PORTS

THE FIBER OPTIC SWITCH SHALL INTERFACE TO SINGLE-MODE FIBER OPTIC CABLE WITH AN OPTICAL WAVELENGTH OF 1310 NM USING SC CONNECTOR. IT SHALL BE CAPABLE OF OPERATING OVER A DISTANCE OF AT LEAST 10KM WITH AN OPTICAL POWER BUDGE OF 17 DB. THE UNIT SHALL BE CAPABLE OF OPERATING IN A FAULT TOLERANT FIBER OPTIC LOOP.

PROVIDE A TRANSCEIVER THAT IS FULLY COMPLIANT WITH IEEE 802.3, 802.3U & 802.3Z. THE TRANSCEIVER SHALL PROVIDE FULL-DUPLEX OPERATION AND FLOW CONTROL.

PROVIDE A SIMPLE INTUITIVE USER INTERFACE FOR CONFIGURATION AND MONITORING OF THE TRANSCEIVER VIA STANDARD HTML GRAPHICAL WEB BROWSER, INCLUDING DETAILED ON-LINE HELP. EVENT LOGGING AND RECORDING SHALL BE INCLUDED. ALL SIGNIFICANT EVENTS SHALL BE SORTED IN A NON-VOLATILE SYSTEM LOG.

THE OPTICAL ETHERNET SWITCH SHALL CONNECT TO ALL ETHERNET DEVICES IN THE CONTROLLER CABINET INCLUDING THE CONTROLLER, RADAR DETECTION COMMUNICATIONS INTERFACE PANEL AND VIDEO SERVERS (IF APPLICABLE), AND ANY OTHER ETHERNET DEVICES USING PROPERLY RATED CAT5 CABLE CONNECTORS.

IN ADDITION TO ODOT SS809 AND 909, THIS WORK SHALL INCLUDE ALL TIME, LABOR, MATERIAL TO SET UP CAMERAS AND COMPLETE ANY NECESSARY WORK (NETWORKING, ETC.) TO MAKE THE SWITCHES REMOTELY ACCESSIBLE OVER THE SPRINGDALE TRAFFIC SIGNAL FIBER OPTIC NETWORK.

THE COST FOR THIS ITEM SHALL INCLUDE ALL LABOR, EQUIPMENT, MATERIAL, AND INCIDENTALS REQUIRED TO ASSEMBLE A FUNCTIONAL FIBER OPTIC ETHERNET SYSTEM INCLUDING CONNECTIONS, TESTED AND ACCEPTED.

804, FIBER OPTIC CABLE, MISC.: MODIFY EXISTING SPLICE ENCLOSURE


THIS ITEM SHALL INCLUDE ALL LABOR, MATERIALS, AND EQUIPMENT NECESSARY TO MODIFY THE EXISTING AERIAL SPLICE ENCLOSURE. THIS MODIFICATION SHALL INCLUDE THE SPLICING OF NEW 12-FIBER DROP CABLE (PROVIDED SEPARATELY) TO THE EXISTING TRUNK LINE WITHIN THE EXISTING ENCLOSURE. EXISTING DROP CABLE IS TO BE DISCONNECTED AND REMOVED AS PART OF THIS ITEM. A SPLICE DIAGRAM OF EXPECTED CONDITIONS IS PROVIDED HEREIN.

809, CCTV IP-CAMERA SYSTEM, PTZ, AS PER PLAN

THIS ITEM SHALL CONFORM TO THE STANDARDS OF ITEM 809 "CCTV IP-CAMERA SYSTEM, PTZ" WITH THE ADDITION THAT THE CAMERA MANUFACTURER SHALL BE BOSCH.

PAYMENT FOR ITEM 809 "CCTV IP CAMERA SYSTEM, PTZ, AS PER PLAN" SHALL BE MADE AT THE CONTRACT UNIT PRICE FOR EACH UNIT, COMPLETE AND IN PLACE INCLUDING ALL REQUIRED CABINET HARDWARE, MOUNTING BRACKETS, CABLES, CONDUIT AND CONNECTIONS TESTED AND ACCEPTED.

LAST SINGLE RING DROP SPLICE DETAIL

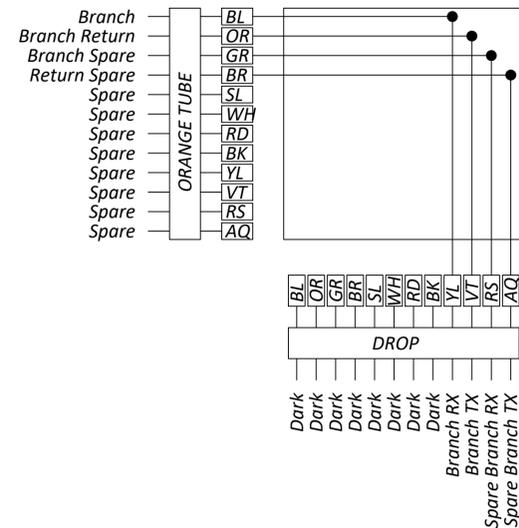


NO	REVISION	DATE

ISSUED FOR:	REVIEW	DESIGNED BY:	DRAWN BY:	CHECKED BY:
ISSUE DATE:	1/13/2026	SCALE:	AFS	AFS

EAST KEMPER ROAD IMPROVEMENTS AND SHARED USE PATH, PH. 1
 CITY OF SPRINGDALE - HAMILTON COUNTY, OHIO
TRAFFIC SIGNAL NOTES 3

PROJECT NO.	242429
DISCIPLINE	CIVIL
SHEET NAME	TSN3
SHEET	OF
37	47

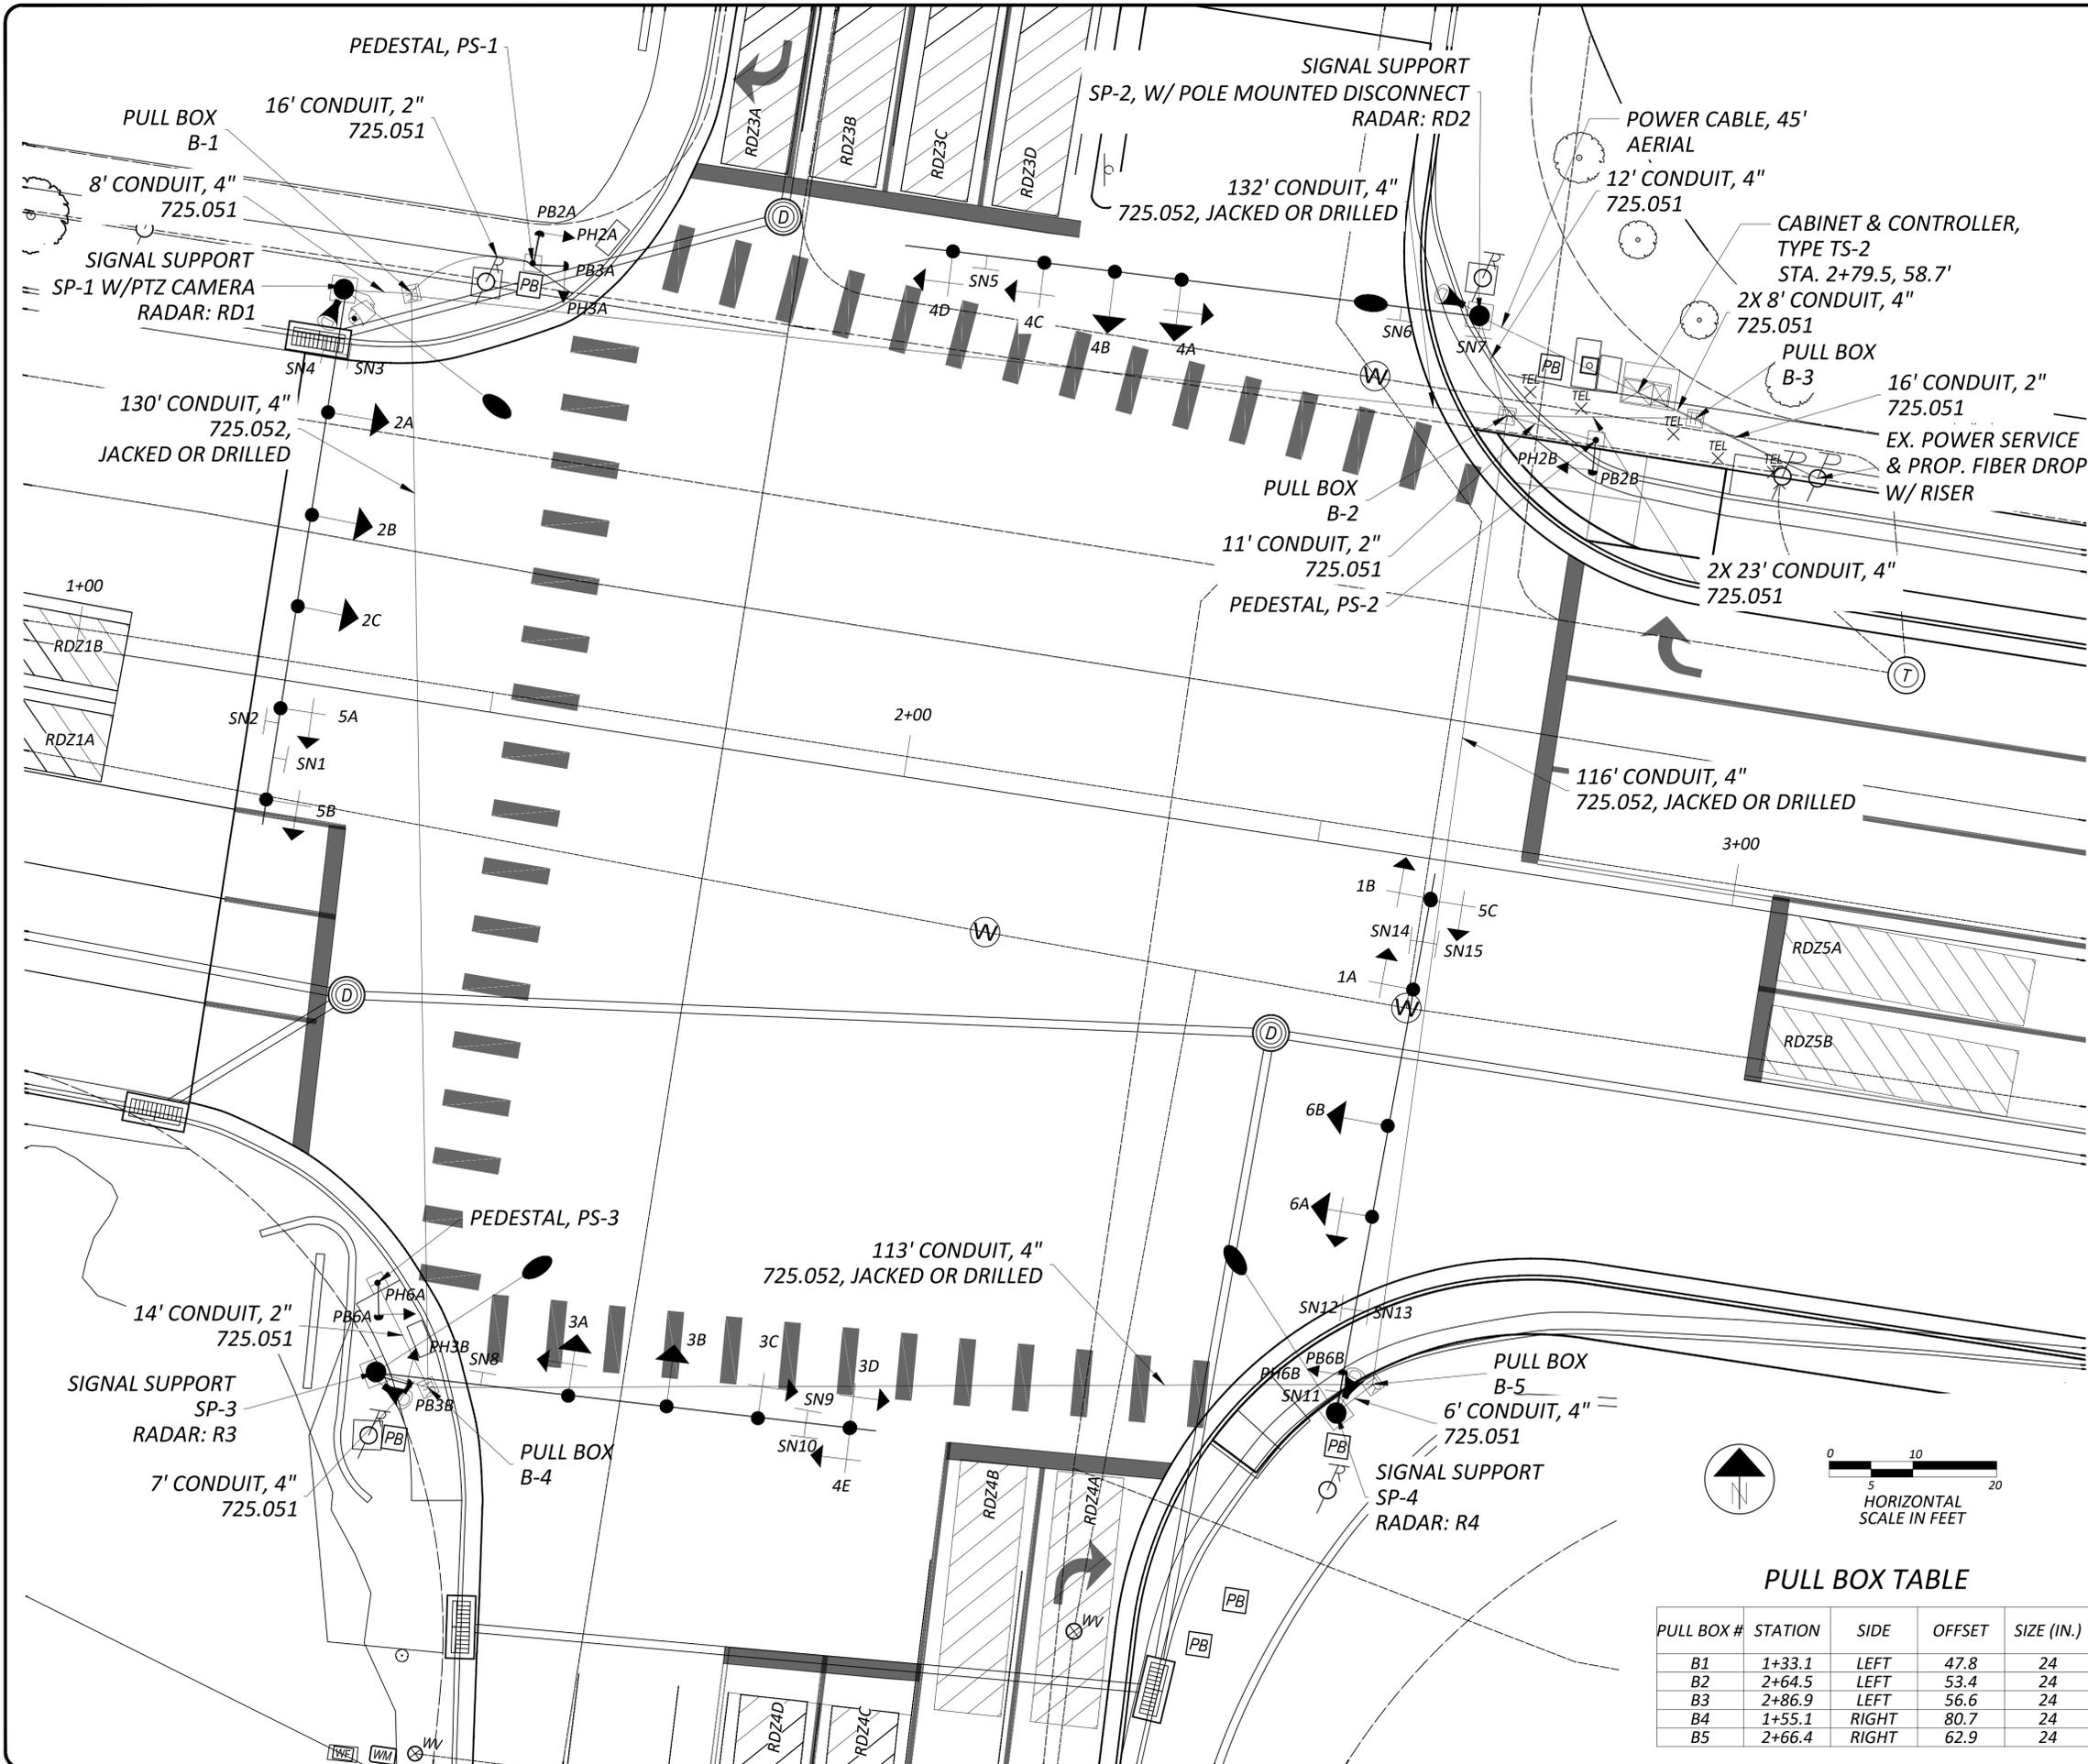

PROPOSED SIGNAL HEADS

3A, 4A, 6A 1A, 1B, 3C, 3D, 4C, 4D, 4E, 5A, 5B, 5C 2A, 2B, 2C, 3B, 4B, 6B

PEDESTRIAN HEADS (LED, COUNTDOWN, TYPE D2)

PH2A, PH2B, PH3A, PH3B, PH6A, PH6B

PROPOSED SIGNS

SERIES B LETTERING 12" CAPITAL LETTERS 18"X84"

E. Kemper Rd
SN6, SN8

SERIES B LETTERING 12" CAPITAL LETTERS 18"X96"

Century Blvd →
SN12

← Century Blvd
SN13

SERIES B LETTERING 12" CAPITAL LETTERS 18"X96"

Commons Dr →
SN3

← Commons Dr
SN4

LEFT TURN SIGNAL

R3-5L-30
SN2, SN15

R10-10L-30
SN1, SN5, SN9, SN10, SN14

R9-3-24
SN7, SN11

LEGEND

	PROP	EXIST
TRAFFIC SIGNAL, 3 UNIT HEAD, 12"		
TRAFFIC SIGNAL, 3 UNIT HEAD, ARROW, 12"		
TRAFFIC SIGNAL, 5 OR 4 UNIT HEAD, ARROW, 12"		
PEDESTRIAN SIGNAL		
PEDESTRIAN PUSH BUTTON		
BRACKET ARM & LUMINAIRE		
SIGNAL SUPPORT POLE		
PEDESTAL SUPPORT		
TRAFFIC PULL BOX		
CCTV, PTZ CAMERA		
CONTROLLER CABINET AND WORK PAD (TS-2)		
STOP BAR RADAR DETECTION UNIT		
DETECTION ZONE		

PULL BOX TABLE

PULL BOX #	STATION	SIDE	OFFSET	SIZE (IN.)
B1	1+33.1	LEFT	47.8	24
B2	2+64.5	LEFT	53.4	24
B3	2+86.9	LEFT	56.6	24
B4	1+55.1	RIGHT	80.7	24
B5	2+66.4	RIGHT	62.9	24

TEC Engineering, Inc.
PLAN PREPARED BY:
TEC Engineering, Inc.
7280 Springdale Road
Mason, OH 45040

NO.	REVISION	DATE

ISSUED FOR:	REVIEW:	NO.	DATE
ISSUE DATE:	1/13/2025		
SCALE:	1"=10'	DESIGNED BY:	AFS
		DRAWN BY:	AFS
		CHECKED BY:	ALH

EAST KEMPER ROAD IMPROVEMENTS AND SHARED USE PATH, PH. 1

CITY OF SPRINGDALE - HAMILTON COUNTY, OHIO

TRAFFIC SIGNAL PLANS

PROJECT NO.	242429
DISCIPLINE	CIVIL
SHEET NAME	TSPL
SHEET	38
OF	47


\\101114\PROJECTS\2024\PROJECTS\242429\VERMONT\ASR\02 EAST KEMPER ROAD\DRAWING\KEMPER & CENTURY CIP01.DWG - CIP01 - 1/16/2025 11:32:46 AM - ANDREW SANT

SIGNAL TIMING CHART

INTERSECTION: KEMPER ROAD & CENTURY BOULEVARD/COMMONS DRIVE MAINTAINING AGENCY: CITY OF SPRINGDALE									
START UP		DUAL ENTRY: YES		PHASES: 2 & 6					
		REST IN RED:		RING 1		RING 2			
START IN: ALL-RED FLASH		OVERLAP		A	B	C	D		
TIME FOR: FLASH, ALL RED (SEC.): 9, 6		PHASES		5	1	3	4		
FIRST PHASE(S): 2									
COLOR DISPLAYED: GREEN									
INTERVAL OR FEATURE									
INTERSECTION MOVEMENT (PHASE)									
CONTROLLER MOVEMENT NO.									
DIRECTION		1	2	3	4	5	6	7	8
MINIMUM GREEN (INITIAL) (SEC.)		EBLT	WB	SB	NB	WBLT	EB	-	-
ADDED INITIAL *(SEC./ACTUATION)		5	15	15	7	5	15	-	-
MAXIMUM INITIAL *(SEC.)		-	-	-	-	-	-	-	-
PASSAGE TIME (PRESET GAP) (SEC.)		3	-	3.5	3	3	-	-	-
TIME BEFORE REDUCTION *(SEC.)		-	-	-	-	-	-	-	-
MINIMUM GAP *(SEC.)		-	-	-	-	-	-	-	-
TIME TO REDUCE *(SEC.)		-	-	-	-	-	-	-	-
MAXIMUM GREEN I (SEC.)		10	30	15	15	10	30	-	-
MAXIMUM GREEN II (SEC.)		40	40	40	40	40	40	-	-
YELLOW CHANGE (SEC.)		3.2	4.1	3.4	3.4	3.2	4.1	-	-
ALL RED CLEARANCE (SEC.)		4.4	1.4	2.5	2.5	4.4	1.4	-	-
DELAYED GREEN (LPI) (SEC.)		-	-	-	-	-	-	-	-
FLASHING YELLOW ARROW DELAY (SEC.)		-	-	-	-	-	-	-	-
WALK (SEC.)		-	11	12	-	-	10	-	-
PEDESTRIAN CLEARANCE (SEC.)		-	28	35	-	-	26	-	-
RECALL		MAXIMUM (ON/OFF)	-	-	-	-	-	-	-
		MINIMUM (ON/OFF)	-	ON	-	-	ON	-	-
		PEDESTRIAN (ON/OFF)	-	-	-	-	-	-	-
MEMORY		(ON/OFF)	-	ON	-	-	ON	-	-

*VOLUME DENSITY CONTROLS

PHASING DIAGRAM

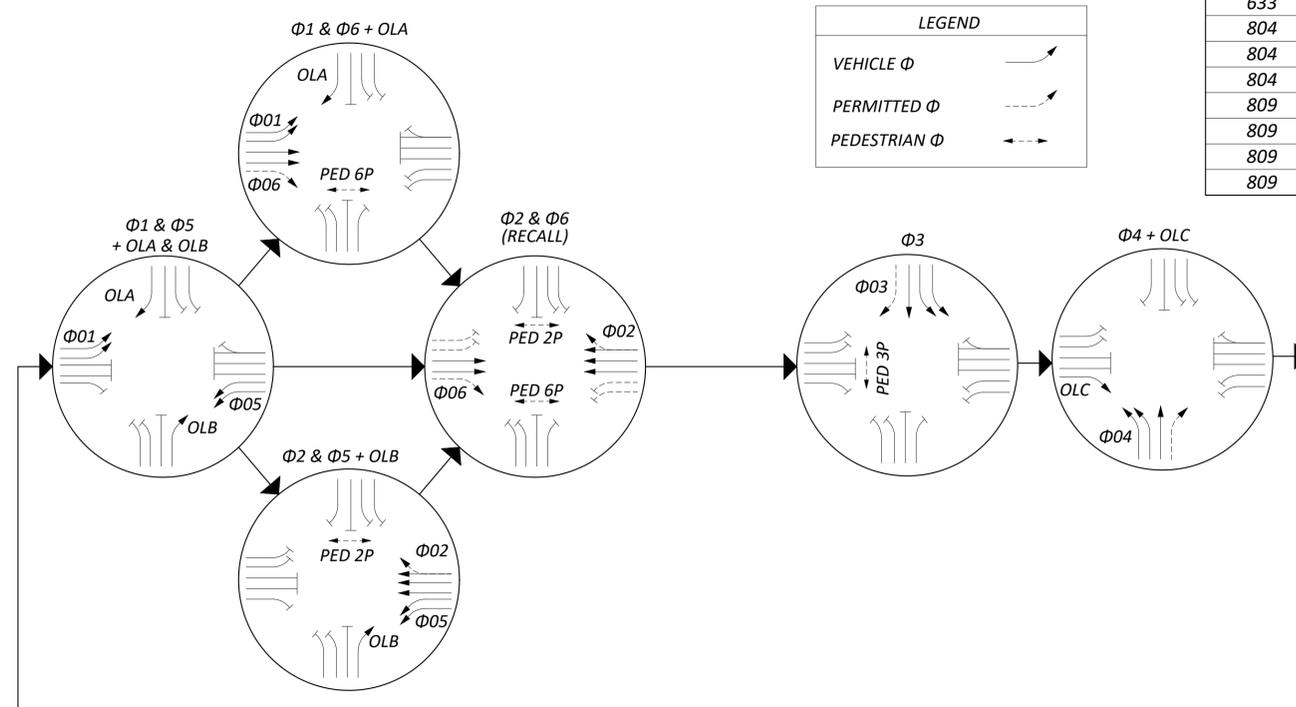

ITEM	ITEM EXT	TOTAL	UNIT	DESCRIPTION
625	00450	4	EACH	CONNECTION, FUSED PULL APART
625	00460	8	EACH	CONNECTION, UNFUSED PULL APART
625	00480	4	EACH	CONNECTION, UNFUSED PERMANENT
625	18201	1	EACH	BRACKET ARM, 15', AS PER PLAN
625	18501	2	EACH	BRACKET ARM, 25', AS PER PLAN
625	18511	1	EACH	BRACKET ARM, 30', AS PER PLAN
625	23304	1473	FT	NO. 8 AWG 600 VOLT DISTRIBUTION CABLE
625	23400	645	FT	NO. 10 AWG POLE & BRACKET CABLE
625	25410	57	FT	CONDUIT, 2", 725.052
625	25606	95	FT	CONDUIT, 4", 725.052
625	25908	491	FT	CONDUIT, JACKED OR DRILLED, 725.052, 4"
625	26253	4	EACH	LUMINAIRE, CONVENTIONAL, SOLID STATE (LED) 120V, TYPE III DISTRIBUTION, AS PER PLAN
625	29002	121	FT	TRENCH, 24" DEEP
625	30706	5	EACH	PULL BOX, 725.08, 24"
625	32000	8	EACH	GROUND ROD
630	79101	13	EACH	SIGN HANGER ASSEMBLY, MAST ARM, AS PER PLAN
630	79201	2	EACH	SIGN ATTACHMENT ASSEMBLY, MAST ARM, AS PER PLAN
630	80100	129.5	SF	SIGN, FLAT SHEET
632	05006	16	EACH	VEHICULAR SIGNAL HEAD, (LED), 3-SECTION, 12" LENS, 1-WAY, POLYCARBONATE, BLACK
632	05086	3	EACH	VEHICULAR SIGNAL HEAD, (LED), 5-SECTION, 12" LENS, 1-WAY, POLYCARBONATE, BLACK
632	20731	6	EACH	PEDESTRIAN SIGNAL HEAD (LED), TYPE D2, COUNTDOWN, AS PER PLAN, BLACK
632	26001	6	EACH	PEDESTRIAN PUSHBUTTON, AS PER PLAN
632	25010	19	EACH	COVERING OF VEHICULAR SIGNAL HEAD
632	25010	6	EACH	COVERING OF PEDESTRIAN SIGNAL HEAD
632	40500	1398	FT	SIGNAL CABLE, 5 CONDUCTOR, NO. 14 AWG
632	40700	3253	FT	SIGNAL CABLE, 7 CONDUCTOR, NO. 14 AWG
632	64010	4	EACH	SIGNAL SUPPORT FOUNDATION
632	64020	3	EACH	PEDESTAL FOUNDATION
632	65300	1368	FT	LOOP DETECTOR LEAD-IN CABLE, 2 CONDUCTOR, NO. 14 AWG
632	66102	127	FT	POWER CABLE, 2 CONDUCTOR, NO. 10 AWG
632	70001	1	EACH	POWER SERVICE, AS PER PLAN
632	70400	1	EACH	CONDUIT RISER, 2" DIAMETER
632	79150	4	EACH	COMBINATION SIGNAL SUPPORT, TYPE TC-81.22, DESIGN 14, AS PER PLAN
632	89901	3	EACH	PEDESTAL, 8' TRANSFORMER BASE, AS PER PLAN
632	90101	1	EACH	REMOVAL OF TRAFFIC SIGNAL INSTALLATION, AS PER PLAN
633	65511	1	EACH	CABINET, TYPE TS-2, AS PER PLAN
633	67100	1	EACH	CABINET FOUNDATION
633	67200	1	EACH	CONTROLLER WORK PAD
633	75001	1	EACH	UNINTERRUPTIBLE POWER SUPPLY (UPS), 1000 WATT, AS PER PLAN
804	32040	119	FT	DROP CABLE, 12 FIBER
804	34012	1	EACH	FIBER TERMINATION PANEL, 12 FIBER
804	98100	1	EACH	FIBER OPTIC CABLE, MISC.: MODIFY EXISTING SPLICE ENCLOSURE
809	60001	1	EACH	CCTV IP-CAMERA SYSTEM, PTZ, AS PER PLAN
809	65990	1	EACH	ITS DEVICE, MISC.: ETHERNET SWITCH WITH GIGABIT UPLINK
809	69101	4	EACH	STOP LINE RADAR DETECTION, AS PER PLAN
809	69123	1	EACH	ATC CONTROLLER, AS PER PLAN

RADAR DETECTION CHART

DETECTION ZONE	MOVEMENT	PULSE OR PRESENCE	ASSOCIATED PHASE	DELAY PROGRAMMED IN CONTROLLER (SEC.)	EXTENSION PROGRAMMED IN CONTROLLER (SEC.)	DETECTOR NO.	PURPOSE	DETECTION ZONE LENGTH (FT)
RDZ1A	EBLT	PRESENCE	Φ1			RD1	STOP LINE	30'
RDZ1B	EBLT	PRESENCE	Φ1			RD1	STOP LINE	30'
RDZ3A	SBTR	PRESENCE	Φ3			RD2	STOP LINE	30'
RDZ3B	SBLT	PRESENCE	Φ3			RD2	STOP LINE	30'
RDZ3C	SBLT	PRESENCE	Φ3			RD2	STOP LINE	30'
RDZ3D	SBLT	PRESENCE	Φ3			RD2	STOP LINE	30'
RDZ4A	NBTR	PRESENCE	Φ4			RD3	STOP LINE	30'
RDZ4B	NBTR	PRESENCE	Φ4			RD3	STOP LINE	30'
RDZ4C	NBLT	PRESENCE	Φ4			RD3	STOP LINE	30'
RDZ4D	NBLT	PRESENCE	Φ4			RD3	STOP LINE	30'
RDZ5A	WBLT	PRESENCE	Φ5			RD4	STOP LINE	30'
RDZ5B	WBLT	PRESENCE	Φ5			RD4	STOP LINE	30'








TEC Engineering, Inc.
PLAN PREPARED BY:
TEC Engineering, Inc.
7280 Centerville Road
Mason, OH 45040

ISSUED FOR:	REVISION	NO	DATE
1/13/2026			
SCALE:	DESIGNED BY:	DRAWN BY:	CHECKED BY:
	AFS	AFS	ALH

EAST KEMPER ROAD IMPROVEMENTS AND SHARED USE PATH, PH. 1
CITY OF SPRINGDALE - HAMILTON COUNTY, OHIO
TRAFFIC SIGNAL DETAILS

PROJECT NO.	242429
DISCIPLINE	CIVIL
SHEET NAME	TSD1
SHEET	OF
39	47

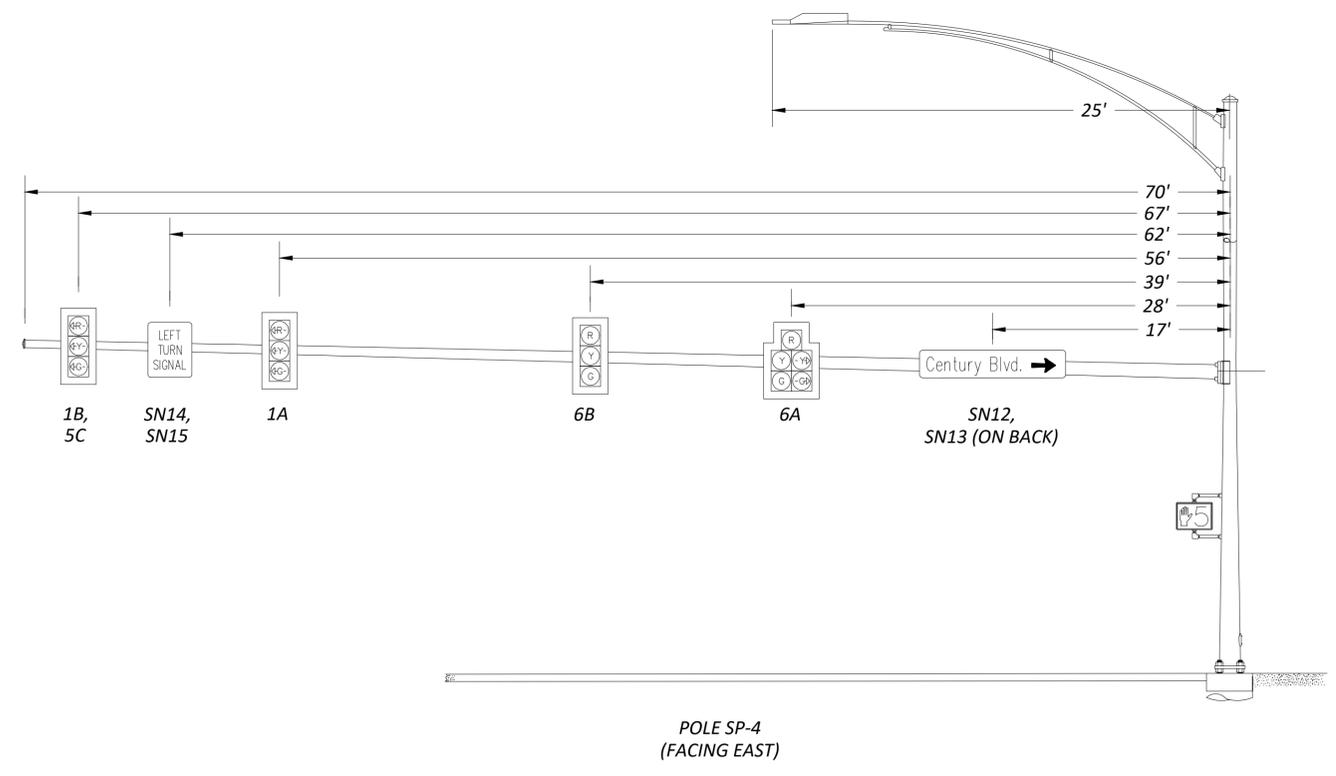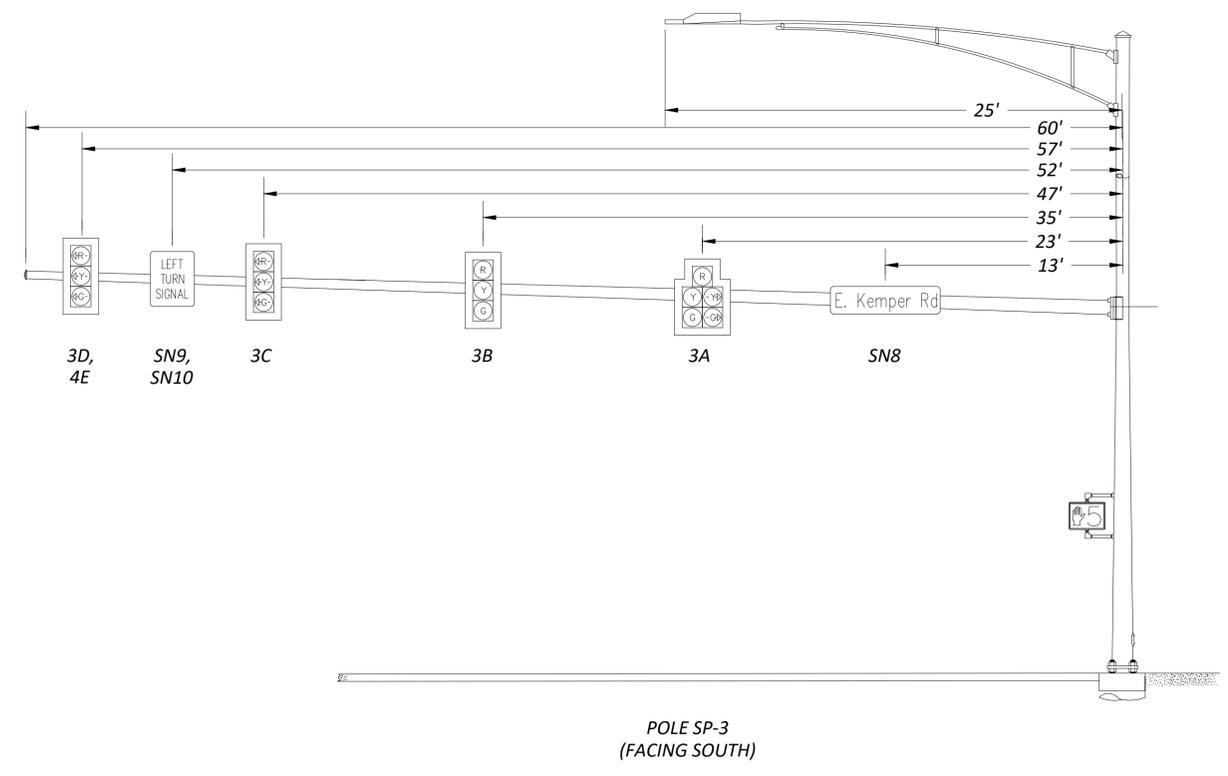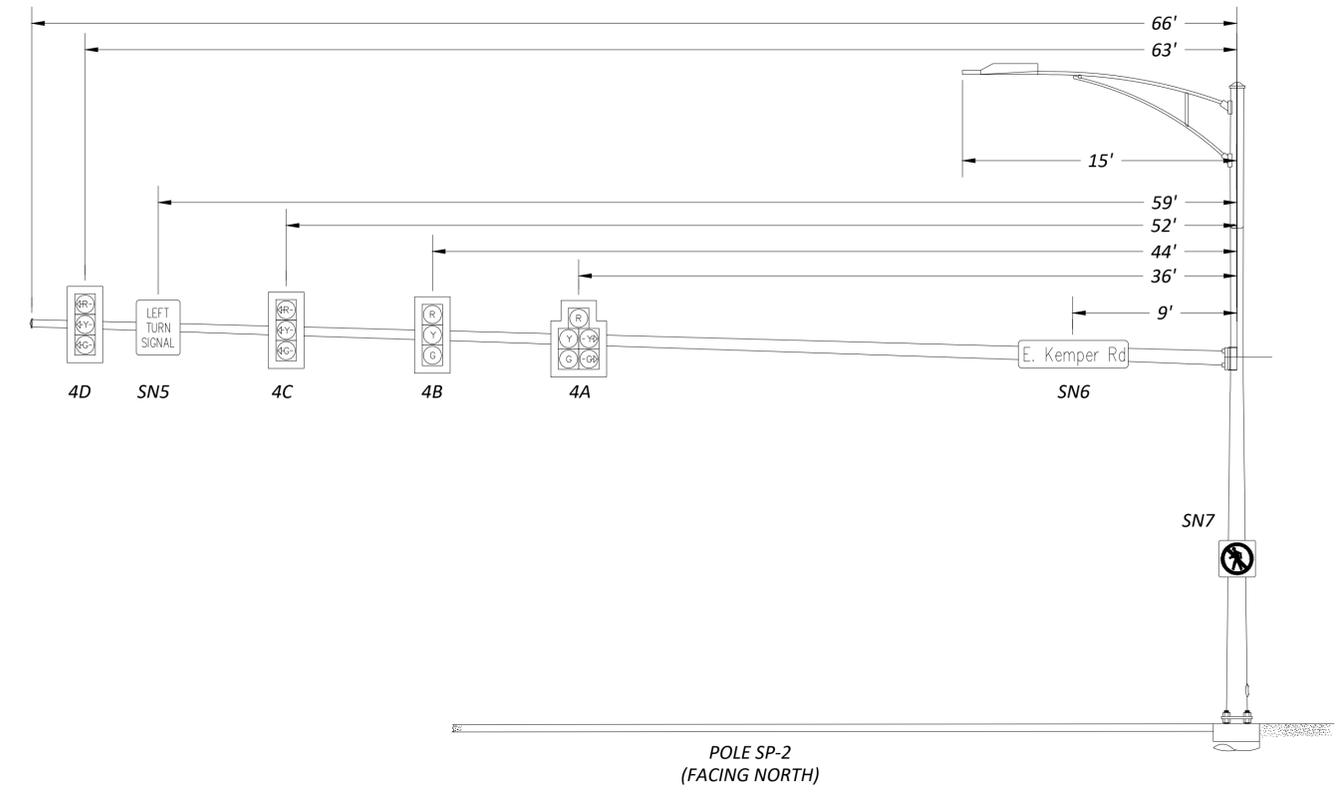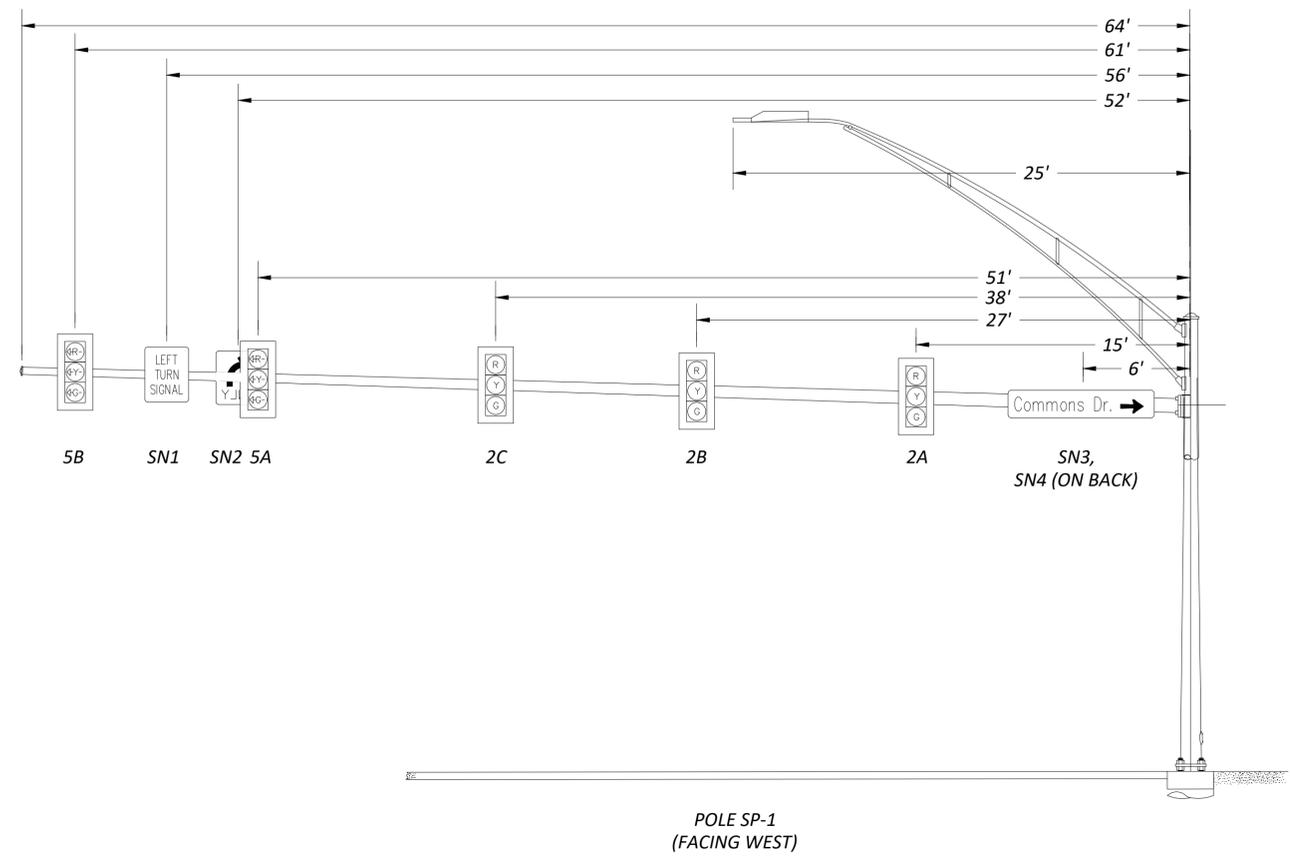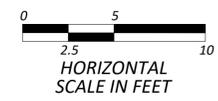

NO	REVISION	DATE

ISSUED FOR:	REVIEW	NO
ISSUE DATE:	1/13/2026	
SCALE:	1:5	
DESIGNED BY:	AFS	
DRAWN BY:	AFS	
CHECKED BY:	ALH	

EAST KEMPER ROAD IMPROVEMENTS AND SHARED USE PATH, PH. 1
CITY OF SPRINGDALE - HAMILTON COUNTY, OHIO

TRAFFIC SIGNAL ELEVATION 2

PROJECT NO.	242429
DISCIPLINE	CIVIL
SHEET NAME	TSE2
SHEET	42
OF	47

GENERAL PROVISIONS

The Contractor is advised that there are several changes to the most recent edition of the City of Cincinnati Supplement dated January 1, 2023. These General Provisions include these changes. The Supplement and a Summary of Changes can be purchased or downloaded from the City's website: <http://www.cincinnati-oh.gov/dote/assets/File/2023%20CITY%20SUPPLEMENT-FINAL.pdf>

Water main items are to be constructed in accordance with the provisions of the State of Ohio, Department of Transportation, Construction and Material Specifications, dated January 1, 2023, and modified by the City of Cincinnati Supplement to said State of Ohio Specifications, effective January 1, 2023, and any supplements or changes thereto. Copies of the State specifications are on file at the Office of Contract Sales of the State of Ohio, Department of Transportation, 25 South Front Street, Columbus, Ohio, and at the offices of the City Engineer of Cincinnati, Ohio. Submission of a bid for this project implies that the Contractor has taken all provisions of the Supplement into account.

The Greater Cincinnati Water Works (GCWW) understands that differing site conditions results in extra work/change orders to the project. Change orders on GCWW contracts will be done in strict accordance with Item 109.05 C of the State of Ohio Department of Transportation Construction and Material Specifications dated January 1, 2023 or most recent edition and as modified in this City of Cincinnati Supplement. GCWW limits the mark up on wages and fringe benefits as described in 109.05 C. 2, "Labor" to 30%. It is expressly understood that regardless of the nature of the claim, or change in scope of work, the Contractor is not entitled to compensation for loss of anticipated profit or production.

As defined in the City of Cincinnati Supplement, sections 107.07 and 107.071, the Contractor is required to submit, at the time of the pre-construction meeting, a Site Safety Plan. Furthermore, the Contractor shall have an authorized and competent safety representative assigned to the project site.

The Contractor is advised that he has certain responsibilities under Section 153.64 of The Ohio Revised Code. For all underground utilities, contact the Ohio Utilities Protection Service at 1-800-362-2764 (toll free) 48 hours in advance of work. The Contractor is advised that all utility information has been shown on the contract plans from information provided by the owner of each utility in compliance with Sec. 153.64 of the Ohio Revised Code. In cases where utility information is incorrect and it results in a change in the contract plans the Contractor shall first notify the owner of the utility to determine the necessary course of action. The Contractor shall submit any subsequent claims as a result of downtime or additional work to the owner of the conflicting utility. The GCWW will not accept claims for any utility other than those as a result of incorrect water main and related appurtenance information.

The Contractor must locate or "pot hole" all utilities within the alignment of the proposed main a minimum of 50 feet ahead of pipe laying. Test holes must be dug, or trench excavated, a minimum of 50 feet (15.2 m) in advance of pipe laying, to assure proper clearance between the water main and any utility crossing, or underground structure. All utilities and structures shall be suitably braced and supported. The Contractor shall understand that any obstructions encountered in the installation of the main, due to the failure of having 50 feet (15.2m) of trench excavated ahead of laying operations, may require removal and relaying of the pipe at the contractors expense. The GCWW will not accept a claim for different utility conditions encountered when test holes are not performed as required.

Item 1120, "Exploratory Excavation", shall not include excavations within the limits of the proposed trench as defined in 1101.04 and 1101.05. Test holes are required on all utilities within 50 feet of the last laid pipe. Test holes within the alignment of the proposed trench are included in the Contractor's unit bid for Item 1101. Locations to be explored will vary from areas within the roadway to areas outside of the roadway.

It is the nature of construction that unmarked utilities or utilities not shown on the plans may be encountered within the excavation for the proposed work. the contractor is responsible to identify and remove any abandoned utilities encountered in the excavation. unless otherwise noted on the plans, no extra payment will be made for up to 10" diameter, width or depth utilities, to the contractor for the identification and removal of the abandon utility. All costs shall be included in the contractor's unit price bid for the appropriate item 1101, "Laying ductile iron pipe and fittings".

Street pavement or sidewalk should not be disturbed for a distance of more than 200 Feet (61.0 m) ahead of the last laid pipe. Backfill shall be completed within 50 feet (15.2 m) of the last laid pipe. Temporary or permanent surface restoration must be installed within a distance of 200 feet (61.0 m) of the laid pipe, including those areas where main installations occur within a closed lane or closed street condition. Roadway plates may be used as a temporary measure for a period not to exceed 24 hours without the approval of the GCWW.

Any undermined pavement of more than 6 inches horizontal must be removed prior to starting trench backfill. If undermining of pavement occurs more than 1 foot, then pavement must be shored to protect traffic, or arrangements made for additional lane closures must be made. If problems continue to occur regarding trenching integrity, sheeting and bracing can be required by the City Engineer or the City Engineer's representative, at the contractor's expense. If any tunneling is necessary, adequate information shown in both plan and profile and tunneling procedures must be submitted to the City Engineer's Office prior to commencement of work.

The GCWW has made every effort to depict the pipe sewers and lateral information on the plans. The Contractor is advised that sewer laterals are shown in plan view only. The Contractor shall determine the elevation of the sewer laterals in advance of laying the water main at these crossings. If the sewer laterals require changing in order to avoid conflict with the water main, or if the Contractor encounters a pipe sewer or lateral in the excavation that was not shown on the plans and requires a change of grade or alignment due to the installation of the water main, the Contractor shall furnish all necessary labor, material, tools, and equipment required to change the grade or alignment of pipe sewers and laterals of various sizes, allowing installation of water mains and appurtenances as shown on the plans, or as directed by the GCWW Inspector. This work shall include all necessary excavation, backfill, and restoration. The Contractor will be compensated under Item 1123, "Changing Pipe Sewers 8 Inch and Under". When crossing sanitary and combination sewers, a vertical clearance of 18" must be maintained.

Notice of Confidentiality – Public Infrastructure Record

This Document is a Public Infrastructure Record of the City of Cincinnati and its Greater Cincinnati Water Works, and is not subject to the public disclosure requirements of the public records laws of the State of Ohio and federal government. This Document is being provided on the basis of your reported need, and shall be considered confidential. By accepting this Document, you agree that it will not be shared or otherwise disclosed to anyone other than persons who have a direct need to know for the sole purpose of carrying out the project for which this Document was obtained. Anyone receiving this Document is bound by the same confidentiality requirements and must take precautions to protect against its dissemination.

The failure to observe the confidentiality requirements of this Notice shall serve as the basis for the City of Cincinnati to immediately seek legal recourse, including the recovery of actual damages resulting from unauthorized access or disclosure of the Document.



The Contractor is advised that due to the alignment of the proposed water main, it may be necessary to install a temporary valve box over an existing chambered valve that must remain in service during the water main installation as directed by the GCWW Inspector. The chamber shall be abandoned, a valve box (furnished by the contractor) placed over the valve, and upon project completion, the valve box must be removed. The contractor will not receive additional compensation for this work, but should include the cost of this work in his unit bid price for Item 1101, "Furnishing & Laying Ductile Iron Pipe and Fittings".

It is the Contractor's responsibility to provide adequate water supply for domestic and fire fighting purposes. In order to accomplish the water main connections with a minimum amount of inconvenience to the consumers, it may be necessary to do the work at other than normal working hours or as may be scheduled by the GCWW.

The Contractor is advised that the operating pressure of the existing water main within the limits of the subject project is approximately **100–130 P.S.I.**

In order to minimize the inconvenience of the consumers, the number of shutdowns required to do the proposed water main work shall be limited. Only one shutdown, limited to 8 hours, will be allowed during a 24 hour period.

All water service branches have a minimum cover of 3.0 feet.

The Contractor is advised that it shall be necessary to install temporary Plug/caps on the existing and proposed water mains in order to maintain service during testing and water main and branch connections. These temporary Plug shall be furnished by the contractor. He is responsible for their proper installation. The cost for this work shall be included in the Contractor's unit bid price for the appropriate Item 1101, "Furnishing & Laying Ductile Iron Pipe and Fittings".

The Contractor is required to excavate and expose the existing utilities and existing water mains along the line of the proposed water main and all proposed connection points to verify location, diameter, line and grade. Also, if the removal of the bulkhead or plug is required all excavation and temporary/permanent restoration shall be compensated under the Contractor's unit bid price for Item 1101, "Furnishing & Laying Ductile Iron Pipe and Fittings".

The Contractor is advised that all C.J. Plug are to be restrained with a Field Lok Gasket and all M.J. caps are to be restrained using a M.J.R.G.. This includes temporary Plug and caps for testing purposes. When a temporary plug is used, the contractor is permitted to remove the plug by cutting the section of pipe containing the plug and using a solid sleeve at that point to complete the tie-in. In the event that a cap is used, the contractor shall remove the M.J.R.G. and cap before completing the tie-in.

The Contractor is advised that on any fire hydrant required to be relocated with this project, all bolt assemblies shall be replaced. The cost for this work shall be included in the unit bid price for Item 1113 "Relocating Existing Fire Hydrants". No part of any fire hydrant setting shall be installed closer than five feet to any driveway, inlet, utility pole or guy wire anchor.

Item 1111, "Water Works Valve Chambers", shall also cover the furnishing and installing of Precast Reinforced Concrete Chambers in accordance with O.D.O.T. Specification 706.13. All pertinent provisions of this item and GCWW Standard Drawing No. 104-1A shall apply. Precast chambers shall be used in all locations where space permits and as directed by the GCWW.

Air cocks may be necessary for the proper operation of the water system. The Air Release Assembly, which may not be shown on the drawing, will be furnished and installed by the Contractor per the detail on these plans, if required by the GCWW.

It shall be the Contractor's responsibility to arrange for the removal and replacement of any poles and guys necessary for the installation of the proposed water mains, and any cost connected thereto shall be at his expense.

All pipe and specials shall be in accordance with City of Cincinnati Specification 40-110-16.

All procured water main and appurtenance materials, other than those furnished through the GCWW must be properly certified; certified for GCWW Inspection; or already inspected by the GCWW. Pipe, fittings, valves and fire hydrants must be GCWW inspected and stamped materials.

The Contractor should be advised that all Fittings (Bends, Offset Bends, Tees, Crosses, Sleeves, Caps and Plug) supplied for this job may be either ANSI/AWWA C-110 Full-body Ductile Iron, Cement Lined Fittings or ANSI/AWWA C-153 Compact Ductile Iron, Fusion Bonded Epoxy Coated Fittings in accordance with City of Cincinnati, Department of Purchasing, Standard Specification No. 40-110-12 for Pipe and Fittings Water, Ductile Iron 3" to 60". All fittings are subject to inspection and approval by appropriate GCWW Inspection personnel. Minor pinholes and abrasions to epoxy coated valves and fittings are to be repaired using 3M Hot Melt Patch Compounds (H.M.P.C.) in the stick form. Repair procedures shall be in accordance with the General Application Steps identified for the H.M.P.C. All repairs to epoxy coated fittings are subject to inspection and approval by appropriate GCWW Inspection personnel.

All rejected material, including pipe and fittings, shall be removed from the project site immediately.

The Contractor must maintain access to sidewalks at all times. Storage of any materials within the public Right of Way, including sidewalks, is not permitted unless approved by GCWW, the Project Engineer, or as indicated on the approved plans.

All copper tubing shall be type "K" of a standard nominal size: 3/4", 1", 1-1/2" and 2". All fittings will have copper flare type connections and shall be in accordance with City of Cincinnati Specification No. 40-113-05.

The contractor shall furnish the necessary certifications for branch material.

All proposed water mains will be hydrostatically tested for leakage in accordance with 1101.054, "Hydrostatic Test for Leakage", of the appropriate Item 1101, "Furnishing & Laying Ductile Iron Pipe and Fittings".

The Contractor will be responsible for filling, flushing, and pressure testing new water mains, 20" or smaller. the contractor will provide all labor, material and equipment (including the necessary pumps to apply the pressure test). The Water Works will provide the necessary meter and gauge. All costs for this work shall be included in the contractor's unit bid price for Item 1101, "Furnishing & Laying Ductile Iron Pipe and Fittings". Once the filling and pressure testing are completed, the Contractor will be responsible for flushing the proposed water main and the GCWW will be responsible for bacteria sampling. The GCWW will be responsible for filling, pressure testing and flushing new water mains greater than 20".

The Contractor is responsible for all pipe sewers disturbed in the completion of this project. In the event it becomes necessary to repair or replace existing pipe sewers, the Contractor must notify Sewer Maintenance, (513)244-1369, before proceeding with the work.

The Contractor is advised that his unit bid prices for the appropriate Item 1101, "Furnish & Install Pipe and Fittings", includes final restoration of all disturbed surfaces. The GCWW will not make full compensation under Item 1101 until final restoration is complete.

*All valve and air release box assemblies shall be domestically manufactured.

All box assemblies for 12-inch and smaller gate valves and 1-inch air releases shall be either Tyler Union Series 6850, EJ Series 8500, or Bingham & Taylor Series 4905, or GCWW approved equal. Box assemblies for these applications require a frost plug and "BOXLOK."

All box assemblies for 16-inch and above butterfly or gate valves and 2-inch air releases shall be EJ Series 460, or GCWW approved equal. Box assemblies for these applications require a frost plug.

All costs associated with adherence to these requirements shall be included in the Contractor's unit bid price for Item 1116 - Furnishing and Installing Valve Box Complete.

SUGGESTED BILL OF MATERIALS

FURNISHED BY CONTRACTOR

QTY	UNIT	DESCRIPTION
5	EACH	6" DUCTILE IRON PIPE, C.J., TH. CL. 55, 20' LENGTH
1	EACH	12" DUCTILE IRON PIPE, C.J., TH. CL. 56, 20' LENGTH
6	EACH	POLYETHYLENE TUBE, 16" WIDE X 20' LONG, 4 MIL CROSS LAMINATE
2	EACH	POLYETHYLENE TUBE, 27" WIDE X 20' LONG, 4 MIL CROSS LAMINATE
1	ROLLS	POLYETHYLENE TAPE, 2" WIDE X 100' LONG
3	EACH	6" 45° BEND, 2 M.J.
6	EACH	12" SOLID SLEEVE, 2 M.J.
1	EACH	12" X 6" TEE, 2 M.J. X FLG.
1	EACH	12" X 6" TEE, 3 M.J.
NOTE 1	1	EACH 6" VALVE, FLG. X M.J.
NOTE 1	1	EACH 6" FLANGE TYTE RUBBER GASKET
2	EACH	VALVE BOX COMPLETE
2	EACH	VALVE BOX BOXLOK
2	EACH	VALVE BOX FROST PLUG
2	EACH	6" FH EXTENSION (12' LONG)
NOTE 4	12	EACH 6" M.J.R.G. ASSEMBLY
NOTE 4	16	EACH 12" M.J.R.G. ASSEMBLY

SERVICE BRANCH MATERIAL

FURNISHED BY CONTRACTOR

QTY	UNIT	DESCRIPTION
NOTE 2	32	LIN. FT. 2" COPPER SERVICE PIPE W/AQUA SHIELD
NOTE 3	1	EACH 2" INSULATING COUPLING
NOTE 3	1	EACH 2" STOP COCK
	1	EACH ROADWAY BOX

FURNISHED BY CITY OF SPRINGDALE

QTY	UNIT	DESCRIPTION
1	EACH	6" FIRE HYDRANT

***Note: Contractor shall verify the size and material of each service branch at the property line prior to installing branch. Cost for this work to be included in Item 1126-"Furnishing and Installing Copper Service Pipe w/ Aqua Shield".

The materials listed are only suggested for use during the water main and branch relocation work as proposed on the drawings. The contractor shall furnish additional material where needed. No allowance will be made for unused material nor will any extra payment be made for additional specials required to complete the water main work. Before ordering material the contractor is responsible for making his own field measurements and for field verifying the O.D. of existing water mains where sleeves and pipe couplings are involved.

Note 1:
Valves furnished by the contractor shall be; American Resilient Wedge Gate Valve Series 2500, U.S. Pipe Metrosafe Gate Valve, Kennedy Valve Ken Seal II Resilient Gate Valve, Clow F-6100 Series Resilient Wedge Gate Valve, Mueller 2360 Resilient Wedge Gate Valve.


Note 2:
Low-Lead Brass Material Requirements:
All components in contact with water shall be fabricated from Sebiloy II or Federalloy I-836 alloys or a material approved by the Engineer. All components that do not come in contact with water shall comply with the requirements of ASTM B 62 Copper Alloy Number. Coated or washed metals are not acceptable if their lead levels exceed .25% by weight prior to the coating or washing process. All service fittings and materials shall be certified as suitable for contact with drinking water by an accredited certification organization in accordance with ANSI/NSF Standard 61, Drinking Water Systems Components - Health Effects. All service fittings shall either be stamped or embossed with the letter "NL", to indicate "No-Lead", or marked to indicate that the product is manufactured from the low-lead alloys.

Note 3:
Special Note on Service Pipe in Corrosive Soils:
Service tubing is to be soft K Copper manufactured to the requirements of ASTM B88. Service tubing coating shall have NOVA Polyethylene LLDPE extrusion resin PP-0118-F coating to meet minimum of .026 mil thickness containing UV inhibitors. Service tubing shall have identification & traceability on both copper & plastic continuously line-marked with tube contents, ASTM specification, size, & descending footage. Unique lot number printed on both copper & plastic allowing product to be traced back to origin and time of manufacturing. Service tubing shall be Aqua Shield as manufactured by KAMCO Products Inc. or approved equal.

Note 4:
Mechanical Joint Restrain Gland (MJRG):
All mechanical joint restraint glands furnished by the contractor shall be any of the following:
EBAA--Megalug
TYLER/UNION--Tufgrip
STAR--Stargrip
FORD--Uni-Flange Series 1400

All products shall be domestically manufactured.

STANDARD WATER MAIN TRENCH INSTALLATION DETAIL

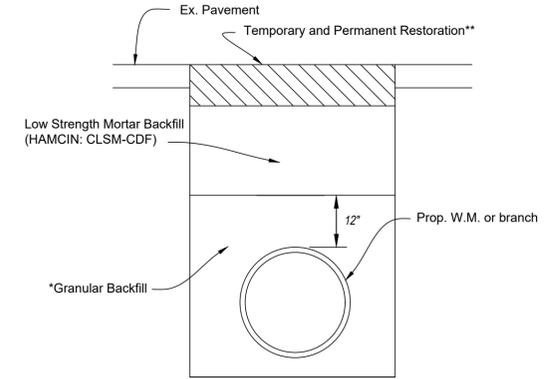

**TEMPORARY AND PERMANENT RESTORATION SHALL BE DONE IN ACCORDANCE WITH THE CONTRACT SPECIFICATIONS AND/OR PROJECT PLAN TYPICAL SECTIONS. (MATCH THE "STORM SEWER TRENCH RESTORATION.")

IN AREAS WHERE THE PAVEMENT; BASE AND/OR SUB-BASE IS TO BE REPLACED AS PART OF THE ROADWAY CONTRACT, THE COST FOR PERMANENT PAVEMENT RESTORATION SHALL BE INCLUDED UNDER THE APPROPRIATE PAVEMENT BID ITEMS. COST FOR TEMPORARY PAVEMENT RESTORATION IN THESE AREAS SHALL BE INCLUDED IN THE CONTRACTOR'S APPROPRIATE UNIT BID PRICE FOR ITEM 1101 OR ITEM 1126.

UNLESS OTHERWISE NOTED ON THE PLANS, AREAS WHERE THE EXISTING PAVEMENT, BASE AND/OR SUB-BASE ARE NOT TO BE DISTURBED, THE COST FOR TEMPORARY AND PERMANENT PAVEMENT RESTORATION SHALL BE INCLUDED IN THE CONTRACTOR'S APPROPRIATE UNIT BID PRICE FOR ITEM 1101 OR ITEM 1126.

*BACKFILL OF THE WATER MAIN AND BRANCH TRENCH SHALL BE DONE IN ACCORDANCE WITH G.C.W.W. SPECIFICATIONS. ALL WATER MAINS AND BRANCHES INSTALLED OUTSIDE OF THE PAVEMENT AREA SHALL UTILIZE GRANULAR BACKFILL IN LIEU OF THE CONTROL DENSITY FILL. ALL COSTS FOR BACKFILL SHALL BE INCLUDED UNDER ITEM 1101, "FURNISHING AND INSTALLING DUCTILE IRON PIPE AND FITTINGS".

CONTROLLED DENSITY FILL MUST MEET BOTH HAMCIN: CLSM-CDF PERFORMANCE SPECIFICATION AND O.D.O.T. SPECIFICATION. ALL FLOWABLE FILL PRODUCTS SHALL MEET THE REQUIREMENTS OF THE CURRENT HAMCIN CLSM-CDF BACKFILL SPECIFICATION (DATED MARCH 2015). COPIES OF THE HAMCIN CLSM-CDF BACKFILL SPECIFICATION ARE MADE AVAILABLE AT THE GCWW ENGINEERING OFFICES AT 4747 SPRING GROVE AVENUE, CINCINNATI DEPARTMENT OF TRANSPORTATION & ENGINEERING AT 801 PLUM STREET, OR THEIR WEBSITE: [HTTP://WWW.CINCINNATI-OH.GOV/DOTE/MANUALS-PERMITS-SUPPLEMENTS/](http://www.cincinnati-oh.gov/dote/manuals-permits-supplements/) ALSO, THE CONTRACTOR SHALL SUBMIT, PRIOR TO THE START OF CONSTRUCTION, THE NECESSARY DOCUMENTATION FOR REVIEW AND APPROVAL BY THE GCWW.

PLEASE NOTE THAT THE G.C.W.W. REQUIREMENT IS IN ADDITION TO HAMCIN SPECIFICATIONS FOR FLOWABLE FILL PRODUCTS. A COPY OF THE G.C.W.W. REQUIREMENT IS AVAILABLE AT THE G.C.W.W. ENGINEERING OFFICE LOCATED AT 4747 SPRING GROVE AVENUE. CONTACT THE SUPERVISOR OF INSPECTION AT 591-7870.

PRIOR TO THE START OF CONSTRUCTION, THE CONTRACTOR SHALL SUBMIT THE NECESSARY CONTROLLED DENSITY FILL COMPLIANCE DOCUMENTATION FOR REVIEW AND APPROVAL BY THE G.C.W.W.

GCWW NOTE:
ALL FIELD LAYOUT OF WATER MAIN PIPE AND SPECIALS SHALL BE THE RESPONSIBILITY OF THE CONTRACTOR AND SHALL BE PERFORMED BY A LICENSED SURVEYOR.

INDEX	
GENERAL PROVISIONS 1
SUGGESTED BILL OF MATERIALS 1
RESTORATION DETAILS 1
PLAN 2-5

EAST KEMPER RD. IMPROVEMENTS AND SHARED USE PATH STIMP

APPROVED: WW004784 / 4-4201 / MF-17100

Joseph M. Z...
GCWW SUPERVISING ENGINEER - DESIGN

Matthew S...
GCWW PRINCIPAL ENGINEER - SYSTEM FACILITIES

Haishan Piao
GCWW CHIEF ENGINEER

8/12/25
DATE

08-07-25
DATE

8/14/25
DATE

OEPA CERTIFICATION EXEMPT

NON - EXEMPT

Joseph M. Z...
SUPER REVIEW

8/12/25
DATE



CALCULATED	MRO	CHECKED	EGG

REVISIONS			

GREATER CINCINNATI
WATER WORKS
 ENGINEERING DIVISION / DESIGN SECTION
 3815 EASTERN AVENUE, CINCINNATI, OHIO 45226




SUGGESTED BILL OF MATERIAL
G.C.W.W. SPECIAL PROVISIONS

4-4201
 WW004784
 MF-17100

1
 5


EAST KEMPER RD. IMPROVEMENTS AND SHARED USE PATH STIMP

EAST KEMPER ROAD

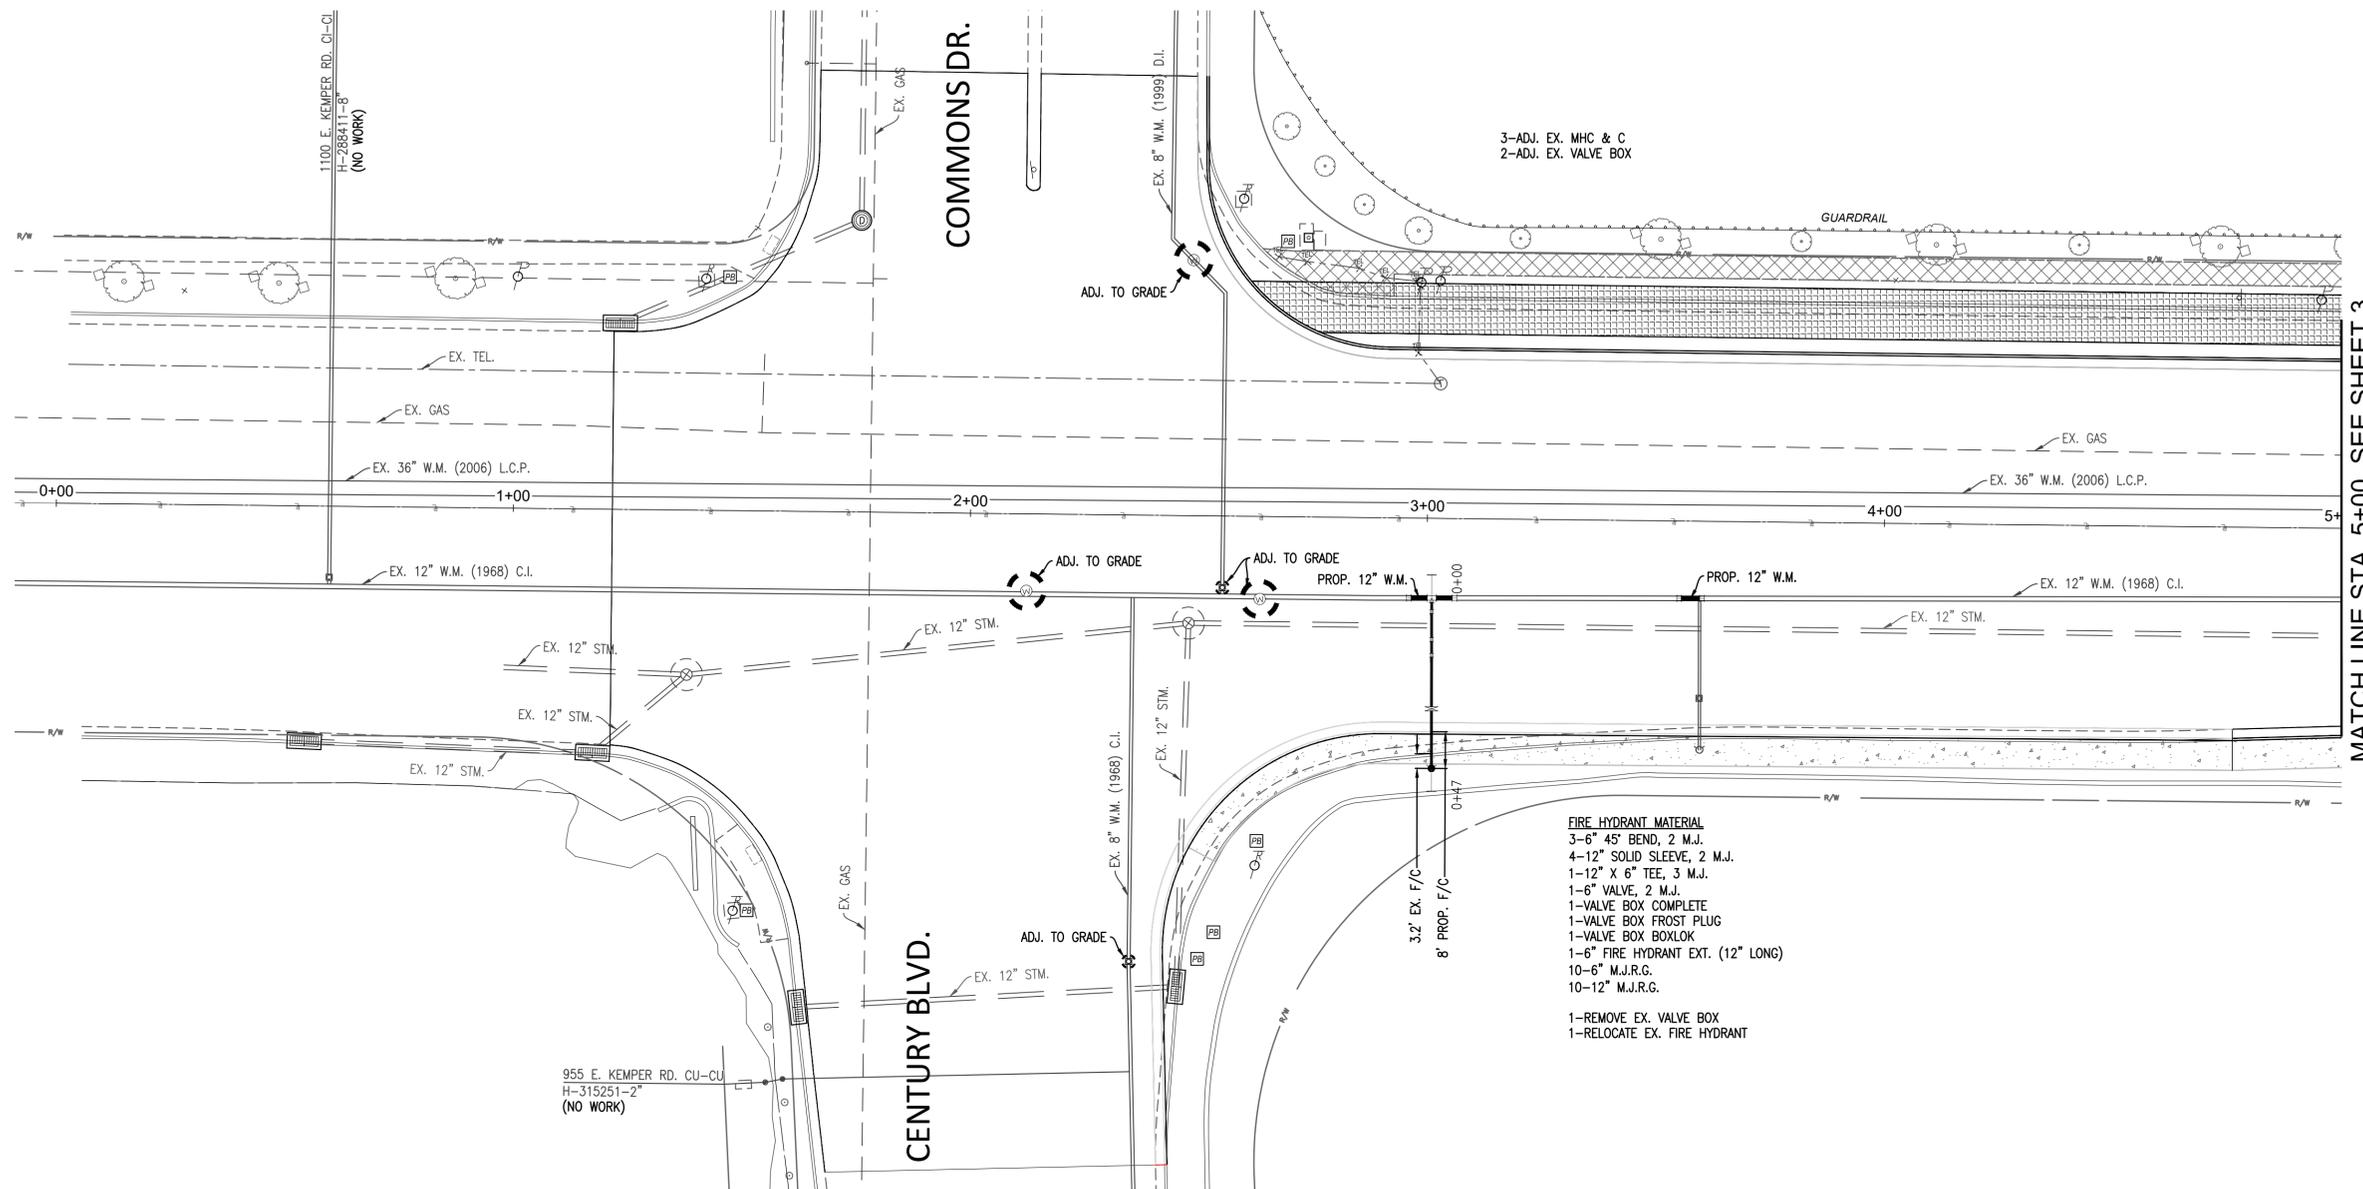


MATCH LINE STA. 5+00, SEE SHEET 3

1ST F.H. EAST OF CENTURY BLVD.
STA. 3+01
(LOOKING EAST)

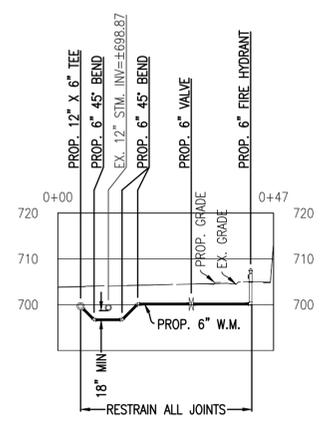

- FIRE HYDRANT MATERIAL**
- 3-6" 45° BEND, 2 M.J.
 - 4-12" SOLID SLEEVE, 2 M.J.
 - 1-12" X 6" TEE, 3 M.J.
 - 1-6" VALVE, 2 M.J.
 - 1-VALVE BOX COMPLETE
 - 1-VALVE BOX FROST PLUG
 - 1-VALVE BOX BOXLOK
 - 1-6" FIRE HYDRANT EXT. (12" LONG)
 - 10-6" M.J.R.G.
 - 10-12" M.J.R.G.
- 1-REMOVE EX. VALVE BOX
1-RELOCATE EX. FIRE HYDRANT

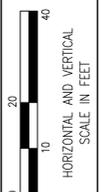

REVISIONS	CALCULATED
	MRD
	CHECKED
	EGG

GREATER CINCINNATI
WATER WORKS
ENGINEERING DIVISION / DESIGN SECTION
3845 EASTERN AVENUE, CINCINNATI, OHIO 45226



**EAST KEMPER ROAD
PLAN AND PROFILE**

4-4201
WW004784
MF-17100

2
5


EAST KEMPER RD. IMPROVEMENTS AND SHARED USE PATH STIMP

NOTICE OF CONFIDENTIALITY - PUBLIC INFRASTRUCTURE RECORD

THIS DOCUMENT IS A PUBLIC INFRASTRUCTURE RECORD OF THE CITY OF CINCINNATI AND ITS GREATER CINCINNATI WATER WORKS, AND IS NOT SUBJECT TO THE PUBLIC DISCLOSURE REQUIREMENTS OF THE PUBLIC RECORDS LAWS OF THE STATE OF OHIO AND FEDERAL GOVERNMENT. THIS DOCUMENT IS BEING PROVIDED ON THE BASIS OF YOUR REPORTED NEED, AND SHALL BE CONSIDERED CONFIDENTIAL. BY ACCEPTING THIS DOCUMENT, YOU AGREE THAT IT WILL NOT BE SHARED OR OTHERWISE DISCLOSED TO ANYONE OTHER THAN PERSONS WHO HAVE A DIRECT NEED TO KNOW FOR THE SOLE PURPOSE OF CARRYING OUT THE PROJECT FOR WHICH THIS DOCUMENT WAS OBTAINED. ANYONE RECEIVING THIS DOCUMENT IS BOUND BY THE SAME CONFIDENTIALITY REQUIREMENTS AND MUST TAKE PRECAUTIONS TO PROTECT AGAINST ITS DISSEMINATION.

THE FAILURE TO OBSERVE THE CONFIDENTIALITY REQUIREMENTS OF THIS NOTICE SHALL SERVE AS THE BASIS FOR THE CITY OF CINCINNATI TO IMMEDIATELY SEEK LEGAL RECOURSE, INCLUDING THE RECOVERY OF ACTUAL DAMAGES RESULTING FROM UNAUTHORIZED ACCESS OR DISCLOSURE OF THE DOCUMENT.

EAST KEMPER ROAD

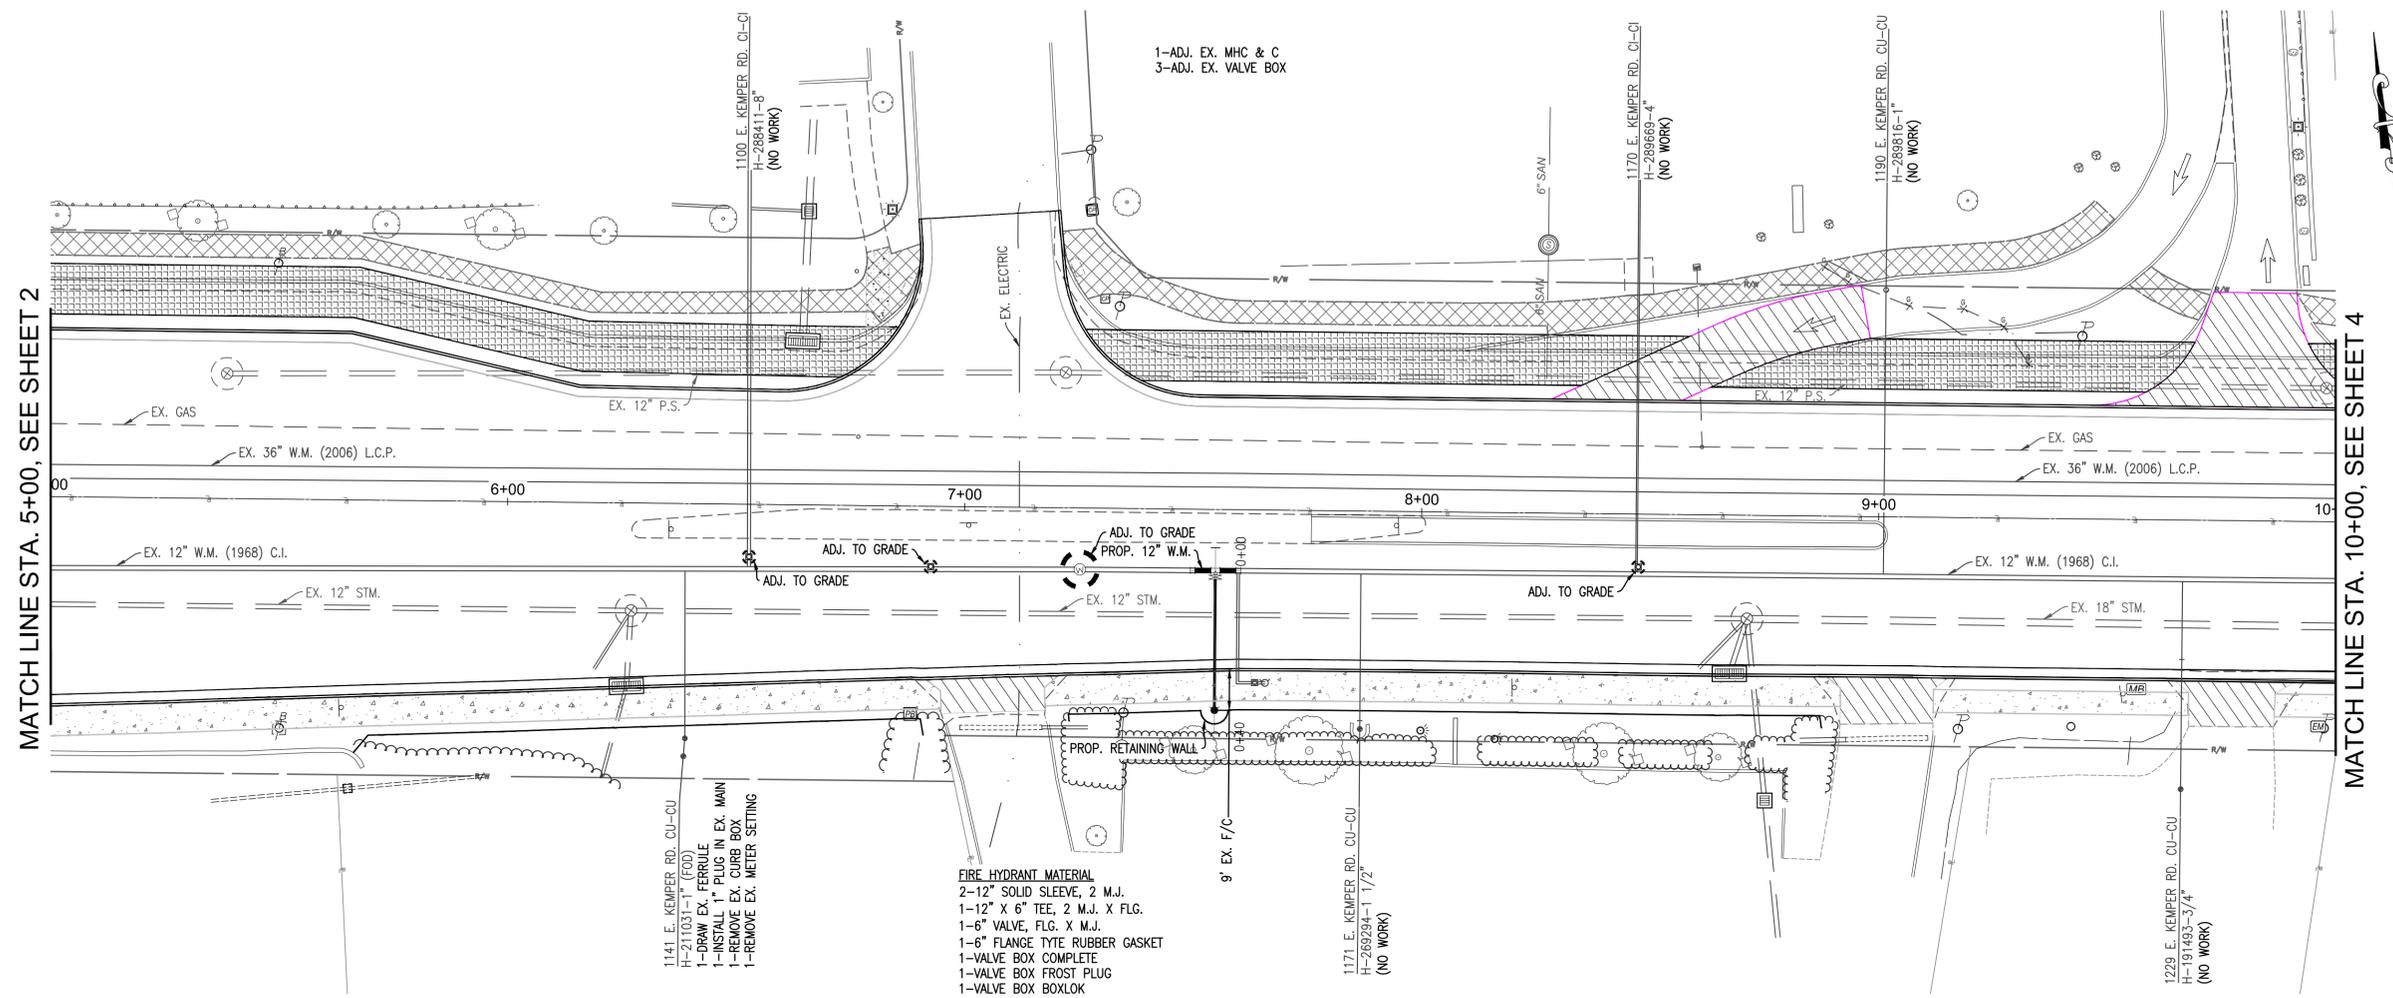

MATCH LINE STA. 5+00, SEE SHEET 2

MATCH LINE STA. 10+00, SEE SHEET 4



- FIRE HYDRANT MATERIAL**
- 2-12" SOLID SLEEVE, 2 M.J.
 - 1-12" X 6" TEE, 2 M.J. X FLG.
 - 1-6" VALVE, FLG. X M.J.
 - 1-6" FLANGE TYTE RUBBER GASKET
 - 1-VALVE BOX COMPLETE
 - 1-VALVE BOX FROST PLUG
 - 1-VALVE BOX BOXLOK
 - 1-6" FIRE HYDRANT EXT. (12" LONG)
 - 1-6" FIRE HYDRANT
 - 2-6" M.J.R.G.
 - 6-12" M.J.R.G.
 - 1-6" FIELD LOK GASKET
- 1-REMOVE EX. VALVE BOX
1-REMOVE EX. FIRE HYDRANT
- FIRE HYDRANT SPECIAL NOTE**
PROP. RETAINING WALL AS PER GCWW STD. 103-1A
(SEE EAST KEMPER ROAD IMPROVEMENT PLANS). ALL COSTS TO BE INCLUDED IN CONTRACTOR UNIT BID FOR ITEM 1112 FURNISHING AND INSTALLING FIRE HYDRANTS.

- 1141 E. KEMPER RD. CU-CU
H-211031-1 (FOOD)
1-DRAW EX. FERRULE
1-INSTALL 1" PLUG IN EX. MAIN
1-REMOVE EX. CURB BOX
1-REMOVE EX. METER SETTING

- 1171 E. KEMPER RD. CU-CU
H-269294-1 1/2"
(NO WORK)

- 1229 E. KEMPER RD. CU-CU
H-191493-3/4"
(NO WORK)

**2ND F.H. EAST OF CENTURY BLVD.
STA. 7+55
(LOOKING EAST)**

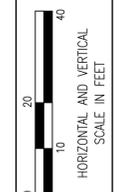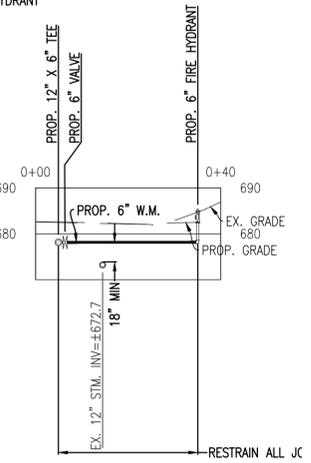

CALCULATED	MRD
CHECKED	EGB

REVISIONS

GREATER CINCINNATI
WATER WORKS
ENGINEERING DIVISION / DESIGN SECTION
3845 EASTERN AVENUE, CINCINNATI, OHIO 45226



**EAST KEMPER ROAD
PLAN AND PROFILE**

4-4201
WW004784
MF-17100


3
5

NOTICE OF CONFIDENTIALITY - PUBLIC INFRASTRUCTURE RECORD

THIS DOCUMENT IS A PUBLIC INFRASTRUCTURE RECORD OF THE CITY OF CINCINNATI AND ITS GREATER CINCINNATI WATER WORKS, AND IS NOT SUBJECT TO THE PUBLIC DISCLOSURE REQUIREMENTS OF THE PUBLIC RECORDS LAWS OF THE STATE OF OHIO AND FEDERAL GOVERNMENT. THIS DOCUMENT IS BEING PROVIDED ON THE BASIS OF YOUR REPORTED NEED, AND SHALL BE CONSIDERED CONFIDENTIAL. BY ACCEPTING THIS DOCUMENT, YOU AGREE THAT IT WILL NOT BE SHARED OR OTHERWISE DISCLOSED TO ANYONE OTHER THAN PERSONS WHO HAVE A DIRECT NEED TO KNOW FOR THE SOLE PURPOSE OF CARRYING OUT THE PROJECT FOR WHICH THIS DOCUMENT WAS OBTAINED. ANYONE RECEIVING THIS DOCUMENT IS BOUND BY THE SAME CONFIDENTIALITY REQUIREMENTS AND MUST TAKE PRECAUTIONS TO PROTECT AGAINST ITS DISSEMINATION.


THE FAILURE TO OBSERVE THE CONFIDENTIALITY REQUIREMENTS OF THIS NOTICE SHALL SERVE AS THE BASIS FOR THE CITY OF CINCINNATI TO IMMEDIATELY SEEK LEGAL RECOURSE, INCLUDING THE RECOVERY OF ACTUAL DAMAGES RESULTING FROM UNAUTHORIZED ACCESS OR DISCLOSURE OF THE DOCUMENT.

EAST KEMPER ROAD

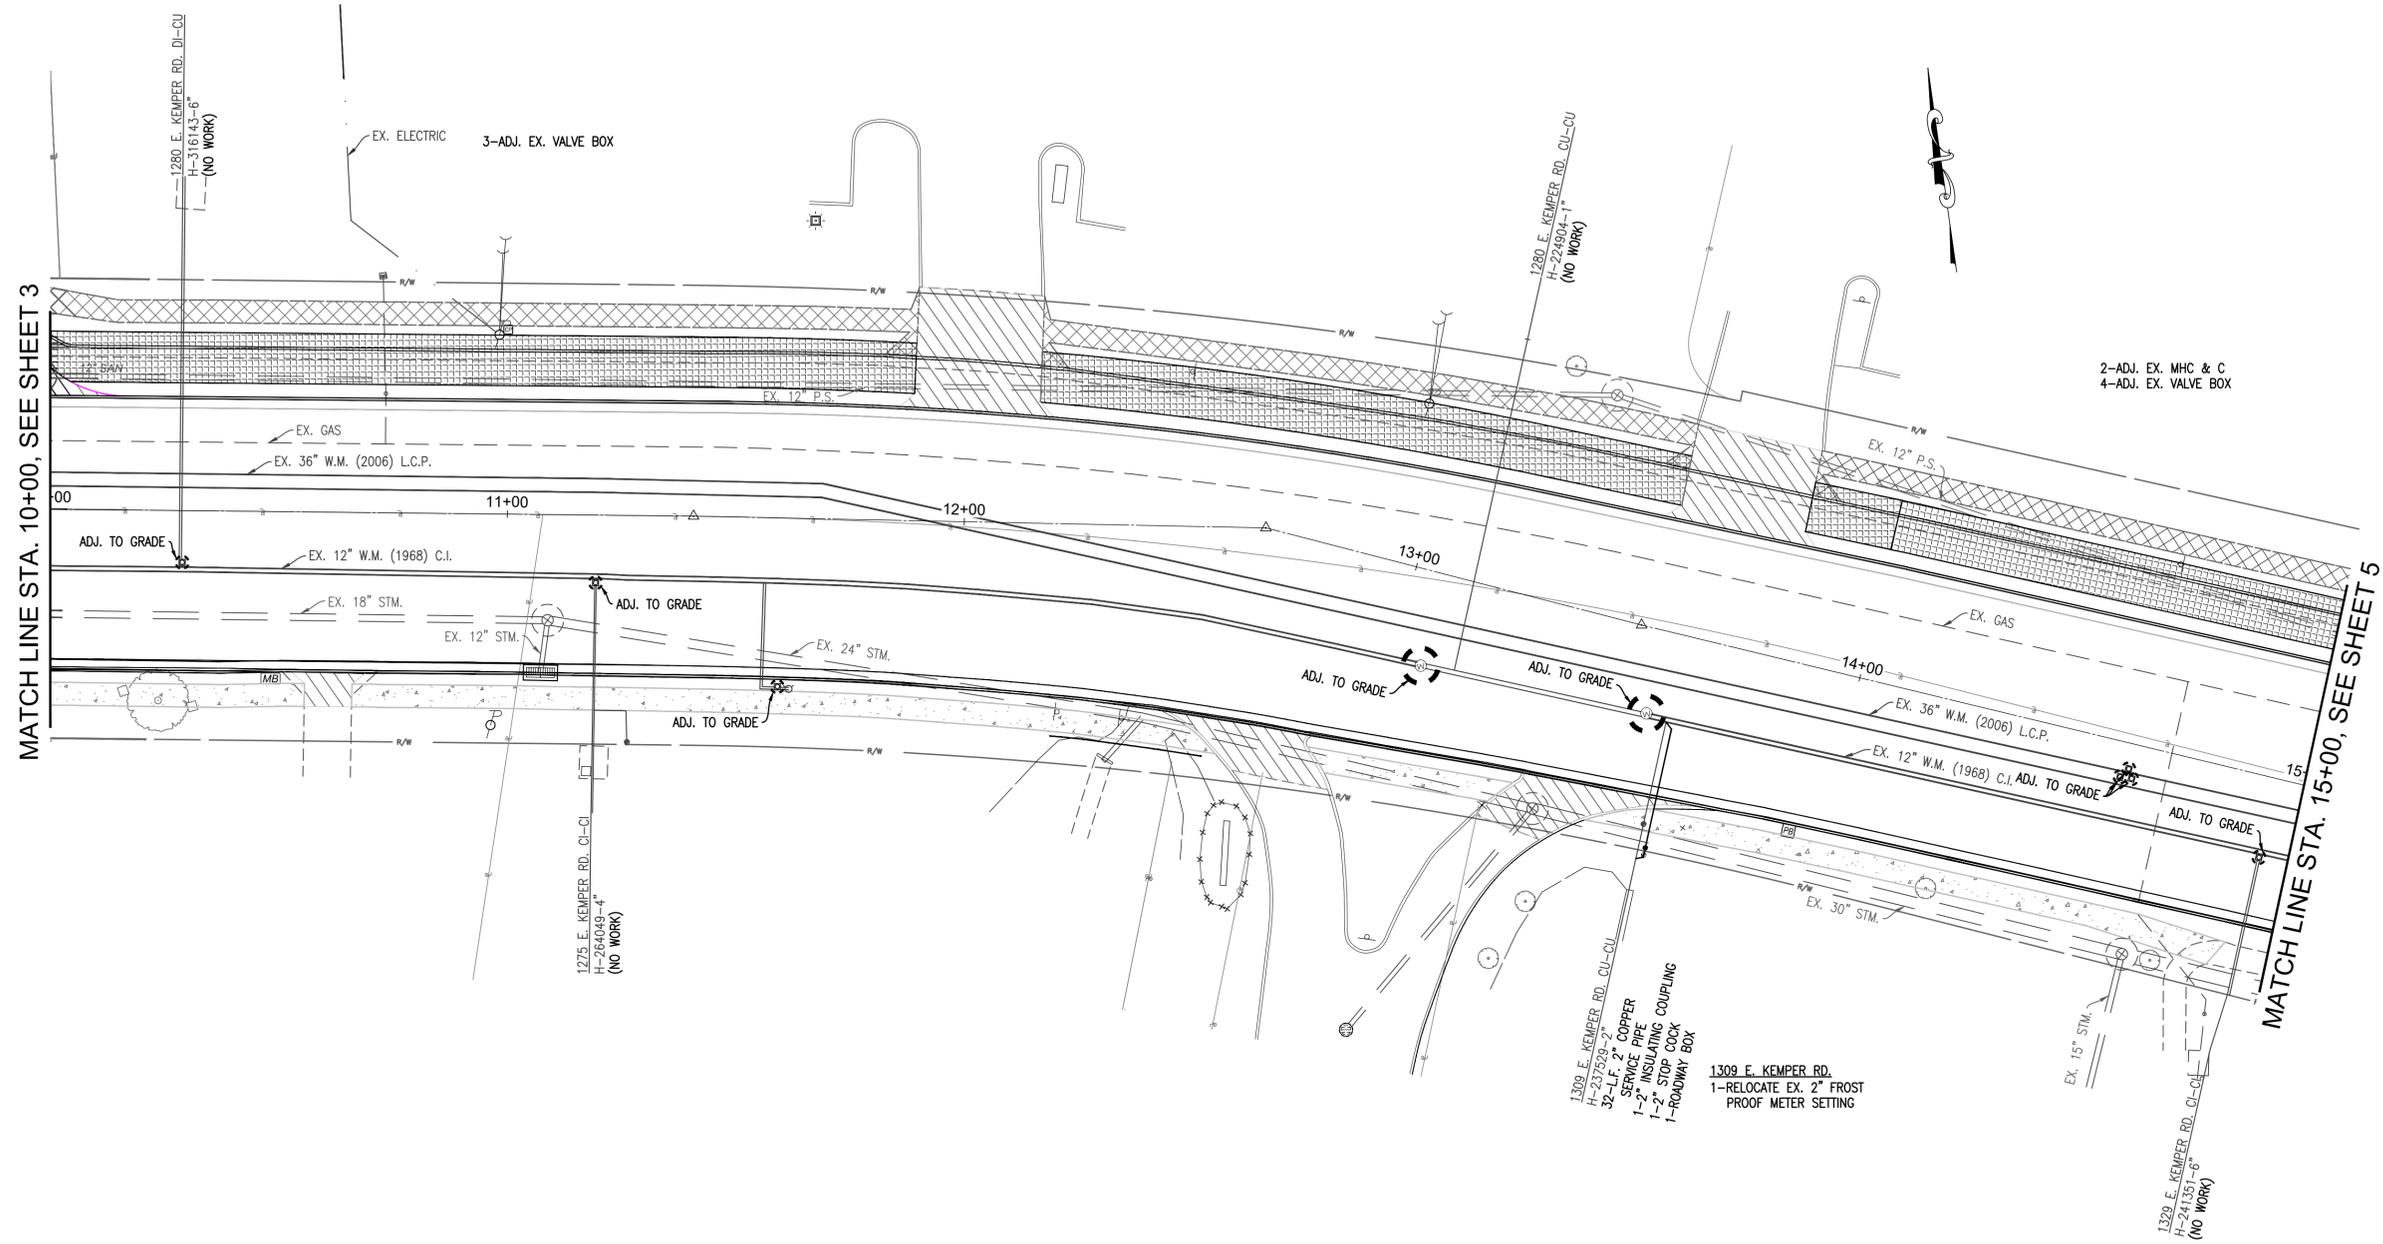

MATCH LINE STA. 10+00, SEE SHEET 3

MATCH LINE STA. 15+00, SEE SHEET 5

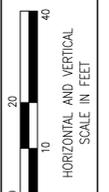

CALCULATED	MRD
REVISIONS	CHECKED
	EGG

GREATER CINCINNATI
WATER WORKS
 ENGINEERING DIVISION / DESIGN SECTION
 3845 EASTERN AVENUE, CINCINNATI, OHIO 45226



EAST KEMPER ROAD PLAN AND PROFILE

4-4201
 WW004784
 MF-17100

4
 5


EAST KEMPER RD. IMPROVEMENTS AND SHARED USE PATH STIMP

NOTICE OF CONFIDENTIALITY - PUBLIC INFRASTRUCTURE RECORD


THIS DOCUMENT IS A PUBLIC INFRASTRUCTURE RECORD OF THE CITY OF CINCINNATI AND ITS GREATER CINCINNATI WATER WORKS, AND IS NOT SUBJECT TO THE PUBLIC DISCLOSURE REQUIREMENTS OF THE PUBLIC RECORDS LAWS OF THE STATE OF OHIO AND FEDERAL GOVERNMENT. THIS DOCUMENT IS BEING PROVIDED ON THE BASIS OF YOUR REPORTED NEED, AND SHALL BE CONSIDERED CONFIDENTIAL. BY ACCEPTING THIS DOCUMENT, YOU AGREE THAT IT WILL NOT BE SHARED OR OTHERWISE DISCLOSED TO ANYONE OTHER THAN PERSONS WHO HAVE A DIRECT NEED TO KNOW FOR THE SOLE PURPOSE OF CARRYING OUT THE PROJECT FOR WHICH THIS DOCUMENT WAS OBTAINED. ANYONE RECEIVING THIS DOCUMENT IS BOUND BY THE SAME CONFIDENTIALITY REQUIREMENTS AND MUST TAKE PRECAUTIONS TO PROTECT AGAINST ITS DISSEMINATION.

THE FAILURE TO OBSERVE THE CONFIDENTIALITY REQUIREMENTS OF THIS NOTICE SHALL SERVE AS THE BASIS FOR THE CITY OF CINCINNATI TO IMMEDIATELY SEEK LEGAL RECOURSE, INCLUDING THE RECOVERY OF ACTUAL DAMAGES RESULTING FROM UNAUTHORIZED ACCESS OR DISCLOSURE OF THE DOCUMENT.

EAST KEMPER ROAD

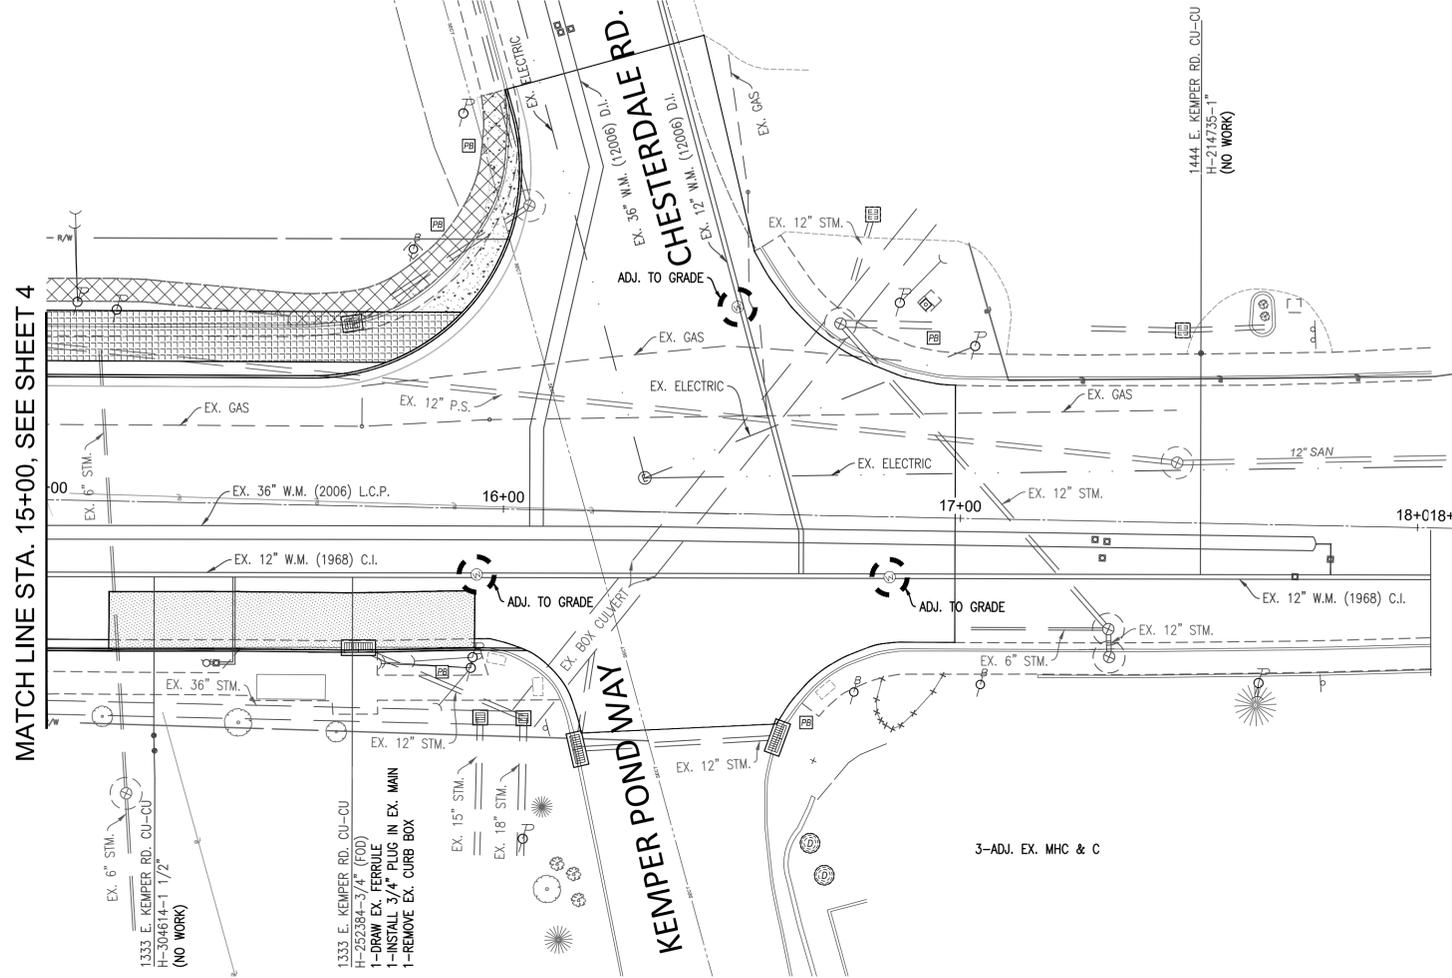

MATCH LINE STA. 15+00, SEE SHEET 4

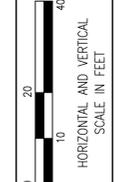

REVISIONS	CALCULATED
	MRD
	CHECKED
	EGG

GREATER CINCINNATI
WATER WORKS
ENGINEERING DIVISION / DESIGN SECTION
3845 EASTERN AVENUE, CINCINNATI, OHIO 45226



EAST KEMPER ROAD PLAN AND PROFILE

4-4201
WW004784
MF-17100

5
5

EAST KEMPER RD. IMPROVEMENTS AND SHARED USE PATH STIMP

NOTICE OF CONFIDENTIALITY - PUBLIC INFRASTRUCTURE RECORD

THIS DOCUMENT IS A PUBLIC INFRASTRUCTURE RECORD OF THE CITY OF CINCINNATI AND ITS GREATER CINCINNATI WATER WORKS, AND IS NOT SUBJECT TO THE PUBLIC DISCLOSURE REQUIREMENTS OF THE PUBLIC RECORDS LAWS OF THE STATE OF OHIO AND FEDERAL GOVERNMENT. THIS DOCUMENT IS BEING PROVIDED ON THE BASIS OF YOUR REPORTED NEED, AND SHALL BE CONSIDERED CONFIDENTIAL. BY ACCEPTING THIS DOCUMENT, YOU AGREE THAT IT WILL NOT BE SHARED OR OTHERWISE DISCLOSED TO ANYONE OTHER THAN PERSONS WHO HAVE A DIRECT NEED TO KNOW FOR THE SOLE PURPOSE OF CARRYING OUT THE PROJECT FOR WHICH THIS DOCUMENT WAS OBTAINED. ANYONE RECEIVING THIS DOCUMENT IS BOUND BY THE SAME CONFIDENTIALITY REQUIREMENTS AND MUST TAKE PRECAUTIONS TO PROTECT AGAINST ITS DISSEMINATION.

THE FAILURE TO OBSERVE THE CONFIDENTIALITY REQUIREMENTS OF THIS NOTICE SHALL SERVE AS THE BASIS FOR THE CITY OF CINCINNATI TO IMMEDIATELY SEEK LEGAL RECOURSE, INCLUDING THE RECOVERY OF ACTUAL DAMAGES RESULTING FROM UNAUTHORIZED ACCESS OR DISCLOSURE OF THE DOCUMENT.