THE VILLAGE OF ORWELL PENNIMAN ROAD PAVEMENT IMPROVEMENTS **ASHTABULA COUNTY, OHIO**

ADMINISTRATION:

KIMBERLY MCKINLEY

BERT CARLSON

SHANE GREGORY

FINANCE DIRECTOR

SENIOR ADMINISTRATIVE ASSISTANT/DEPUTY CLERK

STREET DEPARTMENT SUPERINTENDENT

COUNCIL MEMBERS:

CHRIS RUKS

DAVID HARTZ

JEREMY COTTRELL

BOB DENIHAM

ROBERTA COZAD

PRESIDENT OF COUNCIL

VICE PRESIDENT OF COUNCIL

COUNCIL MEMBER

COUNCIL MEMBER

COUNCIL MEMBER

OHIO 811 DESIGN SERIAL NUMBER & UTILITY LIST:

WATER/SANITARY SEWER VILLAGE OF ORWELL WATER & GAS CORP: SEWER DIVISION 179 W. MAIN STREET ORWELL, OHIO 44076 P.O. BOX 354 PHONE: 440-437-6459

STORM SEWER: VILLAGE OF ORWELL STREET DEPARTMENT 179 W. MAIN STREET ORWELL, OHIO 44076 P.O. BOX 354 PHONE: 440-321-0700


NORTHEAST OHIO NATURAL 8470 STATION STREET MENTOR, OHIO 44060 CONTACT: TIM REILLY PHONE: 440-701-5100 treilly@neogas.com

FIRST ENERGY CORP .: 76 S. MAIN STREET AKRON, OHIO 44308 PHONE: 800-633-4766


HANSON COMMUNICATIONS: 7820 DIVISION DRIVE WAPAKONETA, OHIO 45895 CONTACT: KEVIN WOLFE PHONE: 440-437-6117 Kevin.Wolfe@telserco.com




- 1. UNDERGROUND BUILDING SERVICE UTILITY LINES ARE NOT SHOWN ON THE PLANS. THE CONTRACTOR SHALL BE RESPONSIBLE FOR LOCATING, MAINTAINING AND REPLACING AS NECESSARY TO ENSURE CONTINUAL SERVICE TO BUILDINGS.
- 2. THE CONTRACTOR IS RESPONSIBLE TO CALL OHIO UTILITIES PROTECTION SERVICE @ 1-800-362-2764, THREE WORKING DAYS PRIOR TO CONSTRUCTION.

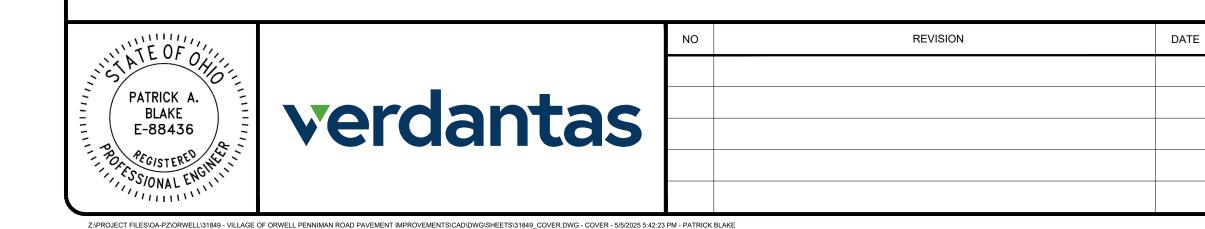


MAY 2025

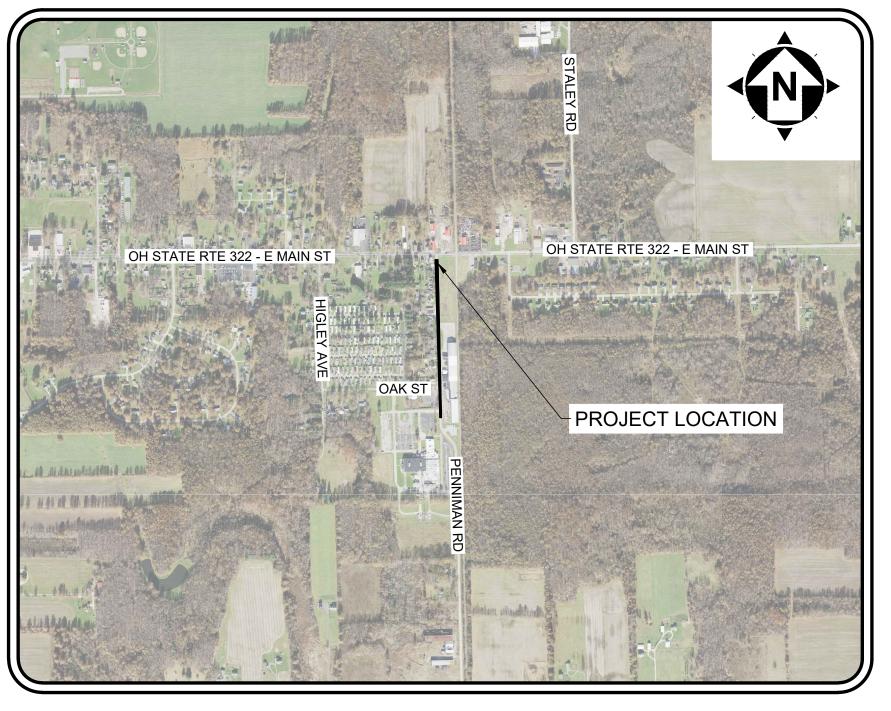

LOCATION MAP 1" = 1000'

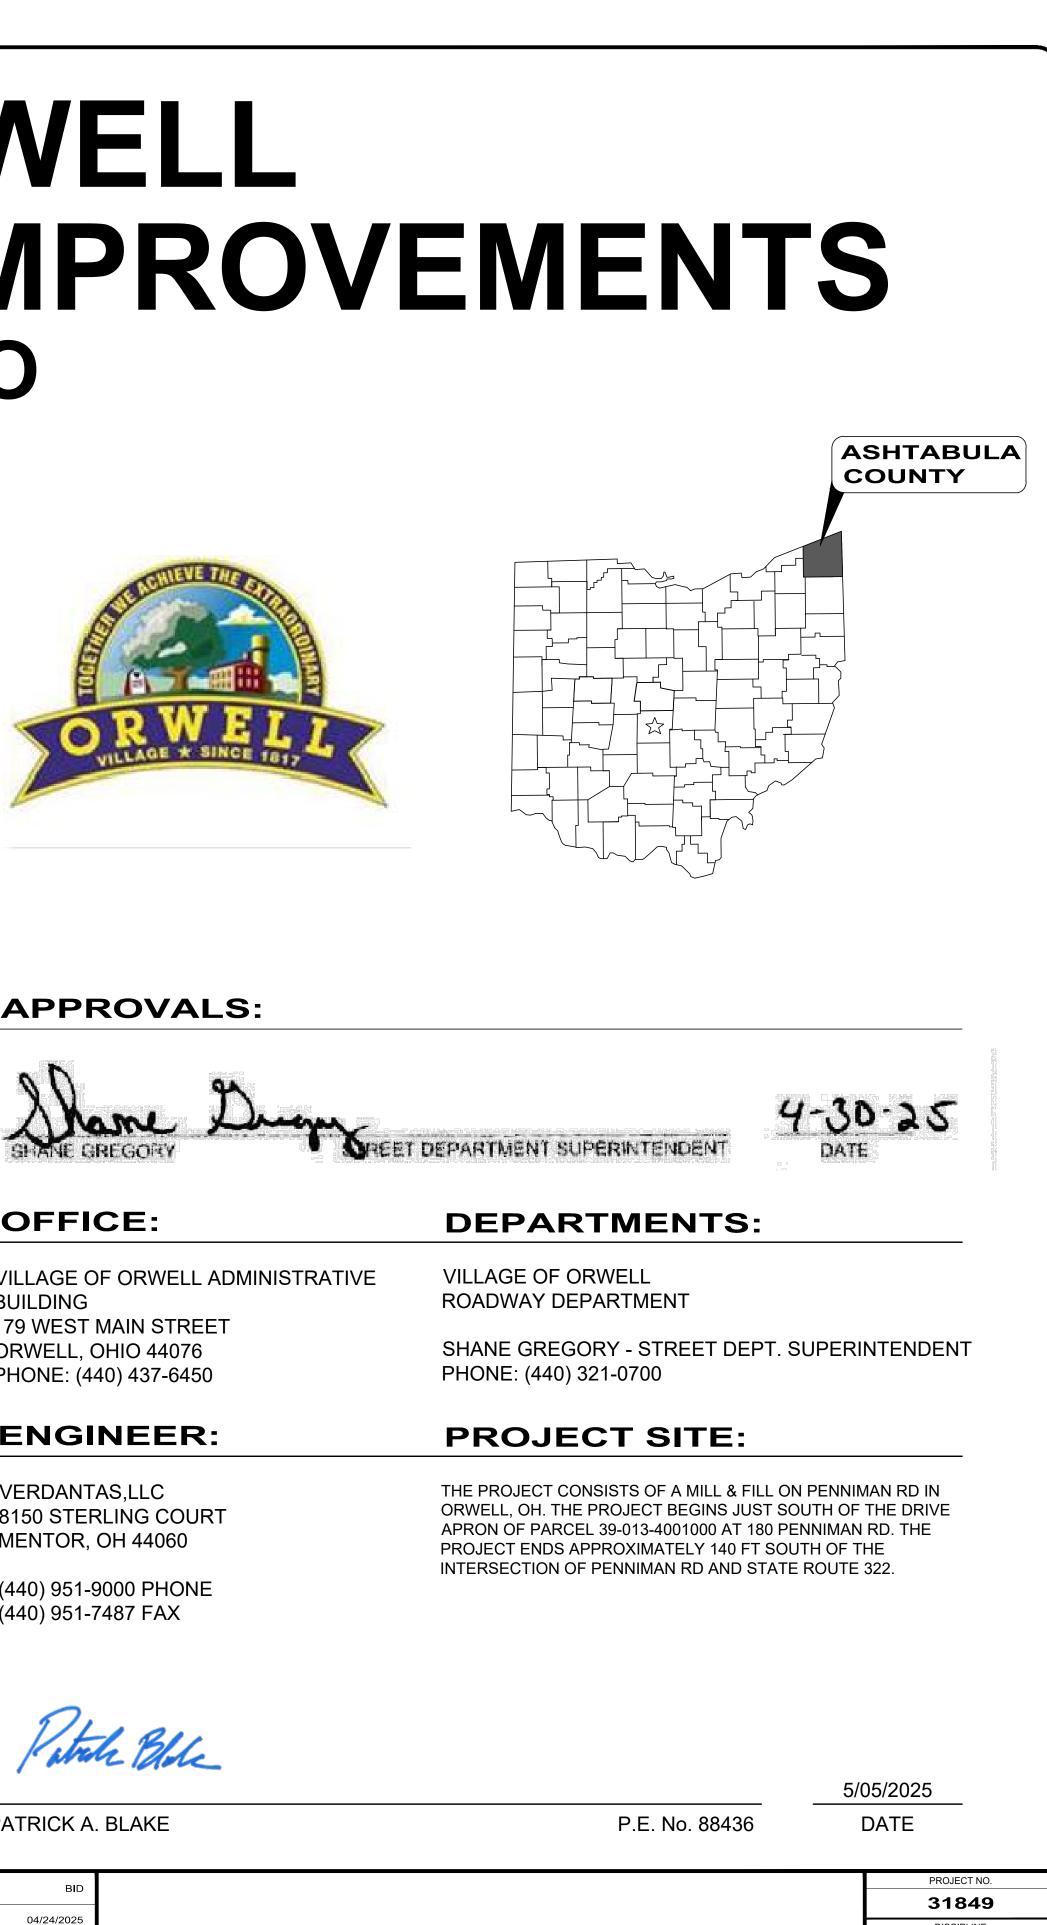



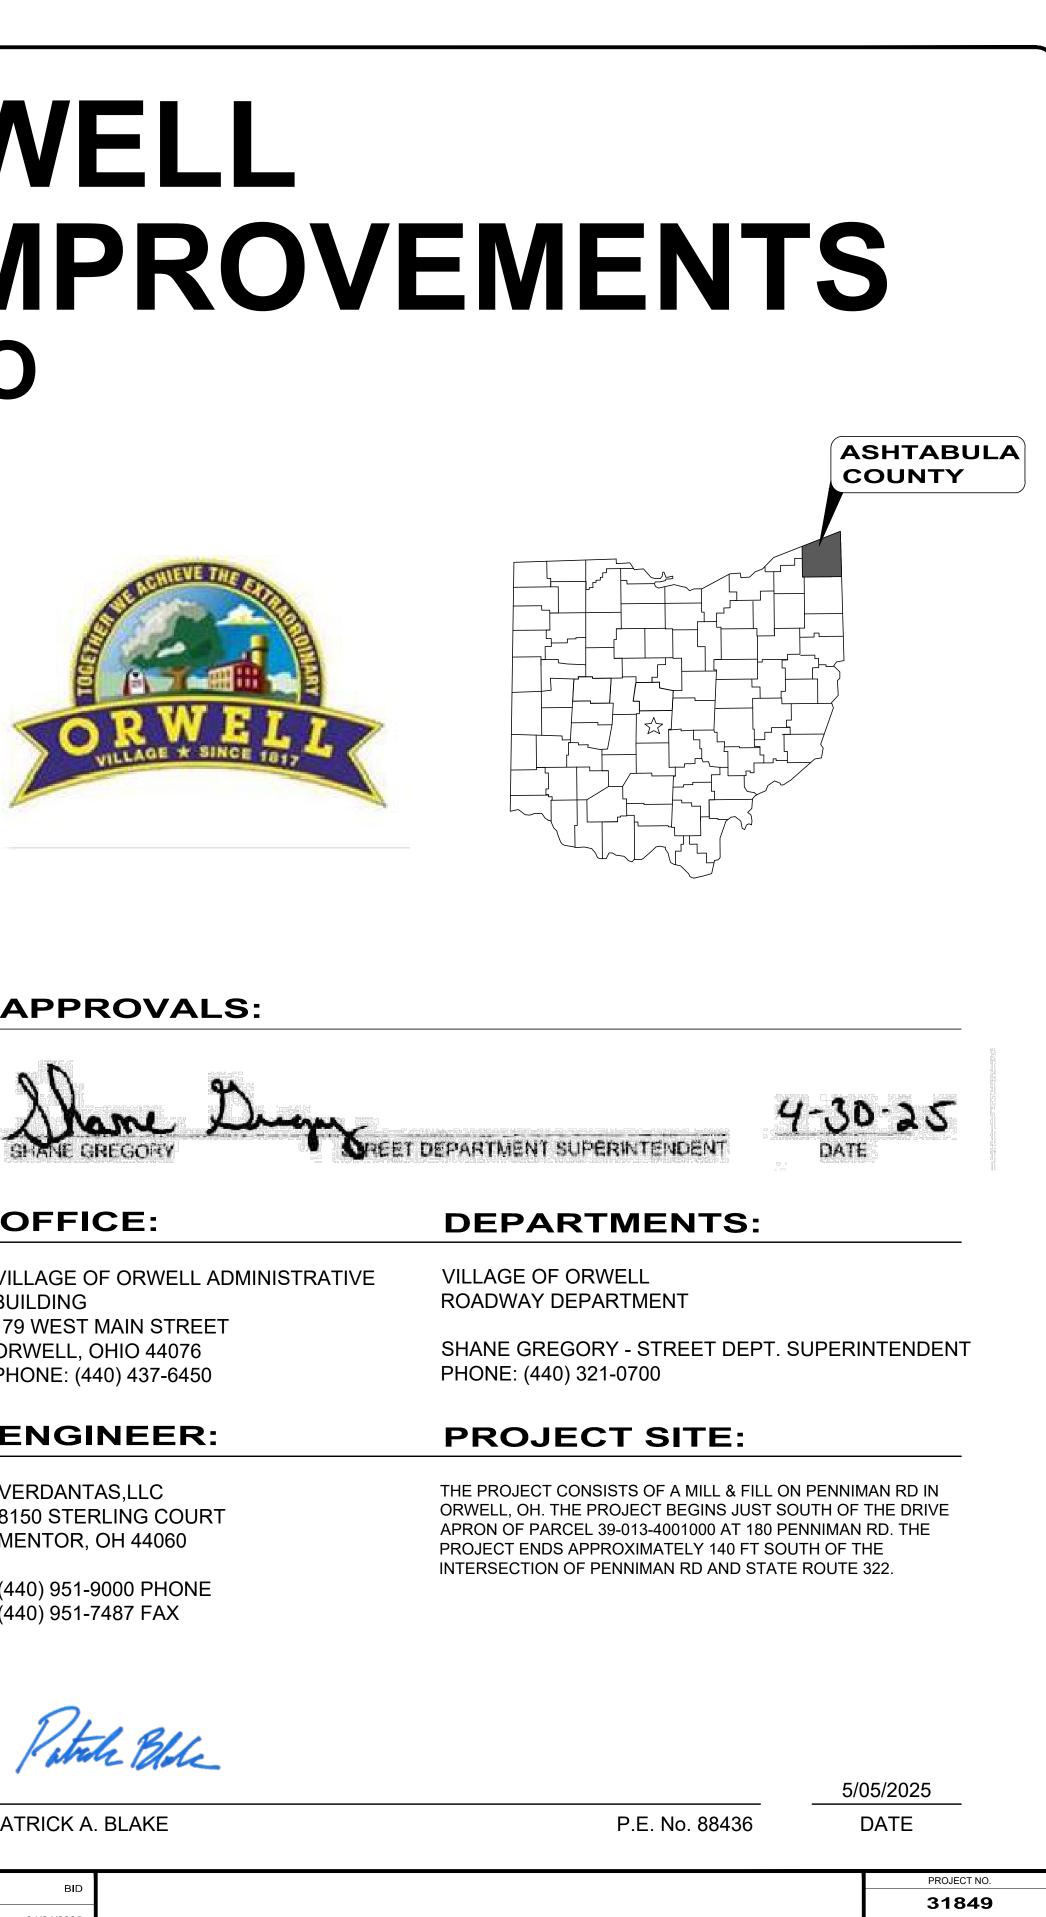

AS SHOWN

34x22"

SNK

PAB

ENGINEER'S PROJECT No. 31849

THE VILLAGE OF ORWELL

PENNIMAN ROAD PAVEMENT **IMPROVEMENTS**

ASHTABULA COUNTY

ORWELL, OH

CHECKED BY:

SCALE:

SHEET SIZE:

DESIGNED BY

DISCIPLINE CIVIL SHEET NAME COVER SHEET OF 6

GENERAL:

- A PRE-CONSTRUCTION CONFERENCE SCHEDULED BY THE ENGINEER SHALL BE HELD PRIOR TO ANY WORK STARTING. IN ADDITION, THE CONTRACTOR SHALL PROVIDE 48 HOURS NOTICE TO THE ENGINEER AND THE OWNER PRIOR TO BEGINNING WORK TO ARRANGE FOR INSPECTION.
- 2. THE CONTRACTOR SHALL BE RESPONSIBLE FOR ALL CONSTRUCTION STAKEOUT/LAYOUT AND SHALL NOTIFY THE ENGINEER, IN WRITING, OF ANY DISCREPANCIES.
- 3. NO WORK SHALL COMMENCE WITHOUT AN EXECUTED NOTICE TO PROCEED.
- 4. THE CONTRACTOR SHALL BE SOLELY RESPONSIBLE FOR COMPLYING WITH OSHA SAFETY REQUIREMENTS. THE CONTRACTOR SHALL BE RESPONSIBLE FOR THE SAFETY OF ALL VISITORS, EMPLOYEES AND WORKERS ON THE CONSTRUCTION SITE.
- 5. THE CONTRACTOR SHALL CONSTRUCT THIS PROJECT IN COMPLIANCE WITH FEDERAL, STATE AND LOCAL BUILDING CODES.
- 6. ALL EXCAVATIONS ARE TO BE SECURED AND PROTECTED AT ALL TIMES.
- 7. MANHOLES, CATCH BASINS, MONUMENT BOXES, WATER VALVE BOXES AND OTHER CASTINGS WITHIN THE ROADWAY AREA OF SHALL BE PROTECTED FROM CHIP SEAL AND FOG EMULSION MATERIAL PLACEMENT. PAYMENT FOR THIS WORK SHALL BE INCLUDED IN THE UNIT PRICE BID FOR OTHER ITEMS OF WORK EXCEPT WHEN BID AS A SEPARATE ITEM.
- 8. ALL SEDIMENT AND EROSION CONTROL PRACTICES SHALL BE THE SOLE RESPONSIBILITY OF THE CONTRACTOR AS PER ODOT ITEM 832.
- 9. ANY DISTURBED AREAS NOT SCHEDULED FOR CONSTRUCTION ACTIVITIES WITHIN SIXTY DAYS OF DISTURBANCE SHALL BE TEMPORARILY STABILIZED.
- 10. ALL POLLUTANTS OTHER THAN SEDIMENT THAT OCCUR ON-SITE DURING CONSTRUCTION SHALL BE HANDLED AND LEGALLY DISPOSED OF IN A MANNER THAT DOES NOT CAUSE CONTAMINATION OF STORM OR SURFACE WATERS. POLLUTANTS OF CONCERN INCLUDE, BUT ARE NOT LIMITED TO, FUELS, LUBRICANTS, SOLVENTS, CONCRETE BI-PRODUCTS AND CONSTRUCTION MATERIALS.
- 11. THE CONTRACTOR SHALL BE SOLELY RESPONSIBLE FOR THE SECURITY OF ALL STORED MATERIALS.
- 12. THE CONTRACTOR SHALL BE RESPONSIBLE FOR MAINTAINING A SET OF PROJECT RECORD DOCUMENTS. THESE DOCUMENTS SHALL INCLUDE REVIEWED SHOP DRAWINGS, CHANGE ORDERS, EQUIPMENT OPERATING INSTRUCTIONS, FIELD TEST RECORDS, AND AS BUILT DRAWINGS. THE AS BUILT DRAWINGS SHALL BE MARKED LEGIBLY IN RED WITH THE ACTUAL LOCATION OF EQUIPMENT AND CONDUITS AS CONSTRUCTED.

STANDARD SPECIFICATIONS:

THE "CONSTRUCTION AND MATERIAL SPECIFICATIONS" OF THE STATE OF OHIO DEPARTMENT OF TRANSPORTATION (ODOT), 2023 EDITION, CURRENT ODOT SUPPLEMENTAL SPECIFICATIONS, AND CURRENT ODOT STANDARD DRAWINGS SHALL GOVERN WORK AND MATERIALS WATER IS TO BE PROVIDED BY THE CONTRACTOR FOR USE AS DUST CONTROL, AS DIRECTED BY THE ENGINEER. NO SEPARATE PAYMENT WHICH ARE NOT SPECIFIED OR MODIFIED HEREIN OR ON THE PROJECT CONTRACT DRAWINGS. ALL REFERENCES TO "THE DEPARTMENT" WILL BE MADE. SHALL BE CHANGED TO "THE OWNER OR HIS REPRESENTATIVE." THE PROJECT CONTRACT DRAWINGS AND SPECIFICATIONS, IN THE EVENT OF A DISCREPANCY, SHALL SUPERSEDE THE ODOT SPECIFICATIONS.

EXISTING UTILITIES:

- THE CONTRACTOR SHALL VERIFY THE LOCATIONS OF ALL PUBLIC AND PRIVATE UTILITIES WHICH MAY BE AFFECTED BY THE OWNER CONSTRUCTION. THE LOCATION OF UTILITIES AND STRUCTURES, BOTH SURFACE AND SUBSURFACE, ARE SHOWN ON THE DRAWINGS FROM RECORD DATA AVAILABLE FROM THE VILLAGE AND ARE NOT NECESSARILY COMPLETE OR CORRECT. THE EXACT LOCATION AND 2. CONSTRUCTION EQUIPMENT WILL BE PROVIDED WITH INTAKE SILENCERS AND MUFFLERS, AS REQUIRED BY SAFETY STANDARDS. PROTECTION OF UTILITIES AND STRUCTURES ARE THE RESPONSIBILITY OF THE CONTRACTOR. CONTRACTOR TO CALL OUPS (1-800-362-2764) "48 HOURS BEFORE YOU DIG" AND CALL OIL & GAS PRODUCERS PROTECTIVE (1-800-925-0988). CONTRACTOR ALSO TO 3. PERIODICALLY CHECK EQUIPMENT AND MACHINERY FOR PROPER TUNING TO MINIMIZE EXHAUST EMISSIONS AND NOISE COORDINATE HIS WORK WITH THE UTILITIES LISTED ON THIS SHEET. NEITHER THE OWNER NOR THE ENGINEER ENSURES THEIR ACCURACY OR COMPLETENESS.
- 2. THE CONTRACTOR SHALL NOTIFY UTILITY COMPANIES AT LEAST THREE DAYS, EXCLUDING SATURDAYS, SUNDAYS AND LEGAL HOLIDAYS, PRIOR TO CONSTRUCTION TO HAVE UTILITIES STAKED, MARKED OR OTHERWISE DESIGNATED IN THE CONSTRUCTION AREA IN SUCH A MANNER; OR LOCATING SHALL BE COORDINATED TO STAY 48 HOURS AHEAD OF THE PLANNED CONSTRUCTION.
- IT WILL BE THE RESPONSIBILITY OF THE CONTRACTOR TO MAINTAIN SAFE LOCAL ACCESS, VEHICULAR AND PEDESTRIAN INCLUDING 3. CONTRACTOR SHALL VERIFY THE LOCATION AND ELEVATION OF ALL THE EXISTING UNDERGROUND UTILITIES PRIOR TO THE INSTALLATION PERSONS WITH DISABILITIES, TO ALL PROPERTIES WITHIN THE PROJECT LIMITS. THE CONTRACTOR WILL FURNISH, MAINTAIN AND OF ANY PROPOSED IMPROVEMENT INDICATED ON THE PLANS. SHOULD A CONFLICT EXIST AT A UTILITY CROSSING, THE CONTRACTOR SUBSEQUENTLY REMOVE ALL NECESSARY SAFEGUARDS SUCH AS BARRICADES, BARRIERS, TEMPORARY PAVEMENT, LIGHTING, SHALL NOTIFY THE PROJECT ENGINEER IMMEDIATELY. FLAGGERS, SIGNING, PAVEMENT MARKINGS AND OTHER TRAFFIC CONTROLS TO INSURE THE SAFETY OF PERSONS AND VEHICLES DURING CONSTRUCTION WITHIN THE PROJECT LIMITS. 4. IN THE EVENT OF DAMAGE TO EXISTING PUBLIC AND/OR PRIVATE UTILITIES, THE AGENCY CONCERNED SHALL BE NOTIFIED IMMEDIATELY
- AND ALL REPAIR WORK SHALL BE EXECUTED IN ACCORDANCE WITH THE SPECIFICATIONS OF THE RESPECTIVE AGENCY AT NO ADDITIONAL EXPENSE TO THE OWNER INCLUDING ANY INSPECTION FEES OR MAINTENANCE CREWS. CABLE RELOCATION AND SUPPORT COST SHALL BE INCLUDED IN OTHER BID ITEMS.
- 5. WHERE EXISTING POWER OR TELEPHONE POLES ARE IN CLOSE PROXIMITY TO WORK, THE CONTRACTOR SHALL COORDINATE HIS WORK 4. ALL WORK AND TRAFFIC CONTROL DEVICES SHALL BE IN ACCORDANCE WITH ITEM 614 AND OTHER APPLICABLE PORTIONS OF THE EFFORTS WITH THOSE OF THE UTILITY COMPANIES SUCH THAT THEIR EXISTING FACILITIES CAN BE MAINTAINED AND PROTECTED DURING SPECIFICATIONS, AS WELL AS THE OHIO MUTCD. PAYMENT FOR ALL LABOR, EQUIPMENT AND MATERIALS SHALL BE INCLUDED IN THE LUMP THE TIME WORK IS GOING ON ADJACENT TO THE POLE. THE COST FOR ANY REQUIRED PROTECTION OR RELOCATION OF EXISTING POWER OR TELEPHONE POLES SHALL BE THE RESPONSIBILITY OF THE CONTRACTOR AND NOT BE THE RESPONSIBILITY OF THE OWNER. SUM CONTRACT PRICE FOR ITEM 614, MAINTAINING TRAFFIC, UNLESS SEPARATELY ITEMIZED IN THE PLAN.
- DELAYS TO THE CONTRACTOR AS RESULT OF TIMING OF UTILITY RELOCATIONS OR PROTECTION SHALL NOT BE CONSIDERED COMPENSABLE DELAYS, AS IT SHALL BE THE CONTRACTOR'S RESPONSIBILITY TO COORDINATE HIS WORK WITH THE UTILITY COMPANY'S SCHEDULE.
- SHOULD IT BECOME NECESSARY TO CHANGE THE POSITION OR TEMPORARILY REMOVE ANY STORM DRAIN, SANITARY SEWER, ELECTRIC CONDUITS, WATER PIPES, GAS PIPES, PROCESS OR OTHER PIPES OR WIRES IN ORDER TO PERMIT THE CONTRACTOR TO USE A PARTICULAR METHOD OF CONSTRUCTION OR IN ORDER TO CLEAR THE STRUCTURES BEING BUILT, THE CONTRACTOR SHALL NOTIFY THE ENGINEER OF THE LOCATION AND CIRCUMSTANCES AND SHALL CEASE WORK, IF NECESSARY, UNTIL SATISFACTORY ARRANGEMENTS HAVE BEEN MADE BY THE OWNERS OF SAID PIPES OR WIRES TO PROPERLY CARE FOR THE SAME. NO CLAIMS FOR DAMAGES WILL BE ALLOWED ON ACCOUNT OF ANY DELAY OCCASIONED THEREBY. THE ENTIRE COST OF THE CHANGES OR TEMPORARY REMOVAL MUST BE INCLUDED IN THE PRICES STIPULATED FOR THE VARIOUS ITEMS OF WORK TO BE DONE UNDER THIS CONTRACT.
- CONTRACTOR IS RESPONSIBLE FOR THE PRESERVATION OF ALL FENCES, RETAINING WALLS, STEPS, UTILITY POLES, MONUMENTS, UTILITY APPURTENANCES, SIGNAGE AND LANDSCAPE BEDS. IF DAMAGED, THE CONTRACTOR IS RESPONSIBLE FOR THE REPLACEMENT OF THESE ITEMS AT NO ADDITIONAL COST TO THE OWNER.

MATERIAL TESTING AND PERMITS:

1. THE CONTRACTOR SHALL BE RESPONSIBLE FOR THE COST OF ALL MATERIAL AND EQUIPMENT TESTING. THE CONTRACTOR SHALL BE RESPONSIBLE FOR OBTAINING ALL PERMITS REQUIRED FOR THIS PROJECT. THE EXECUTED PROJECT CONTRACT SHALL SERVE TO FULFILL THE VILLAGE OF ORWELL'S PERMITTING REQUIREMENTS.

N'TE OF ALL		NO	REVISION DATE	THE VILLAGE OF ORWELL		ISSUED FOR:	BID	
PATRICK A. BLAKE E-88436						ISSUE DATE:	04/24/2025	
			PENNIMAN ROAD PAVEMENT IMPROVEMENTS		SCALE:	AS SHOWN		
					SHEET SIZE:	34x22"		
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MATERIAL DISPOSAL AND TEMPORARY SURFACES:

- 1. THE REMOVAL AND DISPOSAL OF ALL SURPLUS CONSTRUCTION DEBRIS SHALL BE THE RESPONSIBILITY OF THE CONTRACTOR FOR ULTIMATE DISPOSAL.
- 2. THE COST OF HEREIN DESCRIBED WORK, INCLUDING SEEDING AND MULCHING NECESSARY TO SECURE THESE RESULTS, SHALL BE CONSIDERED INCIDENTAL TO THE OTHER VARIOUS ITEMS OF WORK IN THIS CONTRACT AND INCLUDED IN THE RESPECTIVE PAY ITEMS. NO SEPARATE PAYMENT SHALL BE MADE.
- 3. TEMPORARY SURFACES WHERE EXCAVATION ARE LOCATED IN STREETS, DRIVES AND PARKING AREAS SHALL BE FURNISHED AND PLACED BY THE CONTRACTOR AND SHALL BE FULLY MAINTAINED TO MINIMIZE INCONVENIENCE TO THE PUBLIC AT NO ADDITIONAL COST TO THE OWNER
- 4. THE ABOVE DESCRIBED WORK SHALL BE CONSIDERED INCIDENTAL TO THE COMPLETION OF ALL WORK AND INCLUDED IN THE RESPECTIVE PAY ITEMS AND SHALL NOT BE A SEPARATE PAY ITEM.
- 5. DUMP SITES MUST BE APPROVED BY THE OWNER.

USE OF PRIVATE PROPERTY:

1. THE CONTRACTOR CAN USE PRIVATE PROPERTY FOR THE STORAGE OF EQUIPMENT AND MATERIALS ONLY WITH A WRITTEN AGREEMENT WITH THE PROPERTY OWNER. THE CONTRACTOR SHALL PROVIDE THIS AGREEMENT TO THE ENGINEER PRIOR TO ANY USE OF PRIVATE PROPERTY.

RESTORATION:

- CONTRACTOR SHALL RESTORE ANY DISTURBED AREAS CAUSED FROM CONSTRUCTION TO PRE-CONSTRUCTION CONDITIONS OR BETTER OR AS PER PLAN. FOR DISTURBED LAWN AREAS, THE CONTRACTOR SHALL INSTALL COMPACTED, SCREENED, IMPORTED TOPSOIL TO PROVIDE A SMOOTH TRANSITION FROM NEW OR EXISTING CURB OR SIDEWALK SURFACES TO THE NON-PAVED SURFACE.
- 2. THE COMPOSITION OF SEED MIXTURE SHALL CONFORM TO THE ODOT CMS STANDARDS FOR SEEDING.

DUST CONTROL:

NOISE CONTROL PRACTICES:

1. CONSTRUCTION ACTIVITIES WILL BE LIMITED TO WEEKDAY DAYTIME HOURS (7:00AM TO 5:00PM), UNLESS APPROVED IN ADVANCE BY THE

TRAFFIC MAINTENANCE:

- MAINTAINING TRAFFIC SHALL BE IN ACCORDANCE WITH ODOT ITEM 614 AND THE OHIO MANUAL OF UNIFORM TRAFFIC CONTROL DEVICES (OMUTCD).
- AT ALL EXCAVATION LOCATIONS THE CONTRACTOR SHALL PROVIDE SUITABLE FLASHERS, BARRICADES, AND TRAFFIC CONTROL DEVICES AS DEEMED NECESSARY BY THE ENGINEER AND IN ACCORDANCE WITH THE MUTCH. SUCH TIME AS THE AREA IS COMPLETELY BACKFILLED.

MONUMENTS, PROPERTY CORNERS AND BENCHMARKS:

1. MONUMENTS, PROPERTY CORNER MARKERS AND BENCHMARKS SHALL NOT BE DISTURBED BY THE CONTRACTOR. IN THE EVENT THAT IT IS NECESSARY TO REMOVE MONUMENTS, PROPERTY CORNER MARKERS OR BENCHMARKS FOR THE CONSTRUCTION OF THE WORK, THE CONTRACTOR SHALL HAVE A REGISTERED LAND SURVEYOR PROPERLY REFERENCE THE POINTS AND SHALL HAVE SAME RESET AFTER THE CONSTRUCTION HAS PASSED THE AREA, AT NO ADDITIONAL COST TO THE OWNER.

ITEM SPECIFICATIONS

- 1. CONTINGENCY ITEM 253 PAVEMENT REPAIR, AS PER PLAN HAS BEEN ADDED AS A FULL DEPTH PAVEMENT REPAIR AS DIRECTED ITEM. THIS SHOULD ONLY BE COMPLETED AT THE DIRECTION OF THE ENGINEER AFTER PAVEMENT PLANING HAS OCCURRED.
- 2. ITEM 251 PARTIAL DEPTH PAVEMENT REPAIR, AS PER PLAN WILL BE MARKED BY THE ENGINEER/VILLAGE AFTER PAVEMENT PLANING HAS OCCURRED.

PROHIBITED CONSTRUCTION ACTIVITIES:

- 3.
- 4. OPEN BURNING OF PROJECT DEBRIS WITHOUT A PERMIT.

- - OF RESIDENCE: OR

SHEET LIST					
SHEET NUMBER	SHEET NAME				
1	COVER SHEET				
2	GENERAL NOTES				
3-4	PLAN				
5	MAINTENANCE OF TRAFFIC				
6	CONSTRUCTION DETAILS				

1. THE USE OF EXPLOSIVES, UNLESS A PERMIT IS ISSUED BY THE OWNER.

2. PUMPING OF SEDIMENT-LADEN WATER FROM TRENCHES OR OTHER EXCAVATIONS DIRECTLY INTO ANY SURFACE WATERS, STREAM CORRIDORS, OR STORM SEWERS; ALL SUCH WATER WILL BE PROPERLY FILTERED OR SETTLED TO REMOVE SILT PRIOR TO RELEASE.

DISCHARGING POLLUTANTS SUCH AS CHEMICALS, FUELS, LUBRICANTS, BITUMINOUS MATERIALS, RAW SEWAGE, OR ANY OTHER HARMFUL WASTE INTO OR ALONGSIDE OF RIVERS, STREAMS, IMPOUNDMENTS OR INTO NATURAL OR MAN-MADE CHANNELS LEADING THERETO.

5. STORING CONSTRUCTION EQUIPMENT AND VEHICLES AND/OR STOCKPILING CONSTRUCTION MATERIALS ON PROPERTY, PUBLIC OR PRIVATE, NOT PREVIOUSLY SPECIFIED ON THE PLANS BY THE ENGINEER FOR SUCH PURPOSES.

6. RUNNING WELL POINT OR PUMP DISCHARGE LINES THROUGH PRIVATE OR PUBLIC PROPERTY AND RIGHTS-OF-WAY WITHOUT PERMISSION OF THE PROPERTY OWNER AND THE CONSENT OF THE ENGINEER.

OPERATION ENTAILING THE USE OF VIBRATORY HAMMERS OR COMPACTORS OUTSIDE THE HOURS OF 8:00 AM AND 5:00 PM OR OUTSIDE THE HOURS ALLOWED BY LOCAL ORDINANCES OR REGULATIONS.


8. CLOSING OFF CLEAR ACCESS TO ANY PUBLIC ALLEY, STREET, ROAD, AVENUE OR BOULEVARD WITHOUT THE PRIOR CONSENT OF MUNICIPAL OFFICIALS AND THE ENGINEER AND CLOSING CLEAR ACCESS:

BY FIRE PROTECTION EQUIPMENT AND EMERGENCY VEHICLES;

BY THE PUBLIC TO ANY COMMERCIAL OR PROFESSIONAL PLACE OF BUSINESS, QUASI-PUBLIC OR PUBLIC ESTABLISHMENT, OR PLACE

BY VEHICLES TO DRIVEWAYS WITHOUT THE PROVISION OF ALTERNATIVE MEANS OF BUILDING INGRESS AND EGRESS.


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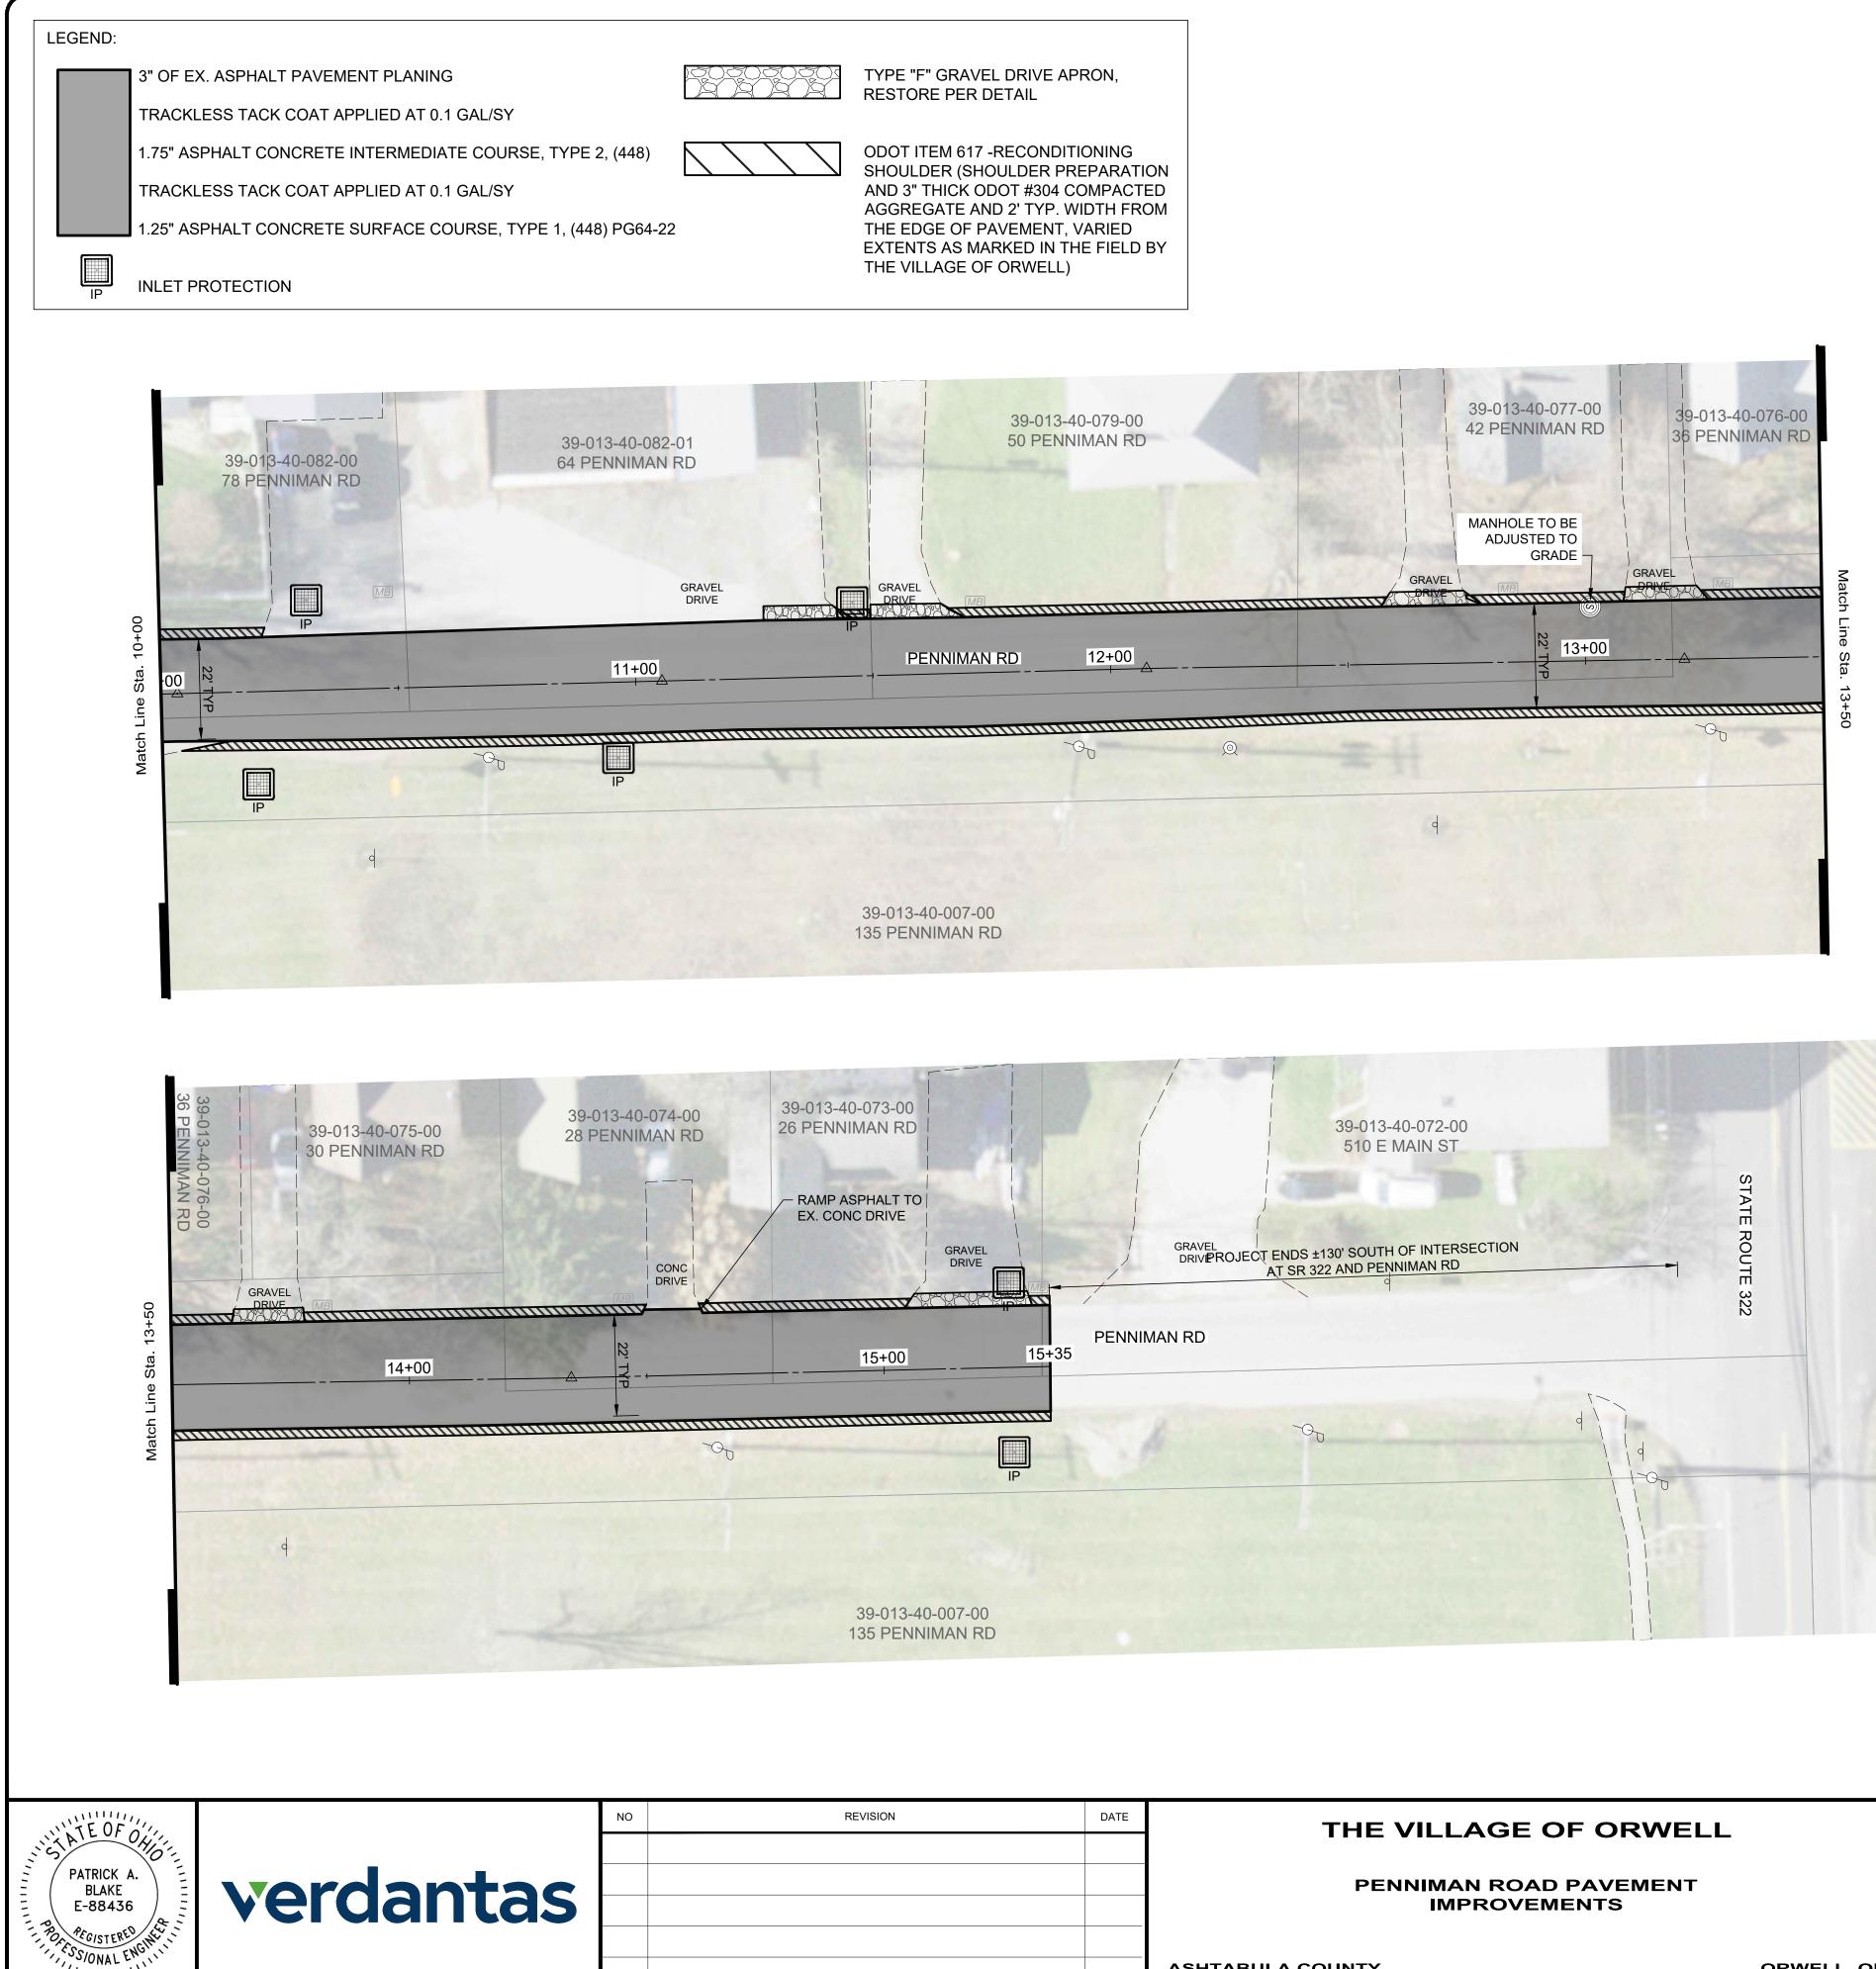
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DATE	THE VILLAGE OF ORWELL		ISSUED FOR:	BID	
				04/24/2025	
	PENNIMAN ROAD PAVEMENT		SCALE:	AS SHOWN	
	IMPROVEMENTS		SHEET SIZE:	34x22"	
			DESIGNED BY:	SNK	
	ASHTABULA COUNTY	ORWELL, OH	CHECKED BY:	PAB	

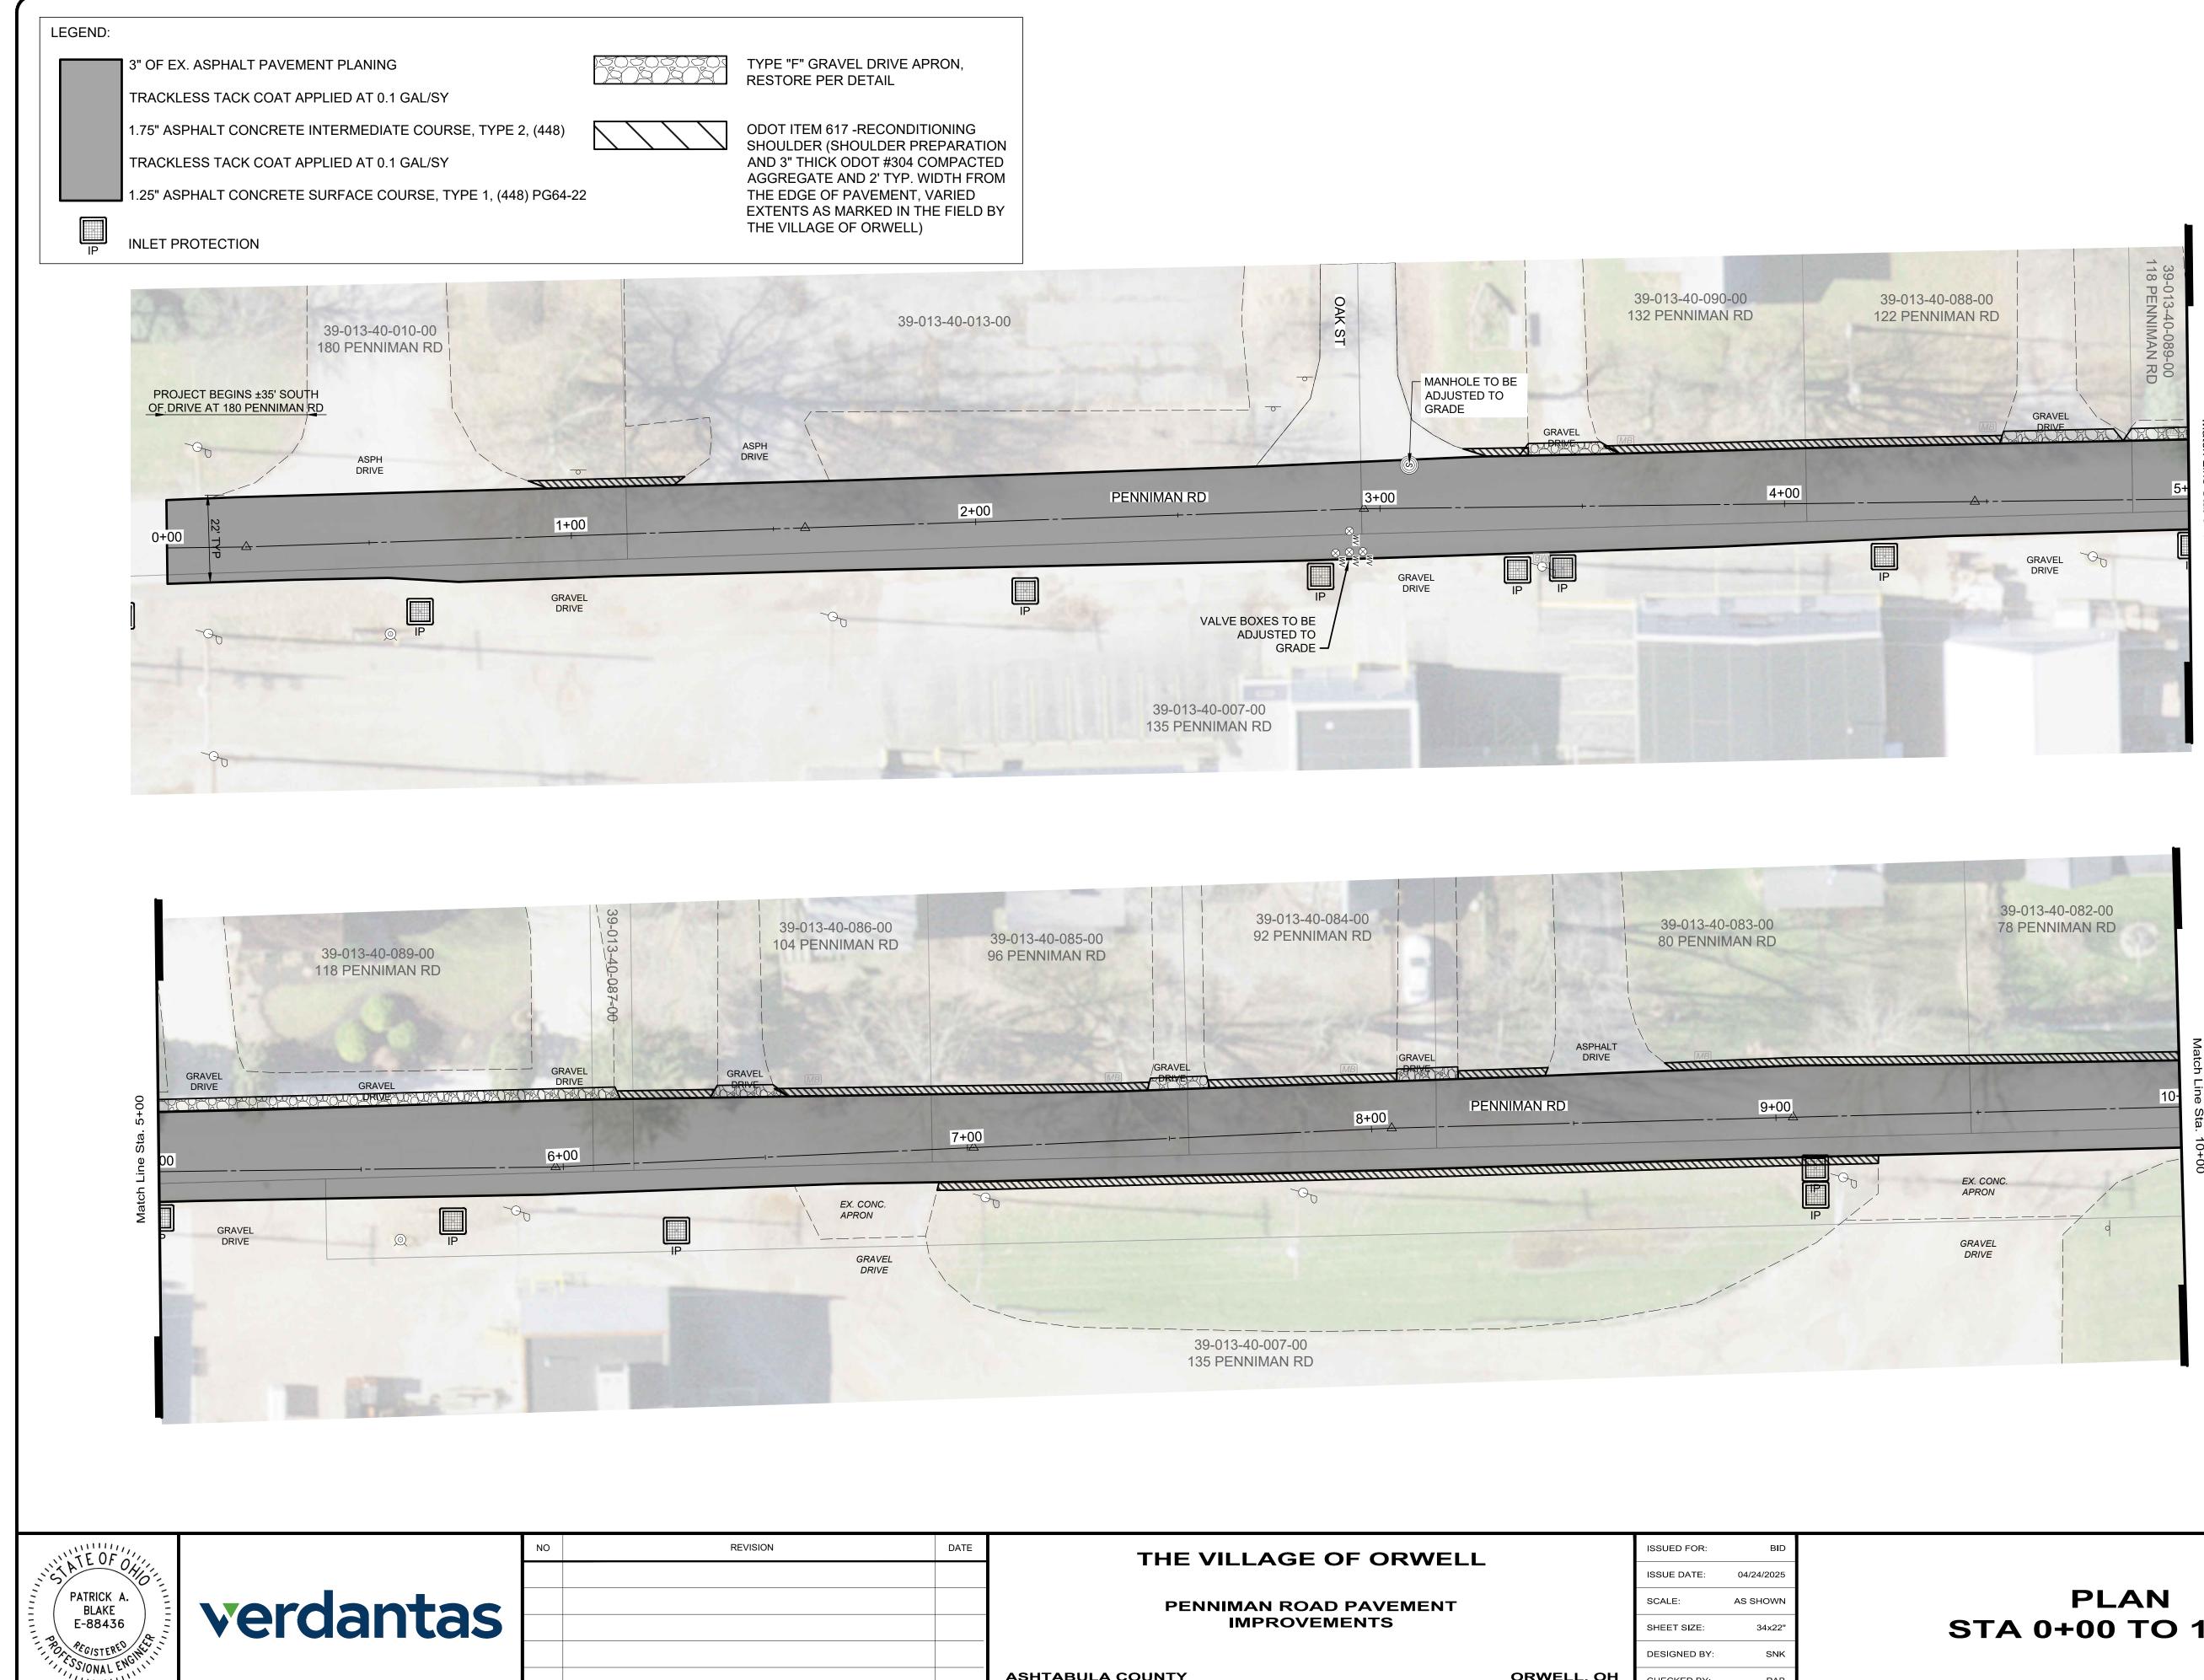

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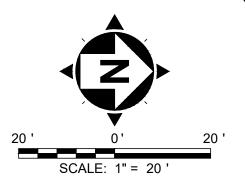
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DATE	THE VILLAGE OF ORWELL		ISSUED FOR:	BID	
				04/24/2025	
	PENNIMAN ROAD PAVEMENT IMPROVEMENTS		SCALE:	AS SHOWN	
			SHEET SIZE:	34x22"	
			DESIGNED BY:	SNK	
	ASHTABULA COUNTY	ORWELL, OH	CHECKED BY:	PAB	

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PENNIMAN RD	-07	Е 322

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PLAN		
STA 10+00 TO END		T NAME -2
	SHEET 4	OF 6

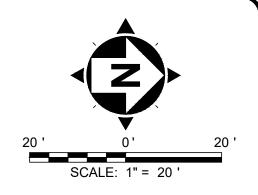

NOTES:

FLAGGERS

1. Flaggers, one for each direction, shall be used to control traffic continuously for as long as a one lane operation is in effect. The flaggers shall be able to communicate with each other at all times.

LENGTH OF CLOSURE

2. It is required that the length of closure be kept to a minimum at all times, as directed by the Engineer, with a maximum allowable length of 5000'.

When the ambient temperature exceeds 80 degrees Fahrenheit the Engine'er may increase the maximum allowable length of closure to allow for sufficient cooling of new pavement.

The Engineer may shorten the maximum allowable length of closure to relieve excessive traffic backups or to improve traffic operation.

SIGN LOCATION AND SPACING

- 3A. The minimum spacing between work zone signs is shown in Table I. Maximum spacing should not be greater than 1.5 times the distances shown in Table I.
- 3B. Sign spacing should be adjusted to avoid conflict with existing signs. Minimum spacing to existing signs shall be 200' for speeds of 45 mph or less and a minimum of 400' for speeds of 50 mph or greater.
- 3C. The location of the advance warning signs should be adjusted to provide for adequate sight distance for the existing vertical and horizontal roadway aliqnment.

ADJUSTMENTS FOR SIGHT DISTANCE


4. The location of the flagger station and the advance warning signs should be adjusted to provide for adequate sight distance for the existing vertical and horizontal roadway alignment.

BASIC SIGNING

- 5A. ROAD WORK AHEAD (W20-1) signs shall be provided on entrance ramps or roadways entering the work limits.
- 5B. END ROAD WORK (G20-2) signs are only required for lane closures of more than 1 day. It is intended that these signs be placed on the mainline, on all exit ramps, and on roadways exiting the work limits.
- 5C. Overlapping of signing for adjacent projects should be avoided where the messages could be confusing. Any ROAD WORK AHEAD or END ROAD WORK sign which falls within the limits of another traffic control zone shall be omitted or covered during the period when both projects are active.

SIGNING DETAILS

- 6A. The Advisory Speed (W13-1P) plaque shall be used when specified in the plan.
- 6B. 36" warning signs may be used when the approach speed limit is 40 mph or less.

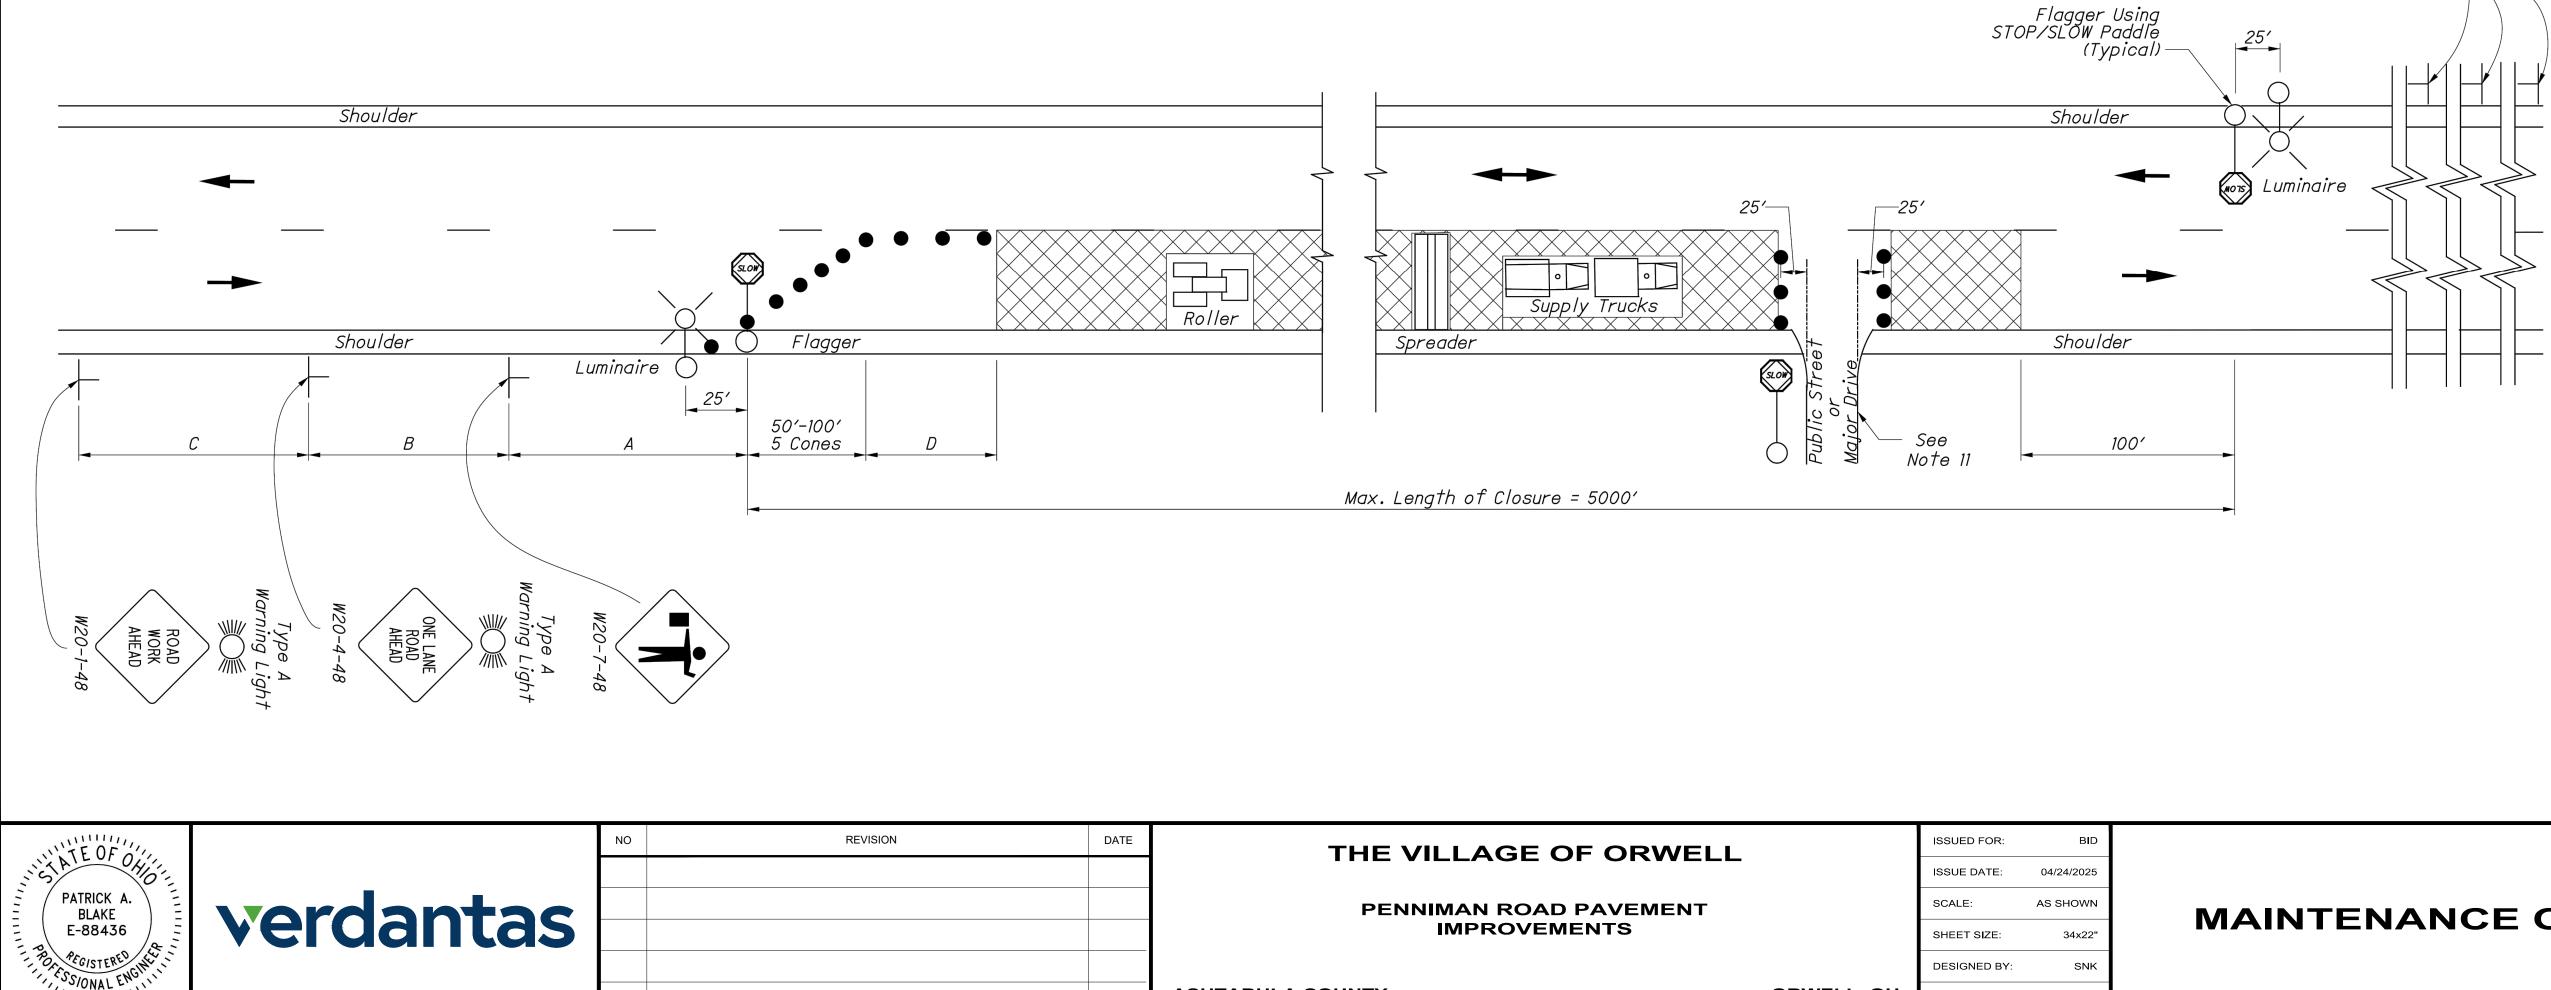

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FLASHING WARNING LIGHTS

7. Type A flashing warning lights shown on the ROAD WORK AHEAD (WŽO-1) signs and on the LANE CLOSED AHEAD (W20-5) signs are required whenever a night lane closure is necessary.

CONES

- 8A. Cone spacing shall be as follows:
- a) Spacing along the buffer shall be 40' center-to-
- center. b) Spacing along the approach taper shall be 10' centerto-center.
- 8B. Cone sizes shall be as follows:
 - a) Cones used for daytime traffic control shall have a minimum height of 28". b) Cones used for nighttime traffic control shall have a minimum height of 42".
- 8C. Provisions shall be made to stabilize the cones to
- prevent them from blowing over.
- 8D. A minimum of two cones shall be used to close the pavea shoulder.

(RESERVED FOR FUTURE USE)

9A. (intentionally blank)

AREA ILLUMINATION

- 10A. Adequate area illumination of each flagger station shall be provided at night. Use of portable flood lighting is acceptable.
- 10B. To ensure the adequacy of floodlight placement and the elimination of glare, the Contractor and the Engineer shall drive through the worksite each night when the lighting is in place. Light placement and shielding shall be adjusted to the satisfaction of the Engineer.

INTERSECTION / DRIVEWAY ACCESS

- 11. Within the length of closure, provision shall be made to control traffic entering from intersecting streets and major drives as necessary to prevent wrong-way movements and to keep vehicles off of new pavement not ready for traffic. The Contractor shall:
 - a) Place across the closed lane, either three cones or barricades, and/or
 - intersection and major driveway.

Cones placed across the closed lane shall be located 25' beyond the projected pavement edges of the driveway or cross highway. For barricades, see Standard Construction Drawing MT-101.60.

Existing STOP signs shall be relocated as necessary to assure proper location for the traffic conditions.

The method of control shall be subject to the approval of the Engineer.

CHIP SEAL OPERATION

12. For chip seal operations, additional signing shall be incorporated in accordance with CMS 422.09.

Same as Opposite Approach

DATE	THE VILLAGE OF ORWELL		ISSUED FOR:	BID	
			ISSUE DATE:	04/24/2025	
	PENNIMAN ROAD PAVEMENT		SCALE:	AS SHOWN	ΜΑΙ
	IMPROVEMENTS		SHEET SIZE:	34x22"	
			DESIGNED BY:	SNK	
	ASHTABULA COUNTY	ORWELL, OH	CHECKED BY:	PAB	

b) Provide an additional flagger at every public street


TABLE I (SIGN SPACING)						
ROAD TYPE	DISTANCE	DISTANCE BETWEEN SIGNS (FT)				
	А	В	С			
Two Lane ≤ 40 MPH	100	100	100			
Two Lane 45-50 MPH	350	350	350			
Two Lane 55-60 MPH	500	500	500			

TABLE II						
SPEED LIMIT (MPH)	BUFFER (D) (FT) MIN.					
25	155					
30	200					
35	250					
40	305					
45	360					
50	425					
55	495					
60	570					

LEGEND

WORK AREA	
CONES	• • •
DIRECTION OF TR	AVEL

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	31849	
	PROJECT NO.	

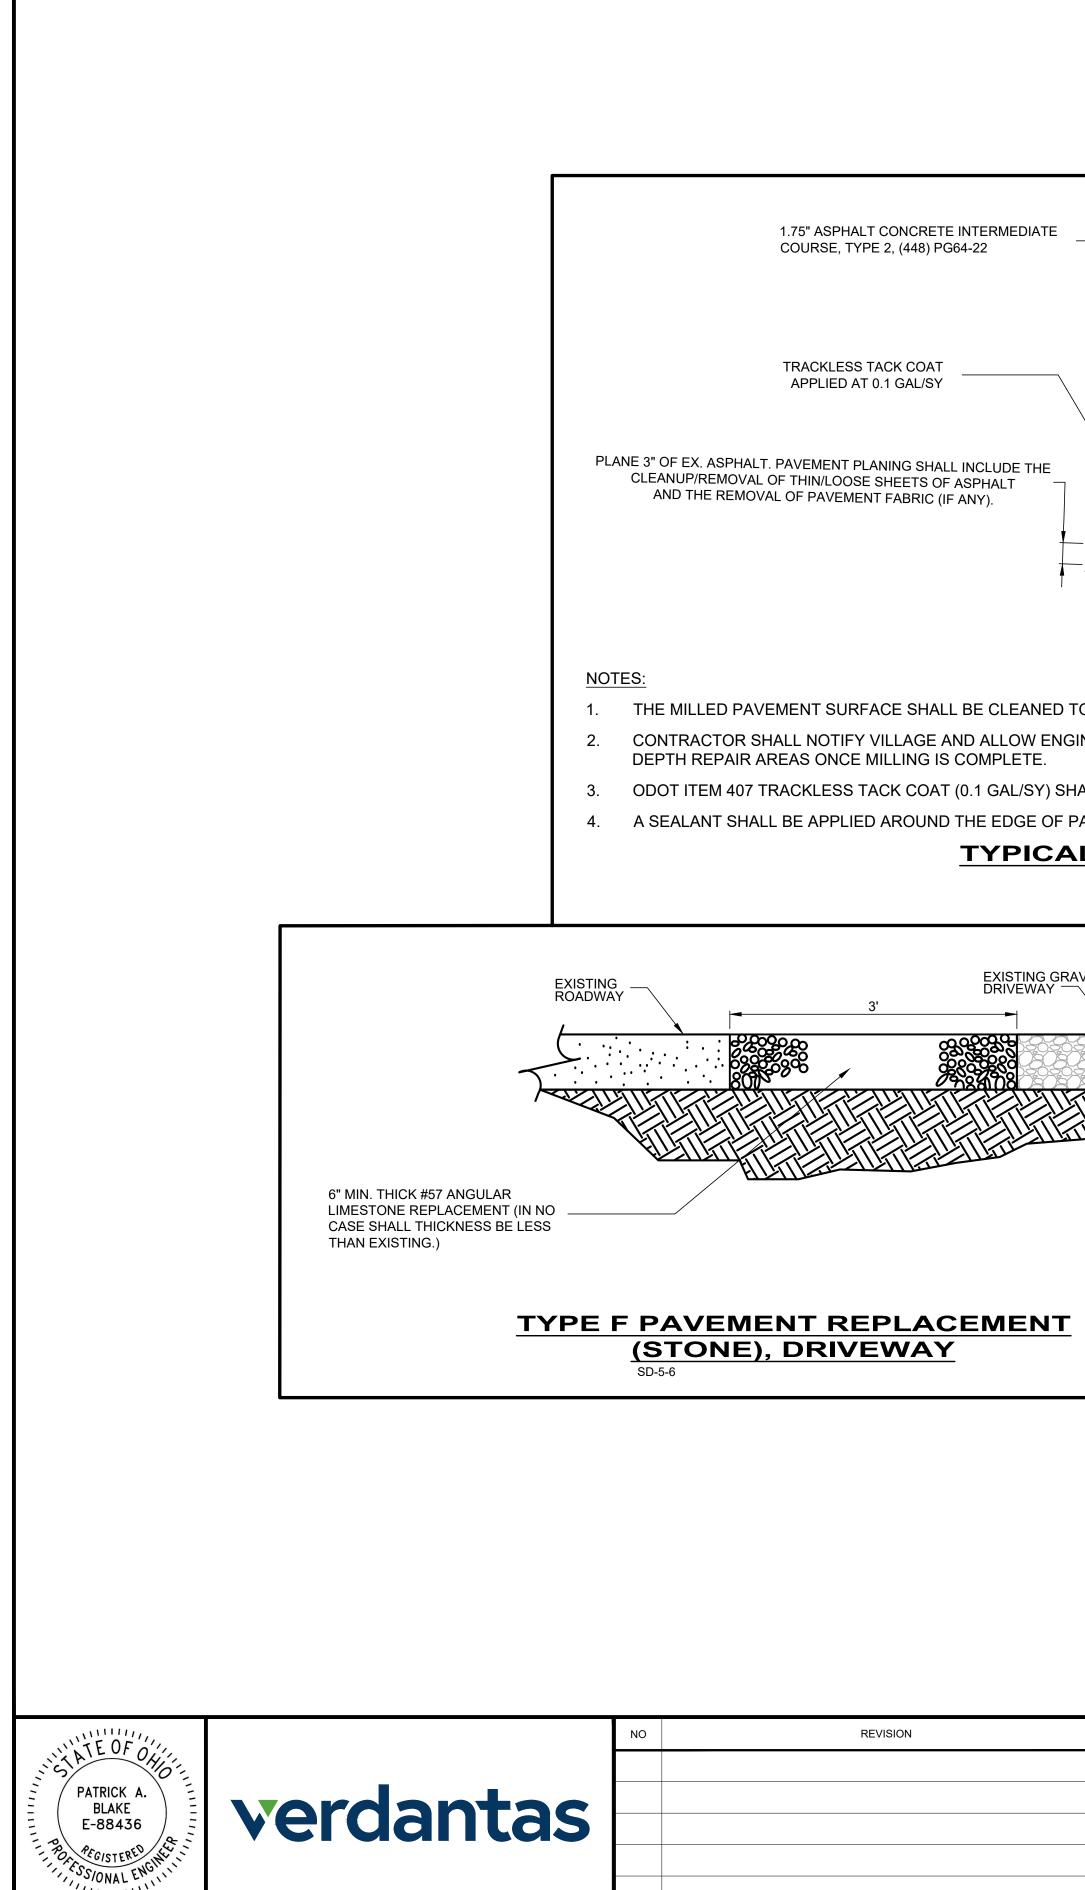

Z: PROJECT FILES \0A-PZ\0RWELL\31849 - VILLAGE OF ORWELL PENNIMAN ROAD PAVEMENT IMPROVEMENTS\CAD\DWG\SHEETS\31849_CONSTRUCTION DETAILS.DWG - D-1 - 4/28/2025 2:22:16 PM - PATRICK BLAKE

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	1.25" ASPHALT CONCRETE SURFACE COURSE, TYPE 1, (448) PG64-22	OV	CATCH-IT LITE"		
	TRACKLESS TACK COAT APPLIED AT 0.1 GAL/SY	GRATE	VELCRO CLOSURES LIFT STRAPS "DANDY BAG"	"t" INTERMEDIATE COURSE EX EX. ASPH. PVMT. 1.25 NOTES:	
INEER TO MAF ALL BE APPLIE	CLEAN CONDITION. RK OUT PARTIAL DEPTH AND FULL ED TO ALL SIDES OF EACH PATCH.	SHALL HAVE INLET 2. INLET PROTECTION CONSTRUCTED. 3. NOT ALL ITEMS SHO CONFIGURATIONS	STING STORM INLET BASINS WITHIN THE WORK LIMITS PROTECTION INSTALLED. N SHALL BE INSTALLED AS EACH STORM INLET IS OWN MAY APPLY OR DIFFERENT TYPES OR MAY BE REQUIRED. THE CONTRACTOR SHALL LET TO CONFIGURE AND ASSEMBLE CUSTOMIZED	 BOTH THE EXISTING AND MILLED BASE PAVEM TO A BROOM-CLEAN CONDITION. TACK COAT SHALL BE APPLIED TO THE EXISTIN AND ALL SIDES OF PATCH. APPLY ODOT ITEM 705.04 HOT APPLIED JOINTS EDGES WHERE NEW ASPHALT MEETS EXISTING ASPHALT PAVEM OVERLAY BUTT JOINT	NG ASPHALT SURFACE SEALER ALONG ALL G ASPHALT. ENT
ATCH. L ASPHALT PAVEMENT MILL AND RESURFACING NOT TO SCALE		INLET FILTERS.	PROTECTION DETAIL SCALE: NONE	SCALE: NONE	
AVEL	LENGTH & WIDTH VARIES AS DIRECTED DEPTH =2.5" EXISTING RAVELED/DETERIORATED EXISTING PAVEMENT EXISTING	Ex. Asphalt NOTES: 1. ANY FULL DEPTH R 2. ASPHALT PAVEMEN	HOWN IN TYPICAL ASPHALT T MILL AND RESURFACING SECTION 1.25" ASPHALT CONCRETE SURFACE COURSE, TYPE 1, (448) PG64-22 1.75" ASPHALT CONCRETE INTERMEDIATE COURSE, TYPE 2, (448) PG64-22 ASPHALT CONCRETE BASE 3" ODOT ITEM 301 <i>Ex. Asphalt</i> <i>Ex. Asphalt</i> <i>COMPACT SUBGRADE</i> PER ODOT ITEM 203 REPAIR SHALL BE COMPLETED ONLY AFTER 3" MILL. NT TO BE REMOVED SHALL BE SAW CUT IN A NEAT E AS FIELD MARKED BY THE ENGINEER. ADDITIONAL	FRAME SET IN MORTAR 3" MIN. EX. FRAME ADJUSTMENT RINGS PRECAST CONCRETE ADJUSTMENT RINGS EX. BRICKS OF PRECAST ADJUSTMENT RINGS PRIMER AND SEALANT Image: Control of the second sec	
		 SAW CUTS MAY BE BE NO EXTRA PAYE BE NO EXTRA PAYE 3. PAVEMENT SHALL THE PAVEMENT TO CONTRACTOR SHAD DAMAGED AREAS A COMPENSATION. 4. TACK COAT SHALL COURSE AND ALL S 5. ODOT ITEM 705.04 EDGE OF PATCH. 	E DESIRED TO FACILITATE REMOVAL, BUT THERE WILL MENT. BE REMOVED WITHOUT DAMAGING OR UNDERMINING O REMAIN. IF ADJACENT PAVEMENT IS DAMAGED, THE ALL MAKE ADDITIONAL SAW CUTS, REMOVE THE AND REPAIR AS NECESSARY WITH NO ADDITIONAL BE APPLIED TO THE EXPOSED EX. ASPHALT BASE	 FILL ALL VOIDS WITH CEMENTITOUS GROUT. IN IRREGULAR OR CONTAINS EXCESSIVE VOIDS T EFFECTIVE SEAL, APPLY PATCHING MIX TO PR UNIFORM SURFACE. DRY INTERIOR SURFACES RECOMMENDATION. APPLY PRIMER AND SEALANT (I.E. FLEX-SEAL) ADJUSTMENT RINGS. THICKNESSES SHALL BE RECOMMENDATION. APPLY TO ENTIRE SURFA RINGS, AS WELL AS MANHOLE STRUCTURE AN ABOVE AND BELOW ADJUSTMENT RINGS. ALL PRIOR TO APPLYING SEALANT. <u>ADJUST MANHOLE CA</u> REHABILITATE ADJUSTMENT 	THAT PREVENTS AN OVIDE A SMOOTH PER MANUFACTURER'S TO MANHOLE PER MANUFACTURER'S CE OF ADJUSTMENT D CASTING AT LEAST 3" OW PRIMER TO CURE
DATE	THE VILLAGE OF ORWELL PENNIMAN ROAD PAVEMENT IMPROVEMENTS ASHTABULA COUNTY ORWELL, OH	ISSUED FOR: BID ISSUE DATE: 04/24/2025 SCALE: AS SHOWN SHEET SIZE: 34x22" DESIGNED BY: SNK CHECKED BY: PAB	CONSTRUCT	ION DETAILS	PROJECT NO. 31849 DISCIPLINE CIVIL SHEET NAME CD SHEET OF 6